
(Sheet Title)

CONCEPTUAL FLOOR PLANS -**BUILDING '1'** 

(Sheet Number)

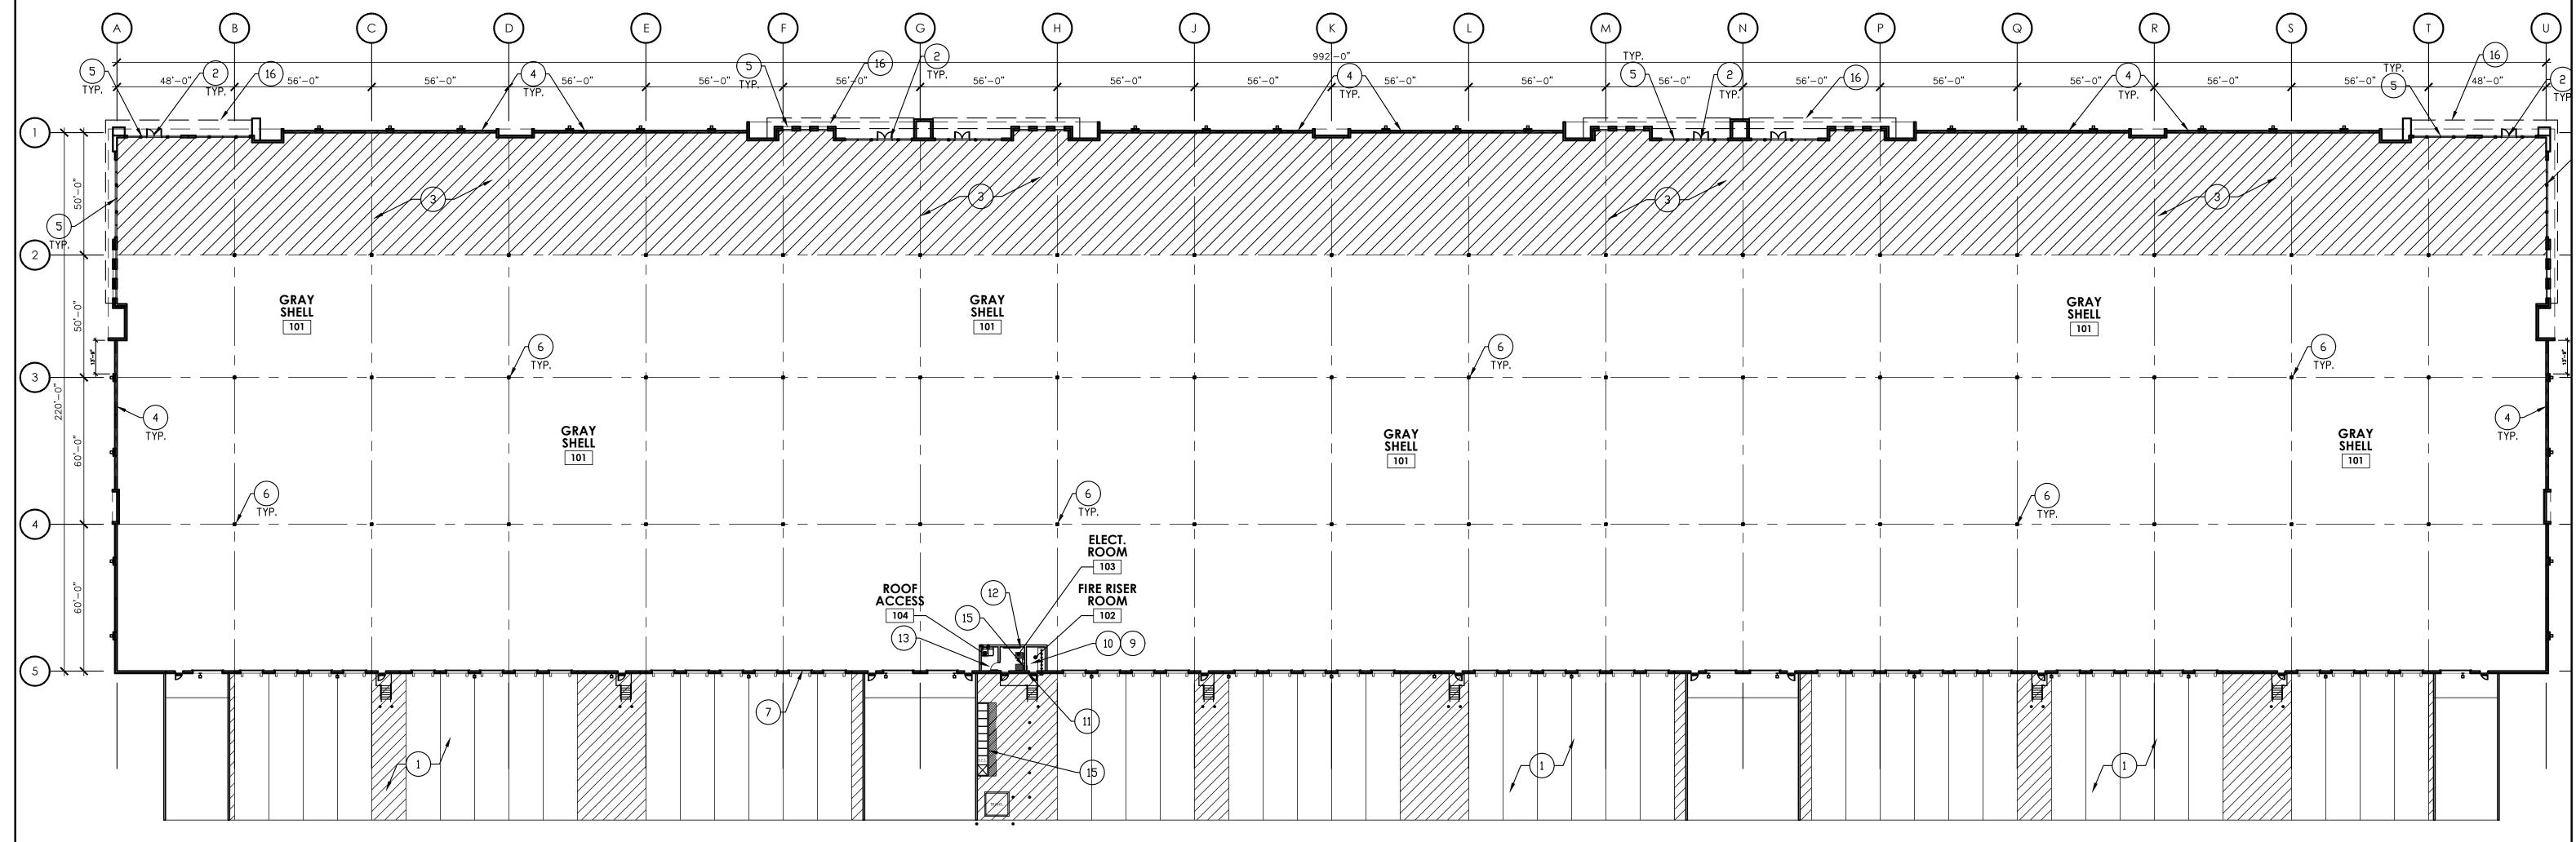

# BUILDING 1 - FLOOR PLAN

SCALE: 1/32" = 1'-0"

AFF.

## **KEYNOTES (PLAN)**

NOTE: THE KEYNOTES LISTED BELOW ARE TYPICAL TO THE BUILDINGS AND MAY NOT BE APPLICABLE AND/OR REFERENCED ON ALL SHEETS.

- CONCRETE SLAB OVER ABC ON GRADE SLOPE AWAY FROM BUILDING - SEE SITE PLAN FOR FINISH & CIVIL FOR GRADES - 2% MAX.
- 2. DOUBLE ENTRY DOORS W/ANODIZED ALUMINUM
- STOREFRONT SYSTEM. 3. CONCRETE SLAB OVER VAPOR BARRIER (15 MIL. MIN.) ON ABC - REFER TO STRUCTURAL DRAWINGS, SOILS REPORT & SPECIFICATIONS. (HATCHED AREA)
- 4. PAINTED CONCRETE TILT-UP PANEL SEE BUILDING ELEVATIONS FOR MATERIAL SCHEDULE. 5. 1" GLAZING IN ANODIZED ALUMINUM SYSTEM — SEE BUILDING ELEVATIONS FOR MATERIAL SCHEDULE.
- S. HSS COLUMN SEE STRUCTURAL. . INDEPENDENT ROOF AND OVERFLOW DRAIN LEADERS ROOF DRAIN AND OVERFLOW DRAIN LEADER TO DAYLIGHT AT FACE OF WALL.
- 8. NOT USED 9. FIRE RISER LOCATION — SEE FIRE SPRINKLER DRAWINGS.
- 10. PROVIDE DBX "AS-BUILT DRAWINGS" CABINET ADJACENT TO FIRE RISER LOCATION.
- 1. KNOX BOX FOR FIRE DEPARTMENT ACCESS WITH ALUMINUM ANNODIZED FINISH, RECESS MOUNTED AT 4'-6" A.F.F.
- **GENERAL NOTES**

MECHANICAL EQUIPMENT.

A. ON ALL EXPOSED METALWORK WELDS AND BRANDS TO BE GROUND VERY SMOOTH AND PAINTED. B. ALL ROOF MOUNTED MECHANICAL EQUIPMENT SHALL BE FULLY SCREENED BY PARAPET WALLS EQUAL TO OR GREATER THAN, THE HIGHEST POINT ON THE

12. PROVIDE 3/4" 4' x 8' FIRE RETARDANT TREATED

13. ROOF ACCESS HATCH & LADDER.14. 5/8" GYP. BD. BOTH SIDES OVER 8" METAL STUDS W/ 3 1/2" SOUND BATT FULL HEIGHT — GYPSUM SHEATHING

FULL HEIGHT ON TENANT SIDE AND ROOF ACCESS

ROOM - PROVIDE GYPSUM BD. CEILING IN FIRE

RISER ROOM AND ELECTRICAL ROOM AT 10'-0"


15. ELECTRICAL SERVICE ENTRY SECTION/PANELS.

16. LINE OF CANOPY/BALCONY/OVERHANG ABOVE.

(Project Number)

(Sheet Title) CONCEPTUAL FLOOR PLANS -**BUILDING '1'** 

A2.01A

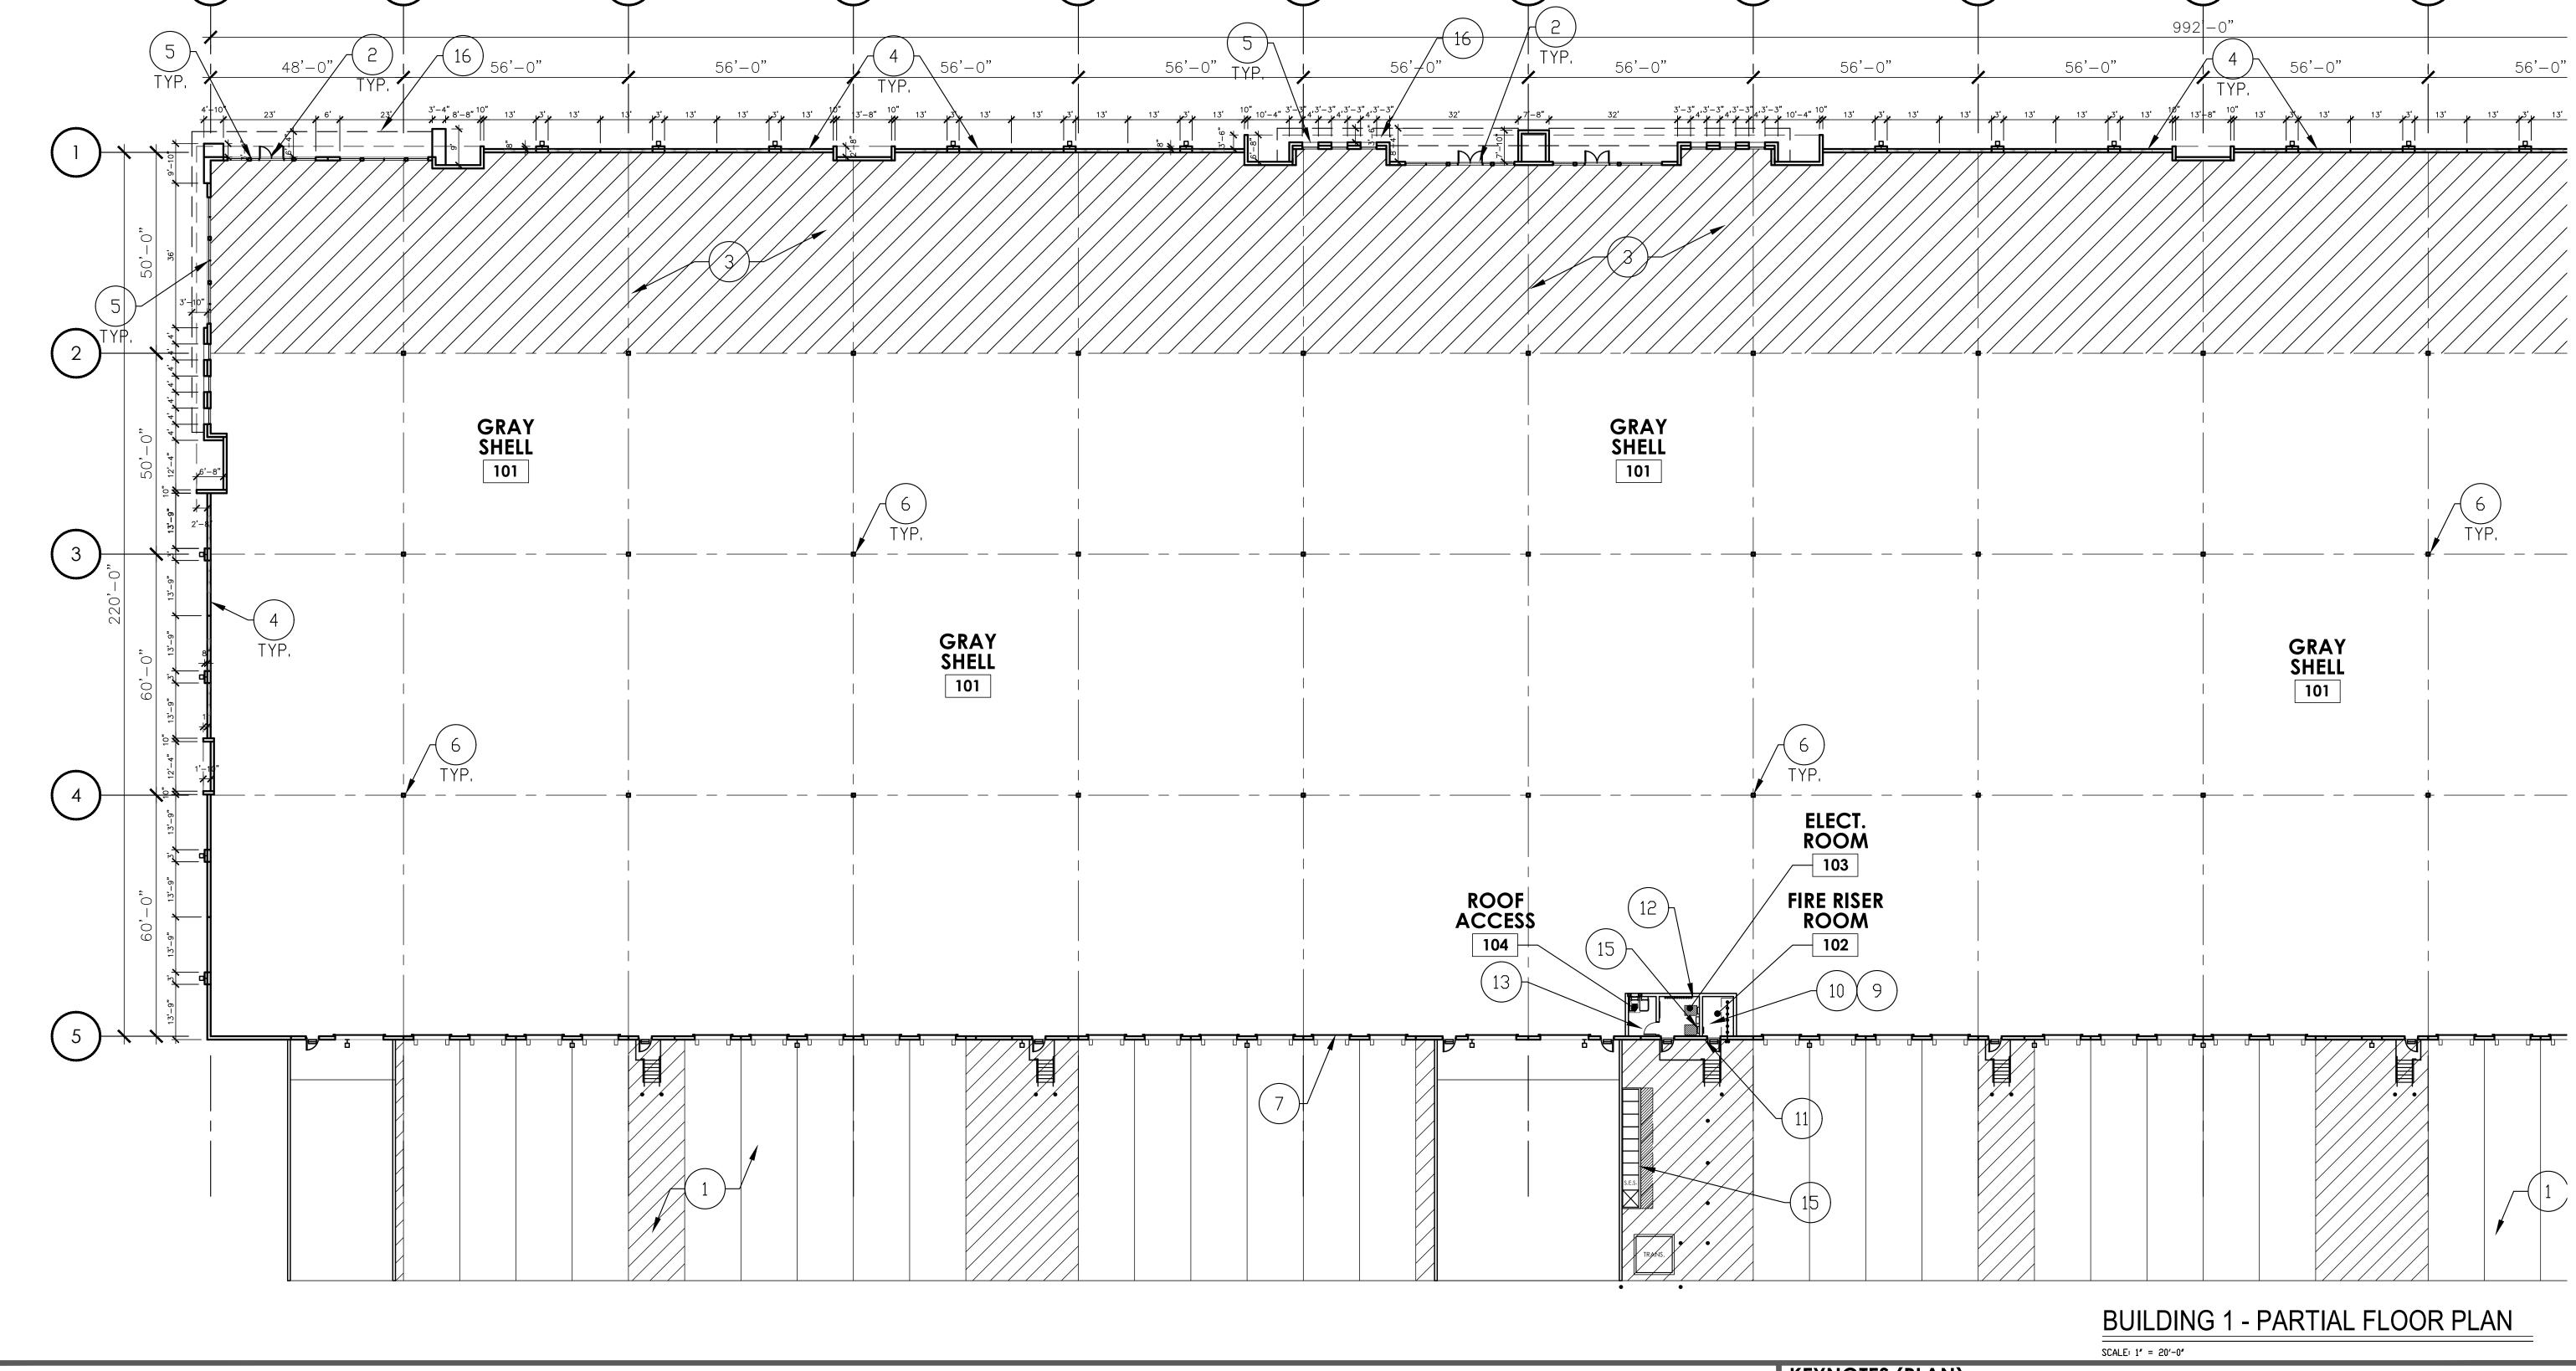

## **KEYNOTES (PLAN)**

NOTE: THE KEYNOTES LISTED BELOW ARE TYPICAL TO THE BUILDINGS AND MAY NOT BE APPLICABLE AND/OR REFERENCED ON ALL SHEETS.

- CONCRETE SLAB OVER ABC ON GRADE SLOPE AWAY FROM BUILDING - SEE SITE PLAN FOR FINISH & CIVIL FOR GRADES - 2% MAX.
- 2. DOUBLE ENTRY DOORS W/ANODIZED ALUMINUM
- STOREFRONT SYSTEM. 3. CONCRETE SLAB OVER VAPOR BARRIER (15 MIL. MIN.) ON ABC - REFER TO STRUCTURAL DRAWINGS, SOIL'S REPORT & SPECIFICATIONS. (HATCHED AREA) 4. PAINTED CONCRETE TILT-UP PANEL - SEE
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- . HSS COLUMN SEE STRUCTURAL. INDEPENDENT ROOF AND OVERFLOW DRAIN LEADERS ROOF DRAIN AND OVERFLOW DRAIN LEADER TO
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- 10. PROVIDE DBX "AS-BUILT DRAWINGS" CABINET ADJACENT TO FIRE RISER LOCATION.
- 1. KNOX BOX FOR FIRE DEPARTMENT ACCESS WITH ALUMINUM ANNODIZED FINISH, RECESS MOUNTED AT 4'-6" A.F.F.

PLYWOOD TMB - BOTTOM AT 6" A.F.F. 13. ROOF ACCESS HATCH & LADDER.14. 5/8" GYP. BD.

12. PROVIDE 3/4" 4' x 8' FIRE RETARDANT TREATED

- BOTH SIDES OVER 8" METAL STUDS W/ 3 1/2" SOUND BATT FULL HEIGHT GYPSUM SHEATHING FULL HEIGHT ON TENANT SIDE AND ROOF ACCESS ROOM - PROVIDE GYPSUM BD. CEILING IN FIRE RISER ROOM AND ELECTRICAL ROOM AT 10'-0" AFF.
- 15. ELECTRICAL SERVICE ENTRY SECTION/PANELS. 16. LINE OF CANOPY/BALCONY/OVERHANG ABOVE.


#### **GENERAL NOTES**

A. ON ALL EXPOSED METALWORK WELDS AND BRANDS TO BE GROUND VERY SMOOTH AND PAINTED. B. ALL ROOF MOUNTED MECHANICAL EQUIPMENT SHALL

BE FULLY SCREENED BY PARAPET WALLS EQUAL TO OR GREATER THAN, THE HIGHEST POINT ON THE MECHANICAL EQUIPMENT.

(Sheet Title) CONCEPTUAL FLOOR PLANS -**BUILDING '1'** 

A2.01B

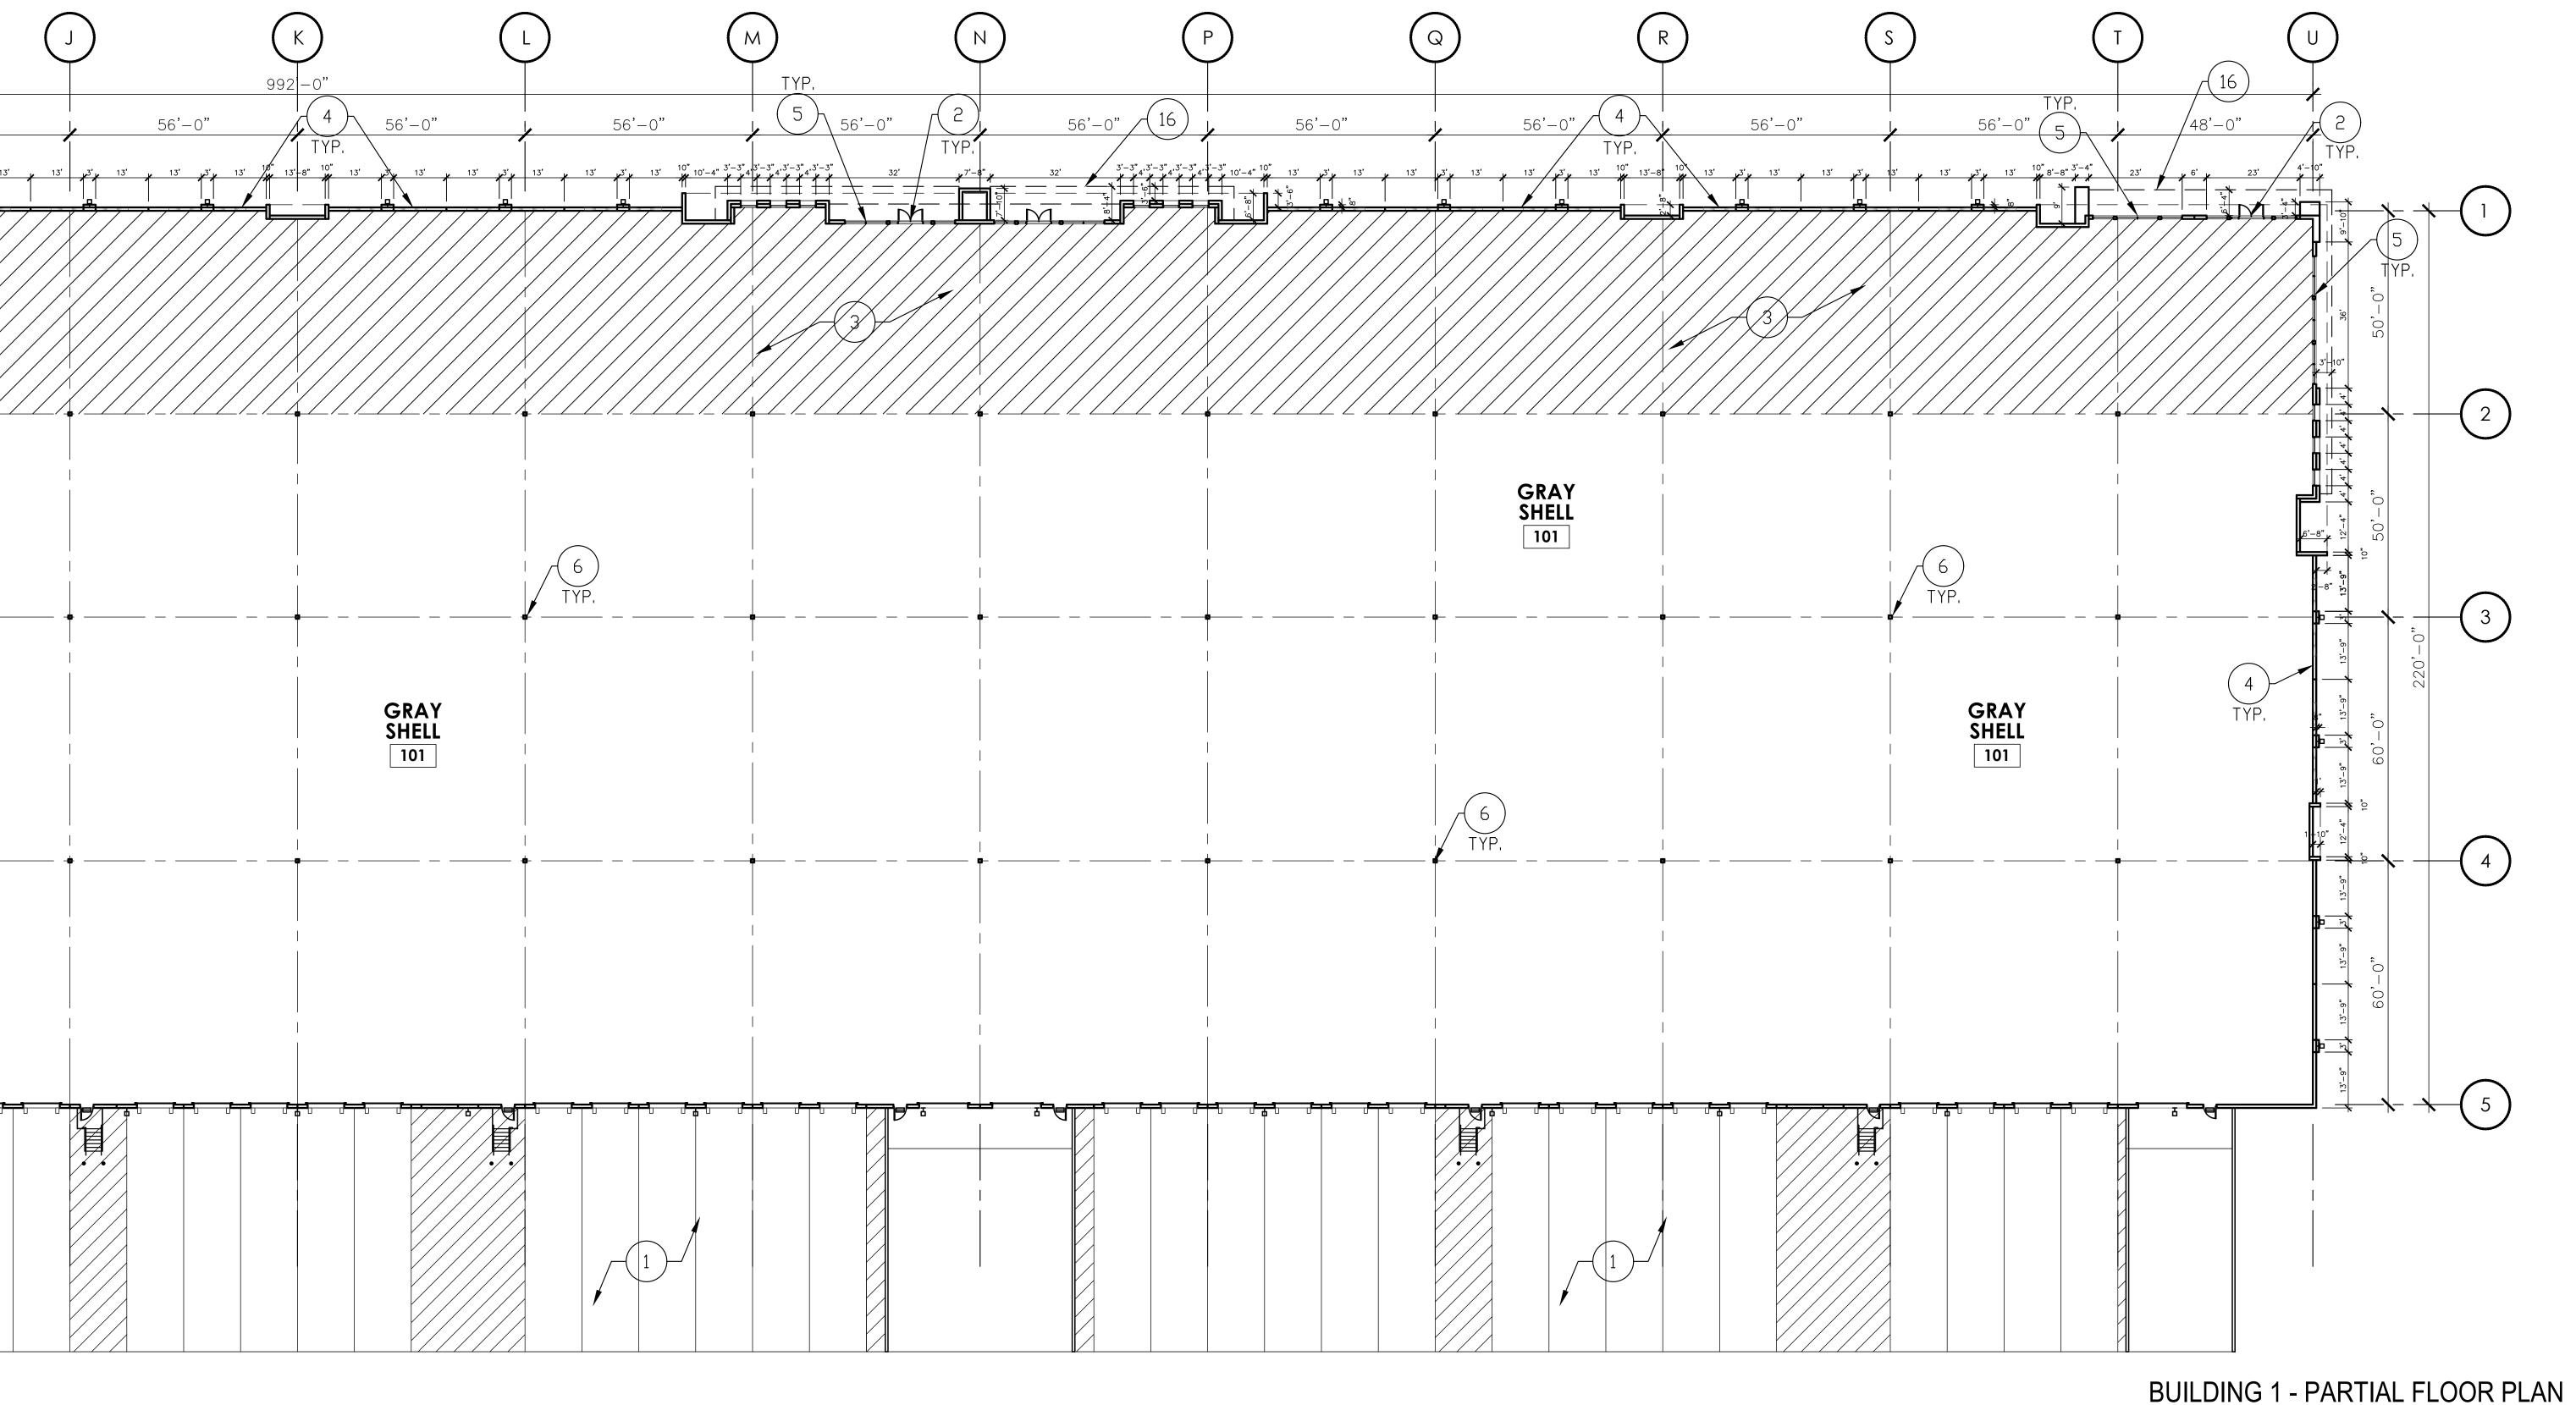

SCALE: 1" = 20'-0"

#### **KEYNOTES (PLAN)**

NOTE: THE KEYNOTES LISTED BELOW ARE TYPICAL TO THE BUILDINGS AND MAY NOT BE APPLICABLE AND/OR REFERENCED ON ALL SHEETS.

- CONCRETE SLAB OVER ABC ON GRADE SLOPE AWAY FROM BUILDING - SEE SITE PLAN FOR FINISH & CIVIL FOR GRADES - 2% MAX.
- 2. DOUBLE ENTRY DOORS W/ANODIZED ALUMINUM
- STOREFRONT SYSTEM. 3. CONCRETE SLAB OVER VAPOR BARRIER (15 MIL. MIN.) ON ABC - REFER TO STRUCTURAL DRAWINGS, SOILS REPORT & SPECIFICATIONS. (HATCHED AREA)
- 4. PAINTED CONCRETE TILT-UP PANEL SEE BUILDING ELEVATIONS FOR MATERIAL SCHEDULE. 5. 1" GLAZING IN ANODIZED ALUMINUM SYSTEM - SEE
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- DRAWINGS. 10. PROVIDE DBX "AS-BUILT DRAWINGS" CABINET ADJACENT TO FIRE RISER LOCATION.
- 1. KNOX BOX FOR FIRE DEPARTMENT ACCESS WITH ALUMINUM ANNODIZED FINISH, RECESS MOUNTED AT 4'-6" A.F.F.

- 12. PROVIDE 3/4" 4' x 8' FIRE RETARDANT TREATED PLYWOOD TMB - BOTTOM AT 6" A.F.F.
- 13. ROOF ACCESS HATCH & LADDER.14. 5/8" GYP. BD. BOTH SIDES OVER 8" METAL STUDS W/ 3 1/2" SOUND BATT FULL HEIGHT — GYPSUM SHEATHING FULL HEIGHT ON TENANT SIDE AND ROOF ACCESS ROOM - PROVIDE GYPSUM BD. CEILING IN FIRE RISER ROOM AND ELECTRICAL ROOM AT 10'-0" AFF.
- 15. ELECTRICAL SERVICE ENTRY SECTION/PANELS. 16. LINE OF CANOPY/BALCONY/OVERHANG ABOVE.

A. ON ALL EXPOSED METALWORK WELDS AND BRANDS

OR GREATER THAN, THE HIGHEST POINT ON THE

BE FULLY SCREENED BY PARAPET WALLS EQUAL TO

TO BE GROUND VERY SMOOTH AND PAINTED. B. ALL ROOF MOUNTED MECHANICAL EQUIPMENT SHALL

**GENERAL NOTES** 

MECHANICAL EQUIPMENT.

**BUILDING '2'** 

**GENERAL NOTES** 

**KEYNOTES (PLAN)** 

NOTE: THE KEYNOTES LISTED BELOW ARE TYPICAL TO THE BUILDINGS AND MAY NOT BE APPLICABLE AND/OR REFERENCED ON ALL SHEETS.

- CONCRETE SLAB OVER ABC ON GRADE SLOPE AWAY FROM BUILDING - SEE SITE PLAN FOR FINISH & CIVIL FOR GRADES - 2% MAX.
- 2. DOUBLE ENTRY DOORS W/ANODIZED ALUMINUM STOREFRONT SYSTEM.
- 3. CONCRETE SLAB OVER VAPOR BARRIER (15 MIL. MIN.) ON ABC - REFER TO STRUCTURAL DRAWINGS, SOILS REPORT & SPECIFICATIONS. (HATCHED AREA)
- 4. PAINTED CONCRETE TILT-UP PANEL SEE BUILDING ELEVATIONS FOR MATERIAL SCHEDULE. 5. 1" GLAZING IN ANODIZED ALUMINUM SYSTEM — SEE BUILDING ELEVATIONS FOR MATERIAL SCHEDULE.
- S. HSS COLUMN SEE STRUCTURAL. . INDEPENDENT ROOF AND OVERFLOW DRAIN LEADERS ROOF DRAIN AND OVERFLOW DRAIN LEADER TO DAYLIGHT AT FACE OF WALL.
- 8. NOT USED 9. FIRE RISER LOCATION — SEE FIRE SPRINKLER DRAWINGS.
- 10. PROVIDE DBX "AS-BUILT DRAWINGS" CABINET ADJACENT TO FIRE RISER LOCATION.

  11. KNOX BOX FOR FIRE DEPARTMENT ACCESS WITH
- ALUMINUM ANNODIZED FINISH, RECESS MOUNTED AT 4'-6" A.F.F.

BOTH SIDES OVER 8" METAL STUDS W/ 3 1/2" SOUND BATT FULL HEIGHT — GYPSUM SHEATHING FULL HEIGHT ON TENANT SIDE AND ROOF ACCESS ROOM - PROVIDE GYPSUM BD. CEILING IN FIRE RISER ROOM AND ELECTRICAL ROOM AT 10'-0"

PLYWOOD TMB - BOTTOM AT 6" A.F.F.

**BUILDING 2 - FLOOR PLAN** 

SCALE: 1/32" = 1'-0"

AFF. 15. ELECTRICAL SERVICE ENTRY SECTION/PANELS. 16. LINE OF CANOPY/BALCONY/OVERHANG ABOVE.

12. PROVIDE 3/4" 4' x 8' FIRE RETARDANT TREATED


13. ROOF ACCESS HATCH & LADDER.14. 5/8" GYP. BD.

A. ON ALL EXPOSED METALWORK WELDS AND BRANDS TO BE GROUND VERY SMOOTH AND PAINTED. B. ALL ROOF MOUNTED MECHANICAL EQUIPMENT SHALL BE FULLY SCREENED BY PARAPET WALLS EQUAL TO OR GREATER THAN, THE HIGHEST POINT ON THE MECHANICAL EQUIPMENT.

(Project Number) (Sheet Title) CONCEPTUAL FLOOR PLANS -

**BUILDING '2'** 

**A2.02A** OR GREATER THAN, THE HIGHEST POINT ON THE

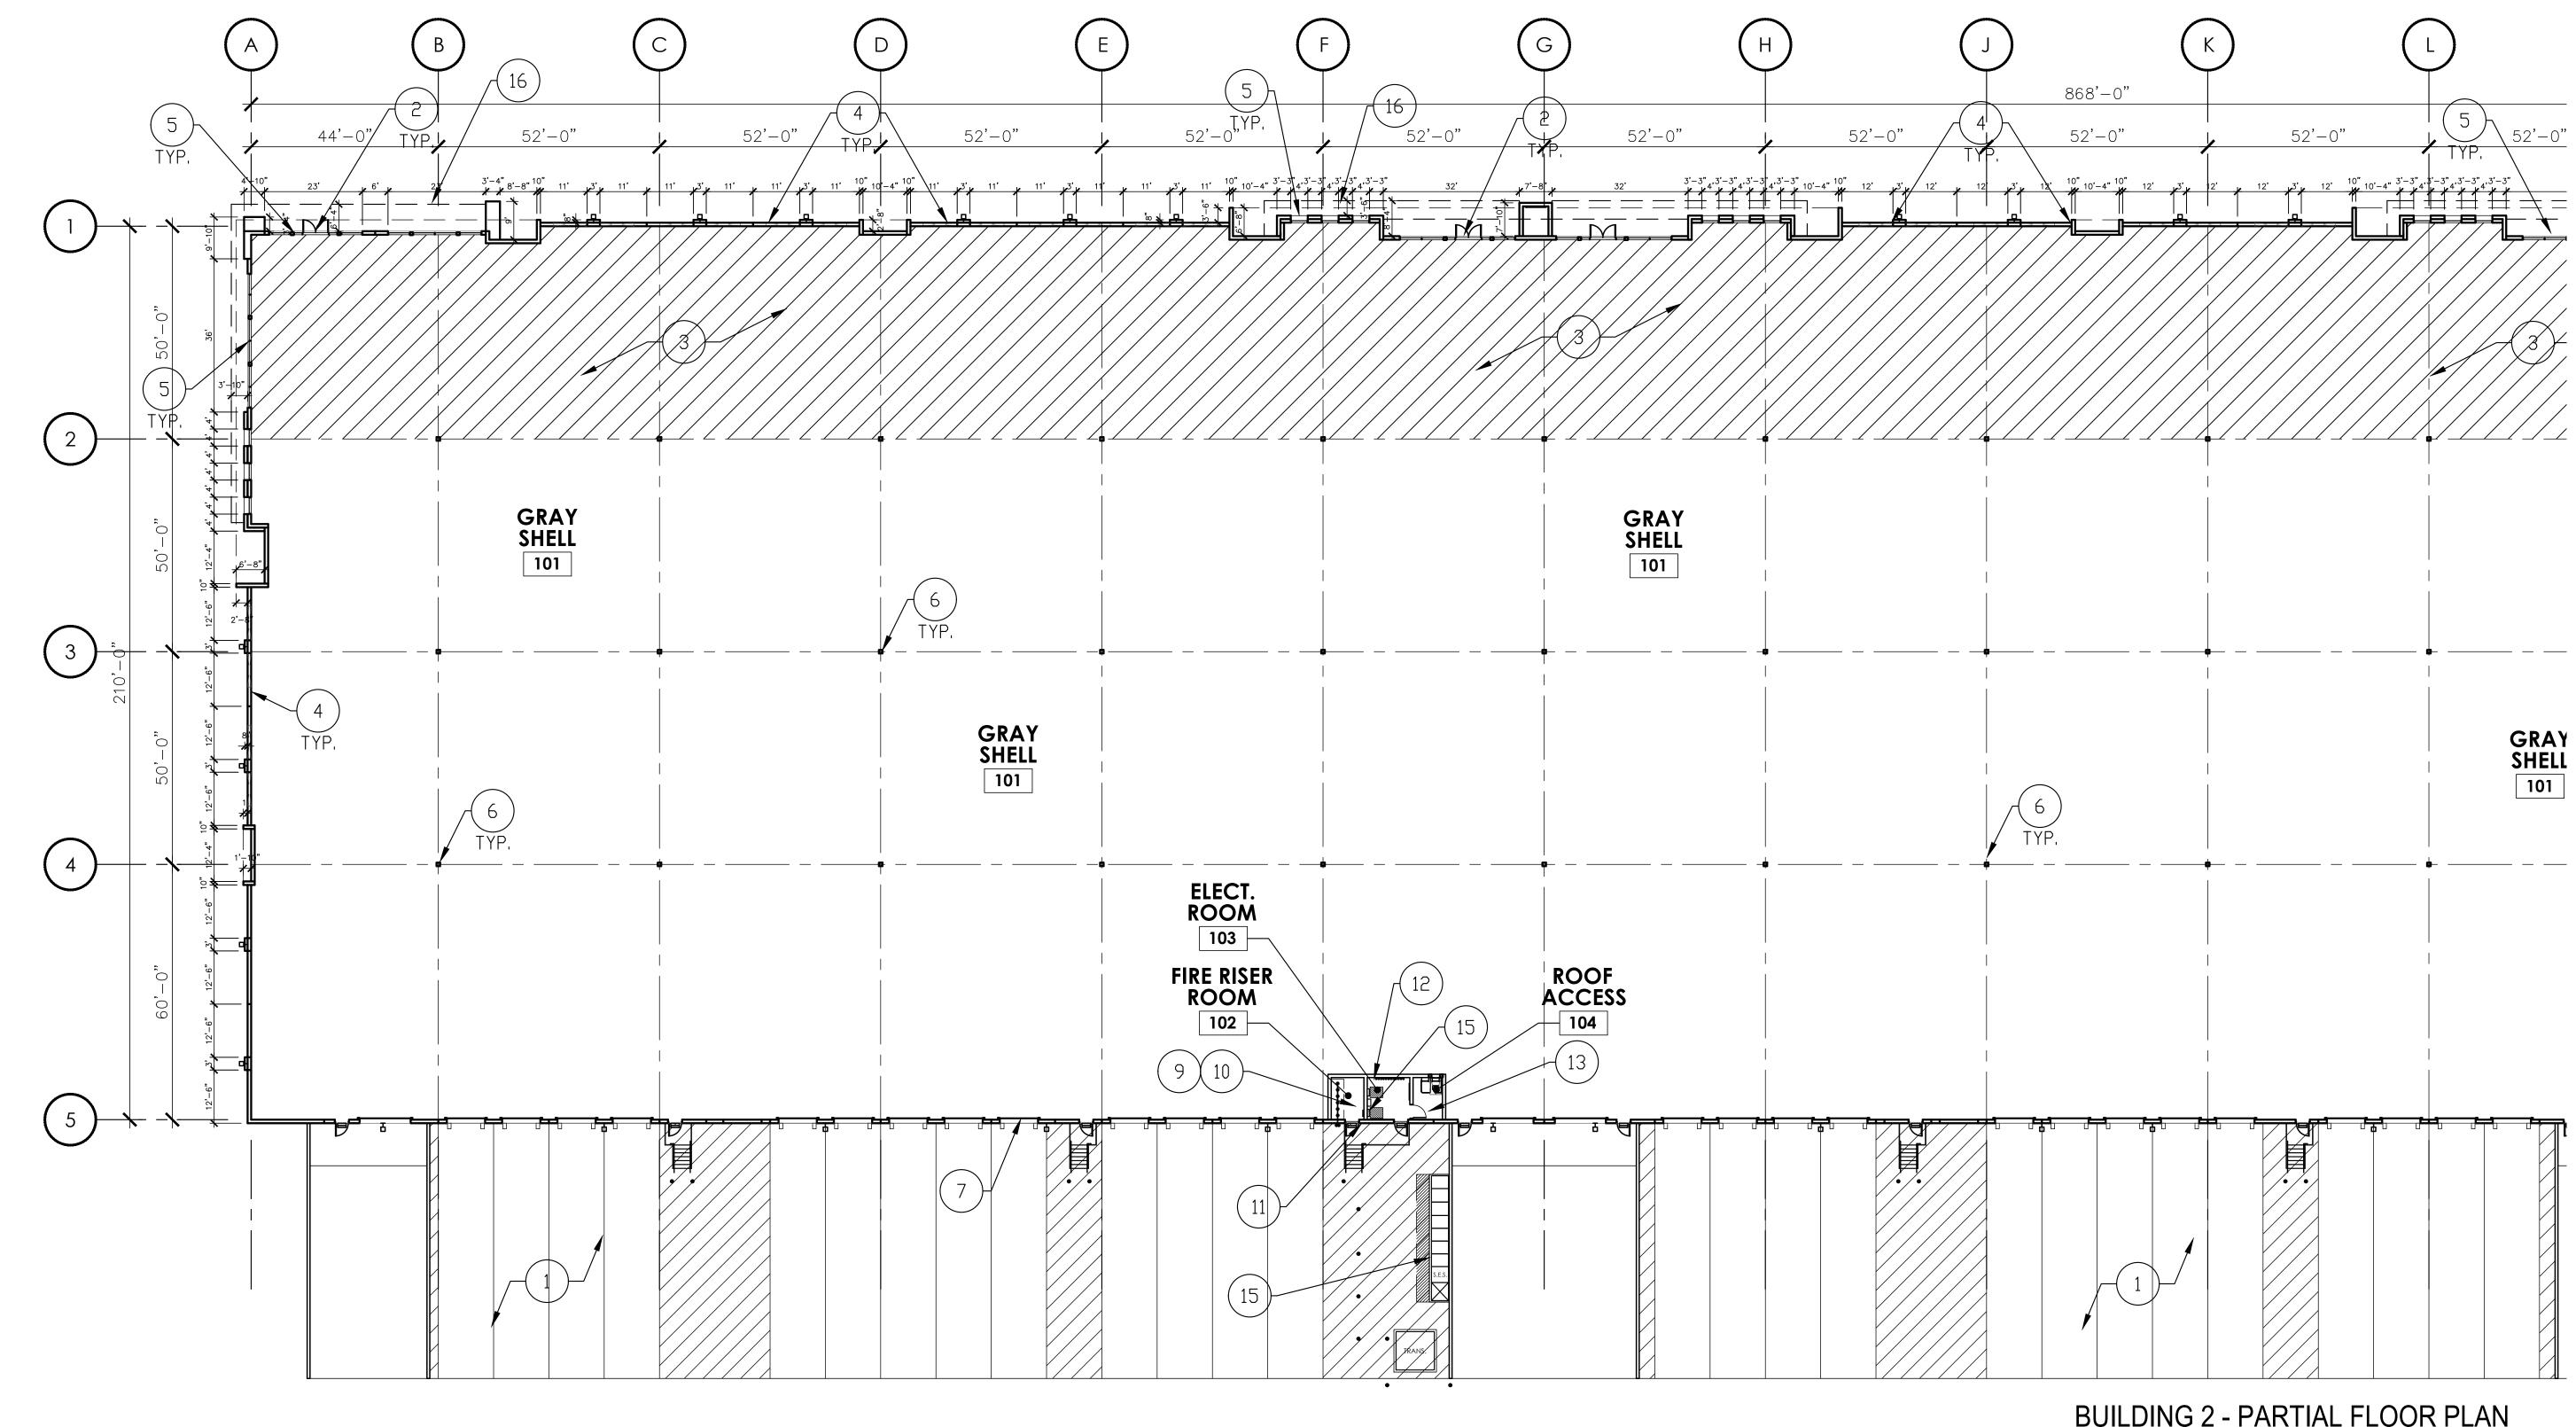

# BUILDING 2 - PARTIAL FLOOR PLAN

AFF.

SCALE: 1" = 20'-0"

#### **KEYNOTES (PLAN)**

NOTE: THE KEYNOTES LISTED BELOW ARE TYPICAL TO THE BUILDINGS AND MAY NOT BE APPLICABLE AND/OR REFERENCED ON ALL SHEETS.

- CONCRETE SLAB OVER ABC ON GRADE SLOPE AWAY FROM BUILDING - SEE SITE PLAN FOR FINISH & CIVIL FOR GRADES - 2% MAX.
- 2. DOUBLE ENTRY DOORS W/ANODIZED ALUMINUM
- STOREFRONT SYSTEM. 3. CONCRETE SLAB OVER VAPOR BARRIER (15 MIL. MIN.) ON ABC - REFER TO STRUCTURAL DRAWINGS, SOILS REPORT & SPECIFICATIONS. (HATCHED AREA) 4. PAINTED CONCRETE TILT-UP PANEL - SEE
- BUILDING ELEVATIONS FOR MATERIAL SCHEDULE. 5. 1" GLAZING IN ANODIZED ALUMINUM SYSTEM - SEE BUILDING ELEVATIONS FOR MATERIAL SCHEDULE.
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- DRAWINGS. 10. PROVIDE DBX "AS-BUILT DRAWINGS" CABINET ADJACENT TO FIRE RISER LOCATION.
- 1. KNOX BOX FOR FIRE DEPARTMENT ACCESS WITH ALUMINUM ANNODIZED FINISH, RECESS MOUNTED AT 4'-6" A.F.F.

#### **GENERAL NOTES**

MECHANICAL EQUIPMENT.

A. ON ALL EXPOSED METALWORK WELDS AND BRANDS TO BE GROUND VERY SMOOTH AND PAINTED. B. ALL ROOF MOUNTED MECHANICAL EQUIPMENT SHALL BE FULLY SCREENED BY PARAPET WALLS EQUAL TO

12. PROVIDE 3/4" 4' x 8' FIRE RETARDANT TREATED

13. ROOF ACCESS HATCH & LADDER.14. 5/8" GYP. BD. BOTH SIDES OVER 8" METAL STUDS W/ 3 1/2" SOUND BATT FULL HEIGHT — GYPSUM SHEATHING

FULL HEIGHT ON TENANT SIDE AND ROOF ACCESS

ROOM - PROVIDE GYPSUM BD. CEILING IN FIRE

RISER ROOM AND ELECTRICAL ROOM AT 10'-0"


15. ELECTRICAL SERVICE ENTRY SECTION/PANELS.

16. LINE OF CANOPY/BALCONY/OVERHANG ABOVE.

(Sheet Title) CONCEPTUAL FLOOR PLANS -

**BUILDING '2'** 

A. ON ALL EXPOSED METALWORK WELDS AND BRANDS OR GREATER THAN, THE HIGHEST POINT ON THE MECHANICAL EQUIPMENT.

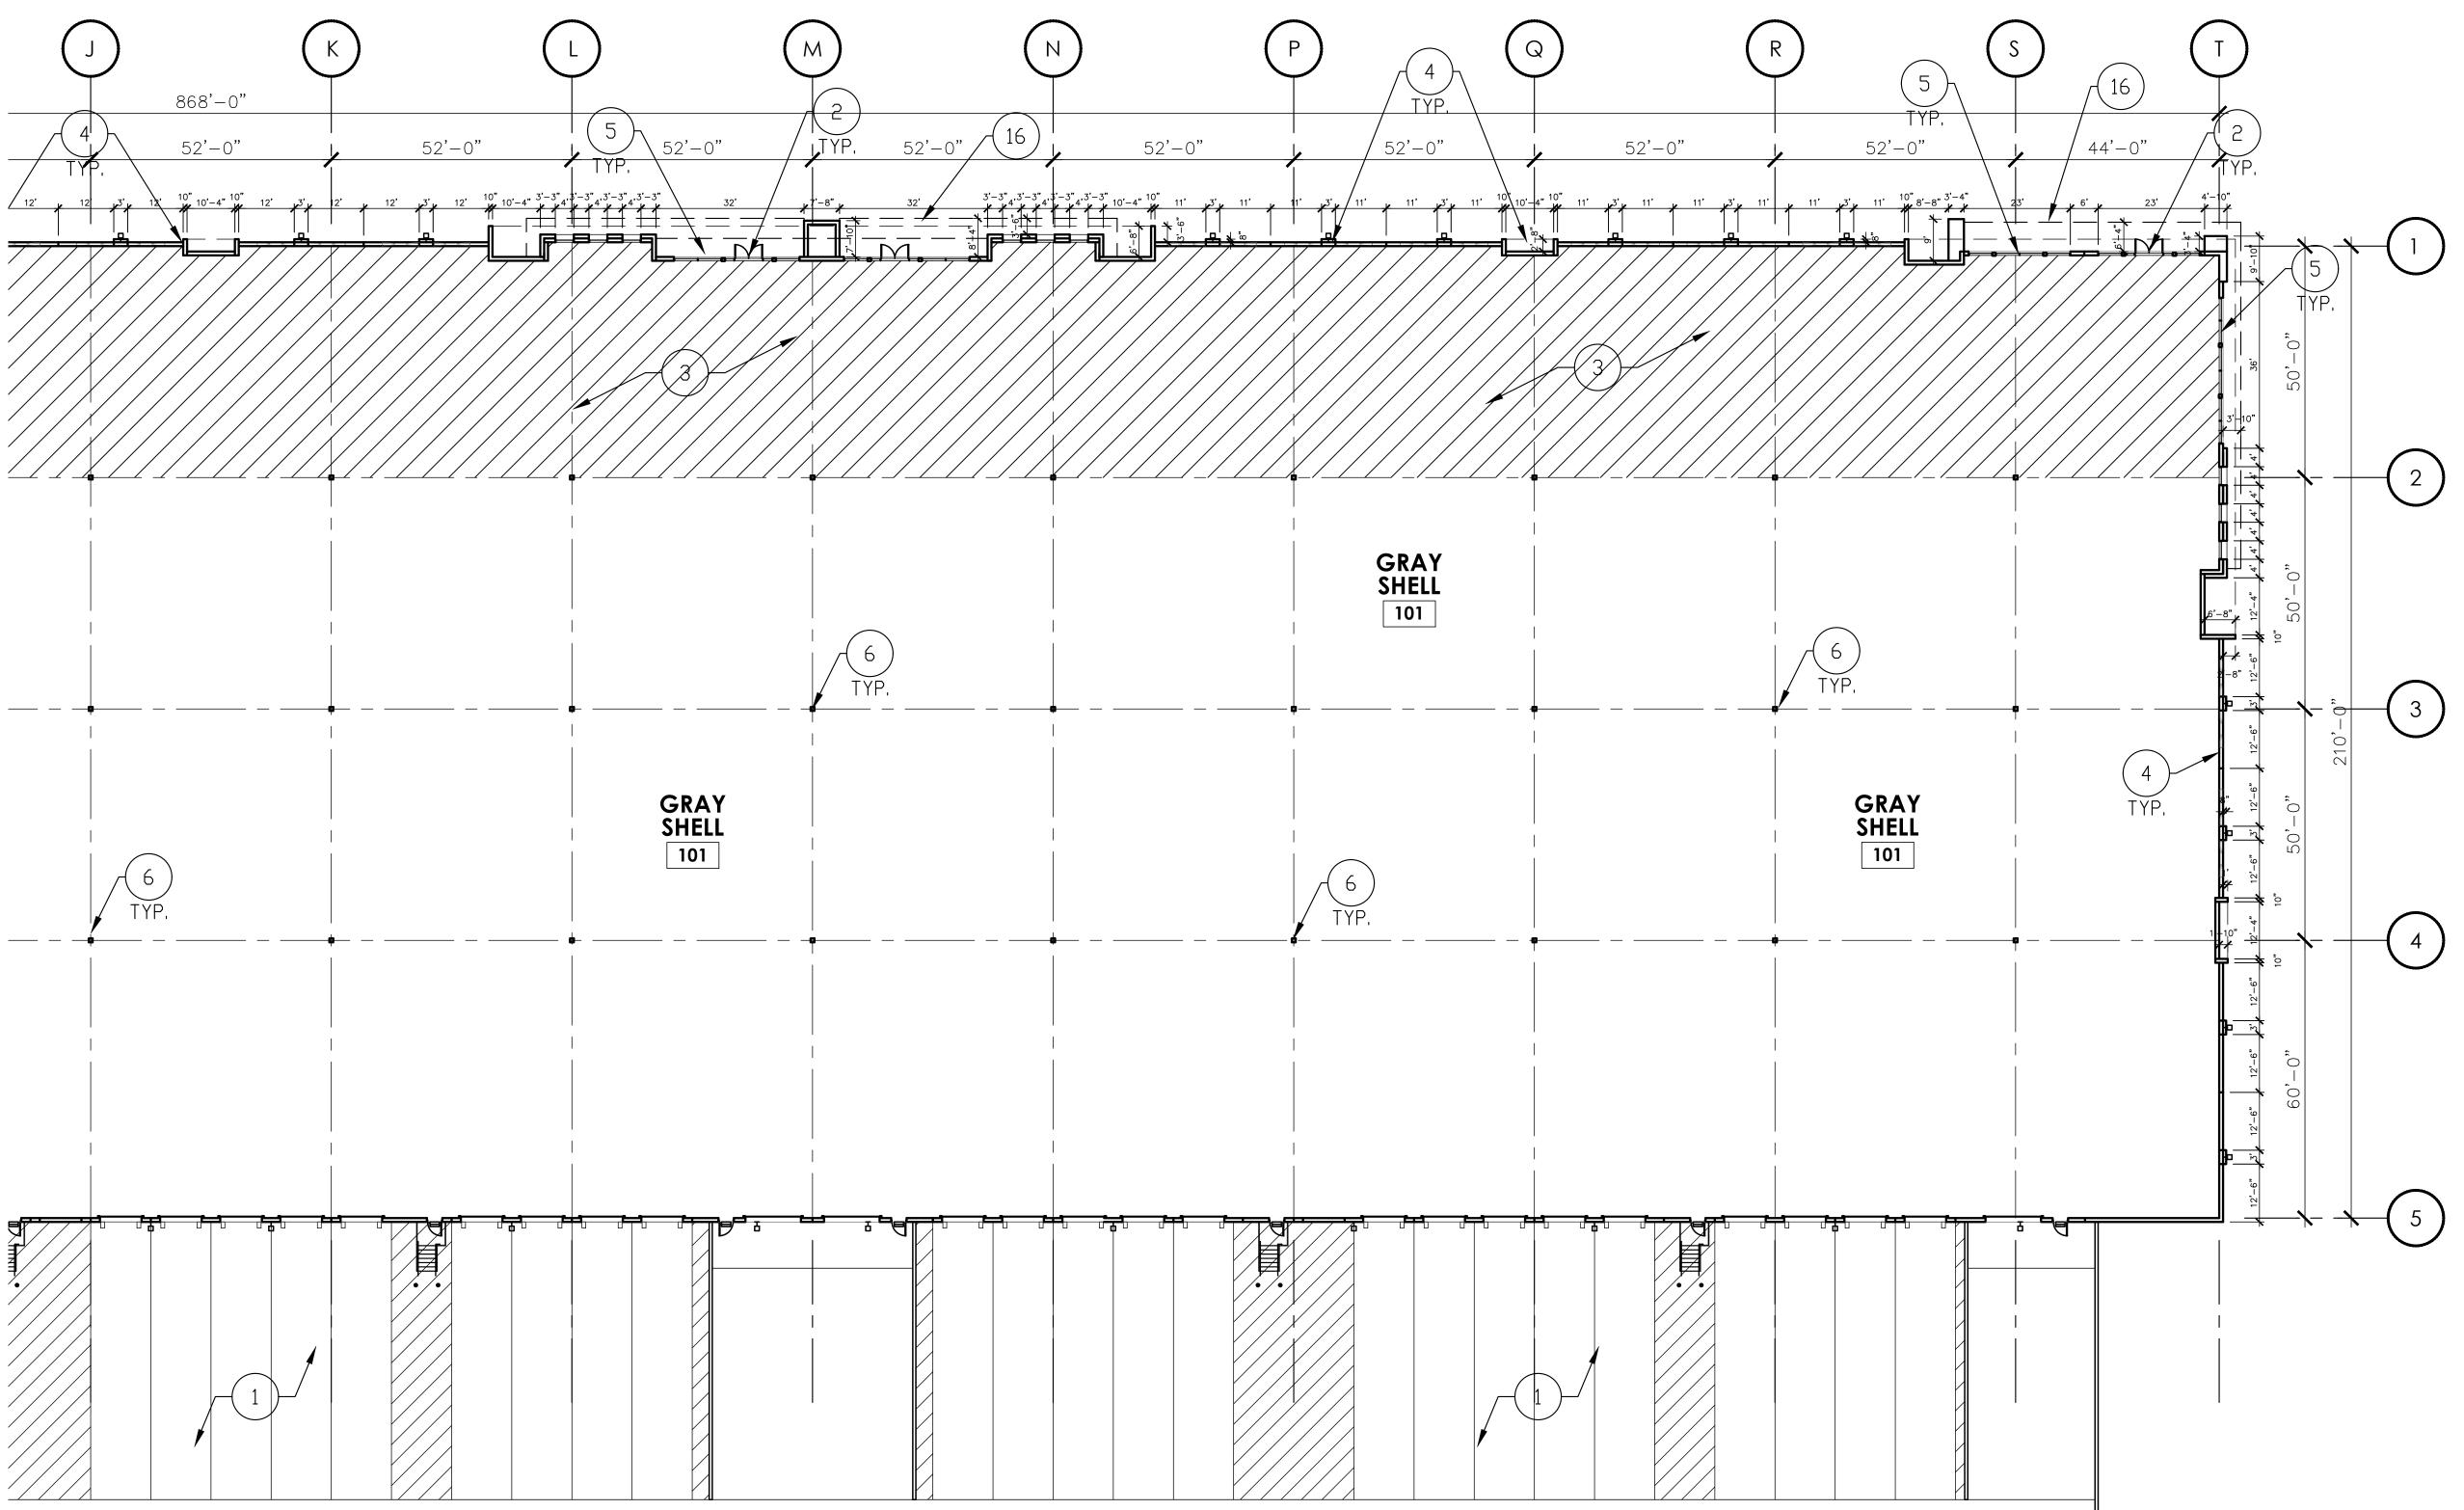

# BUILDING 2 - PARTIAL FLOOR PLAN

AFF.

SCALE: 1" = 20'-0"

#### **KEYNOTES (PLAN)**

NOTE: THE KEYNOTES LISTED BELOW ARE TYPICAL TO THE BUILDINGS AND MAY NOT BE APPLICABLE AND/OR REFERENCED ON ALL SHEETS.

- CONCRETE SLAB OVER ABC ON GRADE SLOPE AWAY FROM BUILDING - SEE SITE PLAN FOR FINISH & CIVIL FOR GRADES - 2% MAX.
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- STOREFRONT SYSTEM. 3. CONCRETE SLAB OVER VAPOR BARRIER (15 MIL. MIN.) ON ABC - REFER TO STRUCTURAL DRAWINGS, SOILS REPORT & SPECIFICATIONS. (HATCHED AREA)
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- 8. NOT USED 9. FIRE RISER LOCATION — SEE FIRE SPRINKLER DRAWINGS.
- 10. PROVIDE DBX "AS-BUILT DRAWINGS" CABINET ADJACENT TO FIRE RISER LOCATION.
- 1. KNOX BOX FOR FIRE DEPARTMENT ACCESS WITH ALUMINUM ANNODIZED FINISH, RECESS MOUNTED AT 4'-6" A.F.F.
- **GENERAL NOTES**
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FULL HEIGHT ON TENANT SIDE AND ROOF ACCESS

ROOM - PROVIDE GYPSUM BD. CEILING IN FIRE


RISER ROOM AND ELECTRICAL ROOM AT 10'-0"

15. ELECTRICAL SERVICE ENTRY SECTION/PANELS.

16. LINE OF CANOPY/BALCONY/OVERHANG ABOVE.

(Sheet Title) CONCEPTUAL FLOOR PLANS -**BUILDING '3'** 

(Sheet Number)

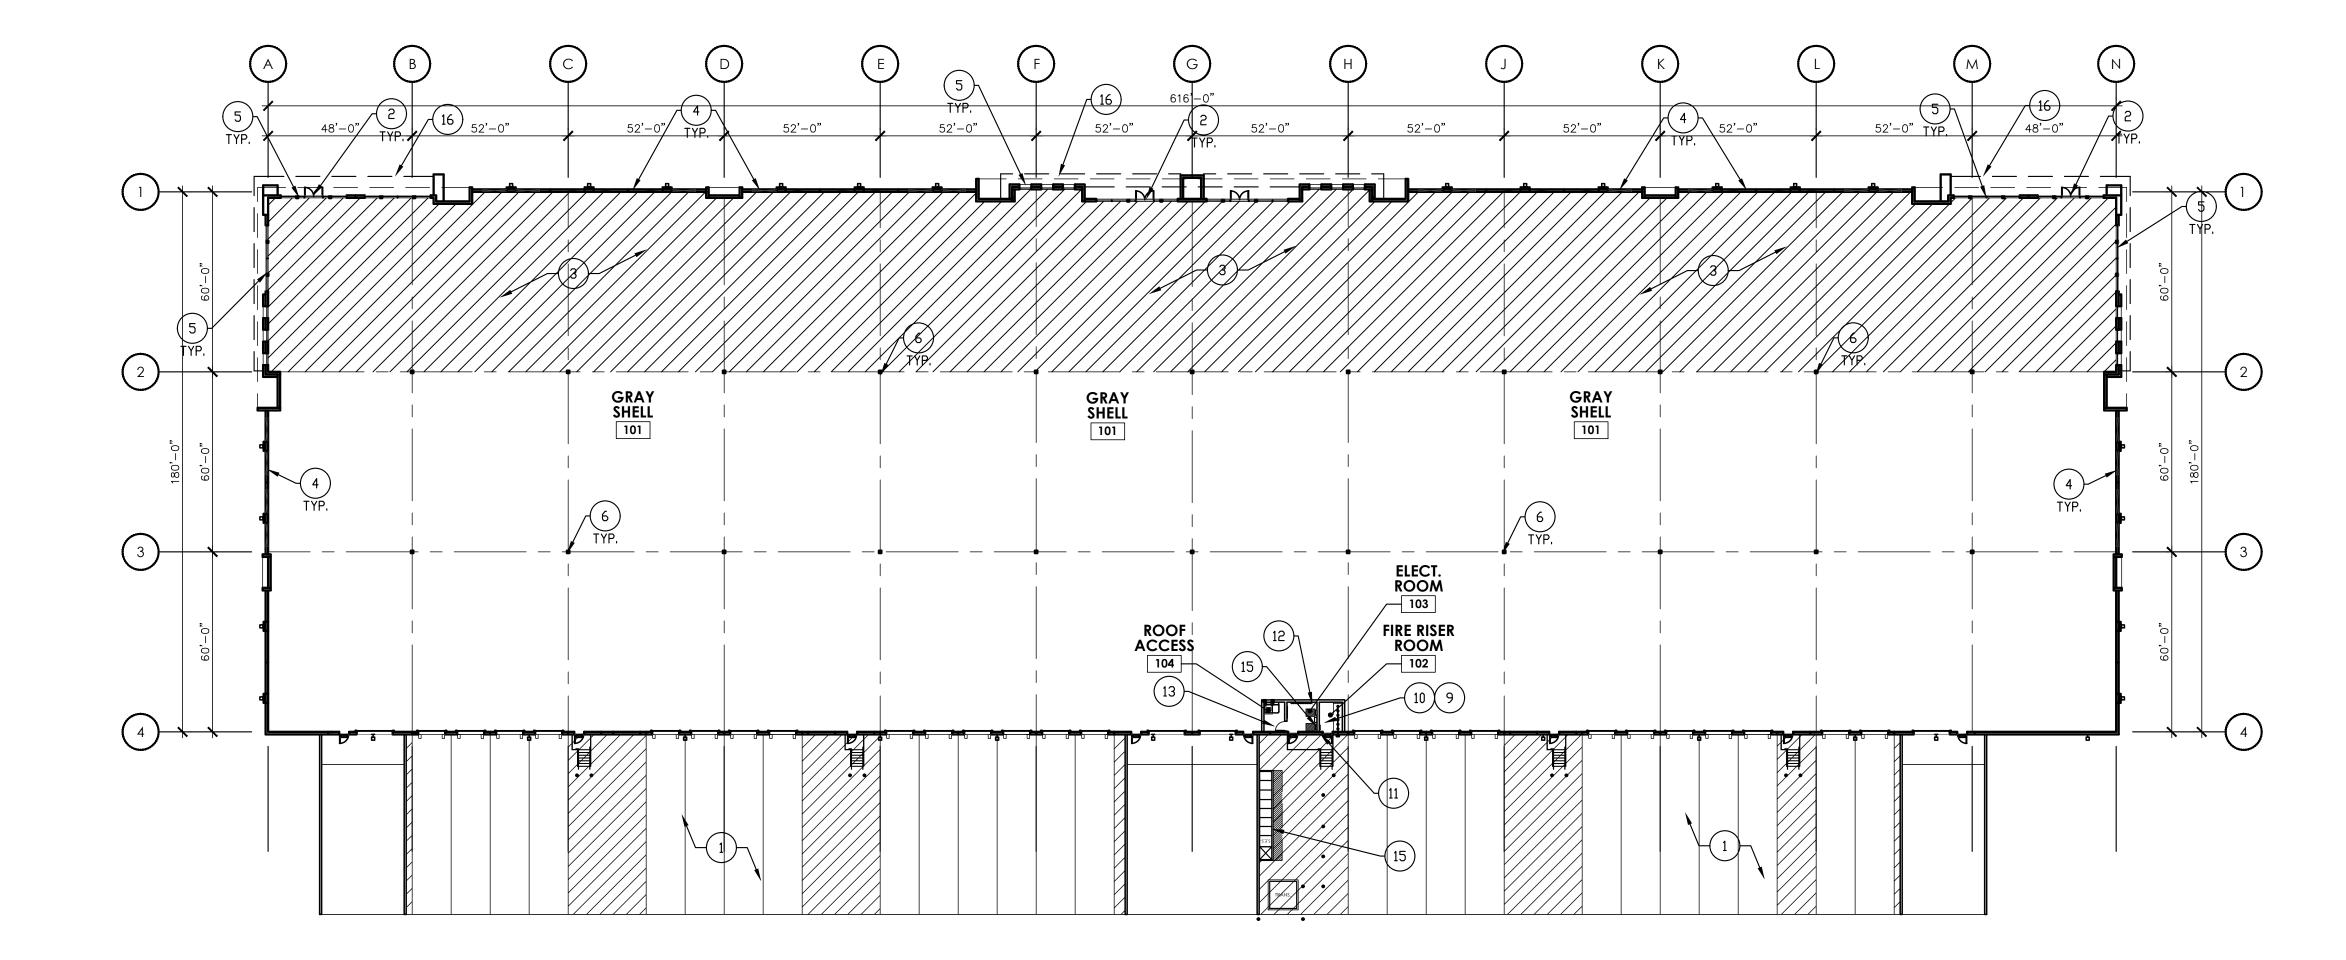

#### **BUILDING 3 - FLOOR PLAN**

SCALE: 1/32" = 1'-0"

## **KEYNOTES (PLAN)**

NOTE: THE KEYNOTES LISTED BELOW ARE TYPICAL TO THE BUILDINGS AND MAY NOT BE APPLICABLE AND/OR REFERENCED ON ALL SHEETS.

- CONCRETE SLAB OVER ABC ON GRADE SLOPE AWAY FROM BUILDING - SEE SITE PLAN FOR FINISH & CIVIL FOR GRADES - 2% MAX.
- 2. DOUBLE ENTRY DOORS W/ANODIZED ALUMINUM
- STOREFRONT SYSTEM. 3. CONCRETE SLAB OVER VAPOR BARRIER (15 MIL. MIN.) ON ABC - REFER TO STRUCTURAL DRAWINGS, SOILS REPORT & SPECIFICATIONS. (HATCHED AREA)
- 4. PAINTED CONCRETE TILT-UP PANEL SEE BUILDING ELEVATIONS FOR MATERIAL SCHEDULE. 5. 1" GLAZING IN ANODIZED ALUMINUM SYSTEM — SEE BUILDING ELEVATIONS FOR MATERIAL SCHEDULE.
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- 10. PROVIDE DBX "AS-BUILT DRAWINGS" CABINET ADJACENT TO FIRE RISER LOCATION.

  11. KNOX BOX FOR FIRE DEPARTMENT ACCESS WITH
- ALUMINUM ANNODIZED FINISH, RECESS MOUNTED AT 4'-6" A.F.F.

- 12. PROVIDE 3/4" 4' x 8' FIRE RETARDANT TREATED PLYWOOD TMB - BOTTOM AT 6" A.F.F.
- 13. ROOF ACCESS HATCH & LADDER.14. 5/8" GYP. BD. BOTH SIDES OVER 8" METAL STUDS W/ 3 1/2" SOUND BATT FULL HEIGHT — GYPSUM SHEATHING FULL HEIGHT ON TENANT SIDE AND ROOF ACCESS ROOM - PROVIDE GYPSUM BD. CEILING IN FIRE RISER ROOM AND ELECTRICAL ROOM AT 10'-0" AFF.
- 15. ELECTRICAL SERVICE ENTRY SECTION/PANELS. 16. LINE OF CANOPY/BALCONY/OVERHANG ABOVE.


#### **GENERAL NOTES**

MECHANICAL EQUIPMENT.

A. ON ALL EXPOSED METALWORK WELDS AND BRANDS TO BE GROUND VERY SMOOTH AND PAINTED. B. ALL ROOF MOUNTED MECHANICAL EQUIPMENT SHALL BE FULLY SCREENED BY PARAPET WALLS EQUAL TO OR GREATER THAN, THE HIGHEST POINT ON THE

(Sheet Title) CONCEPTUAL FLOOR PLANS -**BUILDING '3'** 

A2.03A

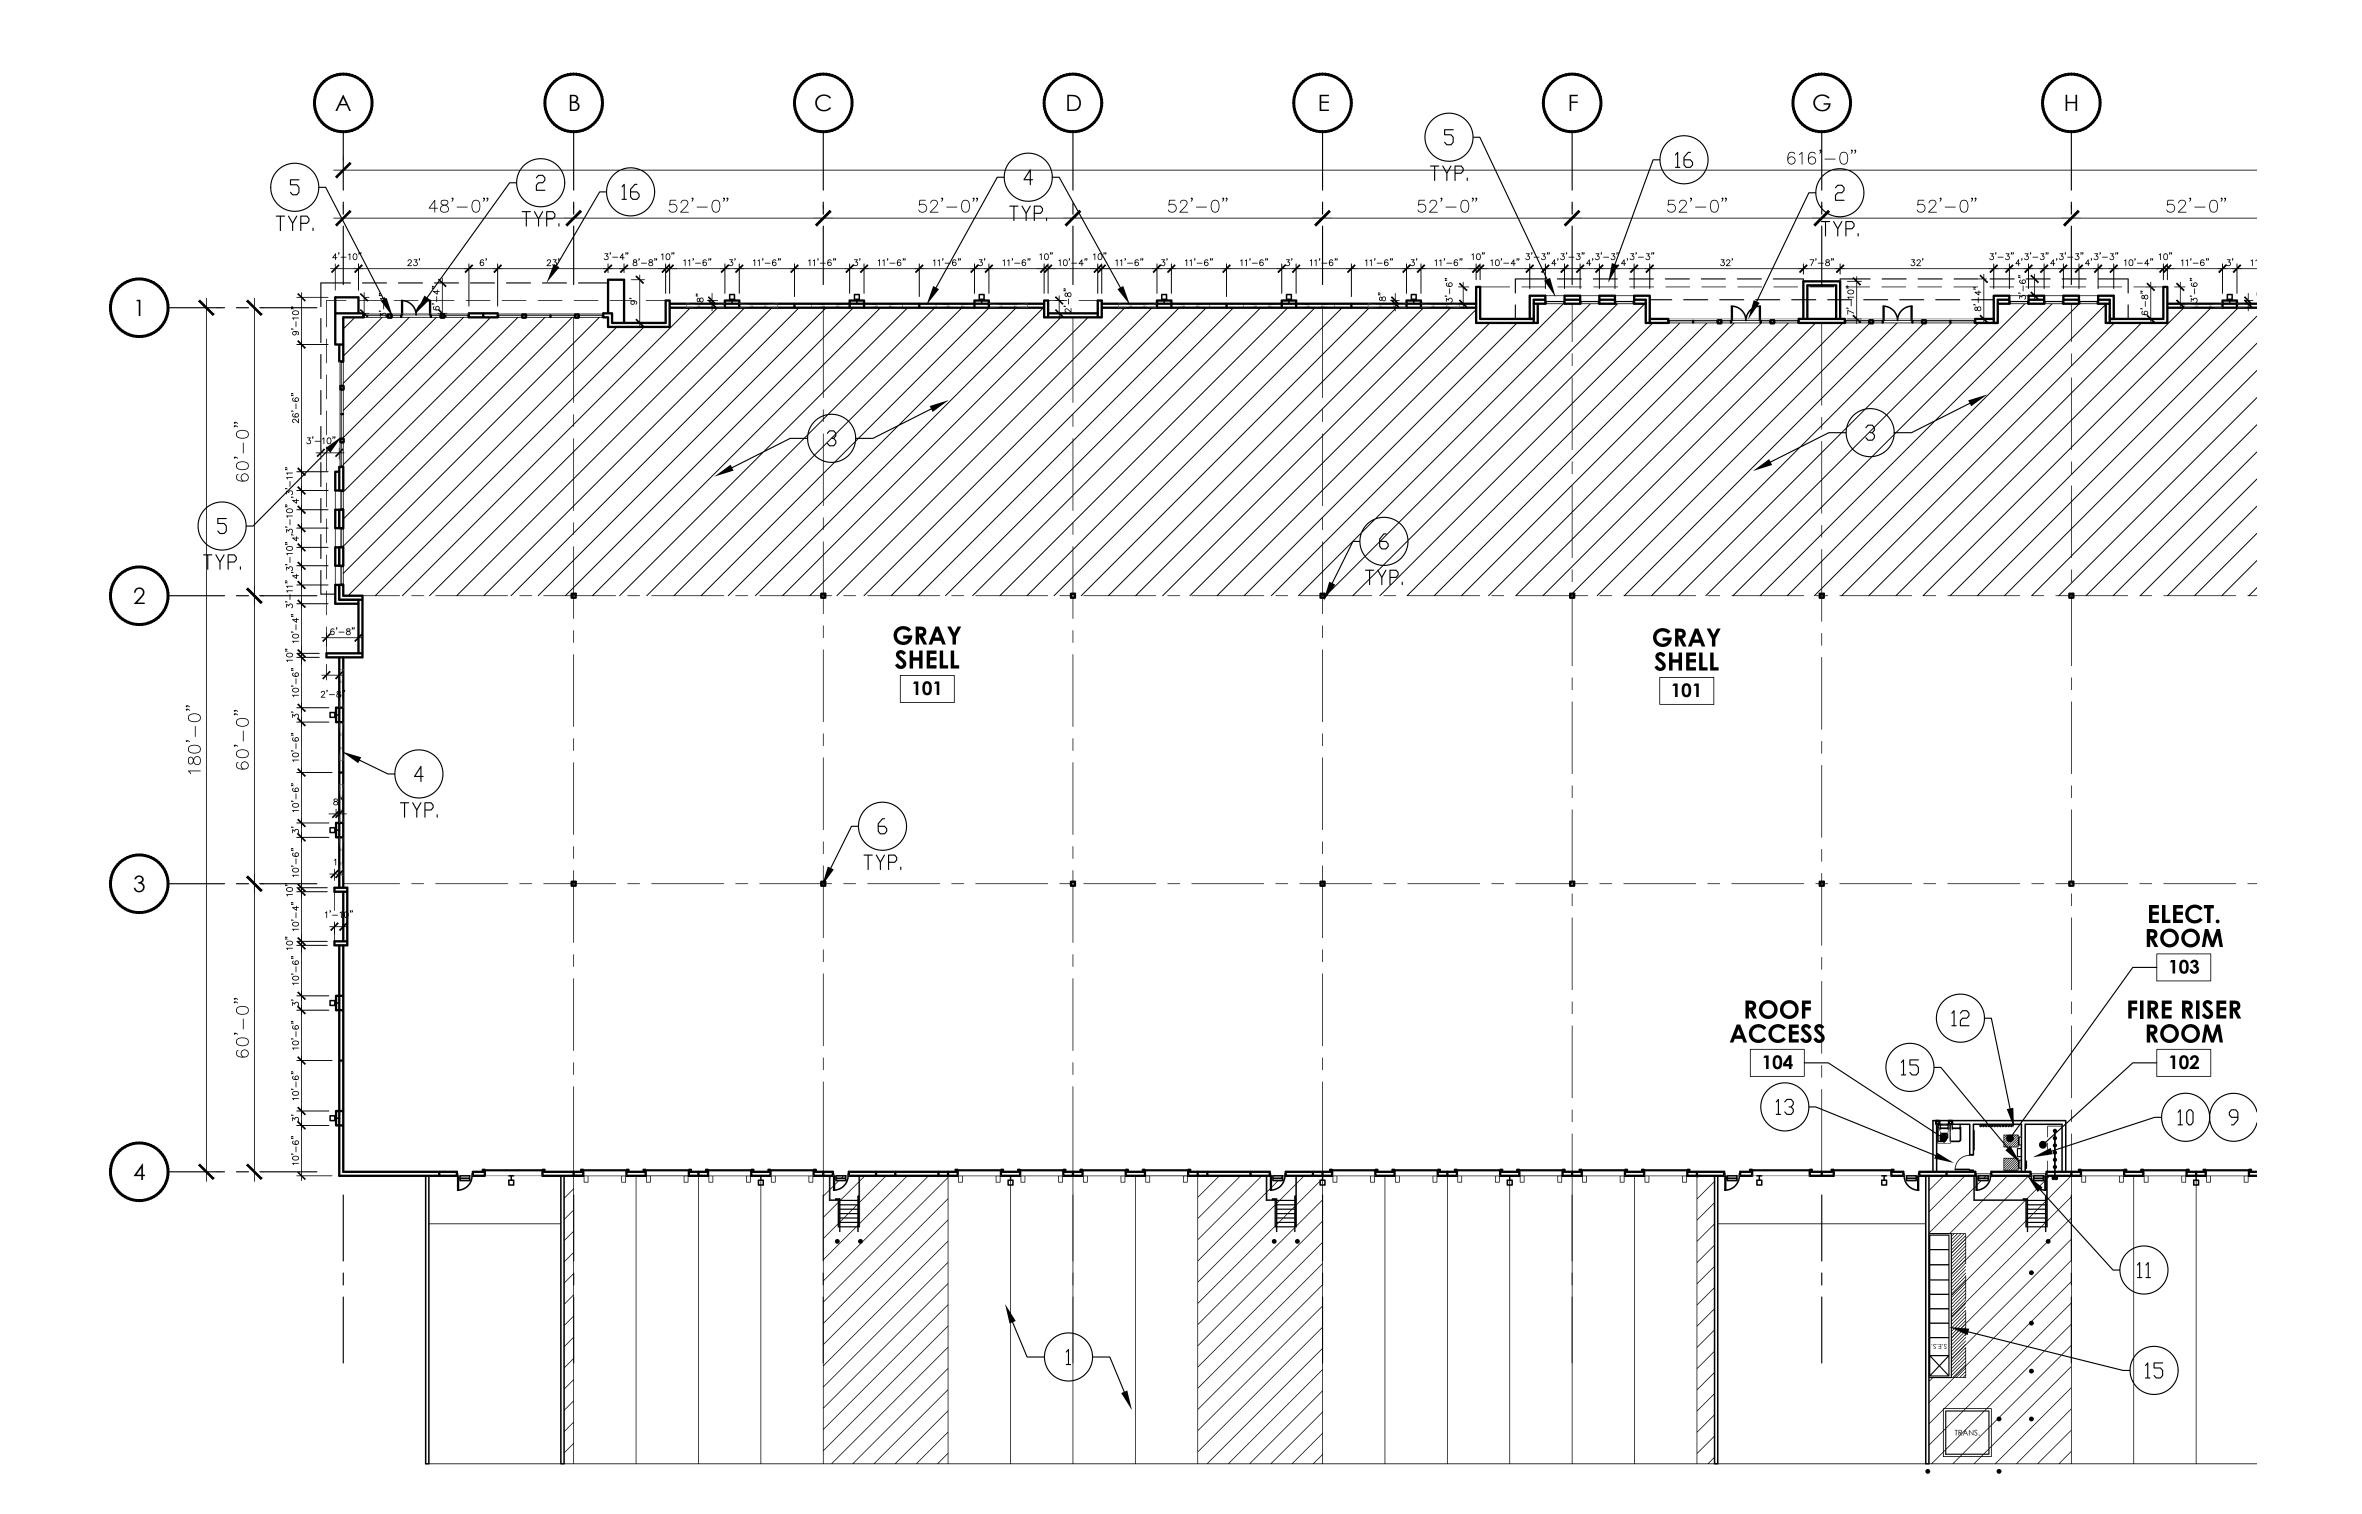

# BUILDING 3 - PARTIAL FLOOR PLAN

#### KEYNOTES (PLAN)

NOTE: THE KEYNOTES LISTED BELOW ARE TYPICAL TO THE BUILDINGS AND MAY NOT BE APPLICABLE AND/OR REFERENCED ON ALL SHEETS.

CONCRETE SLAB OVER ABC ON GRADE - SLOPE AWAY FROM BUILDING - SEE SITE PLAN FOR FINISH & CIVIL FOR GRADES - 2% MAX.

SCALE: 1" = 20'-0"

- 2. DOUBLE ENTRY DOORS W/ANODIZED ALUMINUM
- STOREFRONT SYSTEM. 3. CONCRETE SLAB OVER VAPOR BARRIER (15 MIL. MIN.) ON ABC - REFER TO STRUCTURAL DRAWINGS, SOILS REPORT & SPECIFICATIONS. (HATCHED AREA)
- 4. PAINTED CONCRETE TILT-UP PANEL SEE BUILDING ELEVATIONS FOR MATERIAL SCHEDULE. 5. 1" GLAZING IN ANODIZED ALUMINUM SYSTEM - SEE BUILDING ELEVATIONS FOR MATERIAL SCHEDULE.
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- 10. PROVIDE DBX "AS-BUILT DRAWINGS" CABINET ADJACENT TO FIRE RISER LOCATION. 1. KNOX BOX FOR FIRE DEPARTMENT ACCESS WITH ALUMINUM ANNODIZED FINISH, RECESS MOUNTED AT

4'-6" A.F.F.

PLYWOOD TMB - BOTTOM AT 6" A.F.F.

12. PROVIDE 3/4" 4' x 8' FIRE RETARDANT TREATED

- 13. ROOF ACCESS HATCH & LADDER.14. 5/8" GYP. BD. BOTH SIDES OVER 8" METAL STUDS W/ 3 1/2" SOUND BATT FULL HEIGHT — GYPSUM SHEATHING FULL HEIGHT ON TENANT SIDE AND ROOF ACCESS ROOM - PROVIDE GYPSUM BD. CEILING IN FIRE RISER ROOM AND ELECTRICAL ROOM AT 10'-0" AFF.
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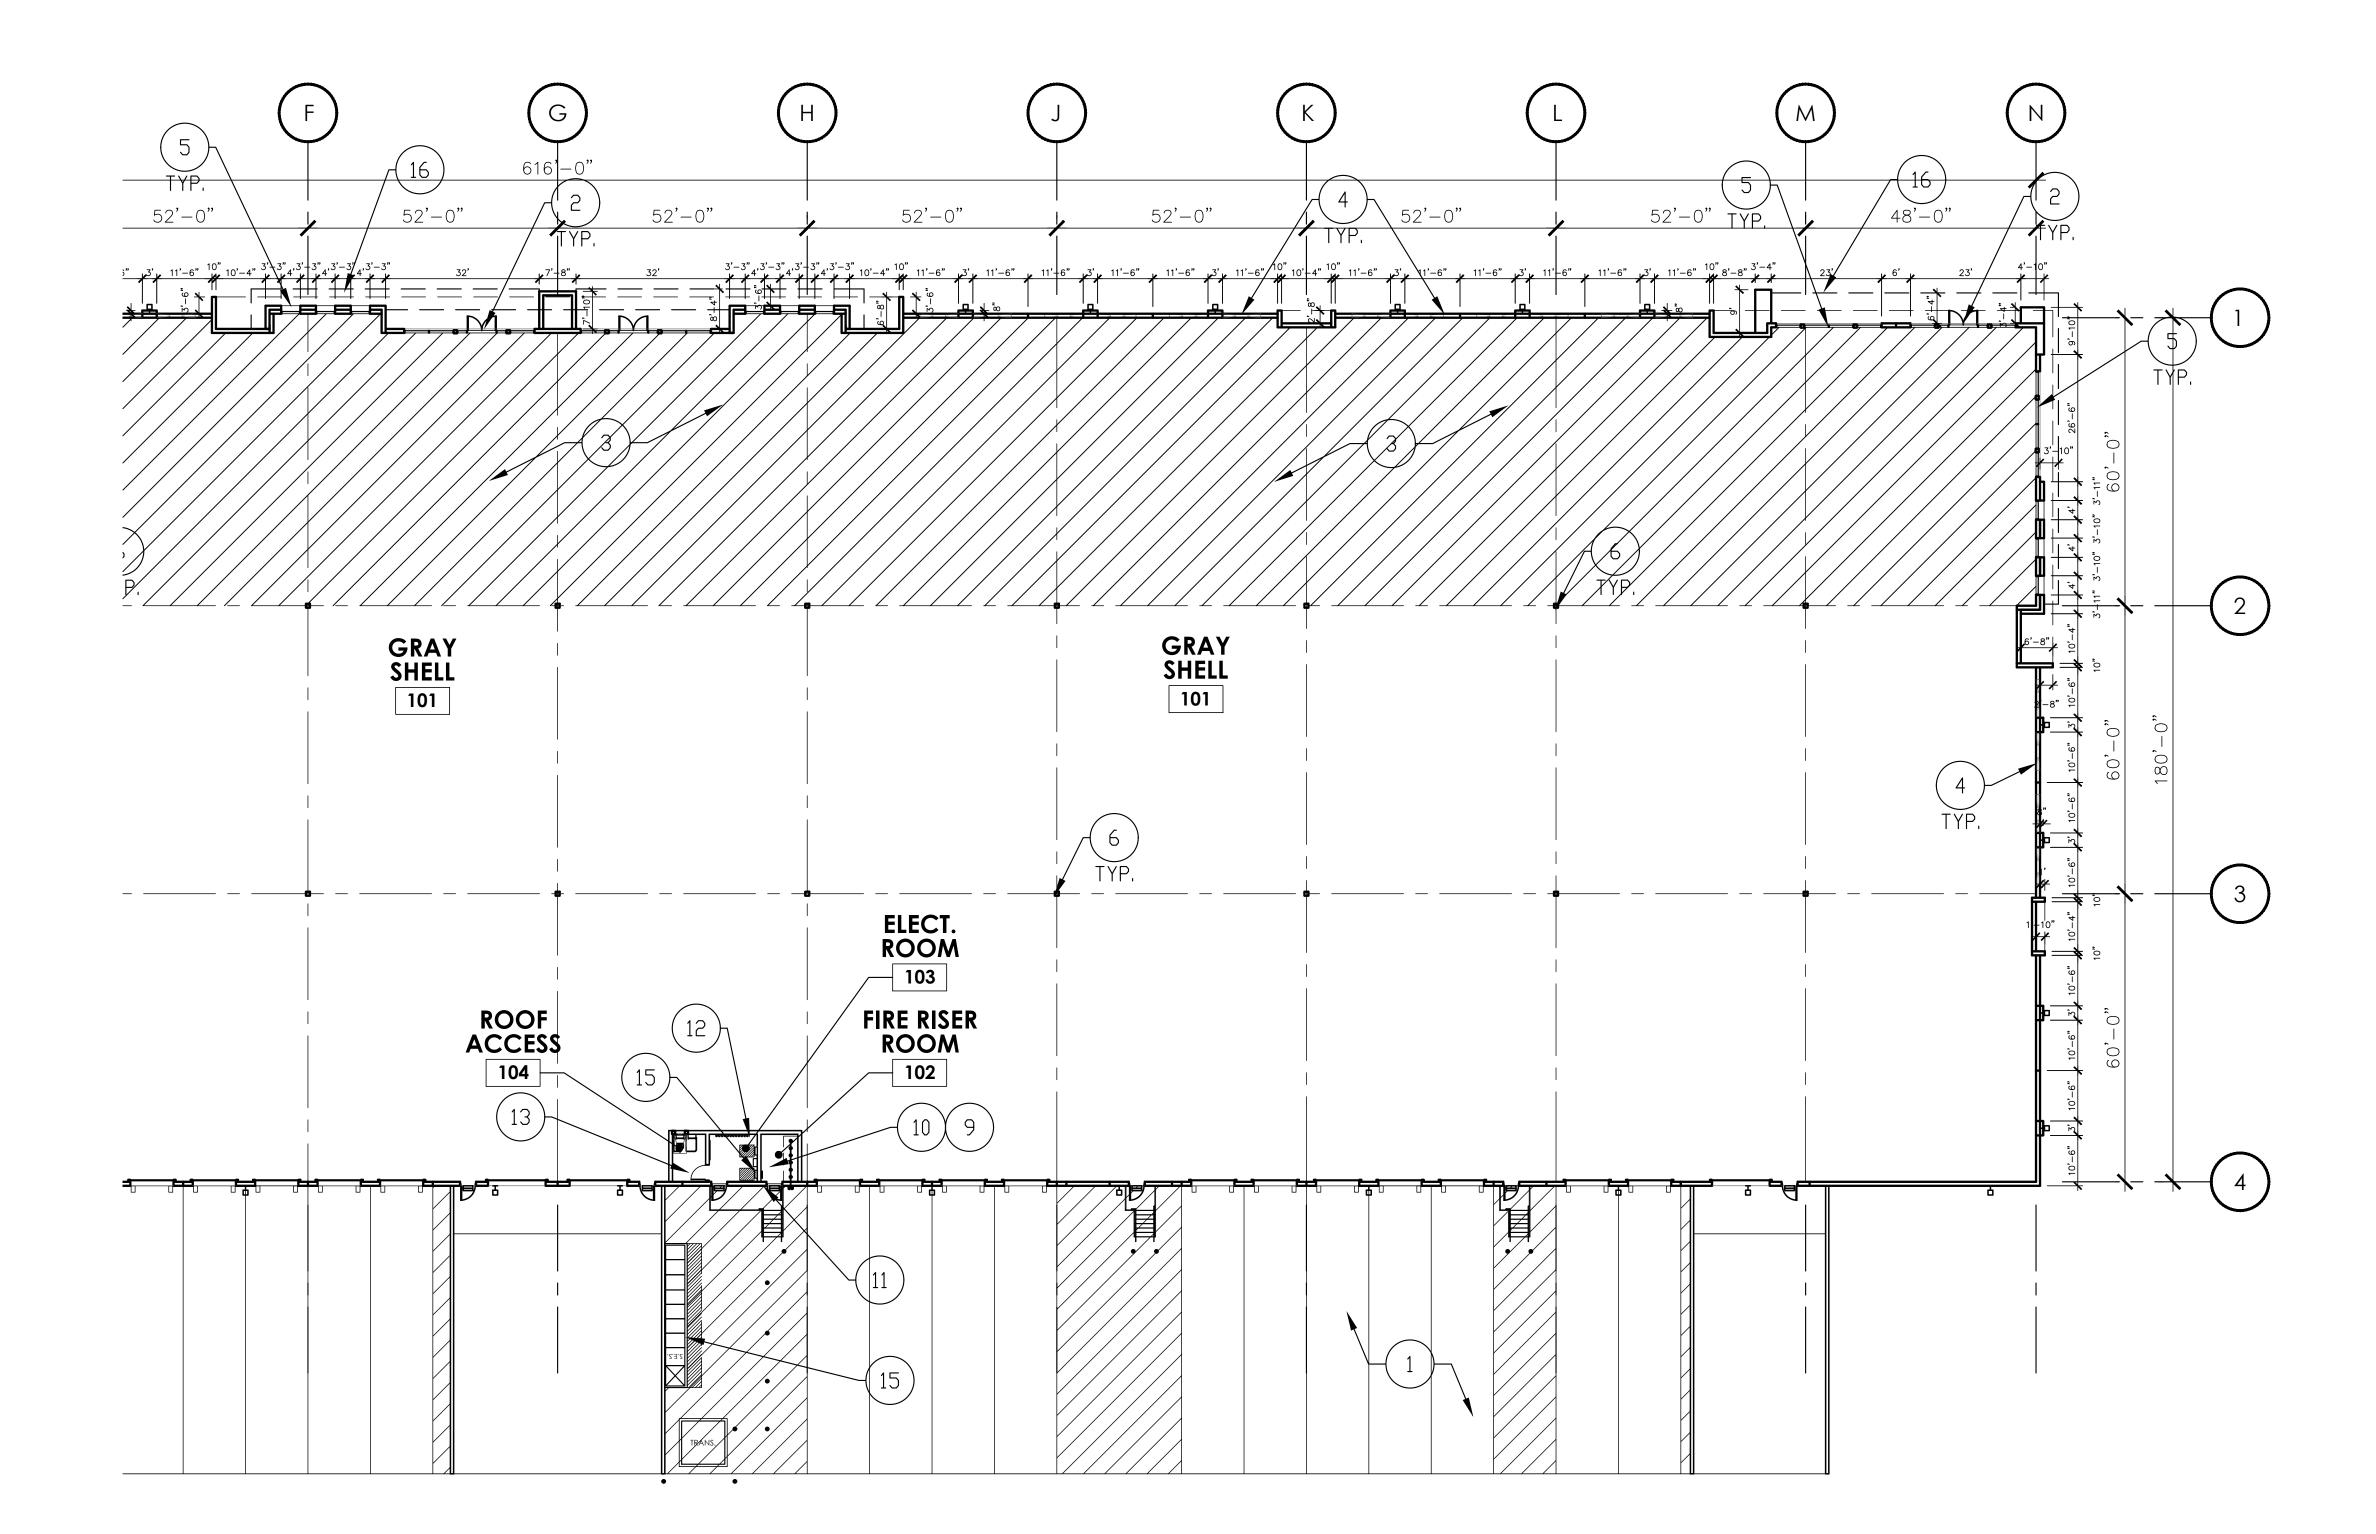
## **GENERAL NOTES**

A. ON ALL EXPOSED METALWORK WELDS AND BRANDS TO BE GROUND VERY SMOOTH AND PAINTED. B. ALL ROOF MOUNTED MECHANICAL EQUIPMENT SHALL

BE FULLY SCREENED BY PARAPET WALLS EQUAL TO OR GREATER THAN, THE HIGHEST POINT ON THE MECHANICAL EQUIPMENT.

**BUILDING '3'** 

A2.03B



# BUILDING 3 - PARTIAL FLOOR PLAN

#### SCALE: 1" = 20'-0"

#### **KEYNOTES (PLAN)**

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- S. HSS COLUMN SEE STRUCTURAL. INDEPENDENT ROOF AND OVERFLOW DRAIN LEADERS ROOF DRAIN AND OVERFLOW DRAIN LEADER TO DAYLIGHT AT FACE OF WALL.
- 9. FIRE RISER LOCATION SEE FIRE SPRINKLER DRAWINGS.
- 10. PROVIDE DBX "AS-BUILT DRAWINGS" CABINET ADJACENT TO FIRE RISER LOCATION. 1. KNOX BOX FOR FIRE DEPARTMENT ACCESS WITH
- 8. NOT USED
- ALUMINUM ANNODIZED FINISH, RECESS MOUNTED AT 4'-6" A.F.F.
- **GENERAL NOTES**

AFF.

A. ON ALL EXPOSED METALWORK WELDS AND BRANDS TO BE GROUND VERY SMOOTH AND PAINTED. B. ALL ROOF MOUNTED MECHANICAL EQUIPMENT SHALL BE FULLY SCREENED BY PARAPET WALLS EQUAL TO OR GREATER THAN, THE HIGHEST POINT ON THE MECHANICAL EQUIPMENT.

12. PROVIDE 3/4" 4' x 8' FIRE RETARDANT TREATED

13. ROOF ACCESS HATCH & LADDER.14. 5/8" GYP. BD. BOTH SIDES OVER 8" METAL STUDS W/ 3 1/2" SOUND BATT FULL HEIGHT — GYPSUM SHEATHING

FULL HEIGHT ON TENANT SIDE AND ROOF ACCESS


ROOM - PROVIDE GYPSUM BD. CEILING IN FIRE

RISER ROOM AND ELECTRICAL ROOM AT 10'-0"


15. ELECTRICAL SERVICE ENTRY SECTION/PANELS.

16. LINE OF CANOPY/BALCONY/OVERHANG ABOVE.

**BUILDING '4'** 

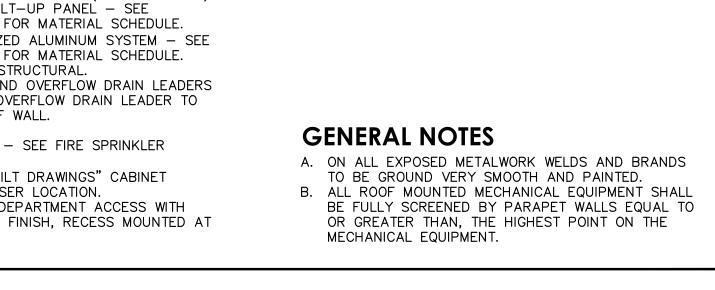

AFF.

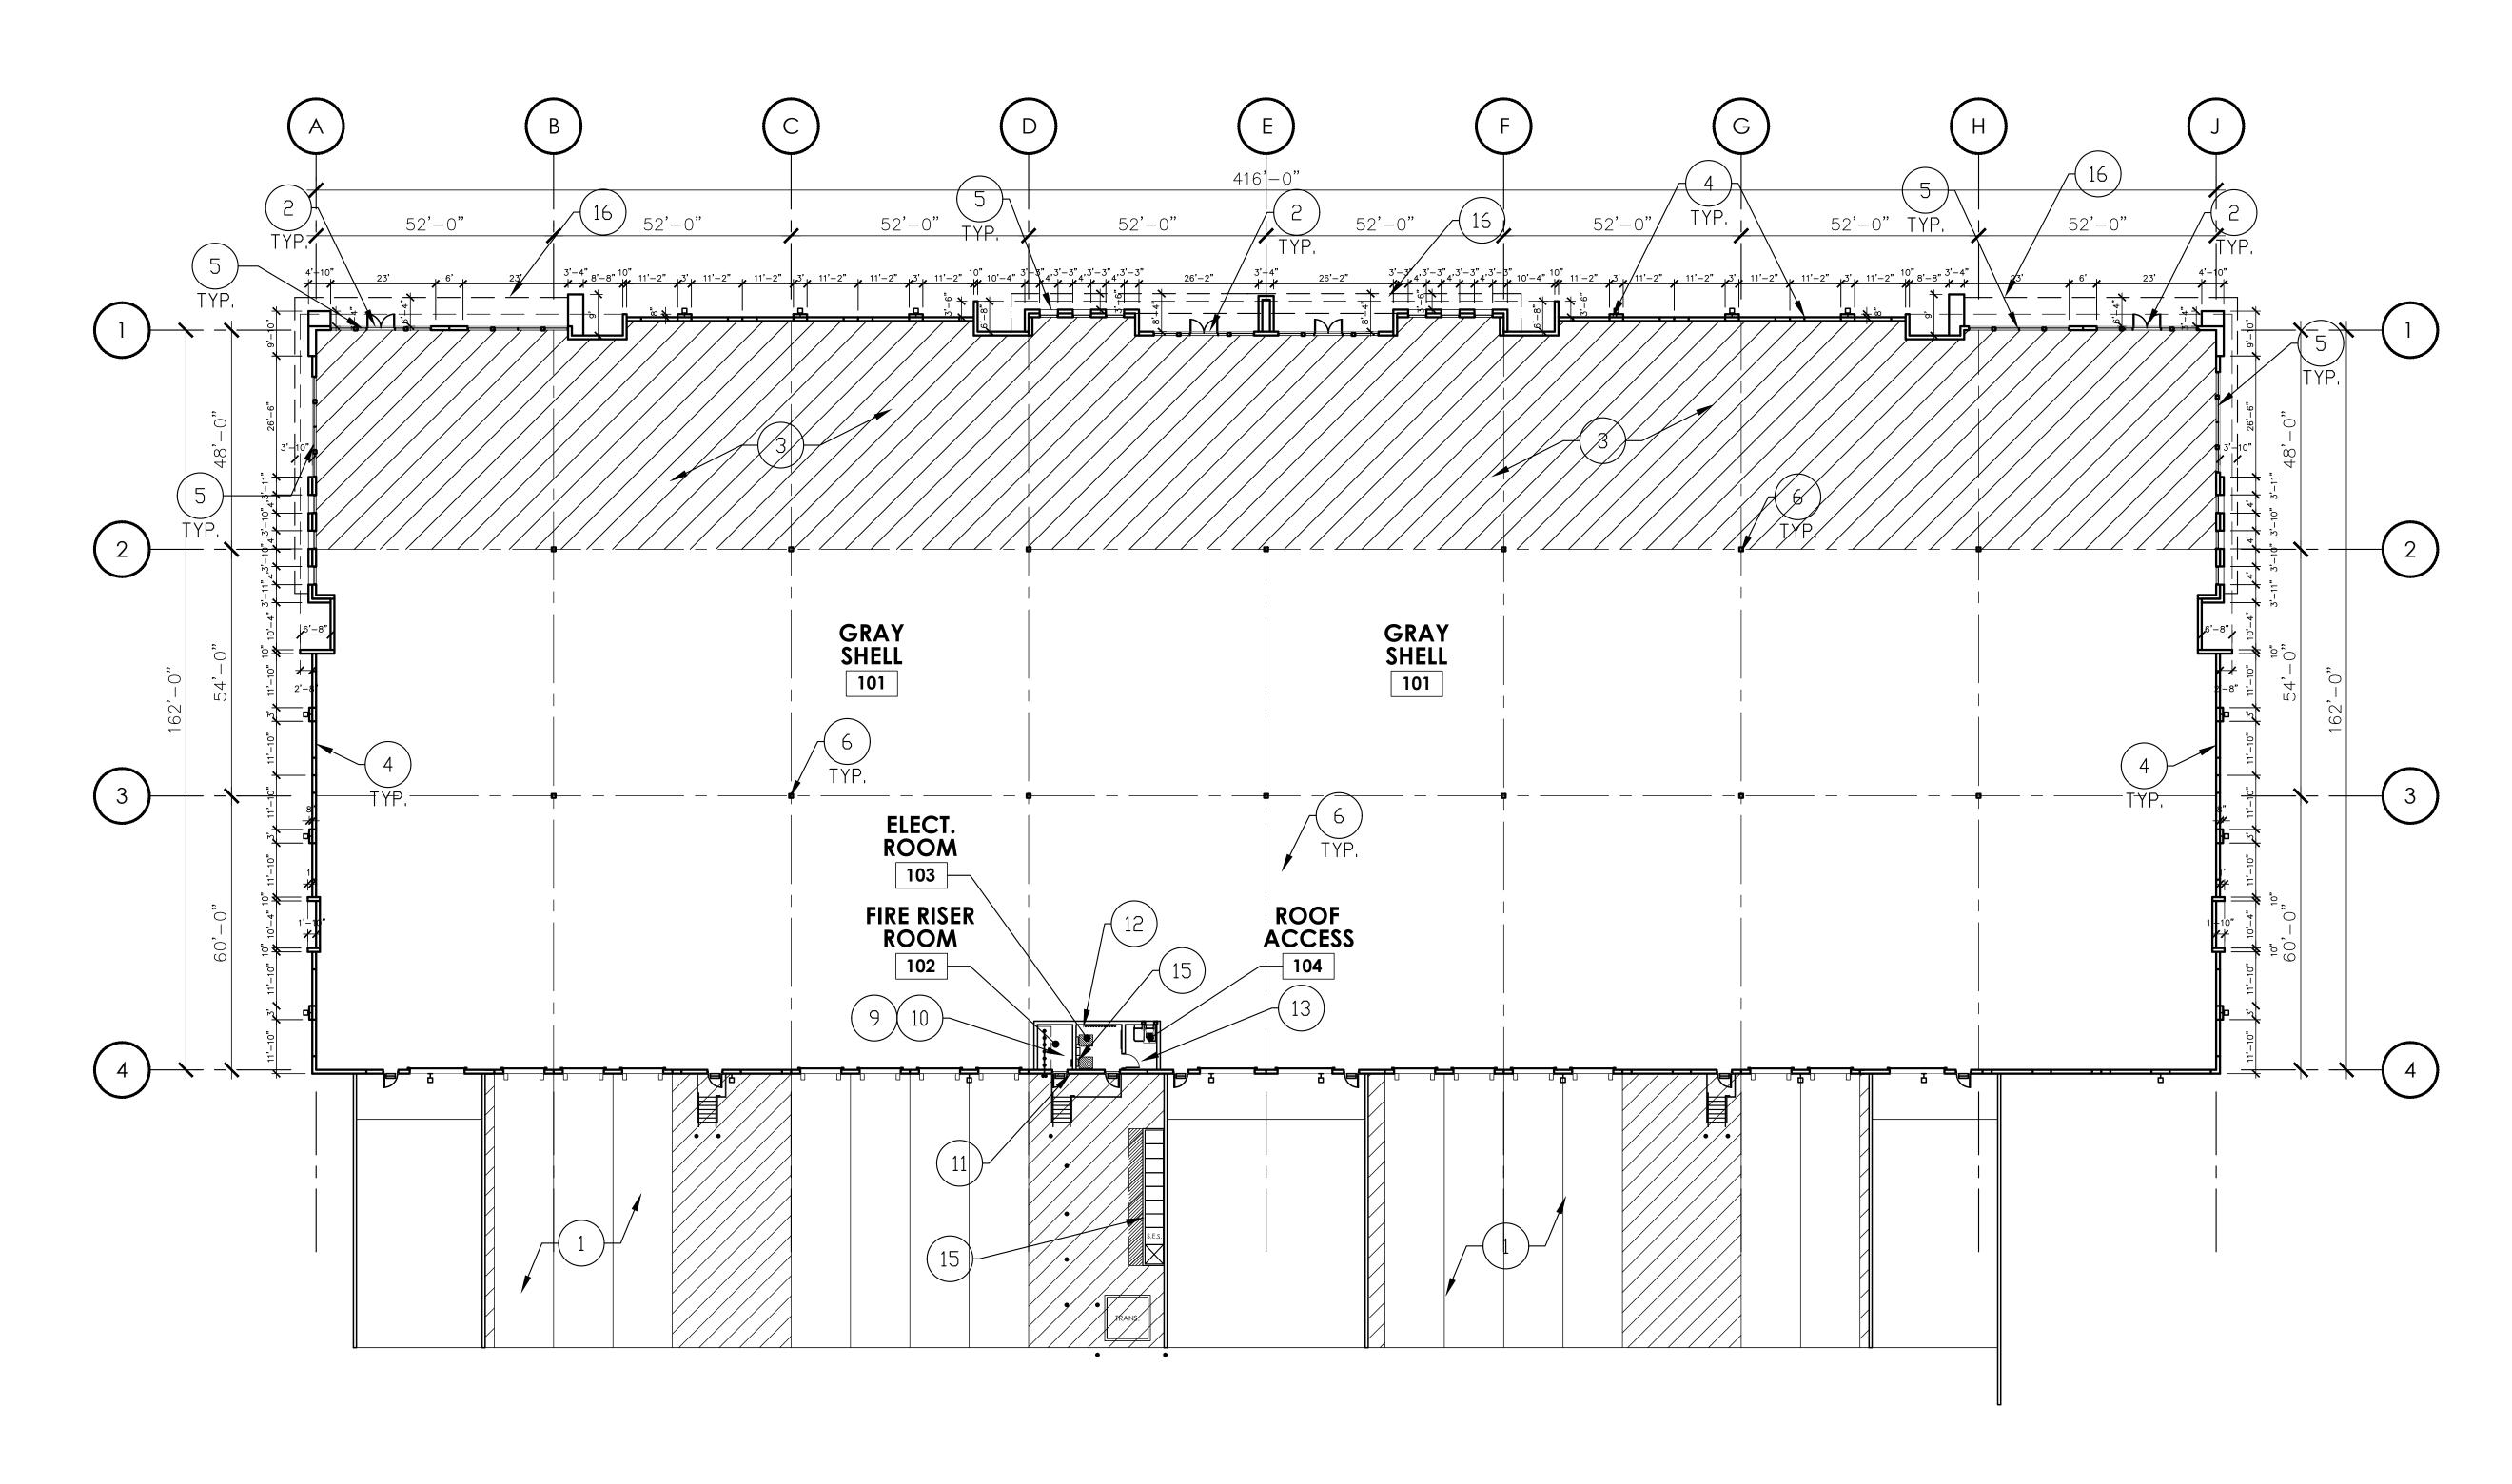

#### BUILDING 4 - FLOOR PLAN

12. PROVIDE 3/4" 4' x 8' FIRE RETARDANT TREATED

13. ROOF ACCESS HATCH & LADDER.14. 5/8" GYP. BD. BOTH SIDES OVER 8" METAL STUDS W/ 3 1/2" SOUND BATT FULL HEIGHT — GYPSUM SHEATHING

FULL HEIGHT ON TENANT SIDE AND ROOF ACCESS

ROOM - PROVIDE GYPSUM BD. CEILING IN FIRE

RISER ROOM AND ELECTRICAL ROOM AT 10'-0"

PLYWOOD TMB - BOTTOM AT 6" A.F.F.

SCALE: 1" = 20'-0"

#### **KEYNOTES (PLAN)**

NOTE: THE KEYNOTES LISTED BELOW ARE TYPICAL TO THE BUILDINGS AND MAY NOT BE APPLICABLE AND/OR REFERENCED ON ALL SHEETS.

- CONCRETE SLAB OVER ABC ON GRADE SLOPE AWAY FROM BUILDING - SEE SITE PLAN FOR FINISH & CIVIL FOR GRADES - 2% MAX.
- 2. DOUBLE ENTRY DOORS W/ANODIZED ALUMINUM
- STOREFRONT SYSTEM. 3. CONCRETE SLAB OVER VAPOR BARRIER (15 MIL. MIN.) ON ABC - REFER TO STRUCTURAL DRAWINGS, SOILS REPORT & SPECIFICATIONS. (HATCHED AREA) 4. PAINTED CONCRETE TILT-UP PANEL - SEE
- BUILDING ELEVATIONS FOR MATERIAL SCHEDULE. 5. 1" GLAZING IN ANODIZED ALUMINUM SYSTEM - SEE
- ROOF DRAIN AND OVERFLOW DRAIN LEADER TO DAYLIGHT AT FACE OF WALL.
- 8. NOT USED 9. FIRE RISER LOCATION - SEE FIRE SPRINKLER DRAWINGS.
- 10. PROVIDE DBX "AS-BUILT DRAWINGS" CABINET
- 15. ELECTRICAL SERVICE ENTRY SECTION/PANELS. 16. LINE OF CANOPY/BALCONY/OVERHANG ABOVE.
- BUILDING ELEVATIONS FOR MATERIAL SCHEDULE. S. HSS COLUMN — SEE STRUCTURAL. INDEPENDENT ROOF AND OVERFLOW DRAIN LEADERS
- ADJACENT TO FIRE RISER LOCATION. 1. KNOX BOX FOR FIRE DEPARTMENT ACCESS WITH ALUMINUM ANNODIZED FINISH, RECESS MOUNTED AT 4'-6" A.F.F.