



DELETIONS:		ALL	KEYNOTES MAY NOT BE USED			I0:29
OUND. PLACED	ш	3.	STANDING SEAM METAL PANE	EDULE FOR FINISH AND COLOR EL ROOF SYSTEM		6/18/2021 6:10:29
	0 Z	5.	METAL FASCIA - PAINT PER CO METAL AWNING - REFER TO DI SCHEDULE STEEL COLUMNS / BEAMS	DLOR SCHEDULE ETAILS SHEET A8.7 AND COLOR		
	KΕΥ	7.	ALUMINUM STOREFRONT SYST PARAPET WALL WITH PARAPET			PRINTED:
	TION	11.	CAST-IN-PLACE CONCRETE - 1 STEEL GUARDRAIL - WITH DEC REFER TO COLOR SCHEDULE	ORATIVE STEEL SHEET PANEL -		
	ΕVΑ	13. 14. 15.	STUCCO CONTROL JOINT - SE FOAM POP-OUT FOAM POP-OUT AT WINDOW CHIMNEY	SILL		
		16. 17. 18.	GARAGE DOOR/ ROLLING SH	HUTTER O MATCH WALL WHERE OCCURS		
		20. 21. 22.	DOOR - PER PLAN DECORATIVE METAL EYEBROV AWNING STEEL SUPPORT ROD			
		24. 25.	FABRIC SHADE CONCRETE WINDOW SILL STANDING SEAM METAL ROO PAINTED STEEL BEAM	FING		
		27. 28. 29.	FASCIA FINISH CONTROL JOINT DECORATIVE METAL GUARDR	AIL		
		30.	FOAM CHAIR RAIL POP OUT			
	TES		PAINT ALL VENTS, FLASHING, N			
	0		ADJACENT BUILDING COLOR STUCCO TEXTURE IS GUN DASI	U.N.O.		
		3.	GEN. CONTRACTOR. VERIFY ALL FINISHES WITH GEN		CS ERED ARCHIER	
	G E N E	4.	APPLICATION VERIFY ALL COLOR SELECTION OWNER PRIOR TO APPLICATIC	IS WITH COLORED ELEVATIONS & DN.	BRIAN BURTON	
	-	5.	ALL PAINT COLOR CHANGES T CORNERS ONLY	TO TERMINATE ON INSIDE	9 gne07/26/2021	
			ROOFING SHALL BE INSTALLED W/MANUFACTURER'S SPECIFIC PROVIDE SEALANT AT ALL STUC	CATIONS.	ONA, C	
		8.	ALL CONTROL JOINTS & REVE/ CORNERS ONLY			
			HORIZONTAL GROUT LINES TO VERTICAL GROUT LINES TO BE			
		11.	ANTI-GRAFFITI COATING AT CI COATING TO EXTEND UP TO 21	MU WALLS/VENEER (@ BUILDINGS ND FINISH FLOOR)		
			ALL EXTERIOR MISC. METALS TO POWDER COATED AS PER OW			
	ULE		COLOR S (STUCCO TEXTURI			
	HED			COLOR/ FINISH	7/26/2021 CITY REVIEW (P&Z)	
	r SC		STUCCO COLOR 1	DE6213 - FINE GRAIN	NO DATE DESCRIPTION THE PREMIERE AT EASTMARK 3.0	
	0101	В	STUCCO COLOR 2	COLOR: DUNN EDWARDS DE6214 PIGEON GRAY	JENNINGS HOLDINGS L.L.C.	
	С М	С	STUCCO COLOR 3	COLOR: DUNN EDWARDS DE6378 JET	5029 S. ELLSWORTH RD. MESA, AZ ARCHISTRUCT LLC	
	ERIO		STUCCO COLOR 4	COLOR: DUNN EDWARDS	345 N. BEVERLY MESA, AZ 85201 TEL: (602) 750-0445 WWW.ARCHISTRUCTDB.COM	
	EXT			DE6376 LOOKING GLASS	THE OWNER, ARCHITECT, AND ENGINEER EXPRESSLY DISCLAIM ANY RESPONSIBILITY ARISING FROM ANY UNAUTHORIZED USE OF THESE PLANS, DRAWINGS, AND NOTES. ANY AUTHORIZATION MUST BE IN WRITING.	
		E	METAL FASCIA/ BALCONY FACE/ STEEL COLUMN	ANODIZED BRONZE	THIS DRAWING COPY MAY HAVE BEEN REPRODUCED AT A SIZE DIFFERENT THAN ORIGINALLY DRAWN. THE OWNER, ARCHITECT, AND ENGINEER ASSUME NO RESPONSIBILITY FOR THE USE OF INCORRECT SCALE.	
		F	HORIZONTAL METAL SIDING	COLOR TO MATCH: DUNN EDWARDS DE6376 LOOKING GLASS		
		G	STANDING SEAM METAL	COLOR TO MATCH: DUNN EDWARDS DE6376 LOOKING GLASS		
		Н	CMU WALL/ VENEER	SANDBLASTED NATURAL GREY FINISH		
		IJ	RAILINGS / STAIRS	DUNN EDWARDS DE6378 - JET		
		К	WINDOW FRAMES/ METAL AWNINGS	ANODIZED BRONZE		
			GLU-LAM BEAMS	CLEAR VARNISH		
		M	STUCCO COLOR 5	COLOR - WHITE	AHJ STAMP	
		L				
	ES	SII	NG			
Approved Fire Detail			-	mply with City of Mesa		
				ouilding/suite numbers,		
position as	to b	e p	n all new and existing plainly visible and legil property. Said numbe	ble from the street or		
their back	-				CITY PROJECT NUMBER:	
			or building number sh ed by any feature or f	nall be posted under a follage.	DRAWING TITLE: Clubhouse Exterior Elevations	
sign at ea	ch e	ntro	ance facing the desig	nan the first story or on a gnated property address.	PROJECT NO: DRAWING NUMBER:	
	hall I	be	a minimum 12" high w		A1.6A	

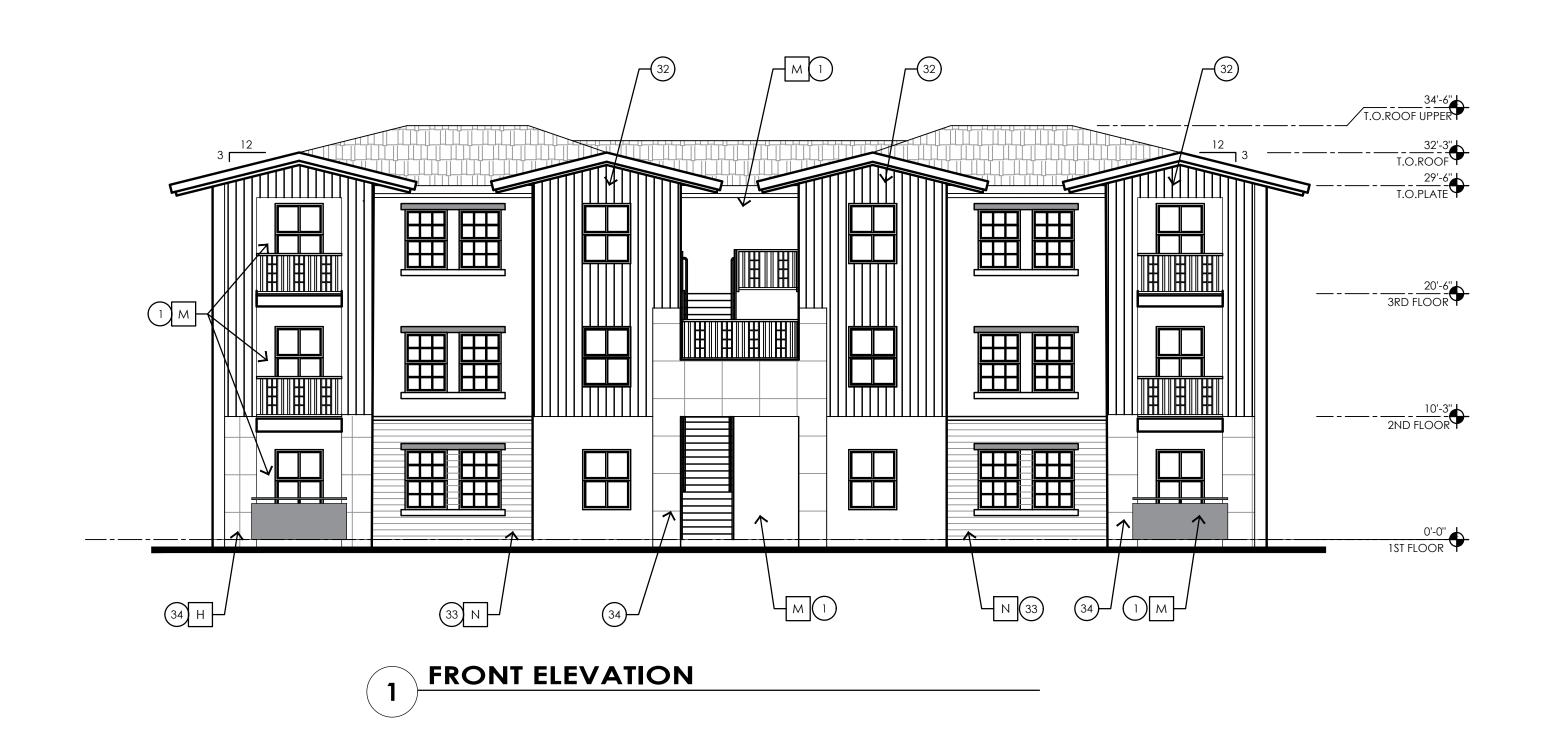

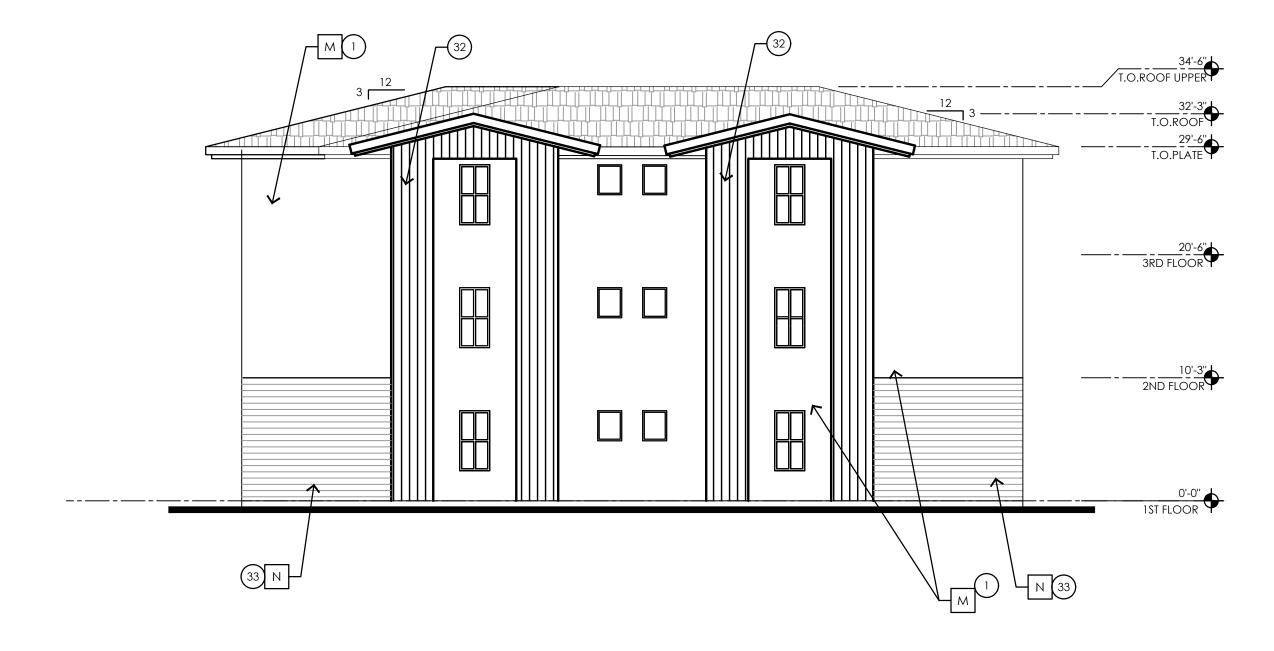









ALTERNATE EXTERIOR ELEVATION ELEMENT SUBSTITUTIONS AND/OR DELETION 1. METAL SIDING CAN BE REDUCED TO 6'-8" (EYE LEVEL) FROM GROUND. AREA FROM WHICH METAL SIDING WAS REMOVED SHALL BE REPLACE WITH STUCCO.


LEVATION KEYNOTE	<ol> <li>PARAPET WALL WITH PARAPET</li> <li>EXPOSED 4X8X16 CMU - REFER</li> </ol>	EDULE FOR FINISH AND COLOR EL ROOF SYSTEM DLOR SCHEDULE ETAILS SHEET A8.7 AND COLOR EM METAL CAP R TO SCHEDULE FOR FINISH AND NATURAL GRAY ORATIVE STEEL SHEET PANEL - E DETAIL 9/A8.6 SILL UTTER D MATCH WALL WHERE OCCURS VS 18" PROJECTION - SEE DETAILS SHEET A8.7. FING AIL PANELING - VERTICAL SEAMS ADDING		
	<ul><li>"ALIERNATES" FOR ADDITIONA GEN. CONTRACTOR.</li><li>3. VERIFY ALL FINISHES WITH GEN</li></ul>	U.N.O. HREFER TO SPECIFICATIONS L FINISH TYPE. COORDINATE WITH		
GENERAL	<ol> <li>VERIFY ALL COLOR SELECTION OWNER PRIOR TO APPLICATIO</li> <li>ALL PAINT COLOR CHANGES T CORNERS ONLY</li> </ol>	TO TERMINATE ON INSIDE IN ACCORDANCE CATIONS. CCO PENETRATIONS ALS TO TERMINATE ON INSIDE HAVE "V" CONTOUR FLUSH MU WALLS/VENEER (@ BUILDINGS ND FINISH FLOOR) D BE FILLED PAINTED, OR		BRIAN BURTON BRIAN BURTON BANDSTROM Brian Sandstrom Brian Sand
	COLOR S (STUCCO TEXTURE LOCATION			
EDULE	A STUCCO COLOR 1	COLOR: DUNN EDWARDS DE6213 - FINE GRAIN		
SCHI	B STUCCO COLOR 2	COLOR: DUNN EDWARDS DE6214 PIGEON GRAY		CITY REVIEW (P&Z)
OLOR	C STUCCO COLOR 3	COLOR: DUNN EDWARDS DE6378 JET	NO DATE	IERE AT EASTMARK 3.0
ы С	D STUCCO COLOR 4	COLOR: DUNN EDWARDS DE6376 LOOKING GLASS		INGS HOLDINGS L.L.C. ILLSWORTH RD. MESA, AZ
TERIO	E METAL FASCIA/ BALCONY FACE/ STEEL COLUMN	ANODIZED BRONZE	345 N. BEVER	RCHISTRUCT LLC RLY MESA, AZ 85201 W.ARCHISTRUCTDB.COM
Е X 	F HORIZONTAL METAL	COLOR TO MATCH: DUNN EDWARDS	ARISING FROM ANY UNAUTHOR	D ENGINEER EXPRESSLY DISCLAIM ANY RESPONSIBILITY IZED USE OF THESE PLANS, DRAWINGS, AND NOTES. ANY IORIZATION MUST BE IN WRITING.
	G STANDING SEAM METAL	DE6376 LOOKING GLASS COLOR TO MATCH: DUNN EDWARDS	ORIGINALLY DRAWN. TH	HAVE BEEN REPRODUCED AT A SIZE DIFFERENT THAN E OWNER, ARCHITECT, AND ENGINEER ASSUME NO ITY FOR THE USE OF INCORRECT SCALE.
	H CMU WALL/ VENEER	SANDBLASTED NATURAL		
		GREY FINISH DUNN EDWARDS		
		DE6378 - JET		
		ANODIZED BRONZE		
	L GLU-LAM BEAMS	CLEAR VARNISH		
	M STUCCO COLOR 5	COLOR - WHITE		
	N WOODEN PANEL	COLOR - BROWN	AHJ STAMP	
Fire Detail FPD Approved stre shall be place position as to b	ding Addressing must co 505.1. eet addressed, including l d on all new and existing be plainly visible and legi the property. Said numb	building/suite numbers, buildings in such a ble from the street or	CITY PROJECT NUMBER:	
No street addr	ress or building number st ucted by any feature or	-	DRAWING TITLE:	Building Type 1 Exterior Elevations
Address numb sign at each e	pers should be no lower th entrance facing the design be a minimum 12" high v	nan the first story or on a gnated property address.	PROJECT NO:	DRAWING NUMBER:




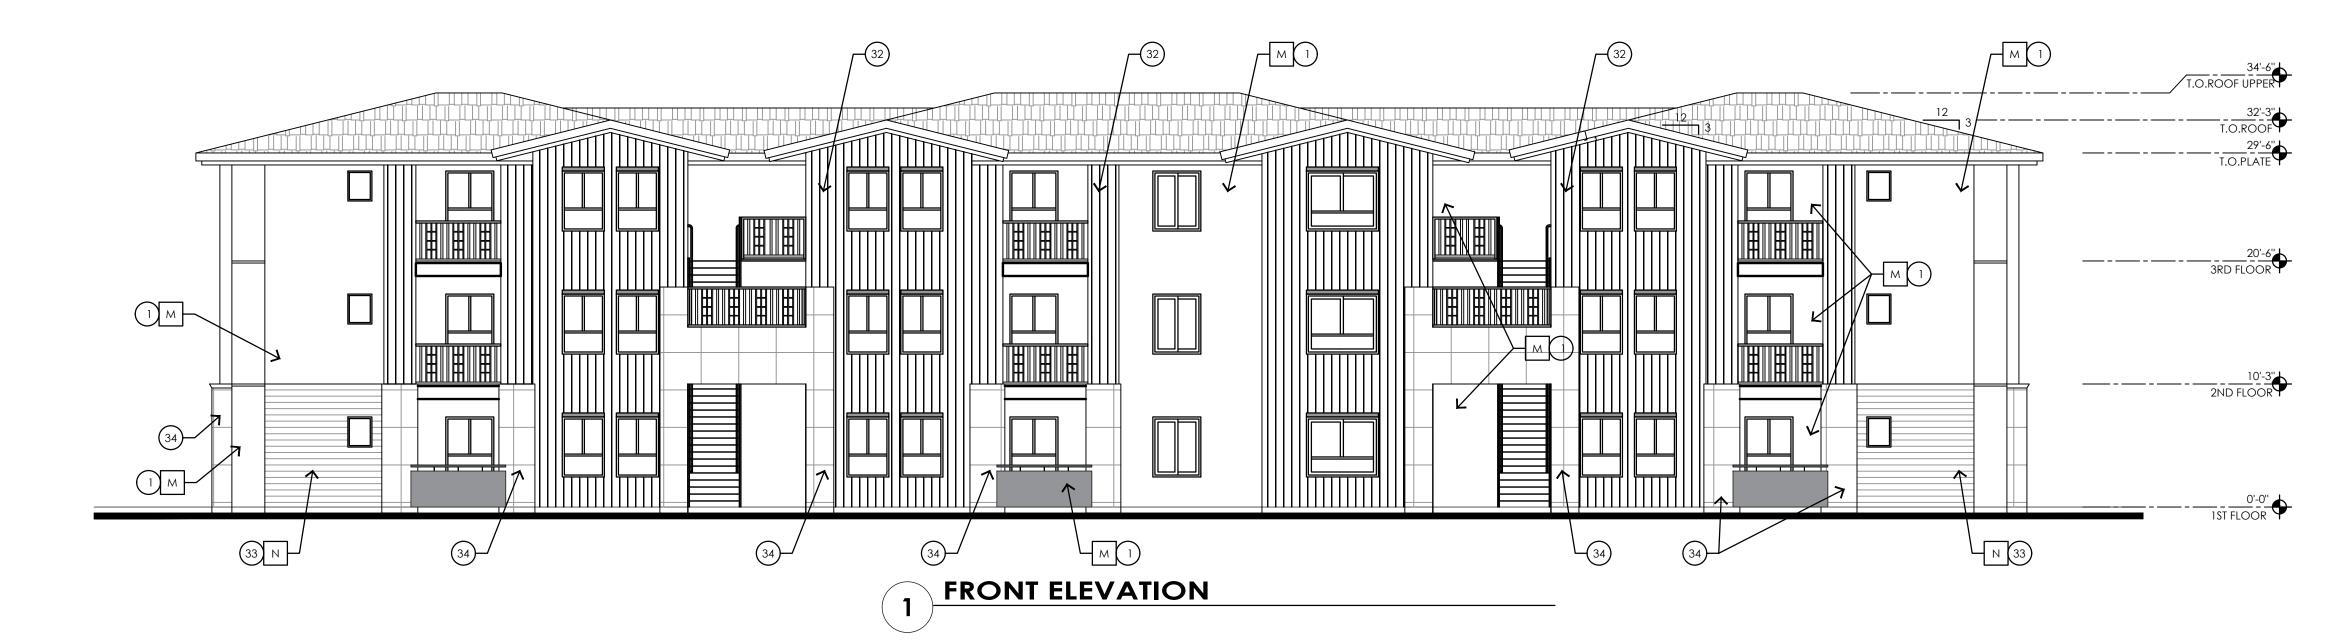

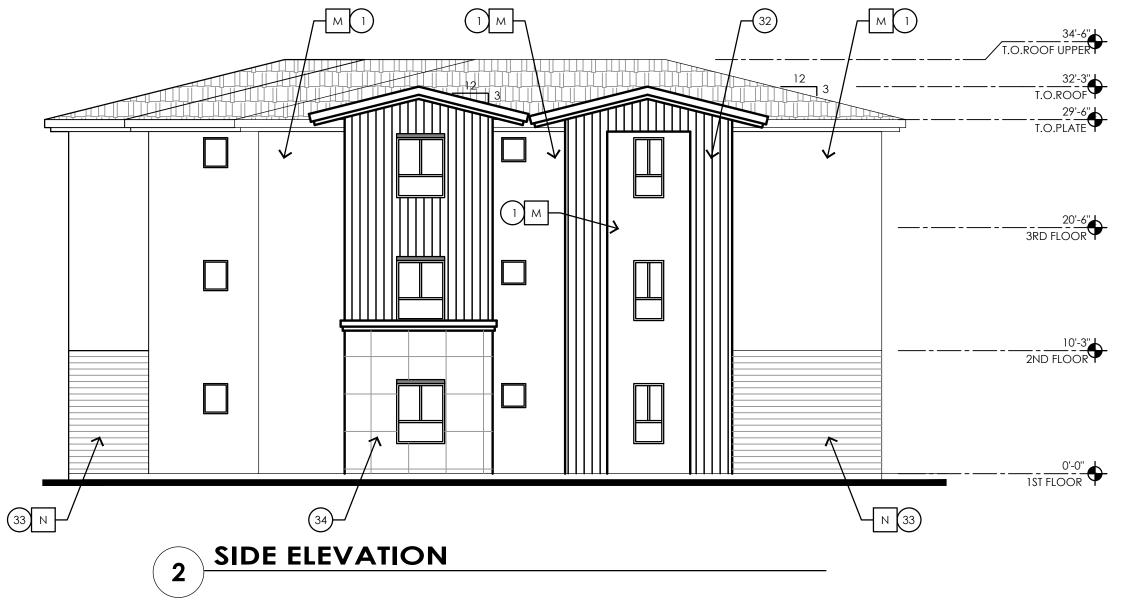


ALTERNATE EXTERIOR ELEVATION ELEMENT SUBSTITUTIONS AND/OR DELETIONS: 1. METAL SIDING CAN BE REDUCED TO 6'-8" (EYE LEVEL) FROM GROUND. AREA FROM WHICH METAL SIDING WAS REMOVED SHALL BE REPLACED WITH STUCCO.

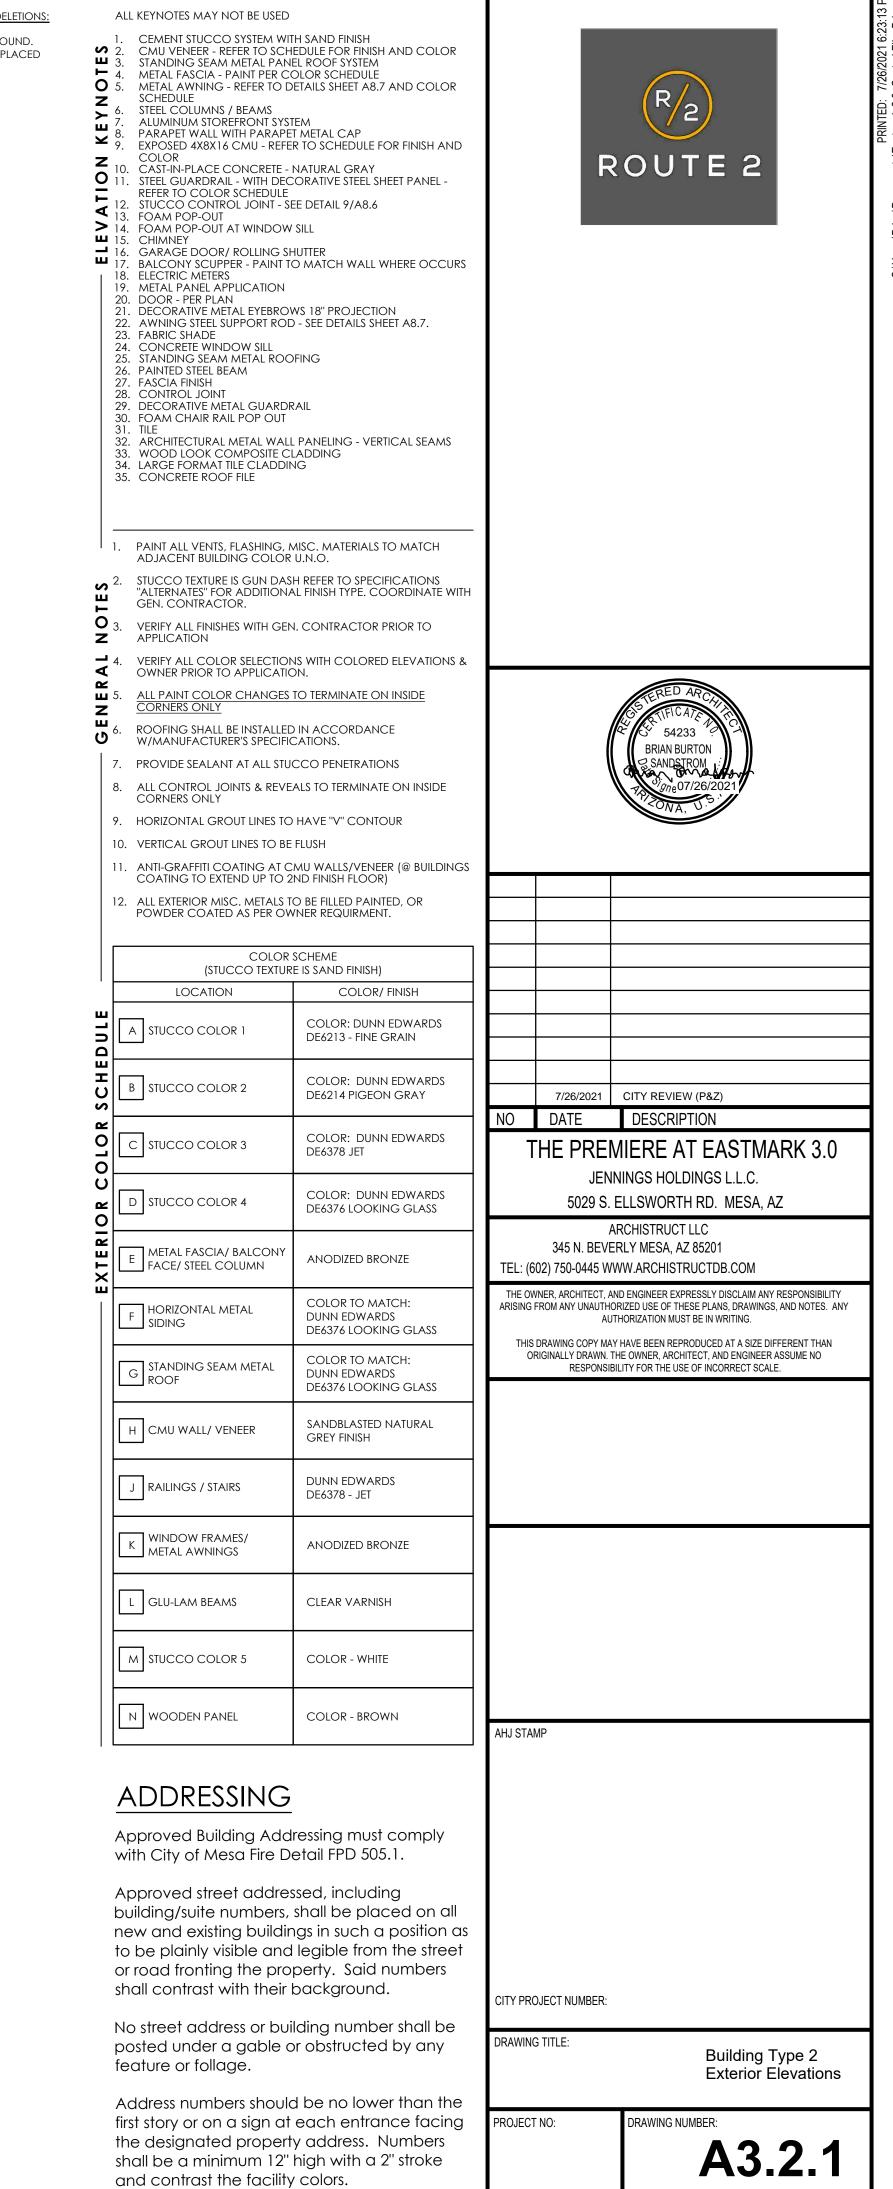


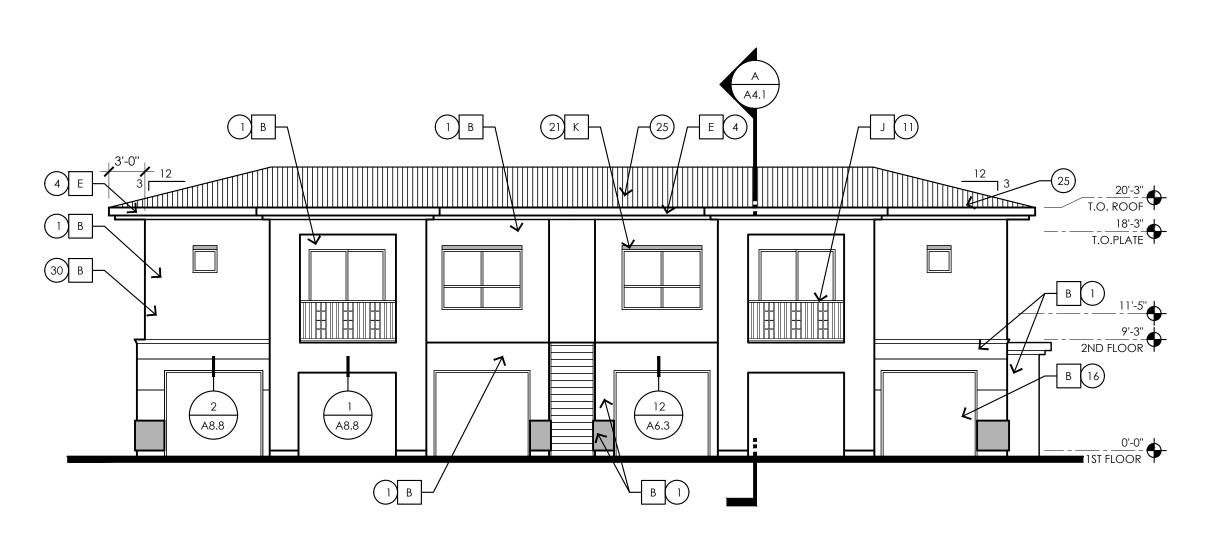



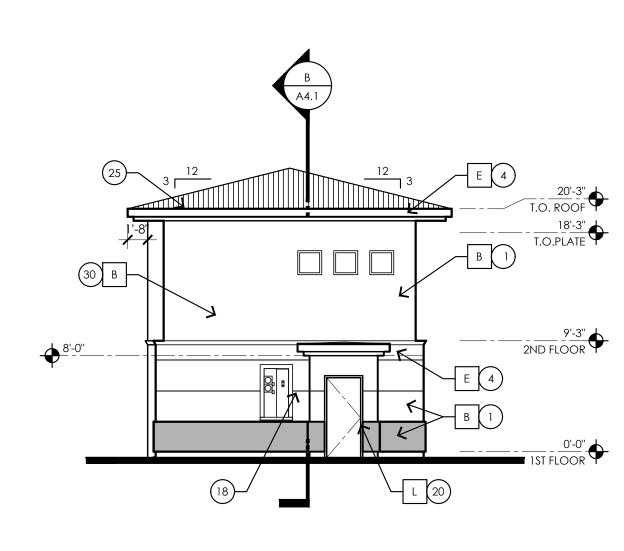




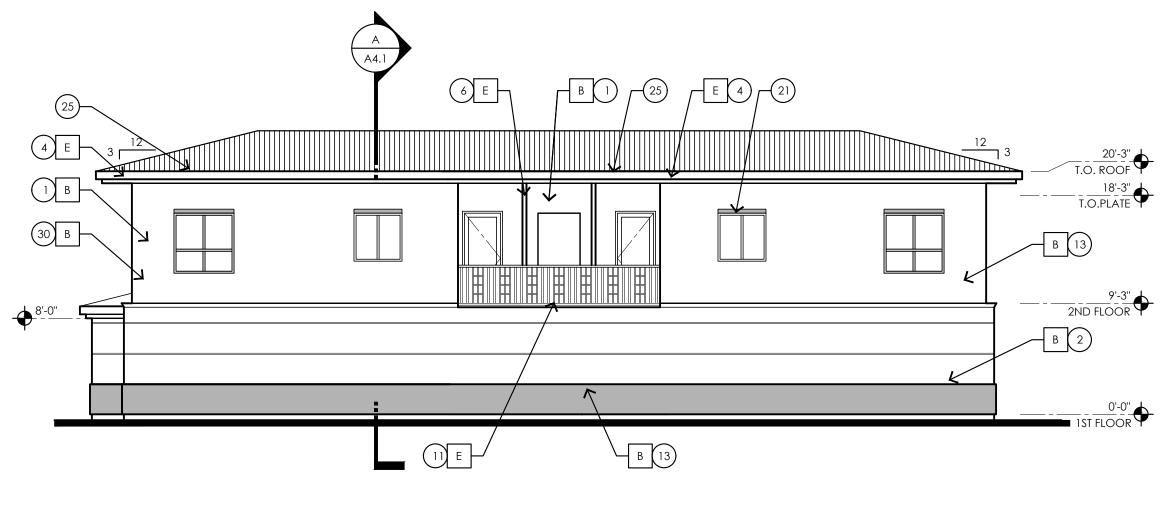

(4) REAR ELEVATION


## ALTERNATE EXTERIOR ELEVATION ELEMENT SUBSTITUTIONS AND/OR DELETIONS:

METAL SIDING CAN BE REDUCED TO 6'-8" (EYE LEVEL) FROM GROUND. AREA FROM WHICH METAL SIDING WAS REMOVED SHALL BE REPLACED WITH STUCCO.

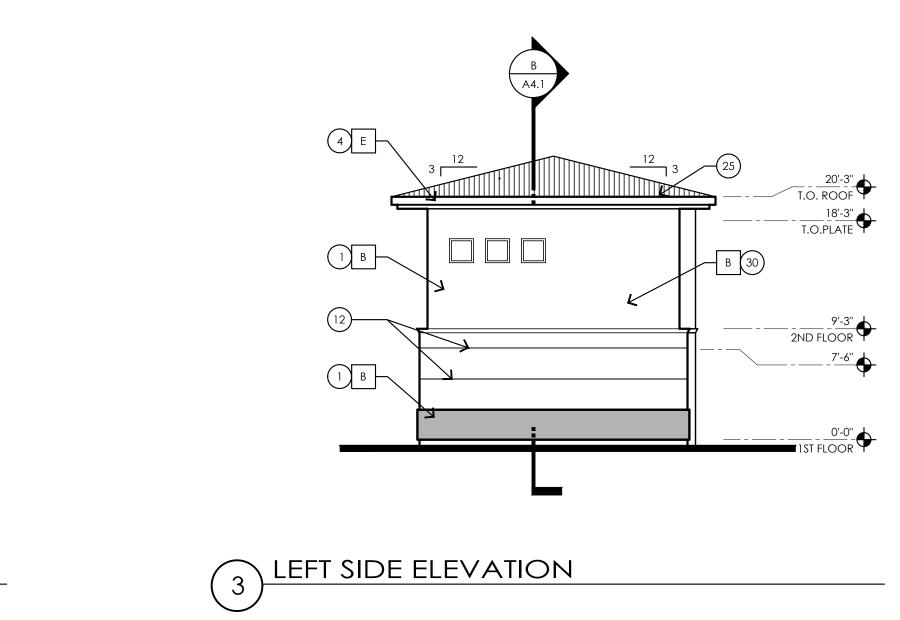


OR DELETIONS: A GROUND. BE REPLACED	<b>LEVATION ΚΕΥΝΟΤΕ</b>	<ol> <li>METAL AWNING - REFER TO E SCHEDULE</li> <li>STEEL COLUMNS / BEAMS</li> <li>ALUMINUM STOREFRONT SYS</li> <li>PARAPET WALL WITH PARAPE</li> <li>EXPOSED 4X8X16 CMU - REFE COLOR</li> <li>CAST-IN-PLACE CONCRETE -</li> <li>STEEL GUARDRAIL - WITH DEC REFER TO COLOR SCHEDULE</li> <li>STUCCO CONTROL JOINT - S</li> <li>FOAM POP-OUT</li> <li>FOAM POP-OUT AT WINDOW</li> <li>CHIMNEY</li> </ol>	TH SAND FINISH HEDULE FOR FINISH AND COLOR IEL ROOF SYSTEM OLOR SCHEDULE DETAILS SHEET A8.7 AND COLOR TEM ET METAL CAP ER TO SCHEDULE FOR FINISH AND NATURAL GRAY CORATIVE STEEL SHEET PANEL - EE DETAIL 9/A8.6 / SILL HUTTER O MATCH WALL WHERE OCCURS WS 18" PROJECTION D - SEE DETAILS SHEET A8.7. DFING RAIL L PANELING - VERTICAL SEAMS LADDING	C.CusersBrianDocumentsFastmark 2.0.Central File Brian of
	VERAL NO	<ol> <li>PAINT ALL VENTS, FLASHING, J ADJACENT BUILDING COLOR</li> <li>STUCCO TEXTURE IS GUN DAS "ALTERNATES" FOR ADDITION, GEN. CONTRACTOR.</li> <li>VERIFY ALL FINISHES WITH GEI APPLICATION</li> <li>VERIFY ALL COLOR SELECTIO OWNER PRIOR TO APPLICATIO</li> <li>ALL PAINT COLOR CHANGES CORNERS ONLY</li> <li>ROOFING SHALL BE INSTALLEE W/MANUFACTURER'S SPECIFI</li> <li>PROVIDE SEALANT AT ALL STU</li> <li>ALL CONTROL JOINTS &amp; REVE CORNERS ONLY</li> </ol>	AL FINISH TYPE. COORDINATE WITH AL FINISH TYPE. COORDINATE WITH N. CONTRACTOR PRIOR TO NS WITH COLORED ELEVATIONS & ON. TO TERMINATE ON INSIDE D IN ACCORDANCE CATIONS. HCCO PENETRATIONS EALS TO TERMINATE ON INSIDE	RIAN BURTON SANDSTROM
		<ol> <li>9. HORIZONTAL GROUT LINES TO</li> <li>10. VERTICAL GROUT LINES TO BE</li> <li>11. ANTI-GRAFFITI COATING AT COATING TO EXTEND UP TO 2</li> <li>12. ALL EXTERIOR MISC. METALS TO POWDER COATED AS PER OWNER</li> </ol>	E FLUSH CMU WALLS/VENEER (@ BUILDINGS 2ND FINISH FLOOR) TO BE FILLED PAINTED, OR	
	ULE		SCHEME RE IS SAND FINISH)	
	СНЕD		COLOR/ FINISH COLOR: DUNN EDWARDS DE6213 - FINE GRAIN	
	LOR S	B STUCCO COLOR 2	COLOR: DUNN EDWARDS DE6214 PIGEON GRAY	NO 7/26/2021 CITY REVIEW (P&Z) DATE DESURIPTION THE PREMIERE AT EASTMARK 3.0
	R 0 0	C STUCCO COLOR 3	COLOR: DUNN EDWARDS DE6378 JET	JENNINGS HOLDINGS L.L.C. 5029 S. ELLSWORTH RD. MESA, AZ
	TERIO	D STUCCO COLOR 4	COLOR: DUNN EDWARDS DE6376 LOOKING GLASS	ARCHISTRUCT LLC 345 N. BEVERLY MESA, AZ 85201 TEL: (602) 750-0445 WWW.ARCHISTRUCTDB.COM
	EX	E METAL FASCIA/ BALCONY FACE/ STEEL COLUMN	ANODIZED BRONZE	THE OWNER, ARCHITECT, AND ENGINEER EXPRESSLY DISCLAIM ANY RESPONSIBILITY ARISING FROM ANY UNAUTHORIZED USE OF THESE PLANS, DRAWINGS, AND NOTES. ANY AUTHORIZATION MUST BE IN WRITING.
		F HORIZONTAL METAL	COLOR TO MATCH: DUNN EDWARDS DE6376 LOOKING GLASS	THIS DRAWING COPY MAY HAVE BEEN REPRODUCED AT A SIZE DIFFERENT THAN ORIGINALLY DRAWN. THE OWNER, ARCHITECT, AND ENGINEER ASSUME NO RESPONSIBILITY FOR THE USE OF INCORRECT SCALE.
		G STANDING SEAM METAL	COLOR TO MATCH: DUNN EDWARDS DE6376 LOOKING GLASS	
		H CMU WALL/ VENEER	SANDBLASTED NATURAL GREY FINISH	
		J RAILINGS / STAIRS	DUNN EDWARDS DE6378 - JET	
		K WINDOW FRAMES/ METAL AWNINGS	ANODIZED BRONZE	
		L GLU-LAM BEAMS	CLEAR VARNISH	
		M STUCCO COLOR 5	COLOR - WHITE	AHJ STAMP
		N WOODEN PANEL	COLOR - BROWN	
ADDR	ES:	SING		
Approved Fire Detail F		ling Addressing must co 505.1.	mply with City of Mesa	
shall be plc position as	icec to b ng th	et addressed, including k I on all new and existing e plainly visible and legil ne property. Said numbe nd.	buildings in such a ble from the street or	CITY PROJECT NUMBER:
No street a	ddre	ess or building number sh cted by any feature or f		DRAWING TITLE: Building Type 1 Exterior Elevations
Address nu sign at eac	mbe :h er nall k	ers should be no lower th ntrance facing the desig be a minimum 12" high w	nan the first story or on a nated property address.	PROJECT NO: DRAWING NUMBER:



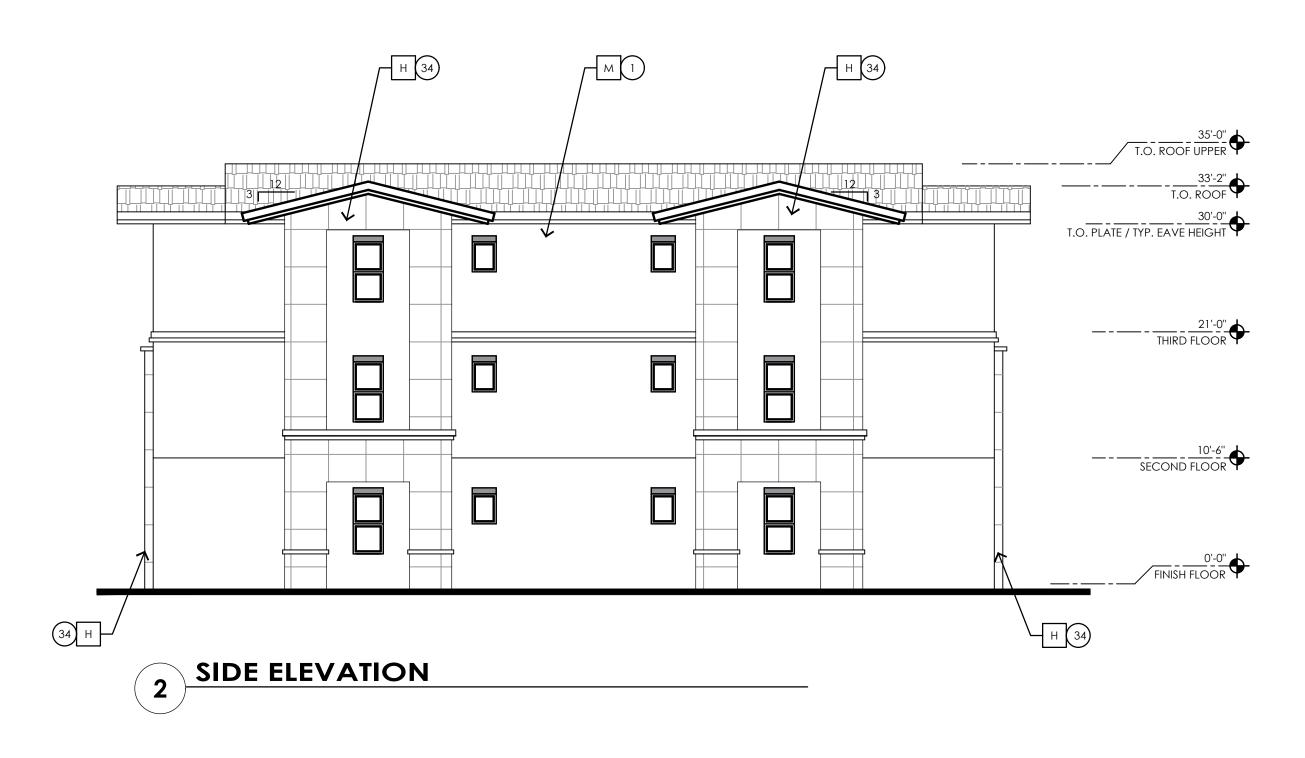


ALTERNATE EXTERIOR ELEVATION ELEMENT SUBSTITUTIONS AND/OR 1 1. METAL SIDING CAN BE REDUCED TO 6'-8" (EYE LEVEL) FROM GF AREA FROM WHICH METAL SIDING WAS REMOVED SHALL BE R WITH STUCCO.

<u>R DELETIONS:</u> GROUND. REPLACED	<ul> <li>H 3. STANDING SEAM METAL PAN METAL FASCIA - PAINT PER CO S. METAL AWNING - REFER TO I SCHEDULE</li> <li>A. STEEL COLUMNS / BEAMS</li> <li>ALUMINUM STOREFRONT SYS</li> <li>PARAPET WALL WITH PARAP</li> <li>PARAPET WALL WITH PARAP</li> <li>EXPOSED 4X8X16 CMU - REF COLOR</li> <li>CAST-IN-PLACE CONCRETE - COLOR</li> <li>CAST-IN-PLACE CONCRETE - I1. STEEL GUARDRAIL - WITH DET REFER TO COLOR SCHEDULE</li> <li>T3. FOAM POP-OUT</li> <li>T4. FOAM POP-OUT</li> <li>T5. CHIMNEY</li> <li>T6. GARAGE DOOR/ ROLLING S</li> </ul>	ITH SAND FINISH HEDULE FOR FINISH AND COLOR NEL ROOF SYSTEM COLOR SCHEDULE DETAILS SHEET A8.7 AND COLOR STEM ET METAL CAP ER TO SCHEDULE FOR FINISH AND NATURAL GRAY CORATIVE STEEL SHEET PANEL - SEE DETAIL 9/A8.6 V SILL SHUTTER TO MATCH WALL WHERE OCCURS OWS 18" PROJECTION D - SEE DETAILS SHEET A8.7. OFING RAIL	ROUTE 2
	GEN. CONTRACTOR. 3. VERIFY ALL FINISHES WITH GE APPLICATION	R U.N.O. SH REFER TO SPECIFICATIONS AL FINISH TYPE. COORDINATE WITH N. CONTRACTOR PRIOR TO INS WITH COLORED ELEVATIONS &	
	<ul> <li>ALL PAINT COLOR CHANGES CORNERS ONLY</li> <li>6. ROOFING SHALL BE INSTALLE W/MANUFACTURER'S SPECIF</li> <li>7. PROVIDE SEALANT AT ALL STU</li> <li>8. ALL CONTROL JOINTS &amp; REVICORNERS ONLY</li> <li>9. HORIZONTAL GROUT LINES TO BUSIC</li> </ul>	D IN ACCORDANCE ICATIONS. JCCO PENETRATIONS EALS TO TERMINATE ON INSIDE D HAVE "V" CONTOUR E FLUSH CMU WALLS/VENEER (@ BUILDINGS 2ND FINISH FLOOR) TO BE FILLED PAINTED, OR	BRIAN BURTON SANDSTROM One OT/26/2021
		RE IS SAND FINISH)	
		COLOR/ FINISH COLOR: DUNN EDWARDS	
		DE6213 - FINE GRAIN COLOR: DUNN EDWARDS	
	R S C	DE6214 PIGEON GRAY	7/26/2021     CITY REVIEW (P&Z)       NO     DATE     DESCRIPTION       THE DECMIEDE AT EACTMADIC 2.0
		COLOR: DUNN EDWARDS	THE PREMIERE AT EASTMARK 3.0 JENNINGS HOLDINGS L.L.C.
		DE6376 LOOKING GLASS	5029 S. ELLSWORTH RD. MESA, AZ ARCHISTRUCT LLC 345 N. BEVERLY MESA, AZ 85201
	E METAL FASCIA/ BALCONY FACE/ STEEL COLUMN	ANODIZED BRONZE	TEL: (602) 750-0445 WWW.ARCHISTRUCTDB.COM THE OWNER, ARCHITECT, AND ENGINEER EXPRESSLY DISCLAIM ANY RESPONSIBILITY
	F HORIZONTAL METAL SIDING	COLOR TO MATCH: DUNN EDWARDS DE6376 LOOKING GLASS	ARISING FROM ANY UNAUTHORIZED USE OF THESE PLANS, DRAWINGS, AND NOTES. ANY AUTHORIZATION MUST BE IN WRITING. THIS DRAWING COPY MAY HAVE BEEN REPRODUCED AT A SIZE DIFFERENT THAN ORIGINALLY DRAWN. THE OWNER, ARCHITECT, AND ENGINEER ASSUME NO
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	N WOODEN PANEL	COLOR - BROWN	AHJ STAMP
Approved Fire Detail F Approved shall be plo position as	street addressed, including aced on all new and existin to be plainly visible and leg ng the property. Said numb	building/suite numbers, g buildings in such a gible from the street or	CITY PROJECT NUMBER:
	ddress or building number s ostructed by any feature of	-	DRAWING TITLE: Building Type 4 Exterior Elevations
sign at eac	mbers should be no lower ch entrance facing the des	ignated property address.	
	nall be a minimum 12" high e facility colors.	with a 2" stroke and	A3.4.1

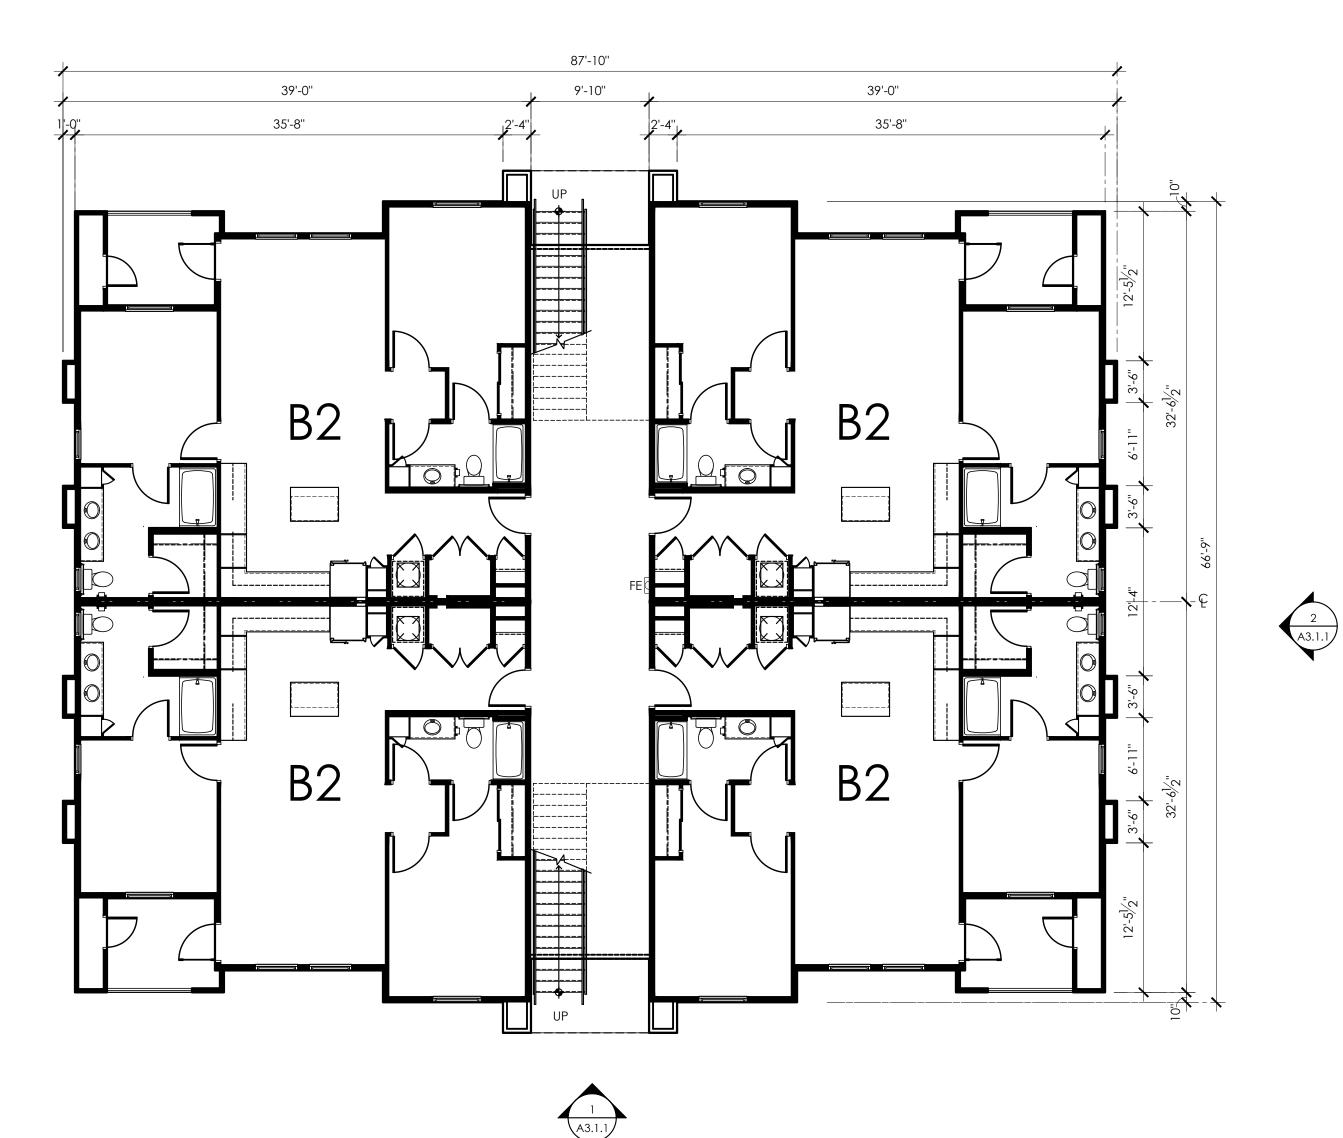






ERED ARCHIER					
BRIAN BURTON SANDSTROM					
APICONA, US					
7/26/2021     CITY REVIEW (P&Z)       NO     DATE       DESCRIPTION					
THE PREMIERE AT EASTMARK 3.0 JENNINGS HOLDINGS L.L.C.					
5029 S. ELLSWORTH RD. MESA, AZ ARCHISTRUCT LLC 345 N. BEVERLY MESA, AZ 85201					
TEL: (602) 750-0445 WWW.ARCHISTRUCTDB.COM THE OWNER, ARCHITECT, AND ENGINEER EXPRESSLY DISCLAIM ANY RESPONSIBILITY					
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RESPONSIBILITY FOR THE USE OF INCORRECT SCALE.					
AHJ STAMP					
CITY PROJECT NUMBER:					
DRAWING TITLE: Building Type 1 Typical Floor Plan					
PROJECT NO: DRAWING NUMBER:					
A3.1.1					

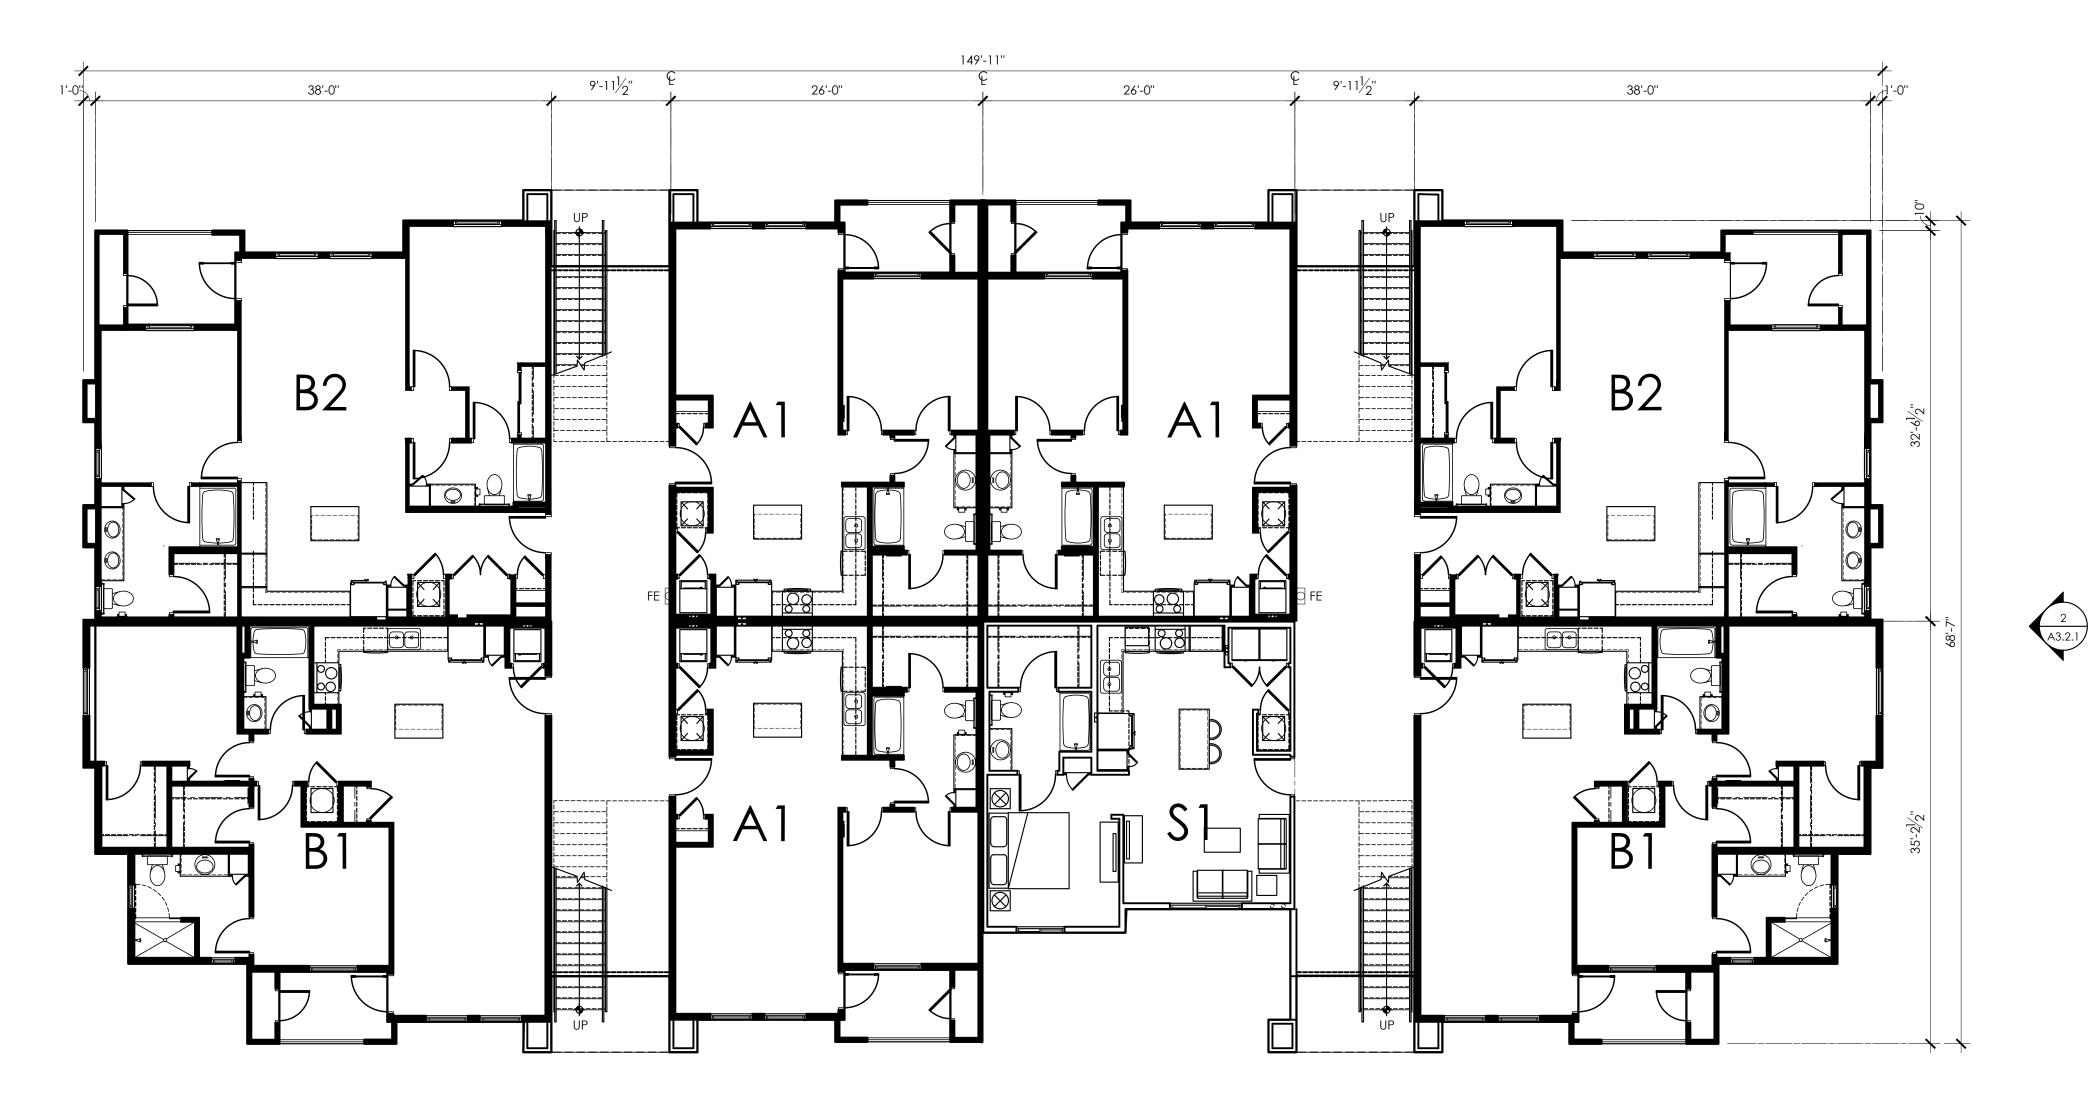

TYPICAL FLOOR PLAN

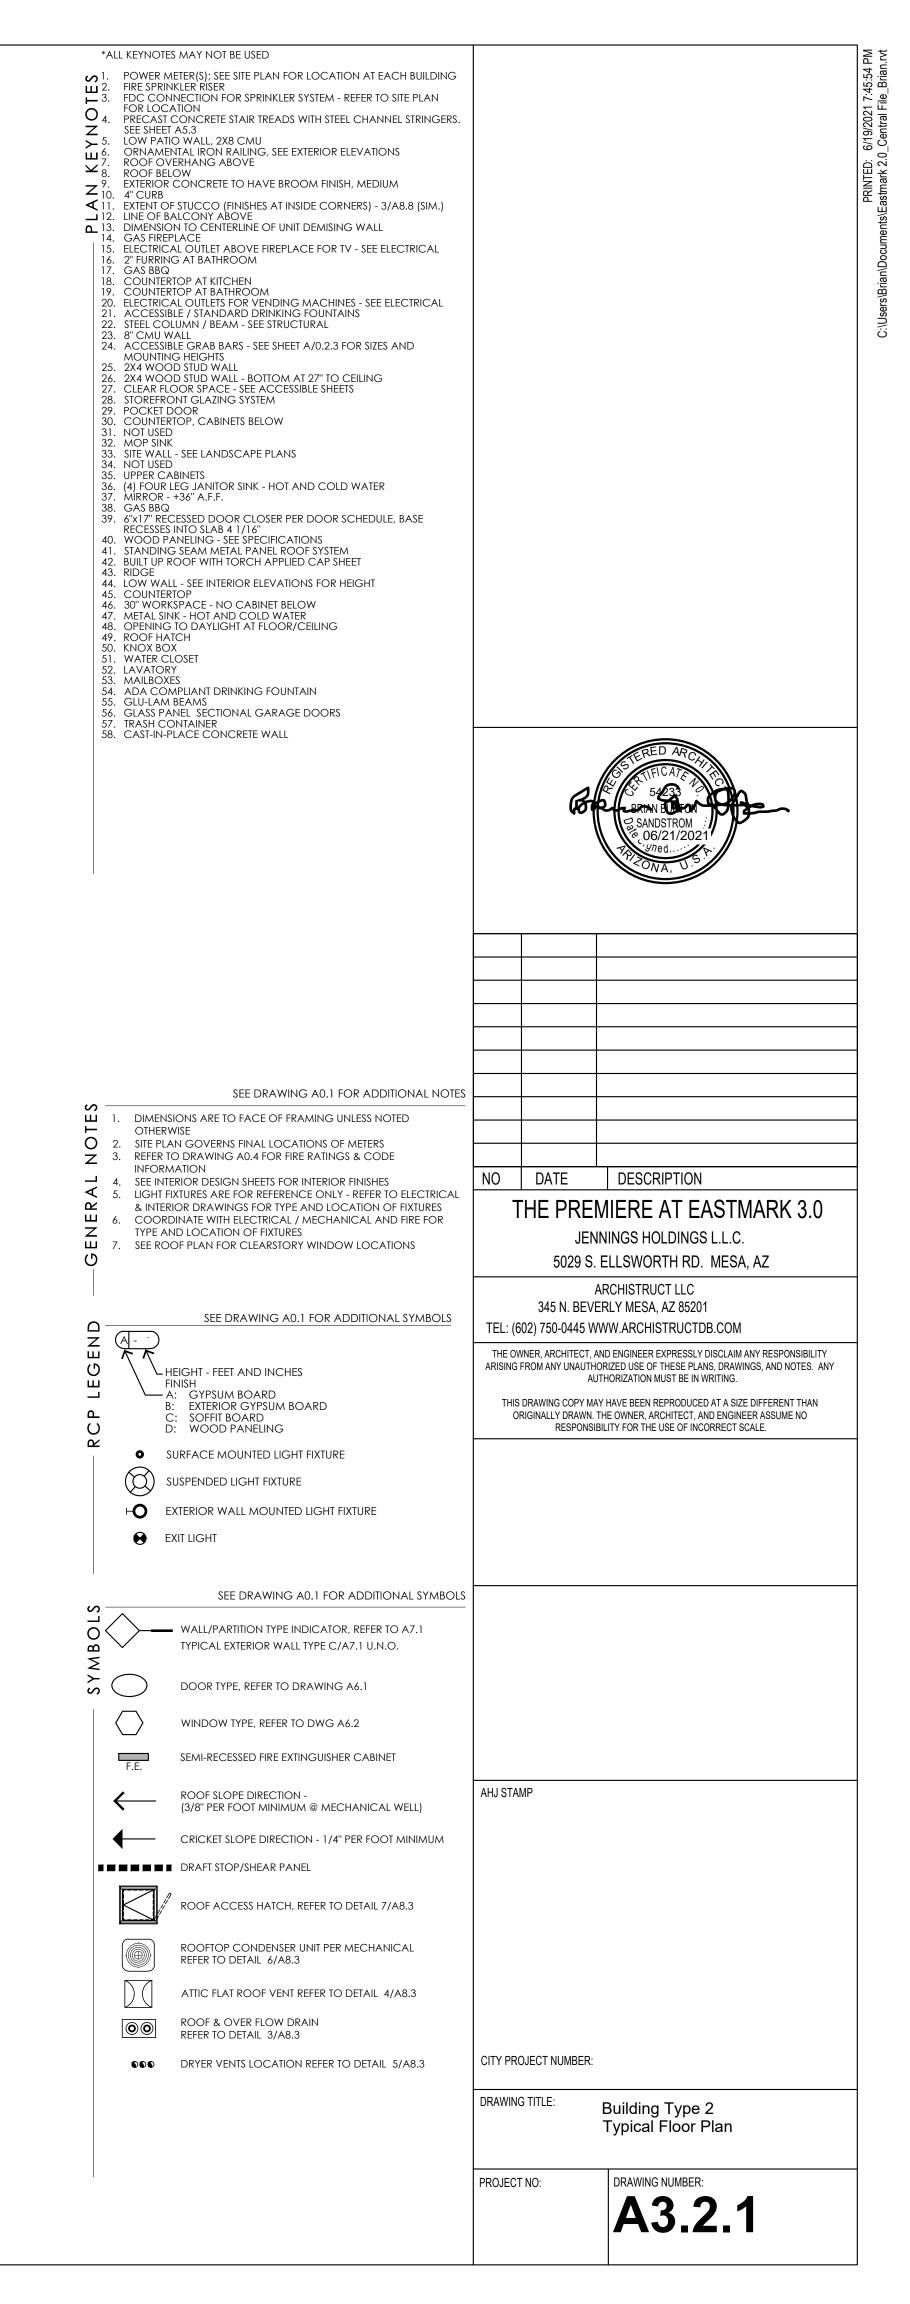

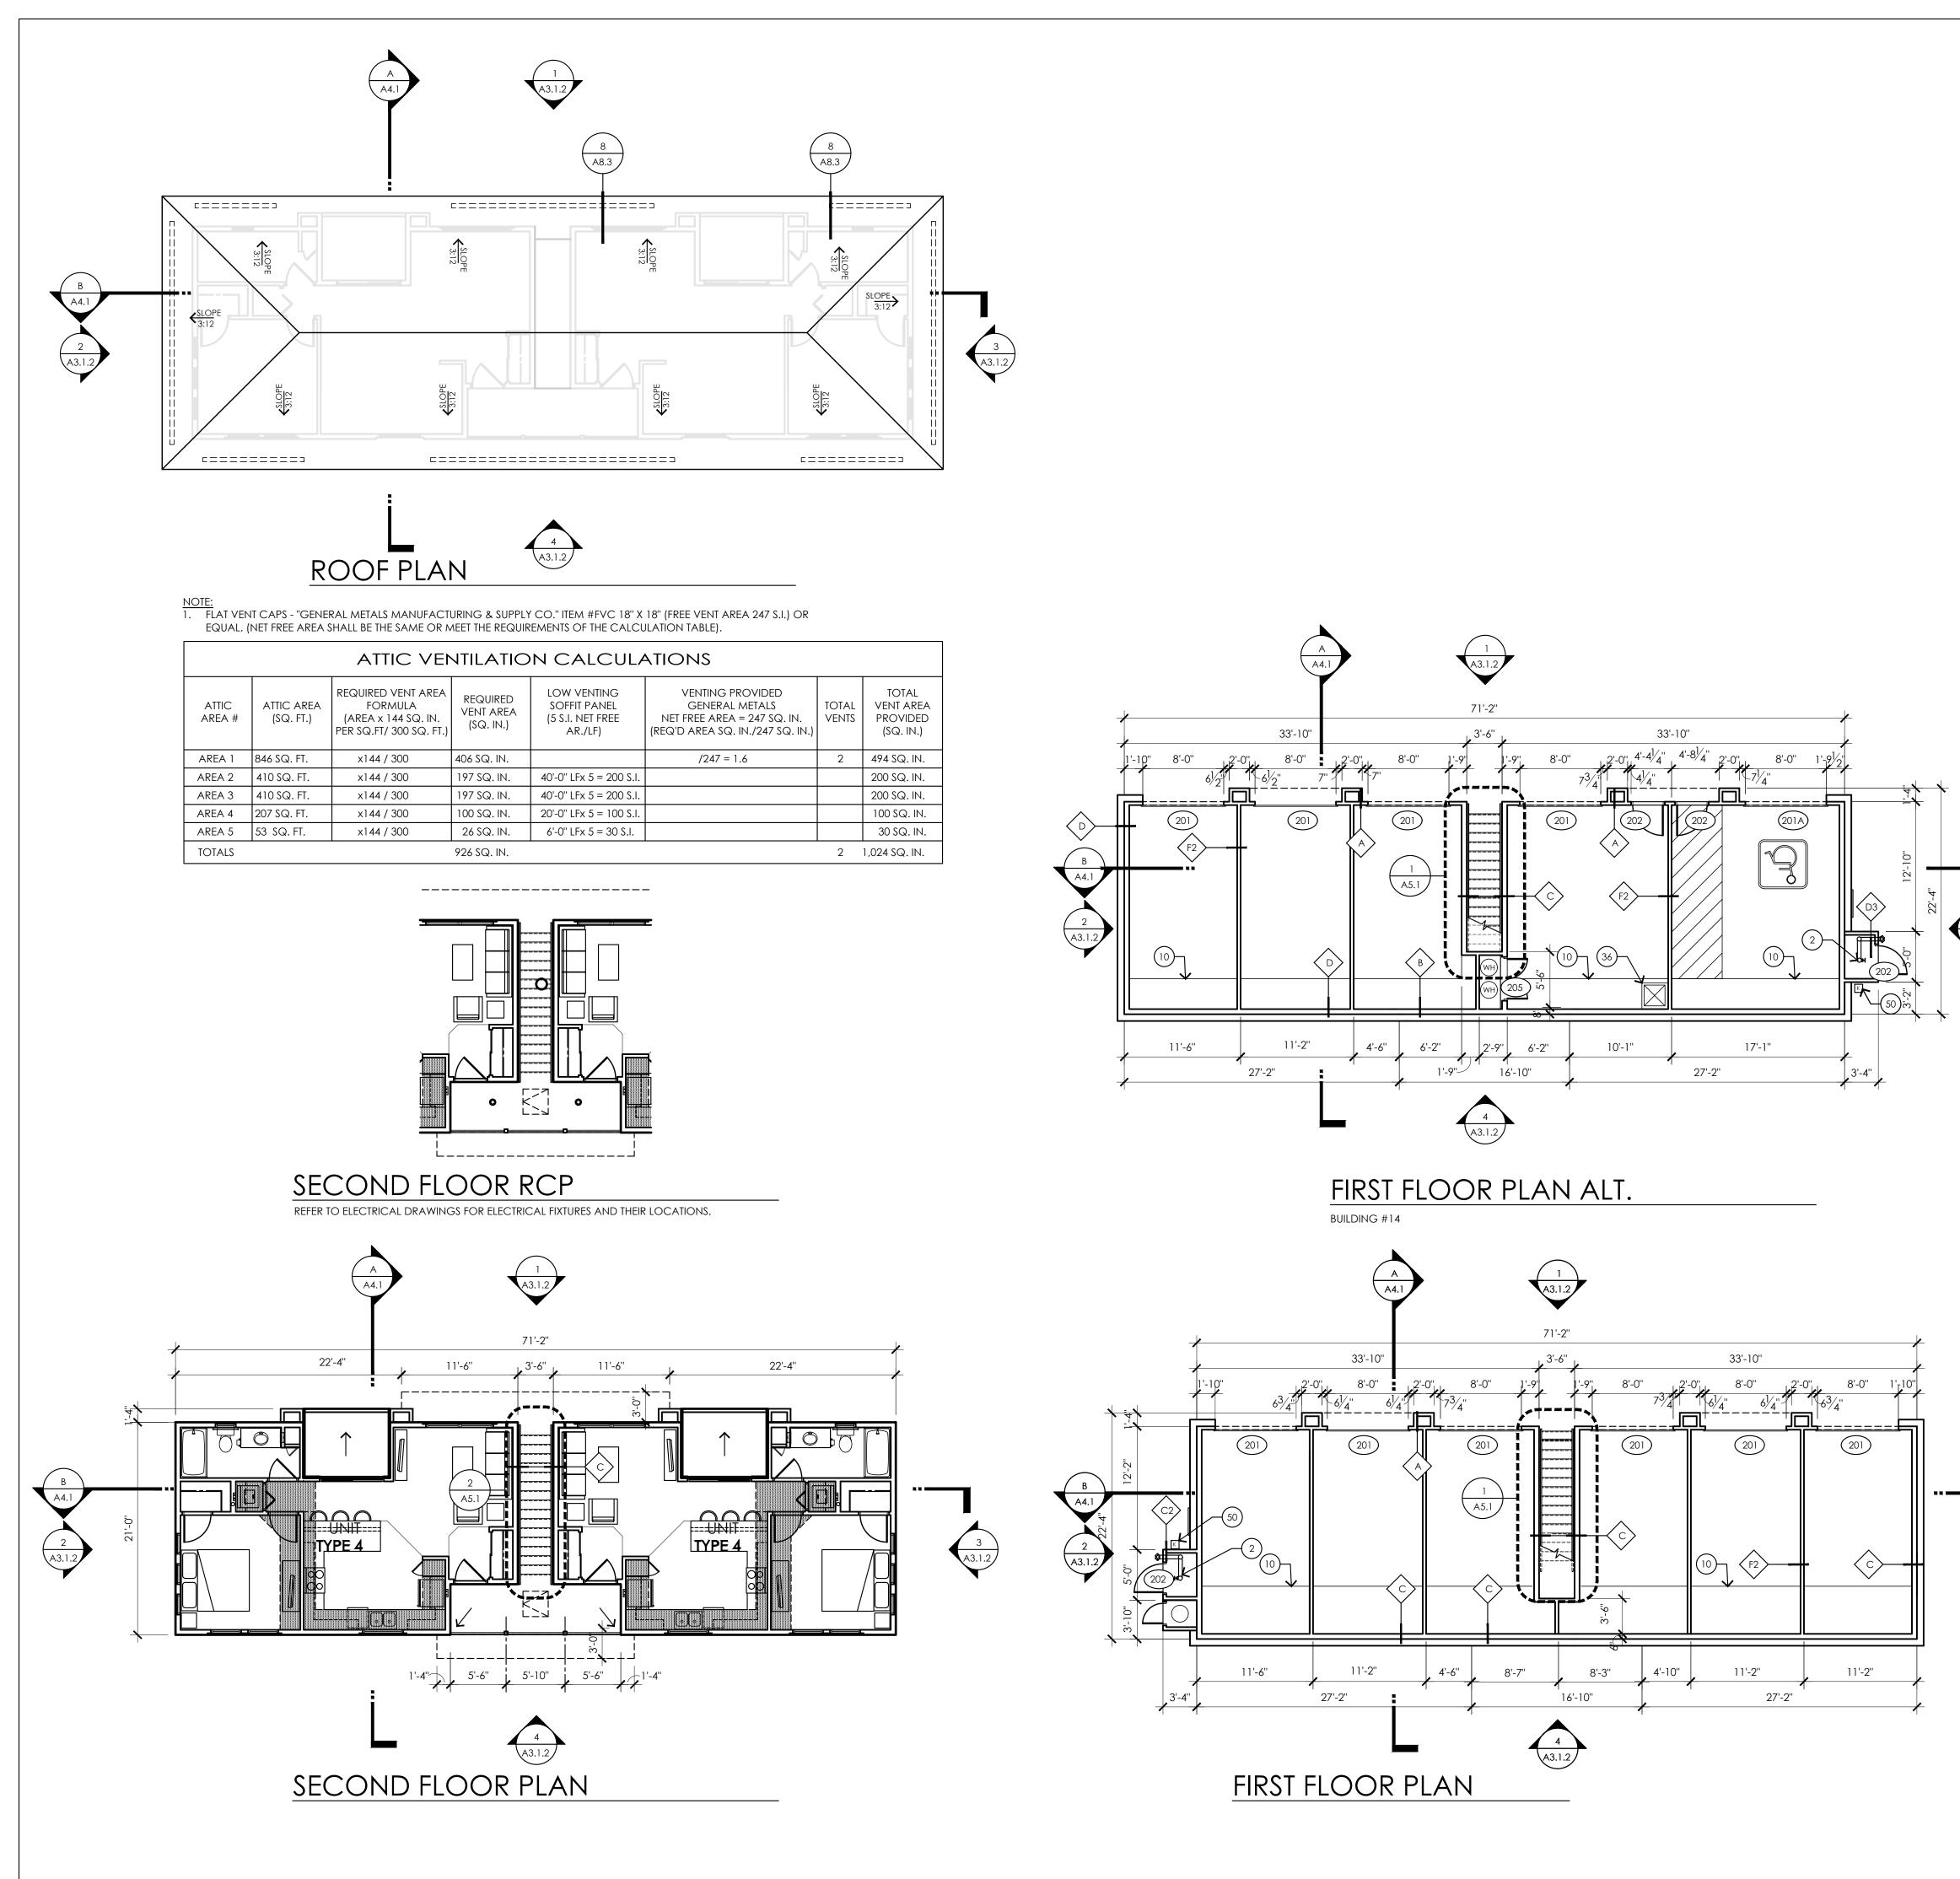

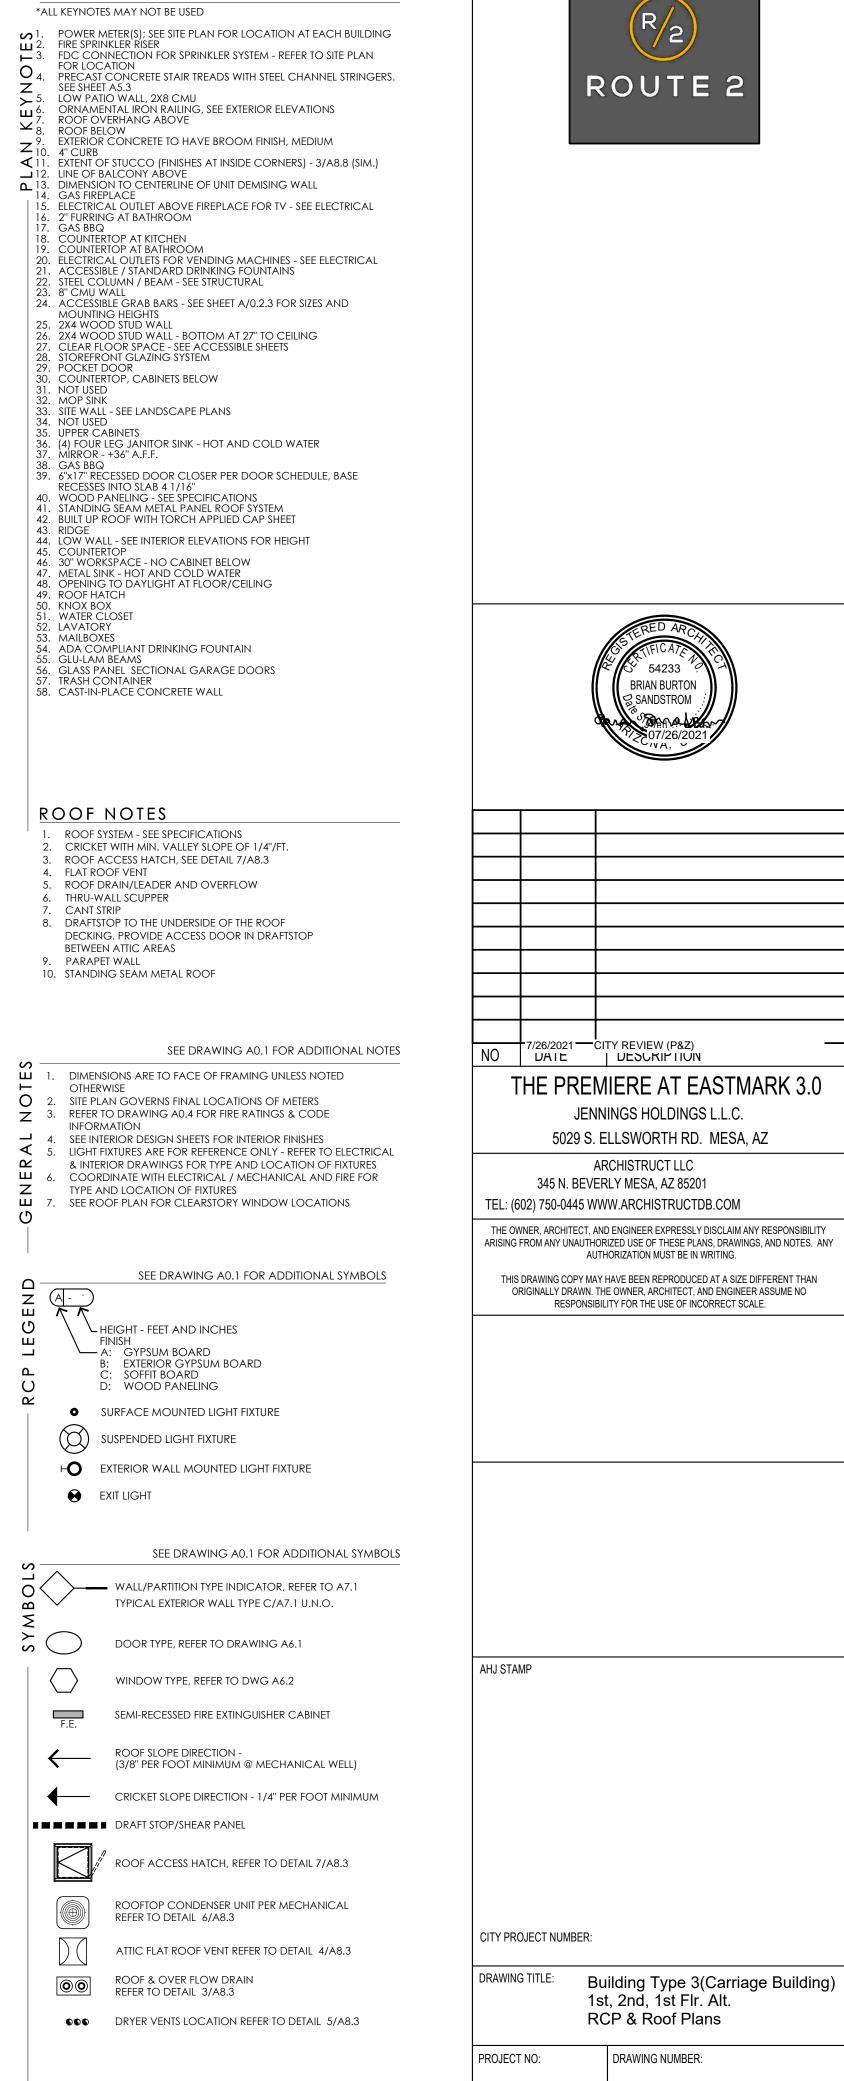

A3.3.1




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A3.1.2



A3.4.1

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NO	
T	HE PREMIERE AT EASTMARK 3.0
	JENNINGS HOLDINGS L.L.C.
	5029 S. ELLSWORTH RD. MESA, AZ ARCHISTRUCT LLC
TEL: (60	345 N. BEVERLY MESA, AZ 85201 )2) 750-0445 WWW.ARCHISTRUCTDB.COM
THE OWN	NER, ARCHITECT, AND ENGINEER EXPRESSLY DISCLAIM ANY RESPONSIBILITY ROM ANY UNAUTHORIZED USE OF THESE PLANS, DRAWINGS, AND NOTES. ANY
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AHJ STAM	IP
CITY PRO	JECT NUMBER:
DRAWING	TITLE: Building Type 4
	Typical Floor Plan
PROJECT	NO: DRAWING NUMBER:
	A3.4.1
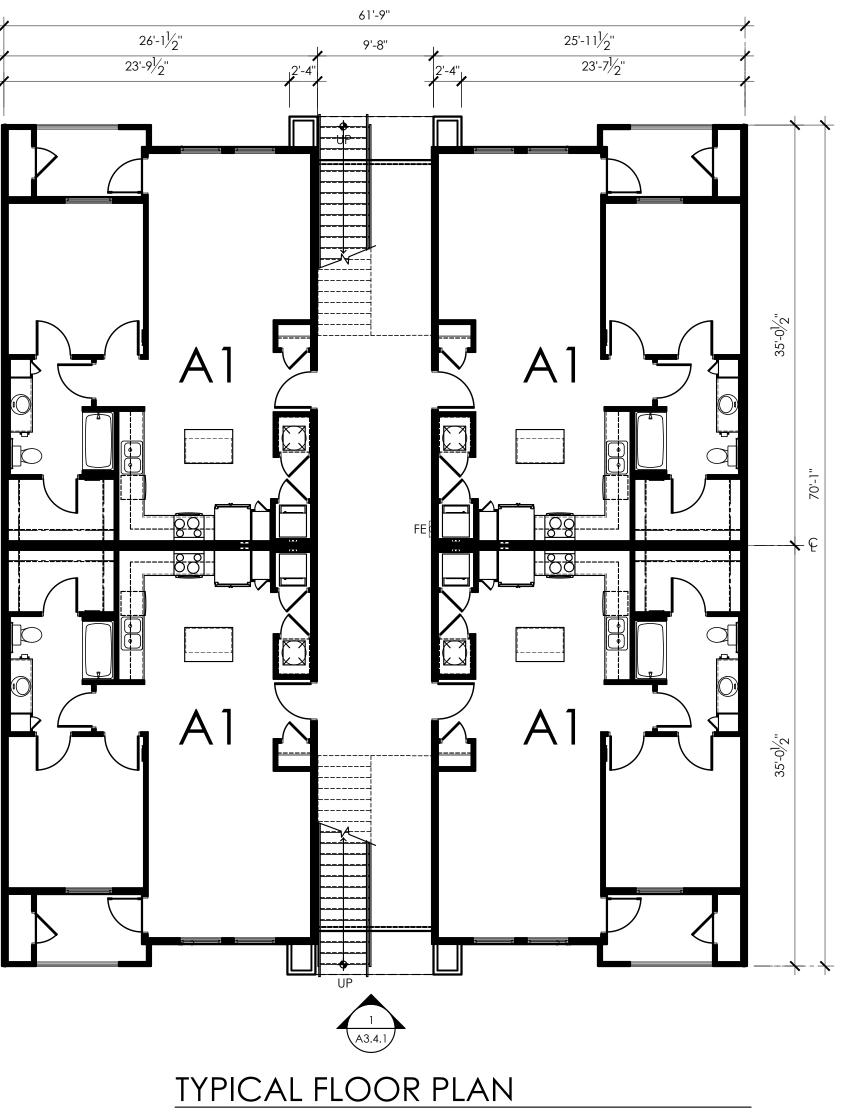
## GENERAL STRUCTURAL NOTES

### BUILDING CODE:

2012 EDITION OF THE INTERNATIONAL BUILDING CODE WITH CITY OF GILBERT AMMENDMENTS ASCE 7-05 WIND VALUES LOADS:

## GRAVITY:

ROOF LIVE LOAD = 20 PSF (REDUCIBLE) CANOPY DEAD LOAD = ACTUAL WEIGHT OF MEMBER: DECK = 1.0PSFPURIIN = 6 PIFBEAM = 30 PLF (TEE), 26 PLF (SEMI) COLUMN = 26 PLF (BOTH)

LATERAL: WIND:

NOMINAL DESIGN WIND SPEED (3-SECOND GUST), V(ASD) = 90 MPH. EXPOSURE C. RISK CATEGORY, I

SEISMIC:

SEISMIC IMPORTANCE FACTOR, I = 1.0. RISK CATEGORY, I. MAPPED SHORT PERIOD SPECTRAL ACCELERATION, Ss = 0.180a. MAPPED ONE SECOND SPECTRAL ACCELERATION, S1 = 0.059g. SOIL SITE CLASS, D. DESIGN SHORT PERIOD SPECTRAL ACCELERATION, Sds = 0.192g. DESIGN ONE SECOND SPECTRAL ACCELERATION, Sd1 = 0.094g. SEISMIC DESIGN CATEGORY, B. BASIC SEISMIC-FORCE-RESISTING SYSTEM = CANTILEVERED COLUMN SYSTEMS DETAILED TO CONFORM TO THE REQUIREMENTS FOR ORDINARY STEEL MOMENT FRAMES. SEISMIC RESPONSE COEFFICIENT. Cs = 0.154. RESPONSE MODIFICATION FACTOR (R)= 1.25.

ANALYSIS PROCEDURE USED = EQUIVALENT LATERAL FORCE PROCEDURE

### FOUNDATIONS:

FEET BELOW EXISTING GRADE.

SOIL REPORT BY TERRANE ENGINEERING CORPORATION, REPORT NO. TEC7T025.RPT.01

ALLOWABLE LATERAL BEARING PRESSURE = 300 PSF/FT FOR DRILLED PIER FOOTINGS. THE DRILLED PIER FOOTINGS ARE DESIGNED AS CONSTRAINED (SECTION 1807.3.2.2, EQUATION 18-3) WHERE PLACED IN CONCRETE AREAS, AS PARTIALLY CONSTRAINED (AVERAGE OF CONSTRAINED AND UNCONSTRAINED) WHERE PLACED IN ASPHALT AREAS AND AS UNCONSTRAINED (CZERNIAK WHEN NOT PLACED IN CONCRETE OR ASPHALT AREAS. DRILLED PIERS MUST BE A MINIMUM OF

#### SPREAD FOOTINGS SHALL BEAR ON FIRM, UNDISTURBED SOIL 2'-0" MINIMUM BELOW ADJACENT EXISTING GRADE. DESIGN SOIL BEARING VALUE = 2500 PSF. REFER TO SOILS REPORT FOR ADDITIONAL INFORMATION PRIOR TO COMMENCEMENT OF EARTHWORK. CONCRETE:

SPECIFIED 28 DAY COMPRESSIVE STRENGTH F'c:

FOUNDATIONS ----- 2,500 PSI

GENERAL:

ALL CAST-IN-PLACE CONCRETE CONSTRUCTION SHALL CONFORM TO THE LATEST EDITION OF THE ACI. MECHANICALLY VIBRATE ALL CONCRETE WHEN PLACED UNLESS NOTED OTHERWISE. ADMIXTURES CONTAINING CHLORIDES SHALL NOT BE USED. NO OTHER ADMIXTURES PERMITTED WITHOUT APPROVAL. FOR CONCRETE WITHOUT PLASTICIZER, MAXIMUM SLUMP 4 1/2" AT POINT OF PLACEMENT U.N.O. IF PLASTICIZER IS USED, A HIGHER FINAL SLUMP MAY BE ALLOWED UPON STRUCTURAL ENGINEER'S APPROVAL.

FOR REINFORCING INFORMATION, SEE REINFORCING SECTION OF G.S.N., PLANS, SCHEDULES AND DETAILS. FLY ASH - SHALL BE LIMITED TO 50% OF TOTAL CEMENTITIOUS MATERIALS BY WEIGHT.

TEST DATA FOR EACH CONCRETE MIX SHALL BE SUBMITTED FOR REVIEW PER CHAPTER 5 OF ACI 318. REFERENCE FIGURE R5.3 FOR SUBMITTAL REQUIREMENTS AND OPTIONS. CONCRETE MIX DESIGNS THAT ARE SUBMITTED WITHOUT THE APPROPRIATE TEST DATA CANNOT BE REVIEWED.

IT IS ACCEPTABLE AND INTENDED TO USE EARTH CUTS FOR THE DRILLED PIER FOOTING AND SPREAD FOOTING. THE FOOTING DESIGNS INDICATED IN THESE DRAWINGS DO NOT APPLY IF THE EARTH CUTS ARE UNSTABLE AND/OR DO NOT STAND ON THEIR OWN.

THE FOOTINGS INDICATED IN THESE DRAWINGS DO NOT APPLY WHERE ORGANIC FILL MATERIALS

CONCRETE SHALL BE ADEQUATELY VIBRATED AROUND THE EMBEDDED STEEL COLUMNS TO ENSURE THE CONCRETE HAS COMPLETELY SURROUNDED THE STEEL COLUMN. CONCRETE SHALL SLOPE UP SLIGHTLY TOWARDS COLUMNS TO PREVENT WATER FROM PONDING AROUND COLUMNS.

IT IS ACCEPTABLE FOR CONCRETE TO FREE FALL INTO THE DRILLED PIER OR SPREAD FOOTINGS. THE GOAL OF THE CONSTRUCTION WITH THE DRILLED PIER AND SPREAD FOOTING IS TO HAVE CONCRETE WELL PLACED WITH MINIMAL VOIDS AND GOOD CONSOLIDATION (i.e. MINIMAL SEGREGATION OF THE AGGREGATE).

#### **REINFORCING:**

ALL REINFORCING PER CRSI SPECIFICATIONS AND HANDBOOK. ASTM A615 (Fy = 60 KSI / GRADE 60) DEFORMED BARS FOR ALL BARS #5 AND LARGER. ASTM A615 (Fy = 40 KSI / GRADE 40) DEFORMED BARS FOR ALL BARS #4 AND SMÄLLER. WHERE SHOWN ON DRAWINGS ALL GRADE 60 REINFORCING TO BE WELDED SHALL BE ASTM A706. NO TACK WELDING OF REINFORCING BARS ALLOWED WITHOUT PRIOR REVIEW OF PROCEDURE WITH THE STRUCTURAL ENGINEER. LATEST ACI CODE AND DETAILING MANUAL APPLY. CLEAR CONCRETE COVERAGES AS FOLLOWS:

CAST AGAINST AND PERMANENTLY EXPOSED TO EARTH ----- 3" EXPOSED TO EARTH OR WEATHER #6 OR LARGER ----- 2\* #5 AND SMALLER ------ 1 1/2

ALL REINFORCING SHALL BE CHAIRED TO ENSURE PROPER CLEARANCES. SUPPORT OF FOUNDATION REINFORCING MUST PROVIDE ISOLATION FROM MOISTURE/CORROSION BY USE OF A PLASTIC OR CONCRETE CHAIR. DUCT-TAPE COVERED REINFORCING IS NOT AN ACCEPTABLE

ALL DIMENSIONS REFERENCED IN DRAWINGS AS "CLEAR" SHALL BE FROM FACE OF STRUCTURE TO EDGE OF REINFORCING, AND SHALL NOT BE LESS THAN STATED, NOR GREATER THAN "CLEAR" DIMENSION PLUS 3/8". ALL OTHERS SHALL BE PLUS OR MINUS 1/4" TYPICAL UNLESS NOTED OTHERWISE.

FIELD BENDING OR STRAIGHTENING OF DEFORMED BARS SHALL BE LIMITED TO #5 BARS AND SMALLER AND SHALL BE FIELD BENT OR STRAIGHTENED ONLY ONCE. ANY BEND SHALL BE LIMITED TO 90 DEGREES. IF FIELD BENDING OR STRAIGHTENING OF #6 BARS OR LARGER IS REQUIRED, OR IF A SECOND BEND IS REQUIRED FOR #5 BARS AND SMALLER, HEAT SHALL BE APPLIED FOR BENDING OR STRAIGHTENING. CONTRACTOR SHALL SUBMIT PROCEDURE FOR APPLYING HEAT TO ENGINEER FOR REVIEW AND APPROVAL PRIOR TO BENDING OR STRAIGHTENING BARS.

#### STRUCTURAL STEEL:

ALL OTHER PER LATEST EDITION OF ACI 318

GENERAL:

ALL CONSTRUCTION PER LATEST AISC STEEL CONSTRUCTION MANUAL. ALL WIDE FLANGE STEEL SHALL BE ASTM A992 (Fy = 50 KSI). ALL MISCELLANEOUS STEEL UNLESS NOTED OTHERWISE SHALL BE ASTM A36 (Fy = 36 KSI). IF CALLED OUT ON PLANS, Fy = 50 KSI PLATE STEEL SHALL BE ASTM A529 OR A572.

ALL STRUCTURAL ROLLED STEEL MEMBERS WITH Fy GREATER THAN 36 KSI ARE TO BE IDENTIFIED WITH AN ASTM SPECIFICATION MARK OR TAG PER IBC SEC. 2203.1. PROTECET ALL EXPOSED STEEL BELOW GRADE WITH HE107 ASPHALT EMULSION PRODUCT.

#### WELDING:

UNLESS NOTED OTHERWISE, ALL WELDS PER LATEST EDITION OF THE AWS STANDARDS. ALL WELDING SHALL BE PERFORMED BY WELDERS HOLDING VALID CERTIFICATES AND HAVING CURRENT EXPERIENCE IN THE TYPE OF WELD SHOWN ON THE DRAWINGS OR NOTES. CERTIFICATES SHALL BE THOSE ISSUED BY AN ACCEPTED TESTING AGENCY. ALL WELDING DONE BY E70 SERIES UNLESS NOTED OTHERWISE. FOR GRADE 60 REINFORCING BARS, USE E90 SERIES. THESE DRAWINGS DO NOT DISTINGUISH BETWEEN SHOP AND FIELD WELDS; THE CONTRACTOR MAY SHOP WELD OR FIELD WELD AT THEIR DISCRETION. SHOP WELDS AND FIELD WELDS SHALL BE SHOWN ON THE SHOP DRAWINGS SUBMITTED FOR REVIEW.

SCREW FASTENERS:

ALL SCREWS 3/4" MIN. LENGTH U.N.O.

EXTEND A MINIMUM OF 2 INCHES ABOVE FINISHED GRADE.

ALL STEEL SCREWS SHALL BE IN ACCORDANCE WITH AISI-GENERAL AND AISI-NAS. Fy = 50 ksi AND Ft = 70 ksi FOR ALL SCREWS. MINIMUM NOMINAL TENSILE STRENGTH = 2900 LB. MINIMUM NOMINAL SHEAR STRENGTH = 1962 LB.

1. MINIMUM SPACING OF SCREWS SHALL NOT BE LESS THAN 3 TIMES THE NOMINAL DIAMETER. MINIMUM EDGE DISTANCE FOR SCREWS SHALL NOT BE LESS THAN 1.5 TIMES THE NOMINAL SCREW DIAMETER. THE HEAD OF THE SCREW OR WASHER SHALL HAVE A DIAMETER, DW, OF NOT LESS THAN 5/16". WASHERS SHALL BE AT LEAST 0.05" THICK.

SCREW NUMBER DESIGNATION	8	10	12 (12–14)	14
NOMINAL DIAMETER	0.164"	0.190"	0.216"	0.250"

STEEL DECKING:

GENERAL:

ALL STEEL DECK SHALL BE MANUFACTURED AND ERECTED IN ACCORDANCE WITH LATEST EDITION OF THE AMERICAN IRON AND STEEL INSTITUTE "SPECIFICATIONS FOR THE DESIGN OF COLD-FORMED STEEL STRUCTURAL MEMBER". STEEL DECK SHALL BEAR ON SUPPORTS A MINIMUM OF 2 INCHES. ENDS OF SHEETS MUST BE LAPPED A MINIMUM OF 2 INCHES OVER SUPPORTS.

COLD FORMED STRUCTURAL STEEL FRAMING: GENERAL:

STRUCTURAL DRAWINGS SHALL BE FABRICATED AND ERECTED IN ACCORDANCE WITH MANUFACTURER'S RECOMMENDATIONS AND IN ACCORDANCE WITH THE LATEST EDITION OF AISC'S "SPECIFICATIONS FOR THE DESIGN OF COLD FORMED STEEL STRUCTURAL MEMBERS". FRAMING:

ALL WELDING TO BE PERFORMED BY WELDERS HOLDING A VALID CERTIFICATE AND HAVING CURRENT EXPERIENCE IN LIGHT GAUGE STEEL. CERTIFICATES SHALL BE ISSUED BY AN ACCEPTED TESTING AGENCY. DO NOT NOTCH FLANGES OF MEMBERS WITHOUT EXPRESSED APPROVAL OF THE ENGINEER OF RECORD. ALL WELDING TO BE PERFORMED IN AN APPROVED FABRICATORS SHOP. COLD FORMED STRUCTURAL STEEL MEMBERS SHAL HAVE A MINIMUM YEILD STRENGTH OF Fy = 55,000 PSI. THE GRADE AND THE ASTM SPECIFICATION NUMBER OR OTHER SPECIFICATION DESIGNATION SHALL BE INDICATED BY PAINTING, DECAL, TAGGING OR OTHER SUITABLE MEANS ON EACH BUNDLE OF FABRICATED ELEMENTS. IT IS ACCEPTABLE TO USE THE FY SHOWN ON THE

MILL CERTIFICATION IN LIEU OF THE "ORDERED" Fy.

THE STEEL PURLINS DO NOT HAVE TO BEAR DIRECTLY ON THE STEEL BEAMS. IT IS ACCEPTABLE AND COMMON FOR THE PURLINS TO NEED TO BE RAISED A LITTLE (1/2" MAXIMUM) TO ASSIST IN LEVELING AND 'TUNING' THE STRUCTURE. THE LOAD BETWEEN THE PURLIN AND THE BEAM IS TRANSFERRED ENTIRELY THROUGH THE SCREWS CONNECTING THE PURLIN TO THE PURLIN CLIP. THE PURLIN DOES NOT NEED TO BEAR ON THE BEAM.

MILS	GAGE NO.	MIN DELIVERED THICKNESS
12	30	0.0120"
14	29	0.0132"
16	26	0.0174"
33	20	0.0336"
43	18	0.0447"
54	16	0.0561"
68	14	0.0713"
97	12	0.0998"
118	10	0.1283"
150	9	0.1430"

#### **GENERAL NOTES:**

THE STRUCTURAL CONSTRUCTION DOCUMENTS REPRESENT THE FINISHED STRUCTURE. EXCEPT WHERE NOTED, THEY DO NOT INDICATE THE METHOD OF CONSTRUCTION. THE CONTRACTOR SHALL PROVIDE ALL MEASURES NECESSARY TO PROTECT THE STRUCTURE DURING CONSTRUCTION. SUCH MEASURES SHALL INCLUDE, BUT NOT BE LIMITED TO, BRACING, SHORING FOR LOADS DUE TO CONSTRUCTION EQUIPMENT, ETC. THE STRUCTURAL ENGINEER OF RECORD SHALL NOT BE RESPONSIBLE FOR THE CONTRACTOR'S MEANS, METHODS, TECHNIQUES, SEQUENCES FOR PROCEDURE OF CONSTRUCTION, OR THE SAFETY PRECAUTIONS AND THE PROGRAMS INCIDENT THERETO (NOR SHALL OBSERVATION VISITS TO THE SITE INCLUDE INSPECTION OF THESE ITEMS).

WHERE REFERENCE IS MADE TO VARIOUS TEST STANDARDS FOR MATERIALS, SUCH STANDARDS SHALL BE THE LATEST EDITION AND/OR ADDENDA. ANY ENGINEERING DESIGN, PROVIDED BY OTHERS AND SUBMITTED FOR REVIEW, SHALL BEAR THE SEAL OF A REGISTERED ENGINEER RECOGNIZED BY THE BUILDING CODE JURISDICTION OF THIS PROJECT.

NOTES AND DETAILS ON DRAWINGS SHALL TAKE PRECEDENCE OVER GENERAL STRUCTURAL NOTES AND TYPICAL DETAILS. WHERE NO DETAILS ARE SHOWN, CONSTRUCTION SHALL CONFORM TO SIMILAR WORK ON THE PROJECT, AND/OR AS PROVIDED FOR IN THE CONTRACT DOCUMENTS. WHERE DISCREPANCIES OCCUR BETWEEN PLANS, DETAILS, GENERAL STRUCTURAL NOTES AND SPECIFICATIONS, THE GREATER REQUIREMENTS SHALL GOVERN.

CONTRACTOR SHALL BE RESPONSIBLE FOR VERIFICATION OF ALL DIMENSIONS WITH ARCHITECTURAL DRAWINGS PRIOR TO START OF CONSTRUCTION. RESOLVE ANY DISCREPANCY WITH THE ARCHITECT. ESTABLISH AND VERIFY ALL OPENINGS AND INSERTS FOR ARCHITECTURAL, CIVIL, MECHANICAL, PLUMBING AND ELECTRICAL ITEMS WITH THE APPROPRIATE TRADE DRAWINGS AND SUBCONTRACTORS PRIOR TO CONSTRUCTION.

TYPICAL DETAILS MAY NOT NECESSARILY BE CUT ON PLANS, BUT APPLY UNLESS NOTED OTHERWISE.

CONSTRUCTION MATERIALS SHALL BE SPREAD OUT IF PLACED ON FRAMED CONSTRUCTION. LOAD SHALL NOT EXCEED THE DESIGN LIVE LOAD PER SQUARE FOOT. OPTIONS ARE FOR CONTRACTOR'S CONVENIENCE. IF AN OPTION IS CHOSEN, CONTRACTOR SHALL BE RESPONSIBLE FOR ALL NECESSARY CHANGES, APPROVALS AND THE COORDINATION OF THE WORK WITH ALL RELATED TRADES AND SUPPLIERS.

SPECIAL INSPECTION - STRUCTURAL ONLY:

CERTIFICATE.

(IF REQUIRED BY THE JURISDICTION HAVING AUTHORITY): FOR SPECIAL STRUCTURAL INSPECTIONS: CONTACT CARUSO TURLEY SCOTT, INC. AT 480-774-1700 PRIOR TO CONSTRUCTION: SPECIAL INSPECTIONS SHALL BE PERFORMED UNDER THE DIRECT SUPERVISION OF A STATE REGISTERED STRUCTURAL ENGINEER WHO IS FAMILIAR WITH THE STRUCTURAL DESIGN OF THIS PROJECT. THE SUPERVISING STRUCTURAL ENGINEER SHALL SEAL THE SPECIAL INSPECTION

SPECIAL INSPECTION IS TO BE PROVIDED FOR THE ITEMS LISTED BELOW IN ADDITION TO THE INSPECTIONS CONDUCTED BY THE BUILDING JURISDICTION. "SPECIAL STRUCTURAL INSPECTION" SHALL NOT RELIEVE THE OWNER OR THEIR AGENT FROM REQUESTING THE BUILDING JURISDICTION INSPECTIONS REQUIRED BY SECTION 109 OF THE INTERNATIONAL BUILDING CODE. SPECIAL INSPECTION IS REQUIRED PER CHAPTER 17 FOR THE FOLLOWING: CONCRETE CONSTRUCTION:

1. CONCRETE(SSI EXCEPTION BASED ON F'c = 2,500 PSI): A. NO INSPECTION IS REQUIRED FOR THE PLACEMENT OF FOUNDATION CONCRETE. INSPECTION OF FOUNDATION REINFORCING AND ANCHOR BOLTS IS REQUIRED PER "REINFORCING STEEL" SECTION BELOW.

. REINFORCING STEEL: INSPECTION OF IN-PLACE REINFORCING FOR CONFORMANCE PRIOR TO THE CLOSING OF FORMS OR THE DELIVERY OF CONCRETE TO THE JOBSITE FOR THE FOLLOWING: A. REINFORCING FOR ALL CONCRETE REQUIRED TO HAVE INSPECTION NOTED ABOVE. B. REINFORCING FOR SPREAD FOOTING CONCRETE FOUNDATIONS. STEEL CONSTRUCTION:

WELDING: A. PERIODIC VISUAL INSPECTION OF ALL FIELD WELDS. 3. CONTINUOUS INSPECTION OF ALL MULTIPASS FILLET WELDS OR SINGLE PASS FILLET WELDS LARGER THAN 5/16" C. NON-DESTRÚCTIVE TESTING OF ALL COMPLETE PENETRATION WELDS BY AN AWS CERTIFIED INDEPENDENT TESTING LABORATORY AT THE CONTRACTORS EXPENSE. D. VERIFICATION OF VALID WELDER'S CERTIFICATES. ALL STRUCTURAL STEEL FABRICATORS SHALL EMPLOY AN AWS CERTIFIED INDEPENDENT TESTING LAB TO PROVIDE SHOP WELD INSPECTIONS PER CODE. INSPECTION REPORTS SHALL BE SUBMITTED TO ENGINEER OF RECORD PRIOR TO STEEL INSTALLATION. EXCEPTION: NO SHOP INSPECTION IS REQUIRED IF THE FABRICATOR IS ON THE CITY OF PHOENIX APPROVED STEEL FABRICATOR LIST.

2. STEEL FRAMES: VERIFICATION OF BRACING, STIFFENING, MEMBER LOCATIONS, AND PROPER JOINT DETAIL APPLICATION AT ALL STEEL FRAME CONNECTIONS. DUTIES AND RESPONSIBILITIES OF THE SPECIAL INSPECTOR:

TO THE APPROVED DESIGN DRAWINGS AND SPECIFICATION. 3. THE SPECIAL INSPECTOR IS NOT AUTHORIZED TO APPROVE DEVIATIONS FROM THE DESIGN DRAWINGS OR SPECIFICATIONS, AND ALL DEVIATIONS MUST BE APPROVED BY THE STRUCTURAL ENGINEER OF RECORD PRIOR TO PROCEEDING WITH THE WORK. ALL REQUESTS FOR DEVIATIONS SHALL BE INITIATED BY THE CONTRACTOR VIA WRITTEN REQUEST FOR INFORMATION (RFI). THE SPECIAL INSPECTOR SHALL FURNISH INSPECTION REPORTS TO THE BUILDING OFFICIAL, AND TO THE ENGINEER OR ARCHITECT OF RECORD. ALL DISCREPANCIES SHALL BE BROUGHT TO THE IMMEDIATE ATTENTION OF THE CONTRACTOR FOR CORRECTION, THEN, IF UNCORRECTED, TO THE DESIGN AUTHORITY AND THE BUILDING OFFICIAL. D. CONTRACTOR SHALL PROVIDE THE SPECIAL INSPECTOR ACCESS TO ALL ITEMS REQUIRING SPECIAL INSPECTION. ACCESS SHALL BE PROVIDED BY IN-PLACE LADDERS, SCAFFOLDS, LIFTS AND/OR OTHER EQUIPMENT OPERATED BY THE CONTRACTOR'S PERSONNEL AS REQUIRED FOR SAFÉ OBSERVATION. INSPECTOR IS NOT RESPONSIBLE OR AUTHORIZED TO OPERATE CONTRACTOR'S EQUIPMENT.


. UPON COMPLETION OF THE ASSIGNED WORK THE ENGINEER OR ARCHITECT SHALL COMPLETE AND SIGN THE APPROPRIATE FORMS CERTIFYING THAT TO THE BEST OF THEIR KNOWLEDGE THE WORK IS IN CONFORMANCE WITH THE APPROVED PLANS AND SPECIFICATIONS, AND THE APPLICABLE WORKMANSHIP PROVISIONS OF THE CODE.


## Applies unless noted otherwise on drawings


ALL COLD FORMED STRUCTURAL STEEL FRAMING AND COMPONENTS INDICATED ON THE


DESIGN THICKNESS
0.0126"
0.0139"
0.0183"
0.0354"
0.0470"
0.0590"
0.0750"
0.1050"
0.1350"
0.1500"

A. THE SPECIAL INSPECTOR SHALL OBSERVE THE WORK ASSIGNED TO BE CERTAIN IT CONFORMS

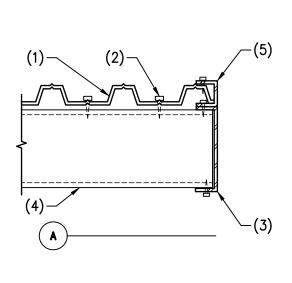

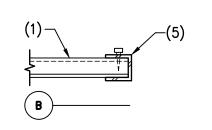

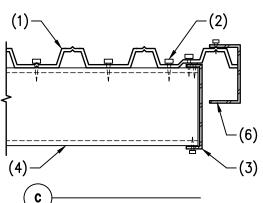

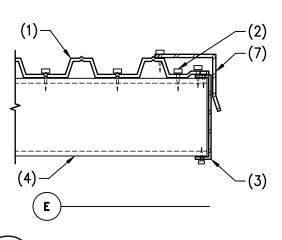

END CAP PURLIN AND FASCIA TRIM 08 16-1503

(5)-


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STEEL BEAM BRACING

**└**(2)

1/8


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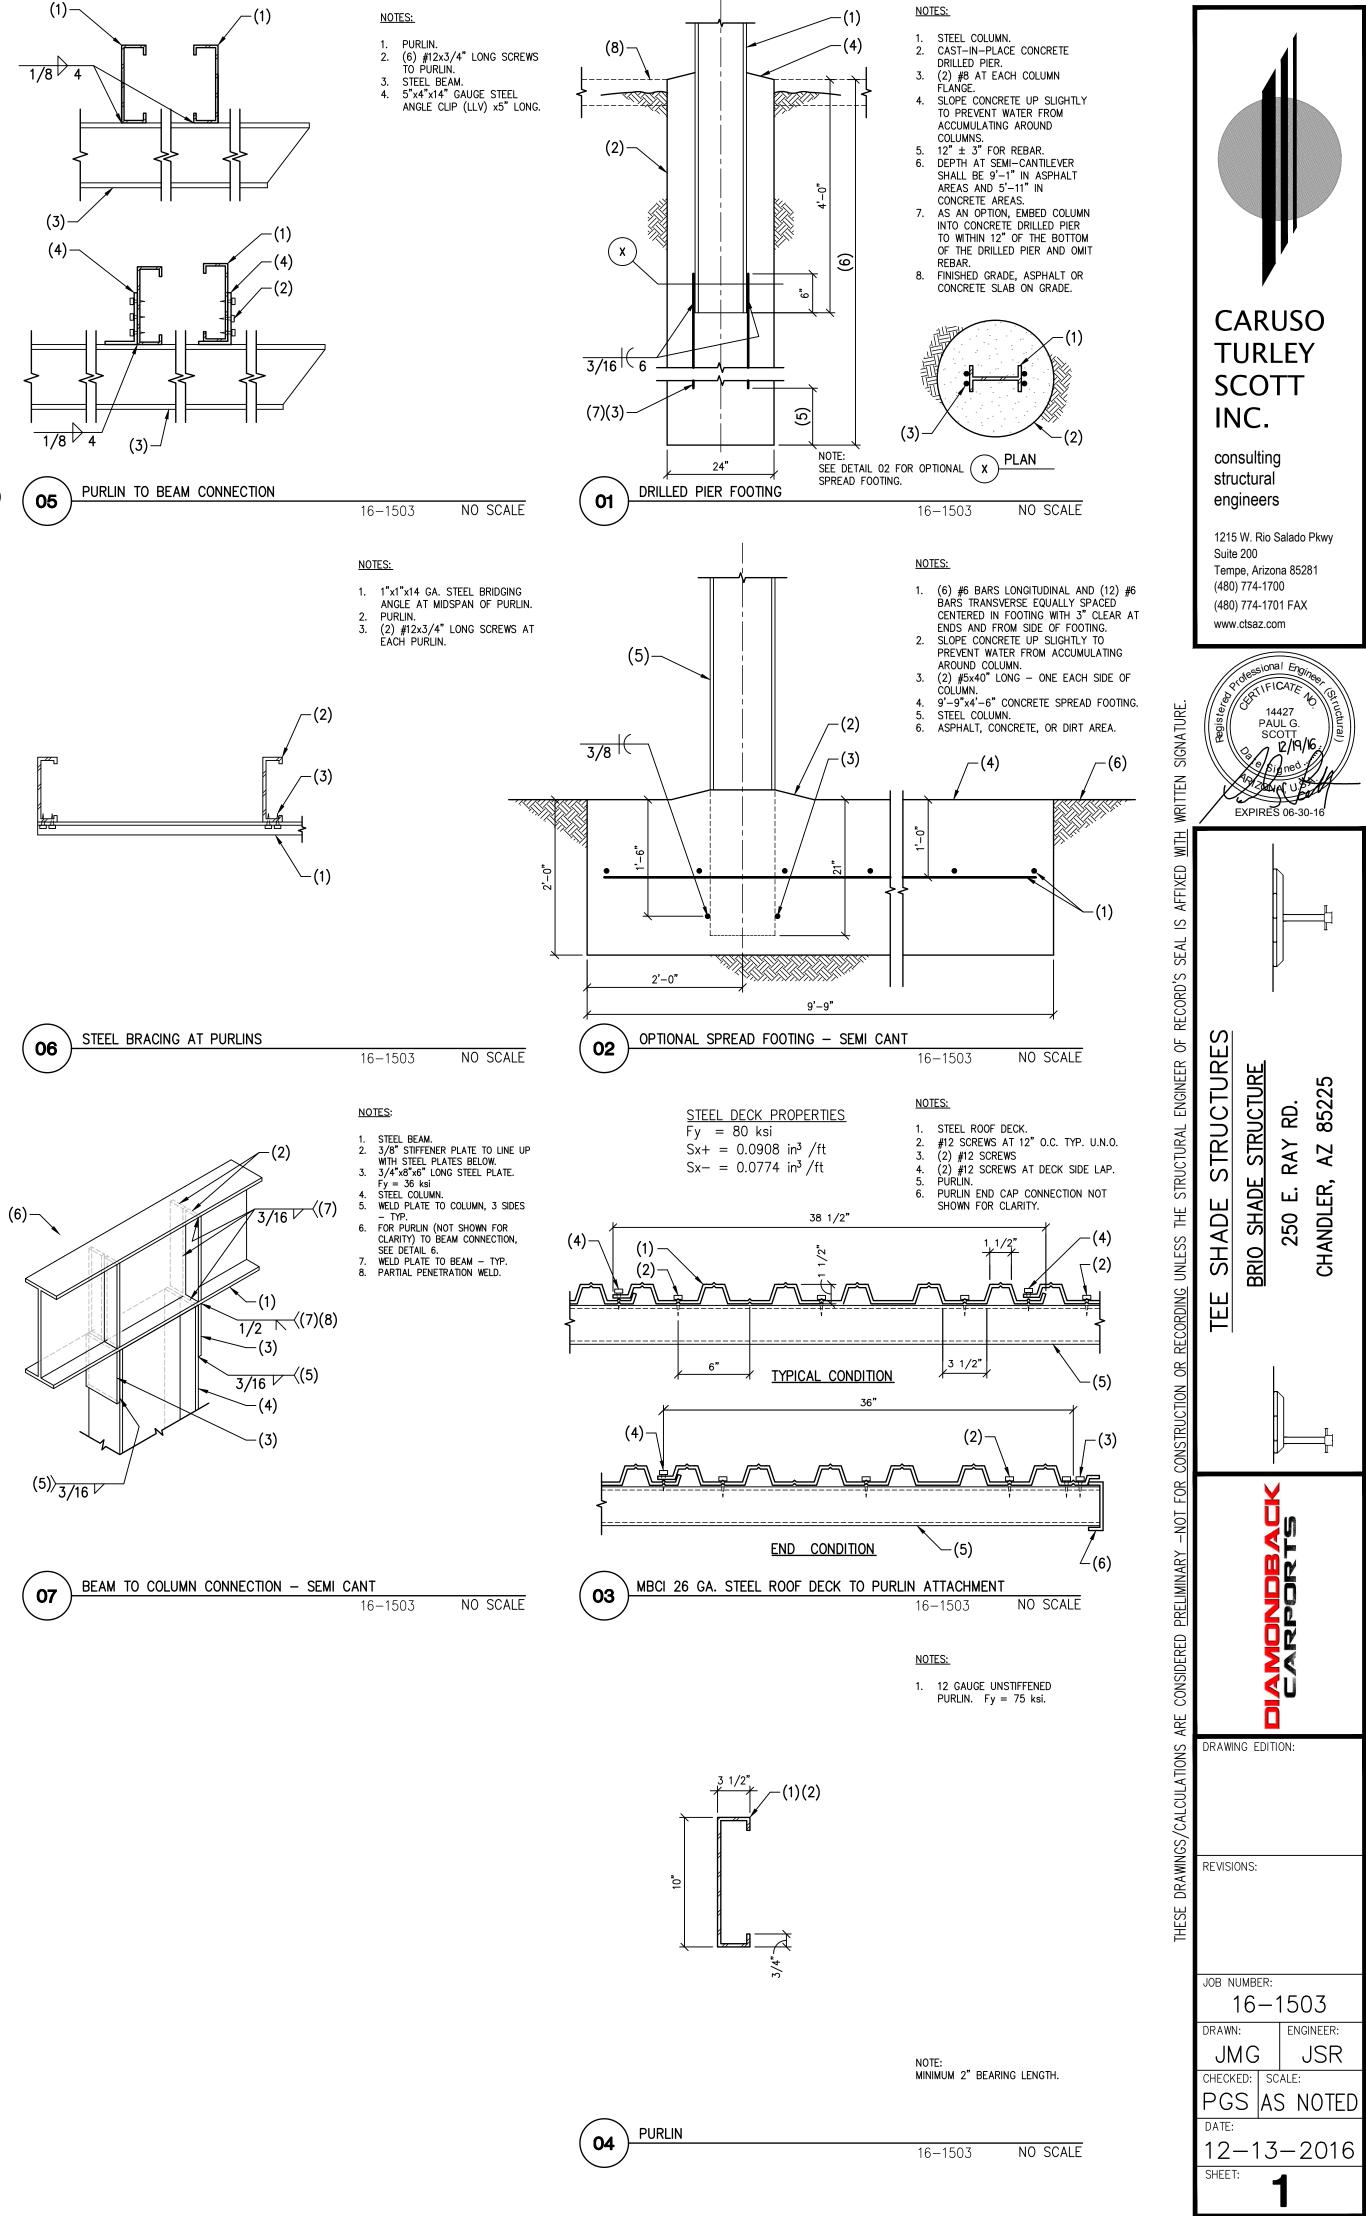



PURLIN. STEEL BEAM. 4. 2"x1/8" THICK STEEL FLANGE BRACE STRAP AS SHOWN ON PLANS. Fy = 33 ksi (MIN). 5. AS AN OPTION TO WELDING, ATTACH BRACE TO PURLIN

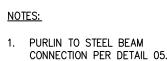
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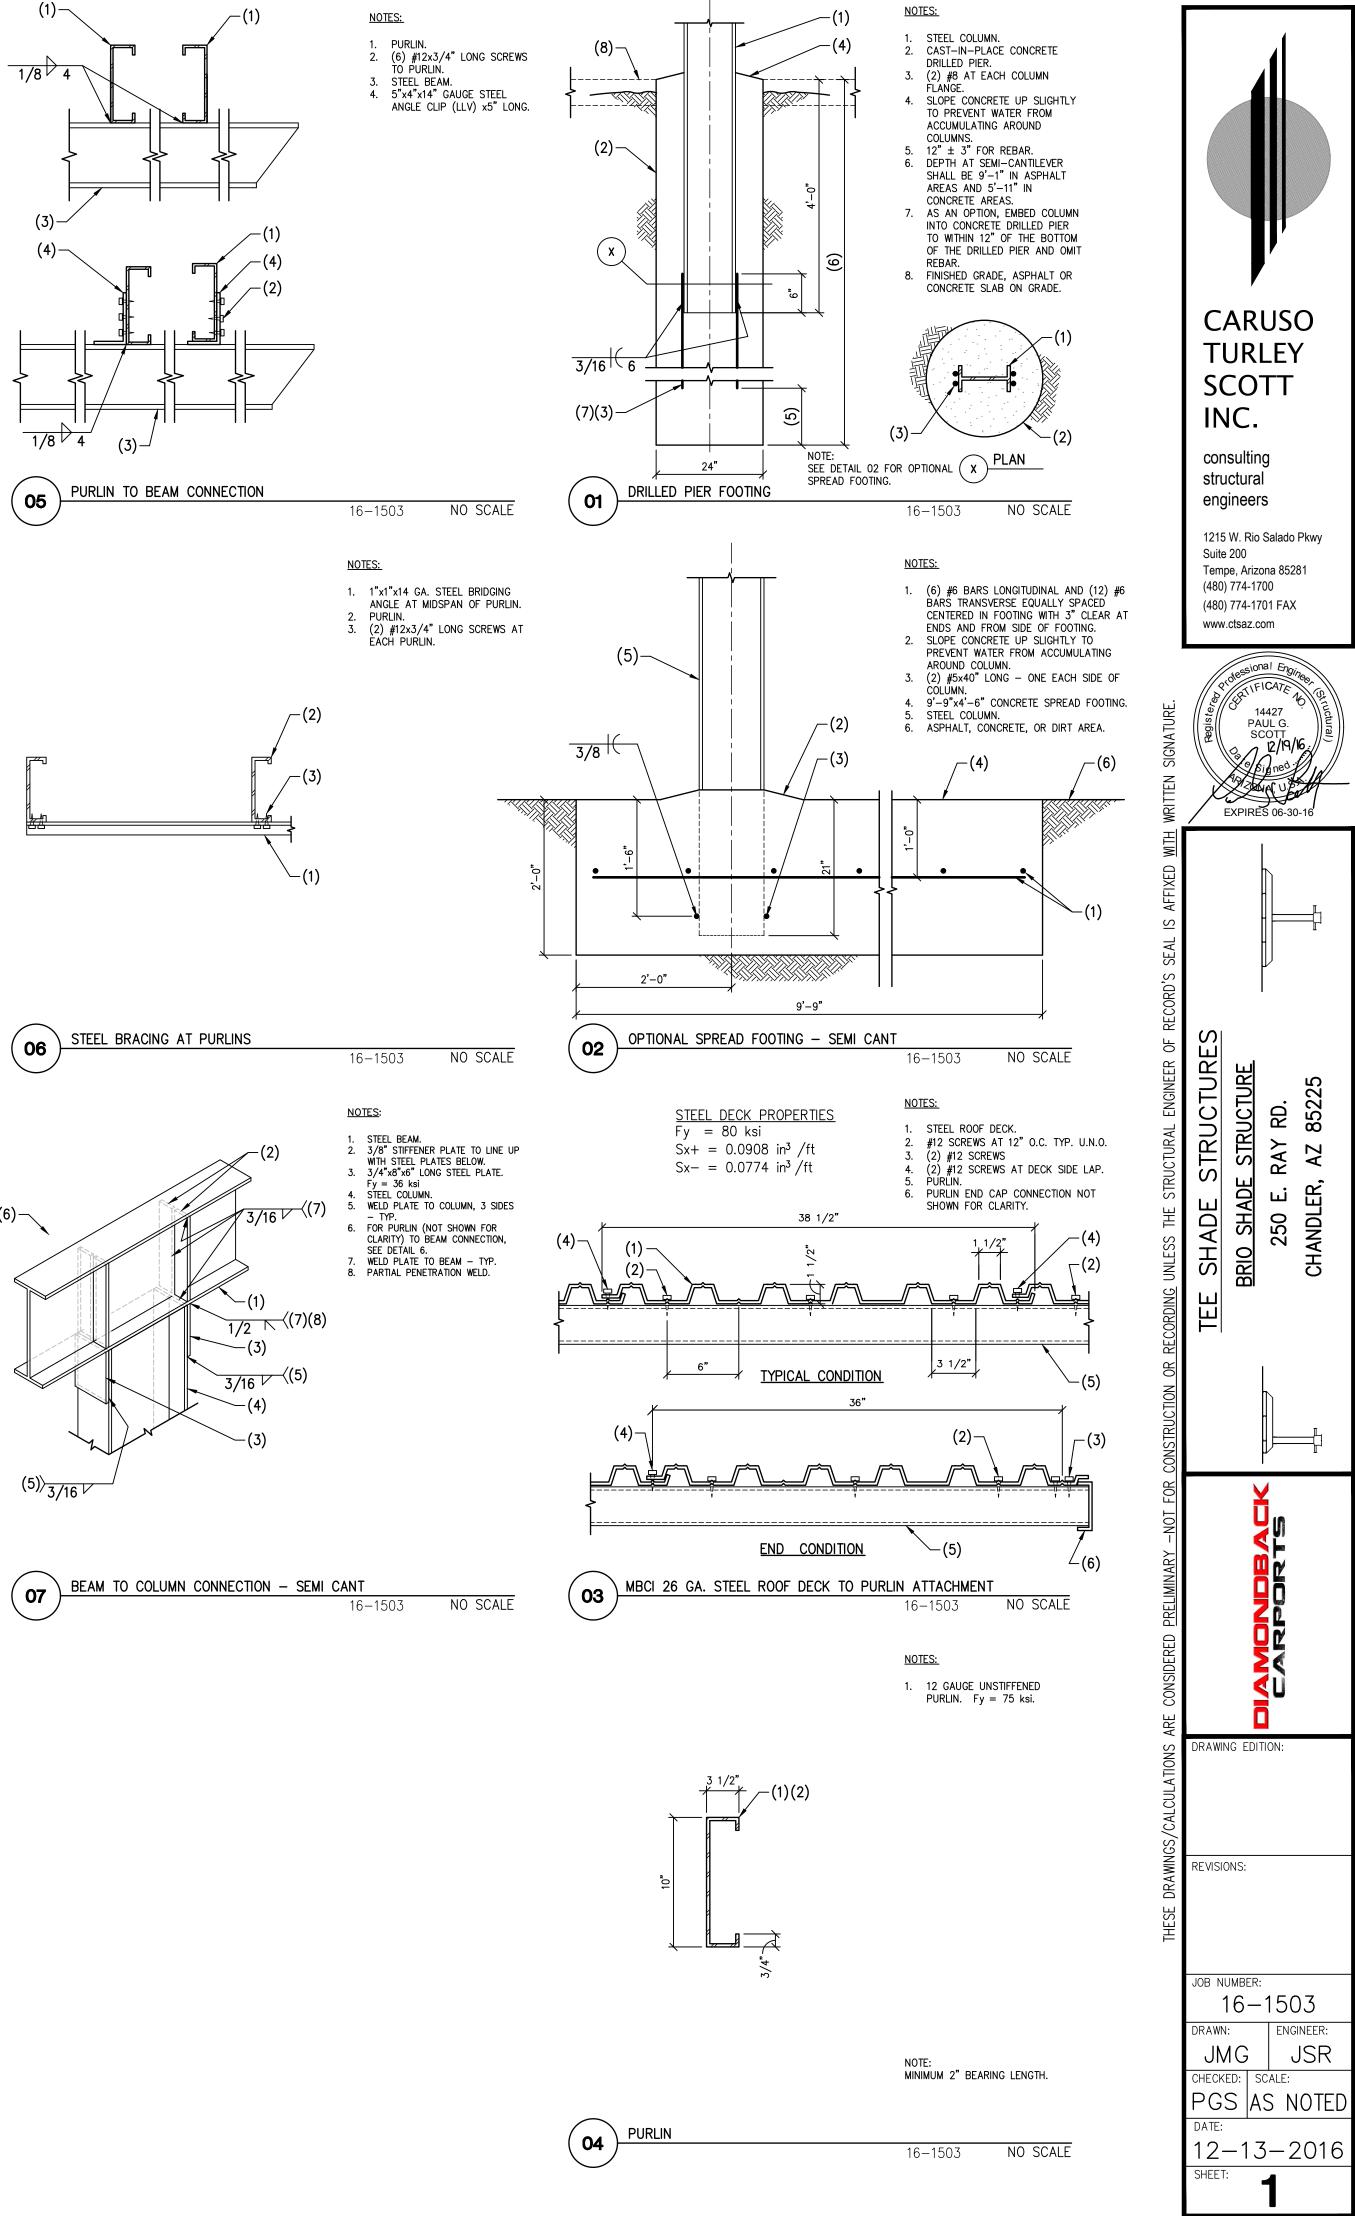





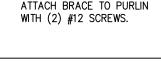



- SCREWS PER DETAIL 03 AND PLAN. CONTINUOUS END CAP TRIM. ATTACH TO PURLIN WITH #12x3/4" SCREWS AT TOP AND BOTTOM FLANGE AND SCREWS AT 12" O.C. INTO STEEL ROOF DECK. PURLIN.
- FASCIA TRIM ATTACH TO STEEL ROOF DECK WITH #8x3/4" LONG SCREWS AT 6" MAXIMUM FASCIA TRIM (OPTIONAL) ATTACH TO ROOF DECK WITH #8x3/4" LONG SCREWS AT 12" O.C.

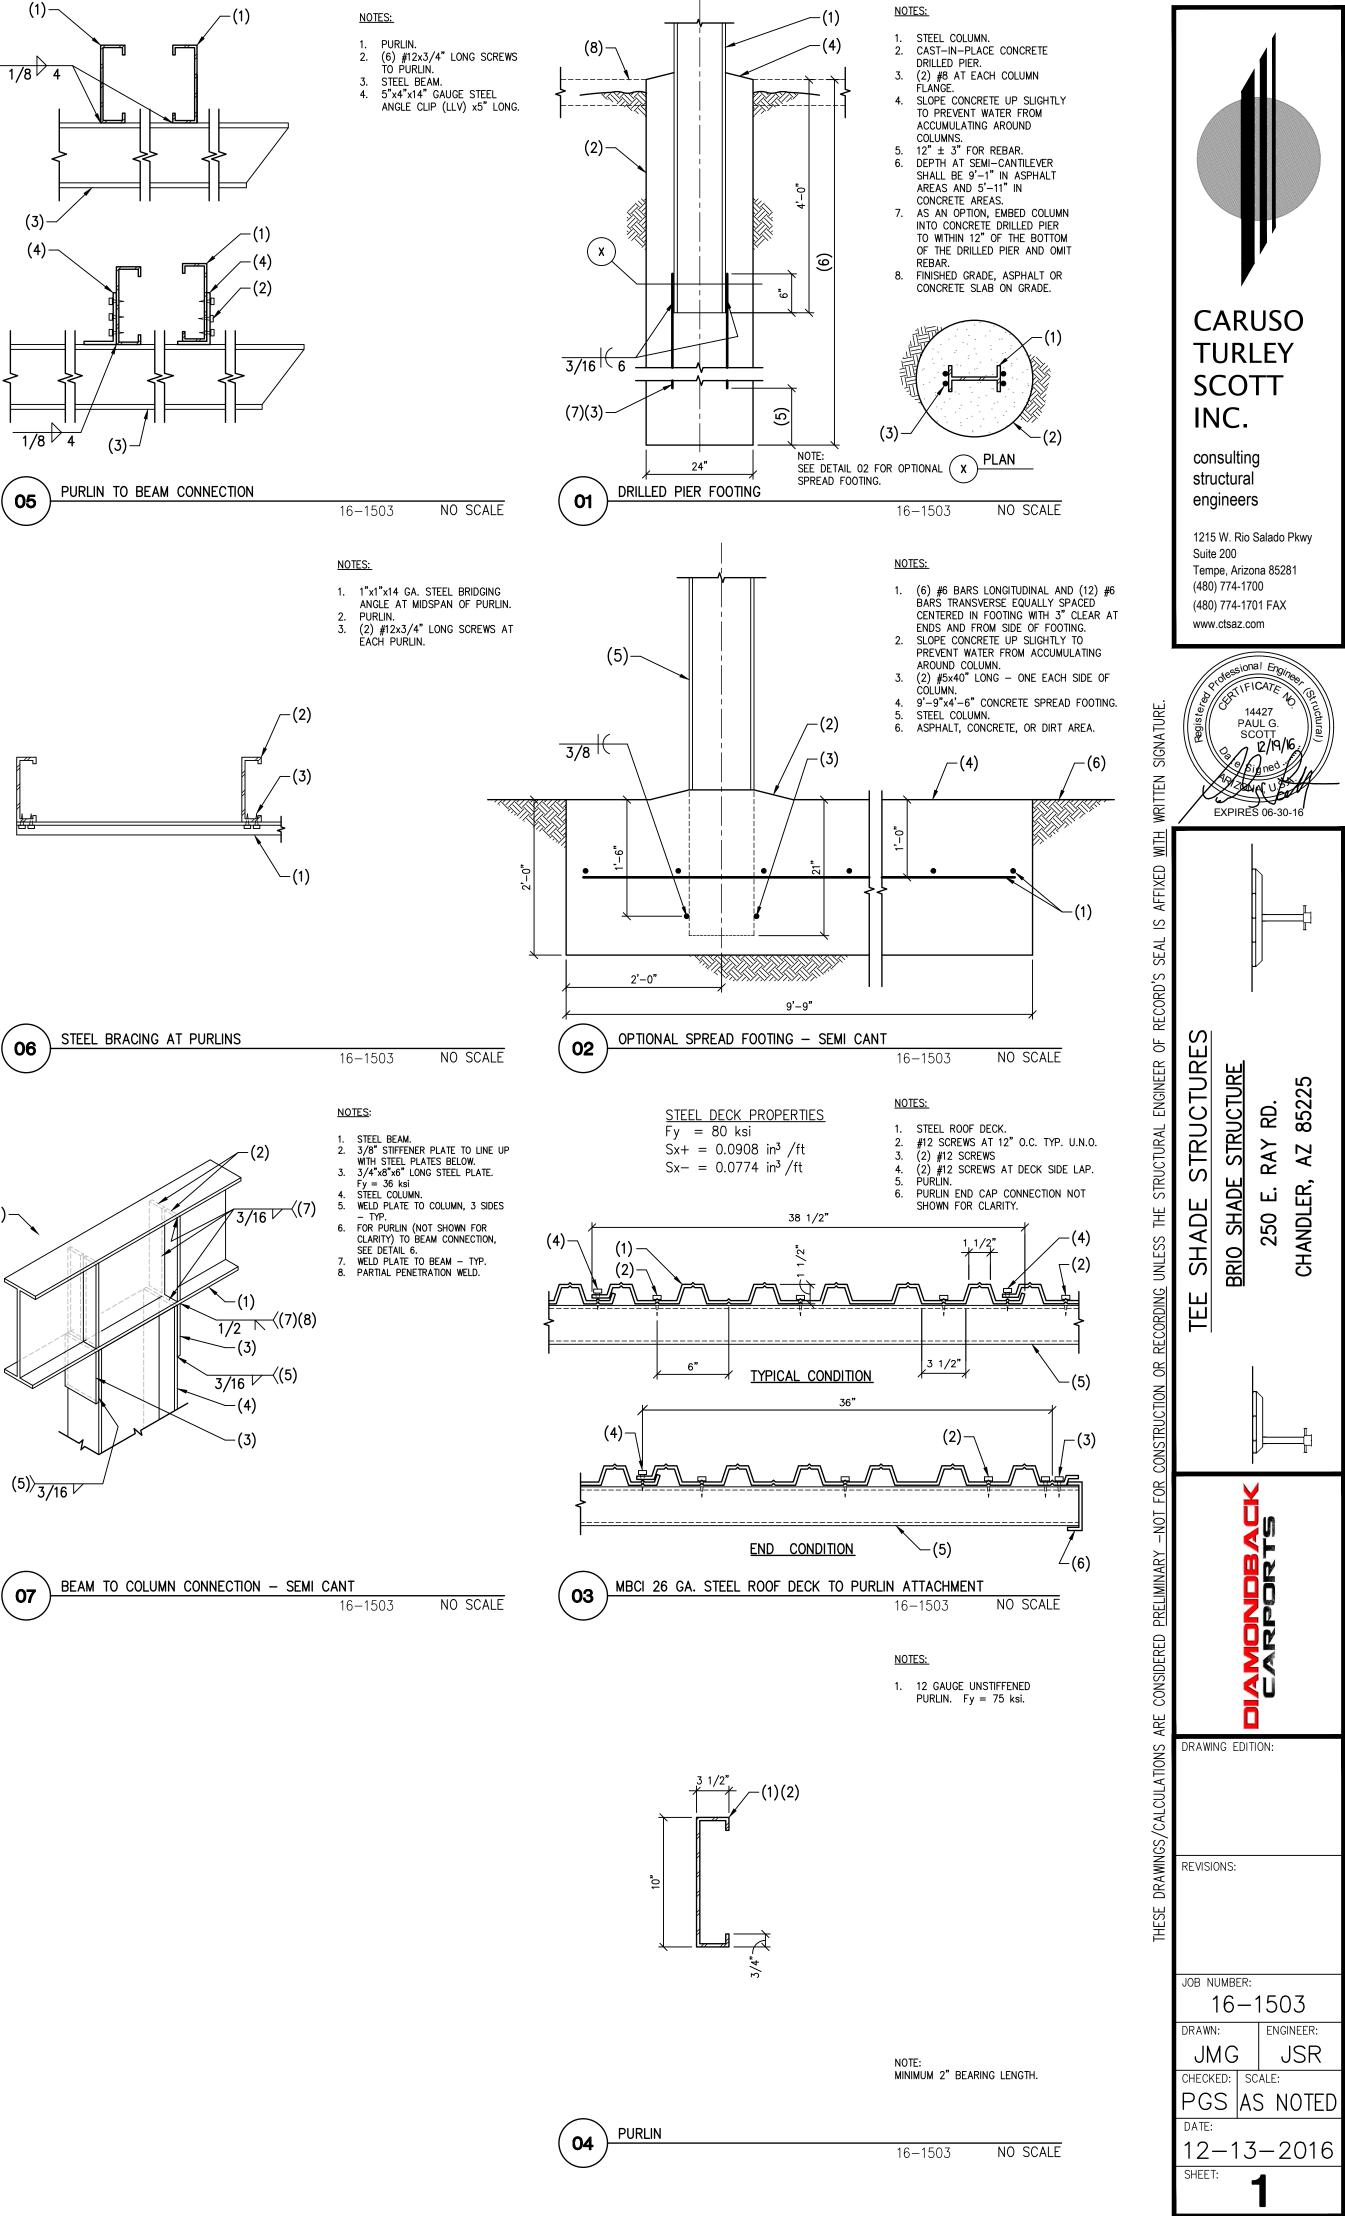DRIP EDGE (OPTIONAL ATTACH TO STEEL ROOF DECK WITH #8x3/4" LONG SCREWS AT 12" O.C.

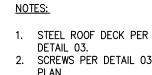


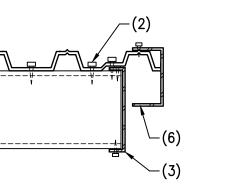


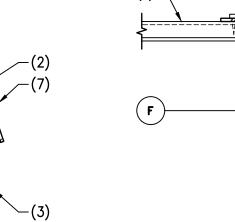

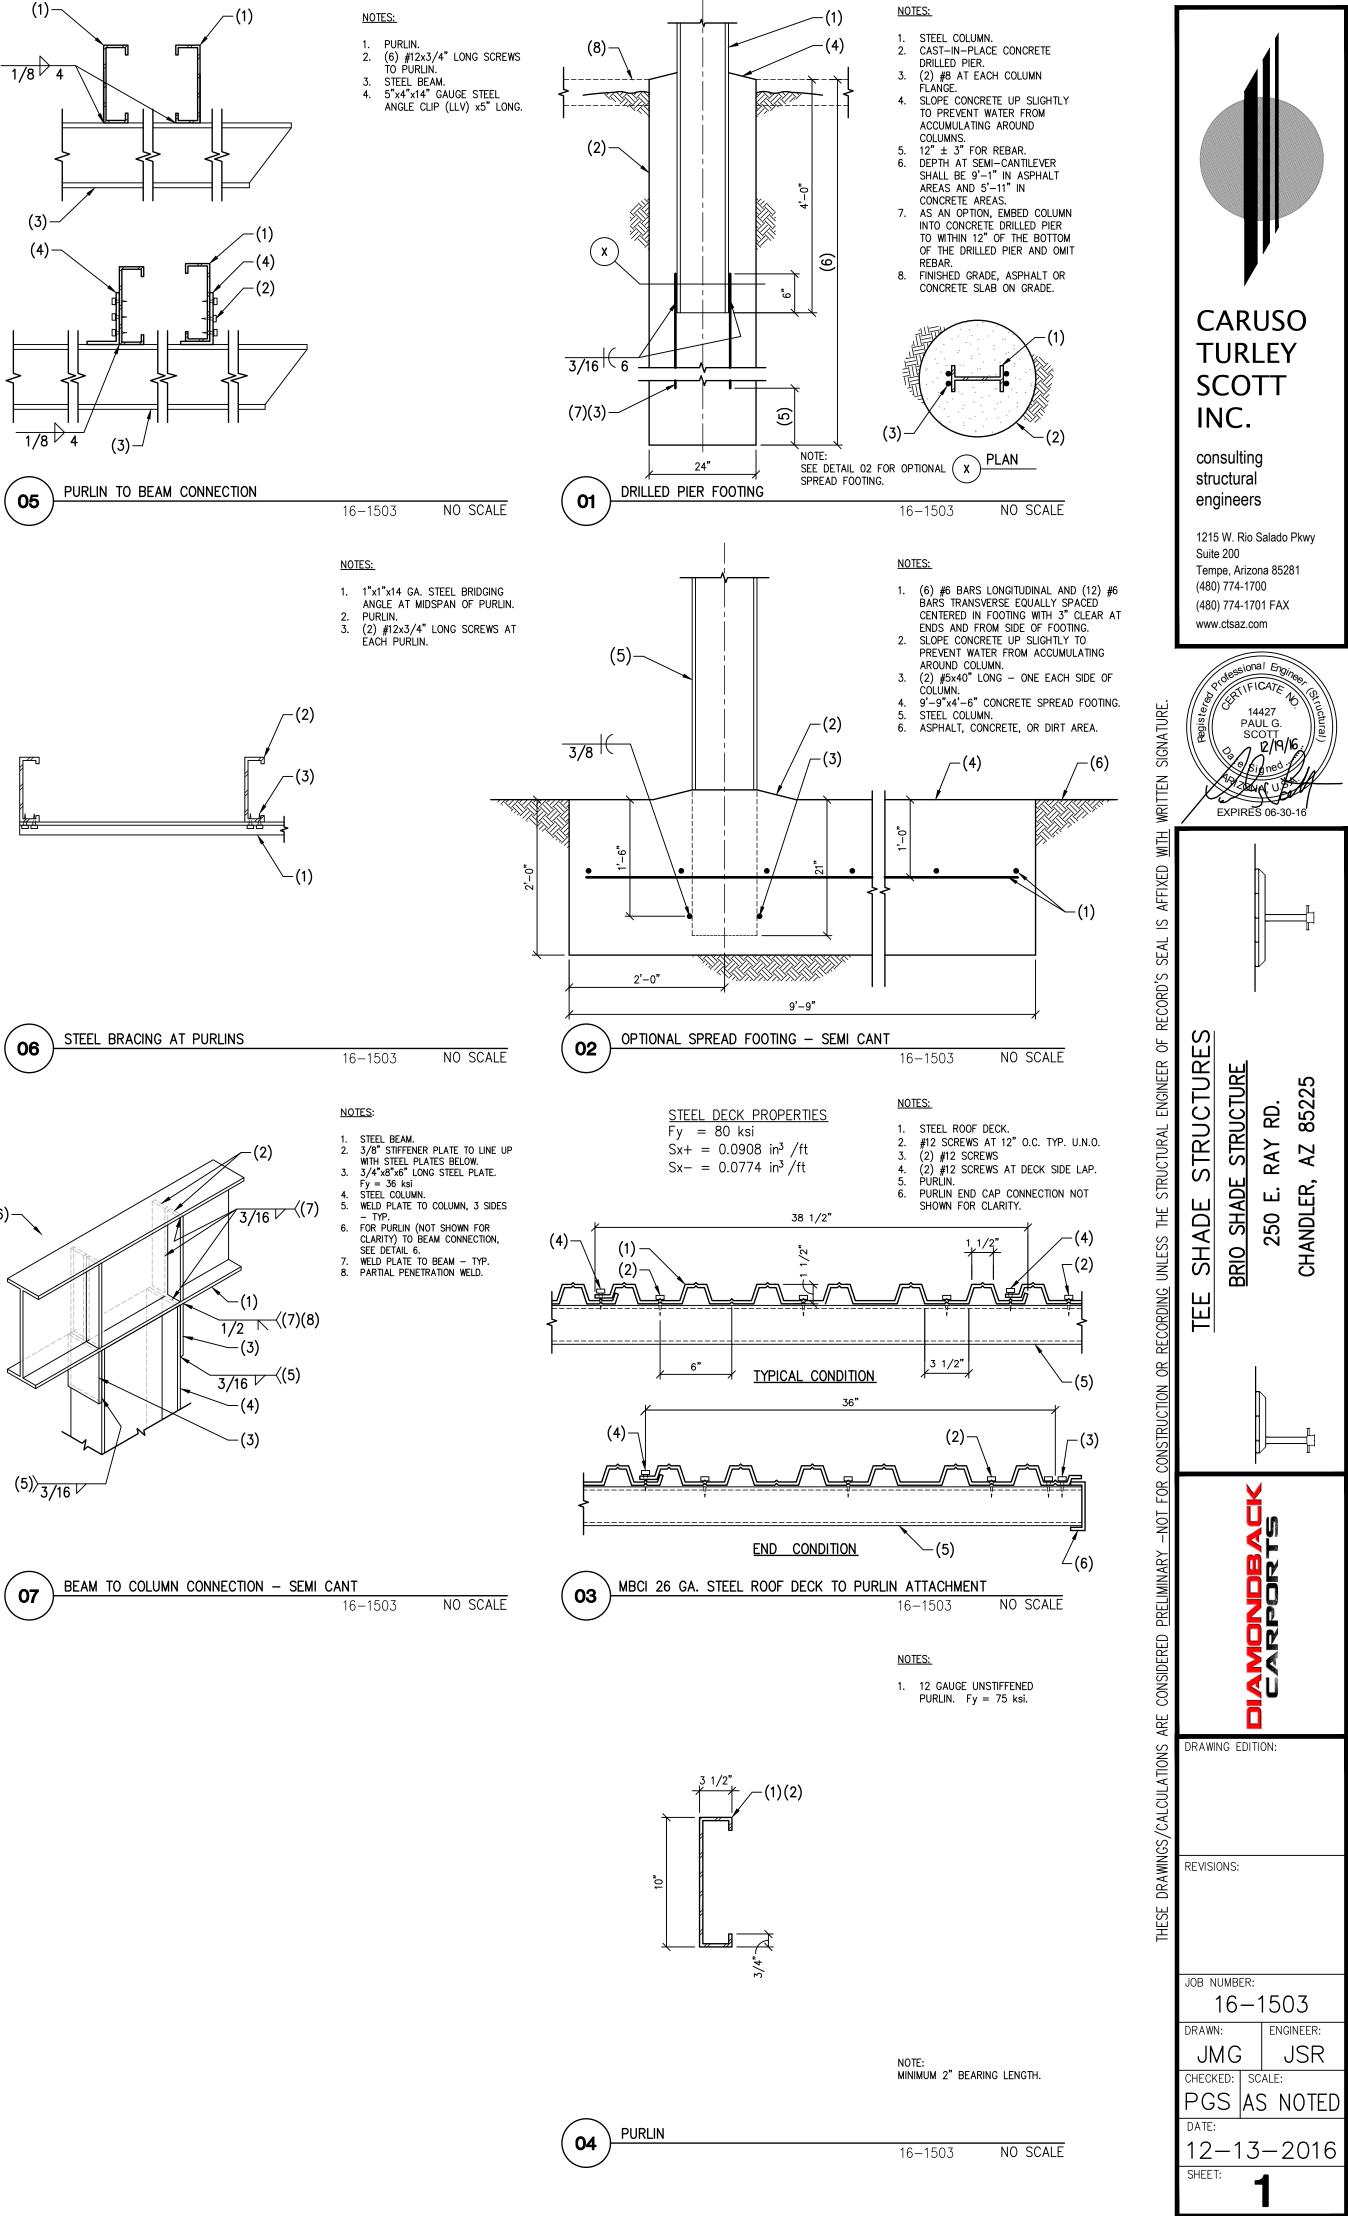


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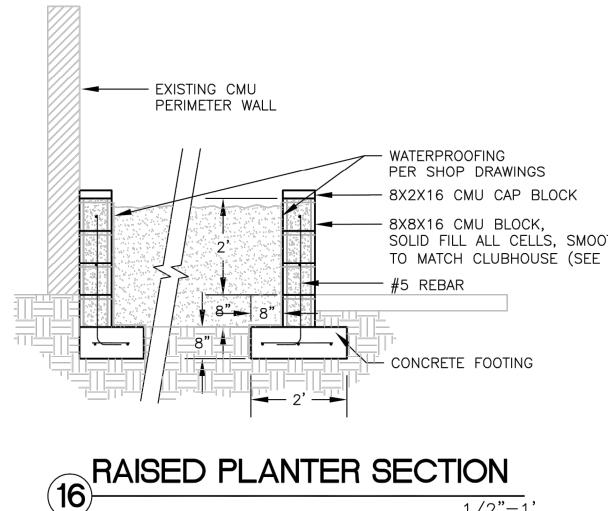


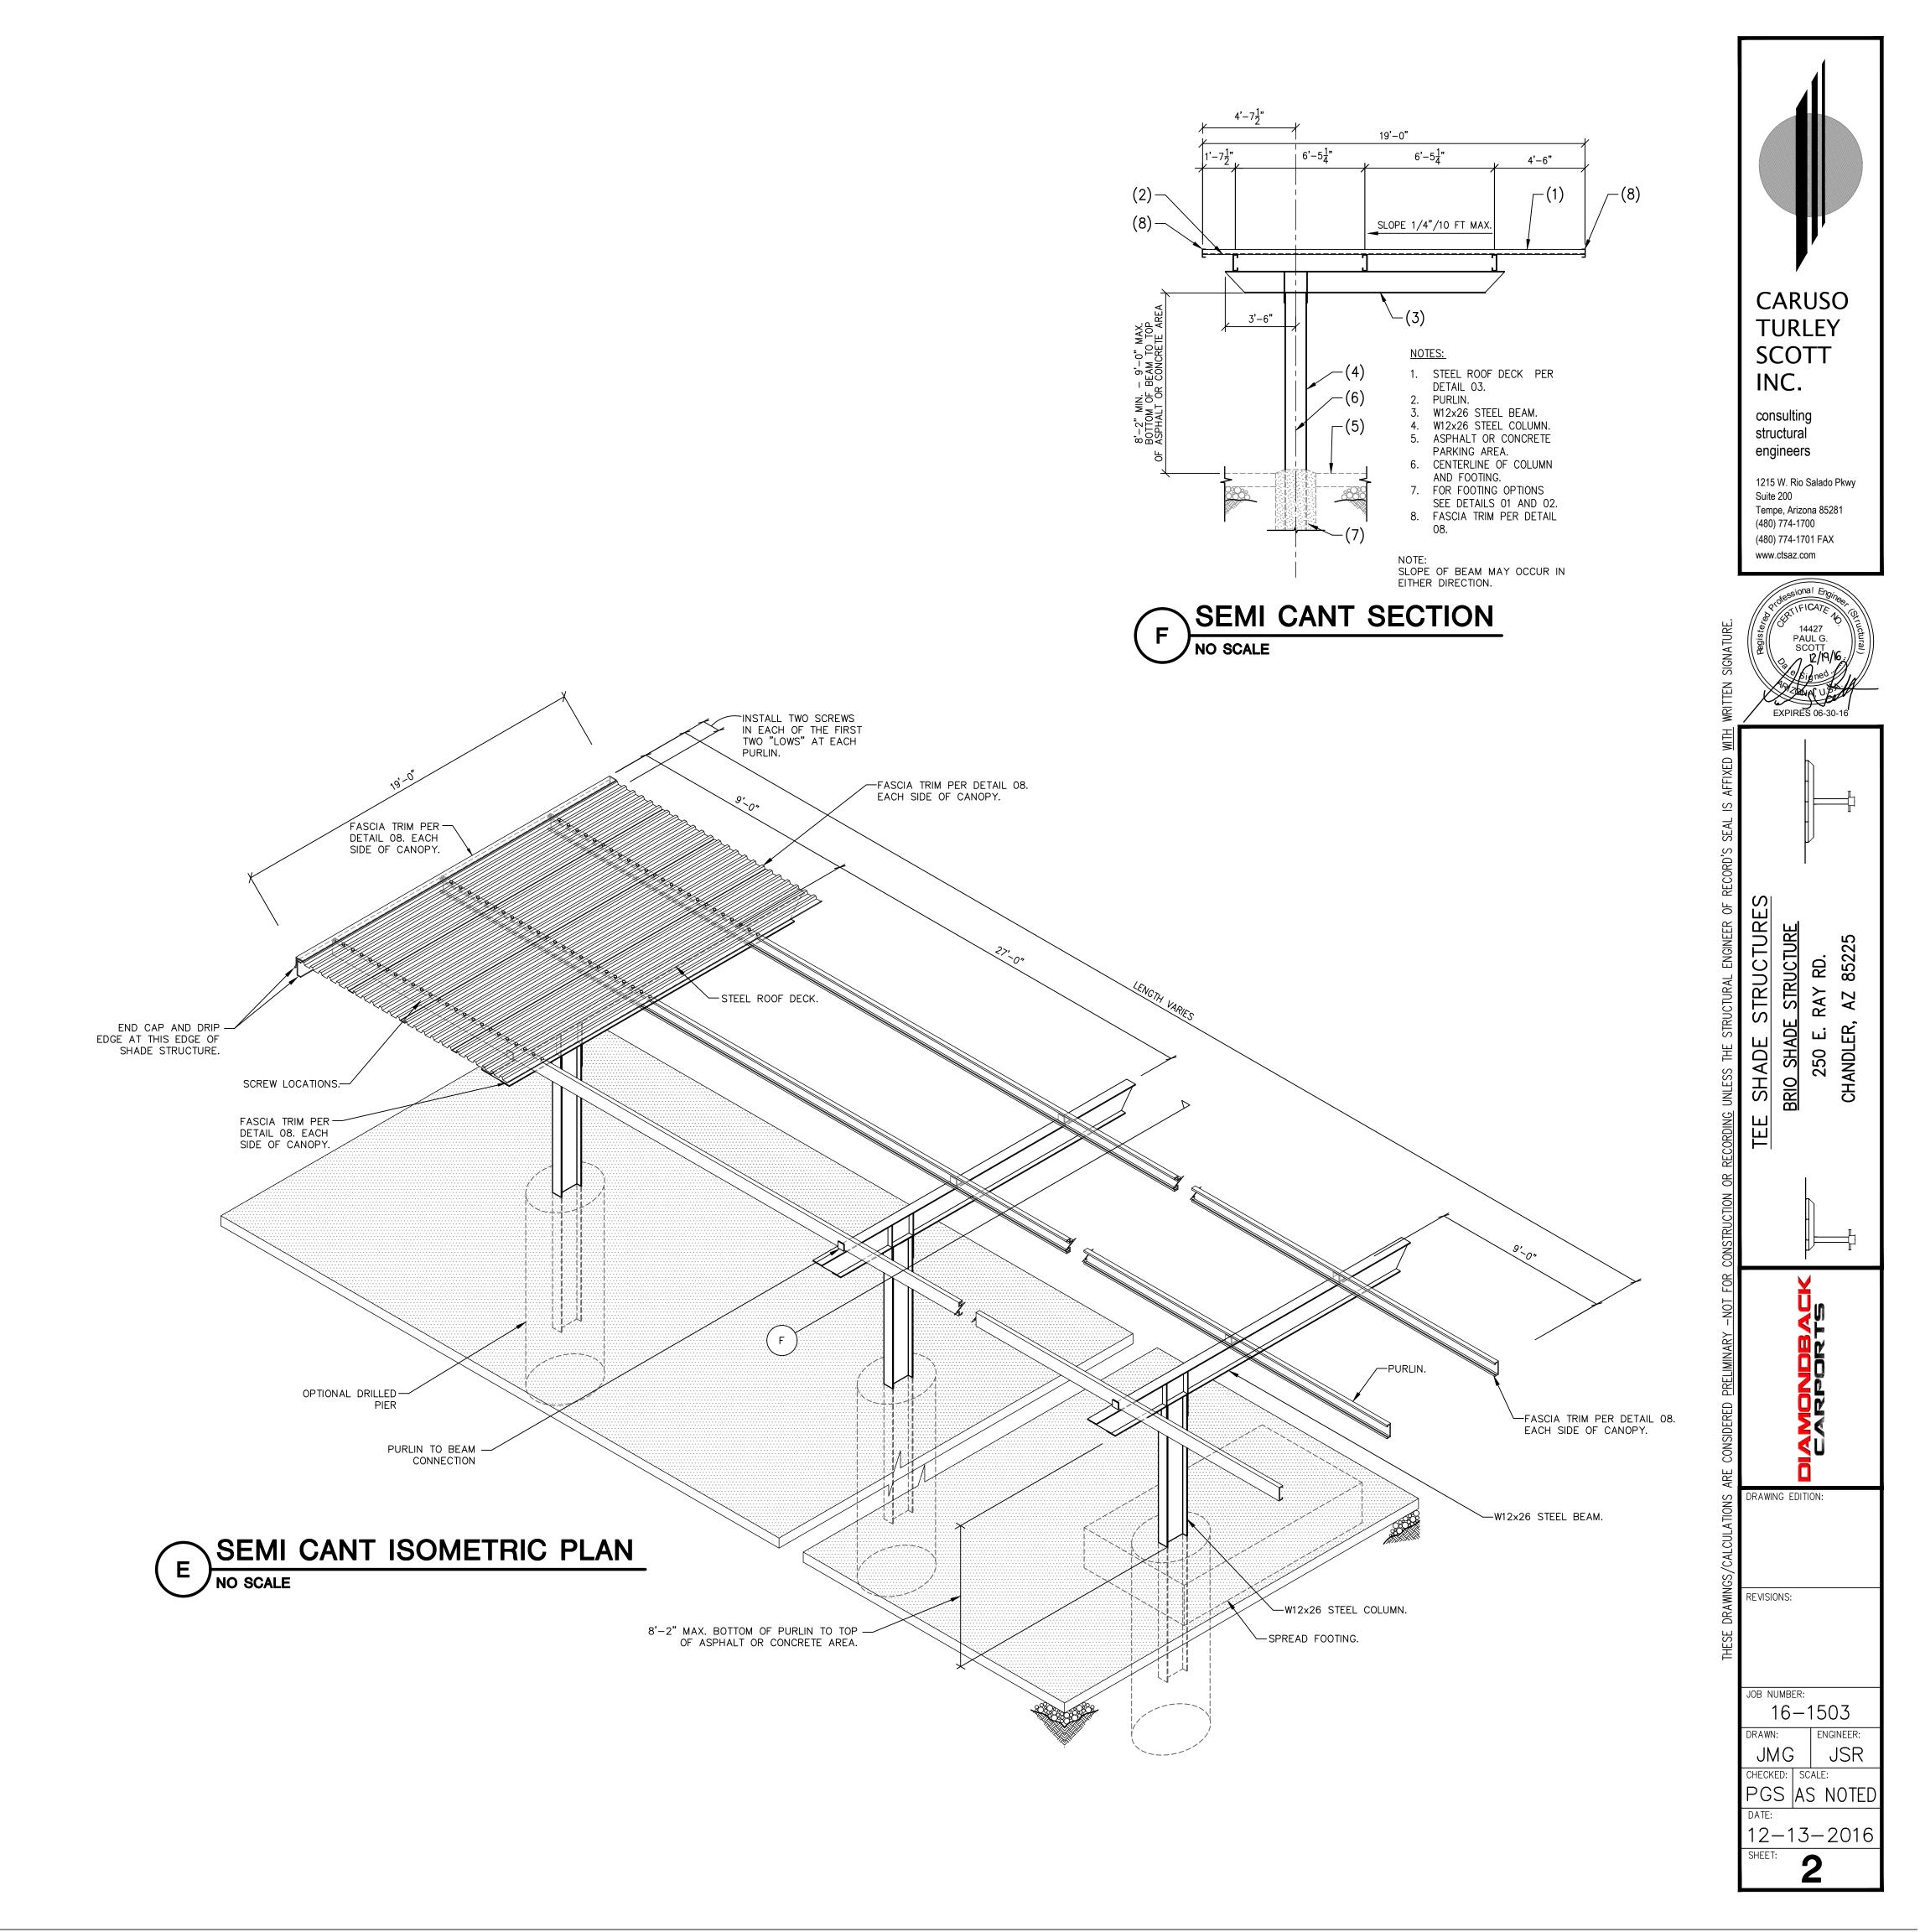


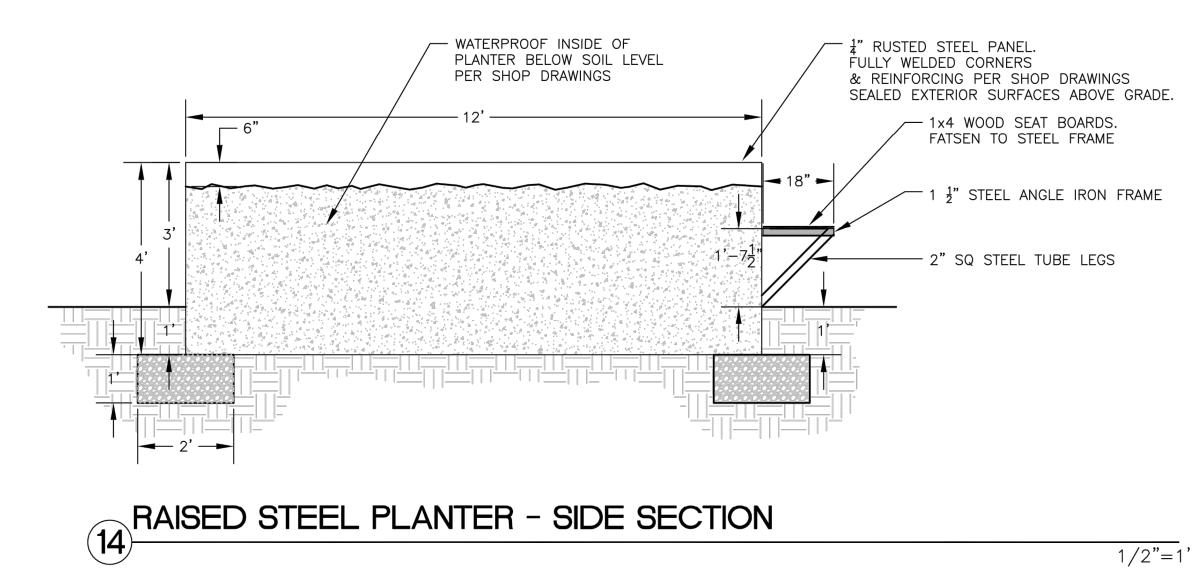Details Exhibit 3

# The Premiere at Eastmark 3.0



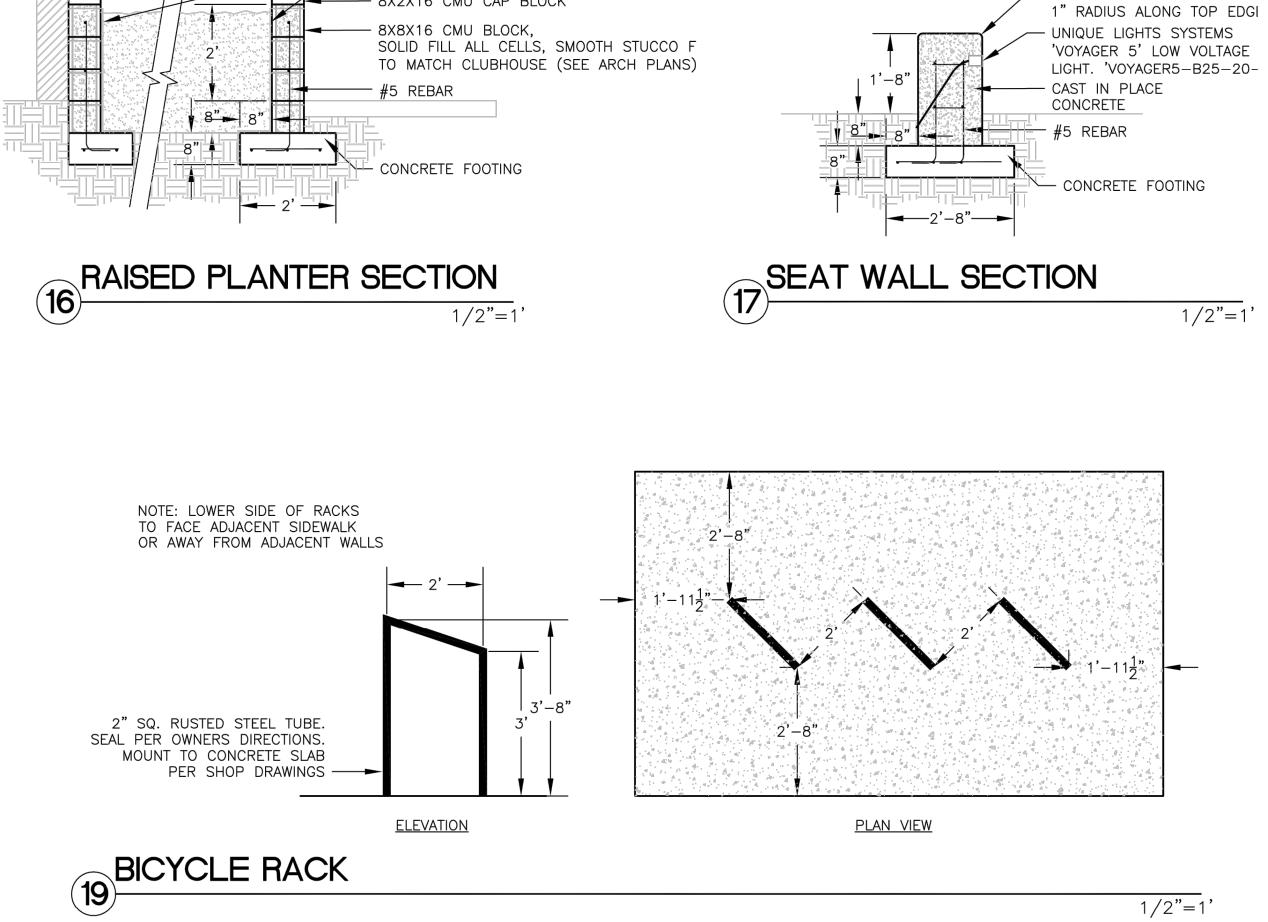

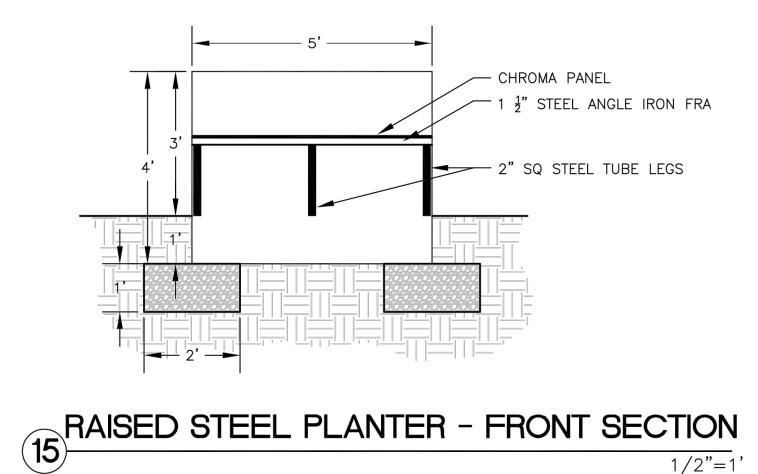








scale: per detail

- SMOOTH FINISH.

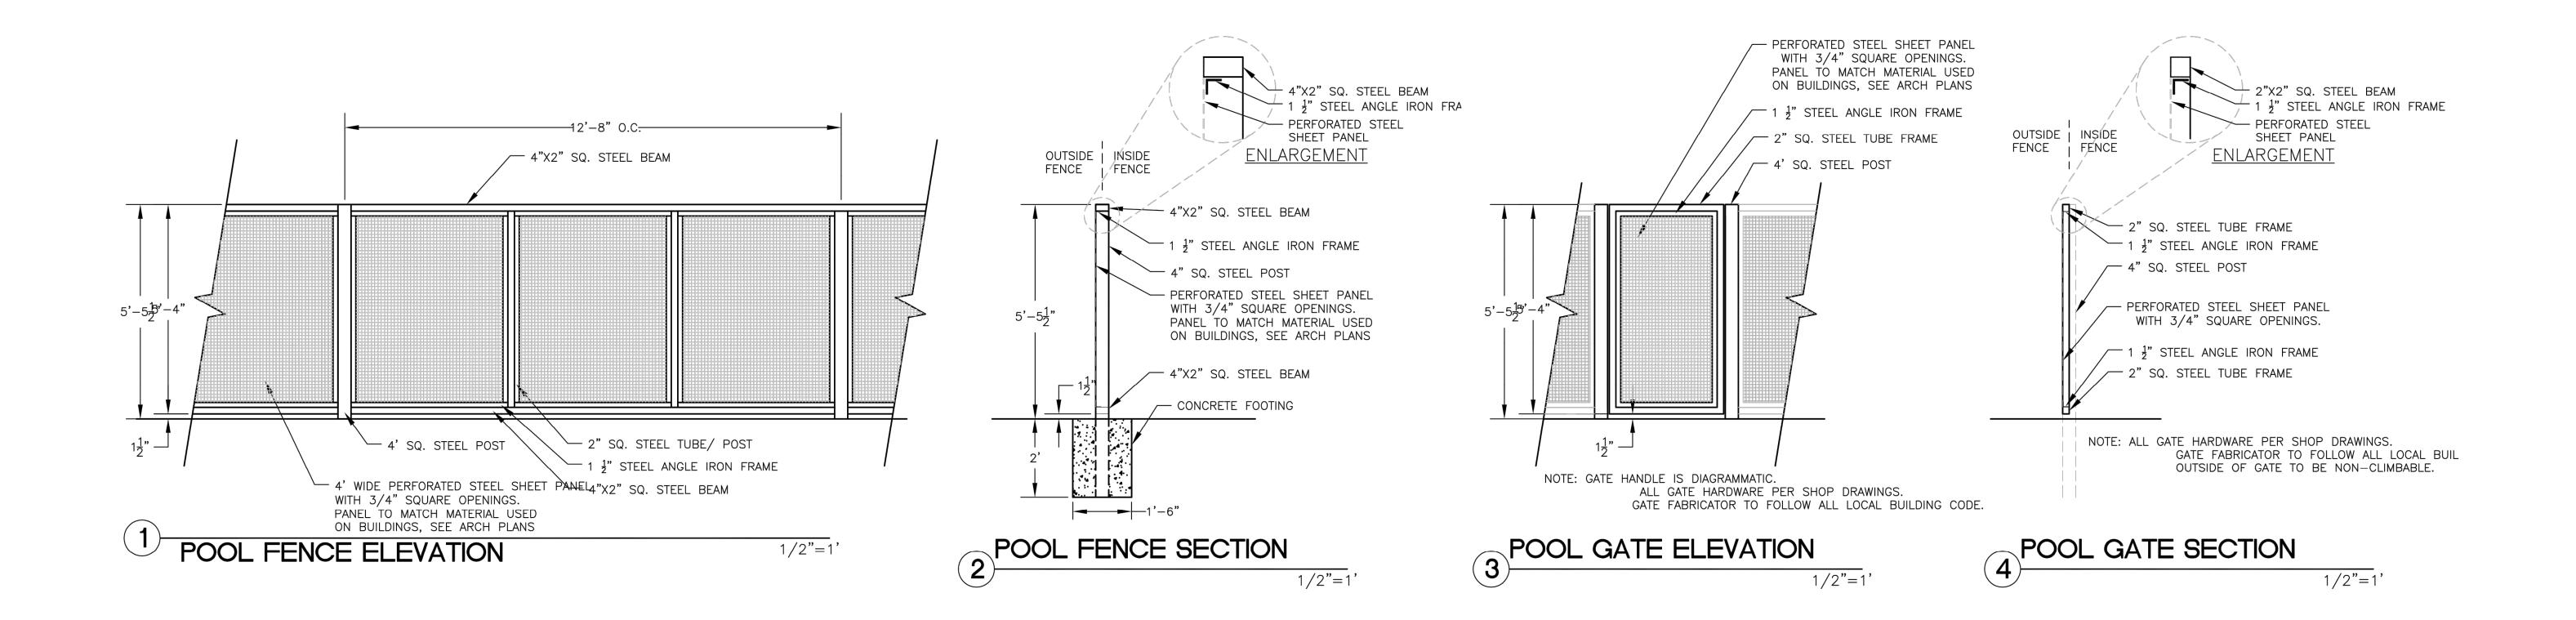

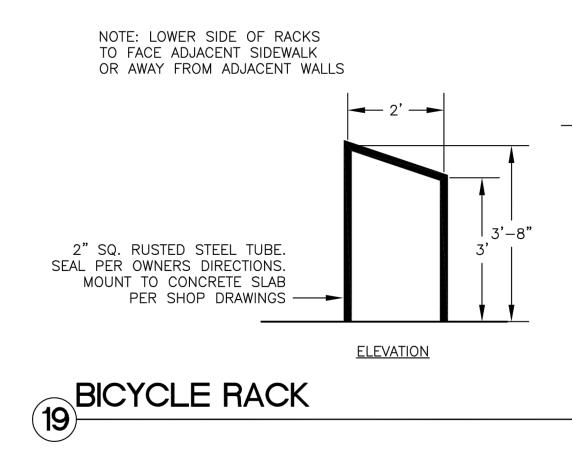

# The Premiere at Eastmark 3.0

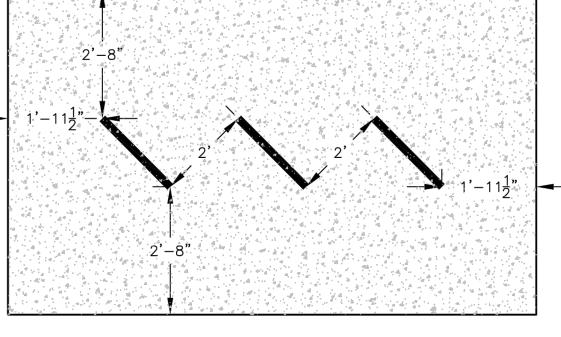

<u>PLAN VIEW</u>

1/2"=1'



scale: per detail