


OPEN AREA = 89,400 SF (22.5%) BUILDING AREA = 80,712 SF (20.3%) ASPHALT AND CONCRETE AREA = 227,155 SF (57.2%) LEGEND 42" A.F.G. HIGH MASONRY SCREENING WALL A SCREEN WALL. 5'-0" WIDE MIN. ACCESS - ROUTE COVERED PARKING 6'-0" A.F.G. HIGH MASONRY SCREENING WALL B SCREEN WALL. EASTMARK3.0 - AMENITIES PROVIDED: POOL SPA BBQ CORNHOLE TOT LOT RAMADA E POINT TWENTY TWO BLVD

VICINITY MAP

RAY ROAD


PROJECT NAME & ADDRESS: EASTMARK 3.0 SO29 5. ELISWORTH ROAD MESA, ARIZONA PROJECT DESCRIPTION: FOR RENT APARTMENTS WITH A CLUBHOUSE INCLUDING: LEASING CENTER, COMMUNITY CENTER & EXERCISE FACILITY. APARIMENT TYPES INCLUDE: ONE BEDROOM, TWO BEDROOM AND THREE BEDROOM UNITS. CARRAGE SULDINGS WITH ONE BEDROOM UNITS ABOVE ATTACHED GARAGES AT CABANA BUILDING AND PEDESTRIAN PATHWAYS AT COURTYARDS. SEE AMENITIES/SERVICES NOTES FOR DETAILED BREAKDOWN OF AMENITIES. GENERAL BUILDING CODE ANALYSIS: PROPOSED USE: MULTI-FAMILY RESIDENTIAL OCCUPANCIES: MULTI-FAMILY RESIDENTIAL OCCUPANCIES: WE Q RARGES A:3 @ CLUBHOUSE (B @ MGR. OFFICE) B @ MAIL BUILDING B @ CABANA B @ CARPORTS CONSTRUCTION TYPE: VA W/ NFPA 13 @ CLUBHOUSE VB @ MAILROOM VB @ CABANA IB @ CARPORTS FFECTIVE GOVERNING CODES: ADMIN. 2018 MESA BLIDG SAFETY ADMINISTRATIVE CODE IRC 2018 INTERNATIONAL RESIDENTIAL CODE IRC 2018 INTERNATIONAL RESIDENTIAL CODE IRC 2018 INTERNATIONAL RESIDENTIAL CODE IRC 2018 INTERNATIONAL BUILDING CODE IRC 2018 INTERNATIONAL RESIDENTIAL CODE IRC 2018 INTERNATIONAL RECODE IRC 2018 INTERNATIONAL RECODE IRC 2018 INTERNATIONAL RECODE IRC 2018 INTERNATIONAL RECODE IRC 2018 INTERNATIONAL RESIDENTIAL CODE IRC 2018 INTERNATIONAL RECODE IRC 2018 INTERNATIONAL SUMMINING POOL & SPA	ROUTE 2
SITE AREA: GROSS	RIAN BURTON BRIAN BURTON BRIAN BURTON BAND STRAW LATA ON A, U.S. Y.
PROJECT UNIT MIX: 1 BEDROOM / 1 BATH	NO DATE DESCRIPTION EASTMARK 3.0 MESA, AZ
PARKING AISLE (FIRELANE PER MESA FIRE) 26'-0" REQUIRED PARKING: (96) x 1.5 = 144 P.S. 1 BEDROOM. (106) x 2.0 = 212 P.S. GUEST. (202) x 0.1 = 21 P.S. TOTAL: (202) x 0.1 = 21 P.S. TOTAL: (377 P.S.) (ACCESSIBLE: 377 X 2%. 08 P.S.) PROVIDED PARKING: 140 P.S. PARKING SPACES. 140 P.S. ACCESSIBLE PARKING SPACES. 06 P.S. GARAGE. 17 P.S. GARAGE. 01 P.S. COVERED PARKING PER DWELLING. 01 P.S. COVERED ACCESSIBLE PARKING 02 P.S. OFF SITE PARKING. 02 P.S. OFF SITE PARKING 04 P.S. ACCESSIBLE PARKING 02 P.S. OFF SITE PARKING 04 P.S. TOTAL: 386 P.S. TOTAL: 386 P.S. PARKING RATIO PROVIDED: 386 P.S. BACKING / 202 UNITS = 1.91 PARKING / UNIT REQUIRED BICYCLE PARKING: (96 x 0.5) = 48	ARCHISTRUCT LLC 345 N. BEVERLY MESA, AZ 85201 TEL: (602) 750-0445 WWW.ARCHISTRUCTDB.COM THE OWNER, ARCHITECT, AND ENGINEER EXPRESSLY DISCLAIM ANY RESPONSIBILITY ARISING FROM ANY UNAUTHORIZED USE OF THESE PLANS, DRAWINGS, AND NOTES. ANY AUTHORIZATION MUST BE IN WRITING. THIS DRAWING COPY MAY HAVE BEEN REPRODUCED AT A SIZE DIFFERENT THAN ORIGINALLY DRAWN. THE OWNER, ARCHITECT, AND ENGINEER ASSUME NO RESPONSIBILITY FOR THE USE OF INCORRECT SCALE.
2 BEDROOM / 2 BATH(106 x 0.5) = 53 <u>GUEST</u>	
 "Fire apparatus access roads are essential during construction to allow emergency response to the site for both fire and medical emergencies. Access roads shall be in place prior to the start of vertical construction. It is important to develop access roads at an early stage of construction to allow for fire department access to the site in the case of fire or injury." b. "Required fire apparatus access road during construction or demolition shall comply with Mesa Fire and Medical Department standard detail FPD 3310.1. The access road shall be a minimum of 20 feet wide of all-weather driving surface, graded to drain standing water and engineered to bear the imposed loads of fire apparatus (78,000 lbs. / 24,000 lbs. front axle, 54,000 lbs. rear axle) when roads are wet. The access road shall be extended to within 200 feet of any combustible materials and/or any location on the jobsite where any person(s) shall be working for a minimum of four (4) continuous hour in any day. A clearly visible sign marked "Fire Department Access", in red letters, shall be provided at the entry to the access road. 	AHJ STAMP
 All open trenches shall have steel plates capable of maintaining the integrity of the access road design when these trenches cross an access road. These access roads may be tmeporary or permanent. This policy applies only during construction and/or demolitiion. Permanent access per the Mesa Fire Code shall be in place prior to any final inspection or certificate of occupancy." c. Water supply for fire protection. An approved water supply for construction site shall meet the requirements of Appendix Chapters B and C. The minimum fire flow requirement when contractor or developer brings combustible materials on site is 1,500 gpm at 25 psi. At least one fire hydrant shall be within 500 feet of any combustible material and capable of delivering the minum fire flow requirement. This hydrant or hydrants may 	CITY PROJECT NUMBER: DRAWING TITLE: Architectural_Area Calculation
be either temporary or permanent as the project schedule permits. In additiion, there are times when hydrants and valves must be closed temporarily for repair work or construction of the water system. The developer/contractor is responsible for ensuring that the water supply is available. When the work is complete, developer/contractor shall make sure that the fire hydrants are active and the valves are open.	PROJECT NO: DRAWING NUMBER:

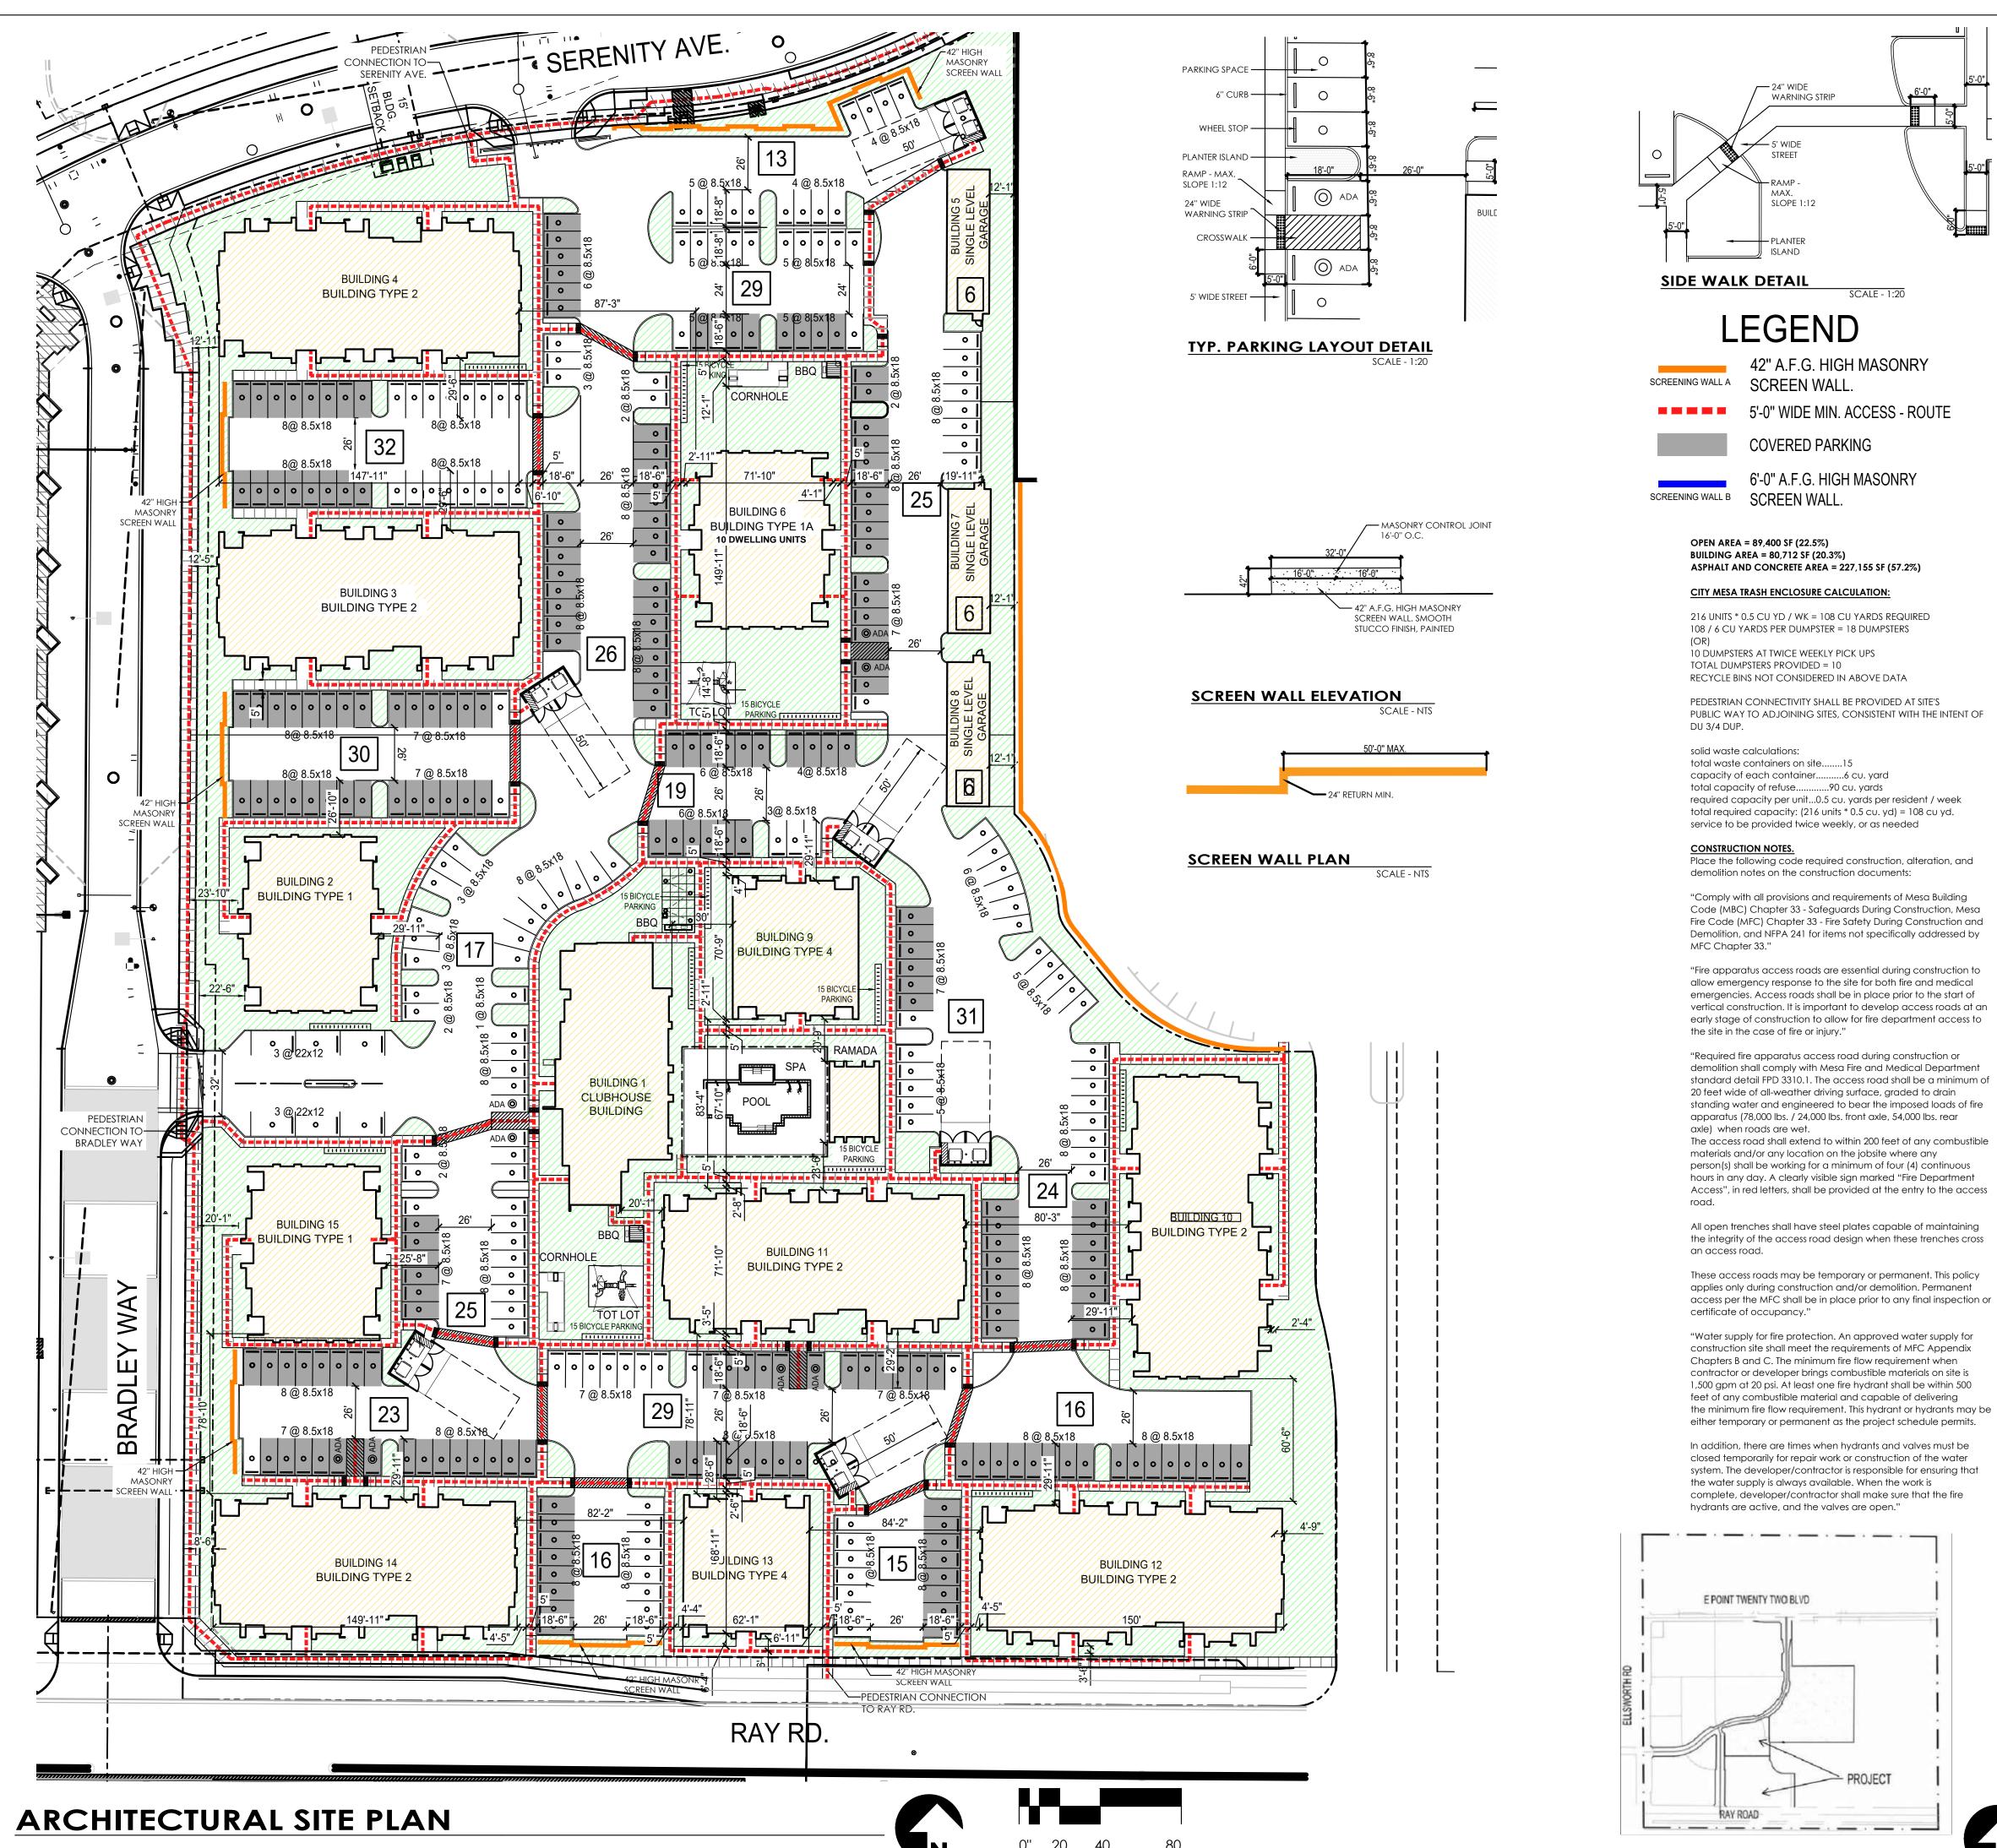


SCALE:

1'' = 40'-0''

VICINITY MAP

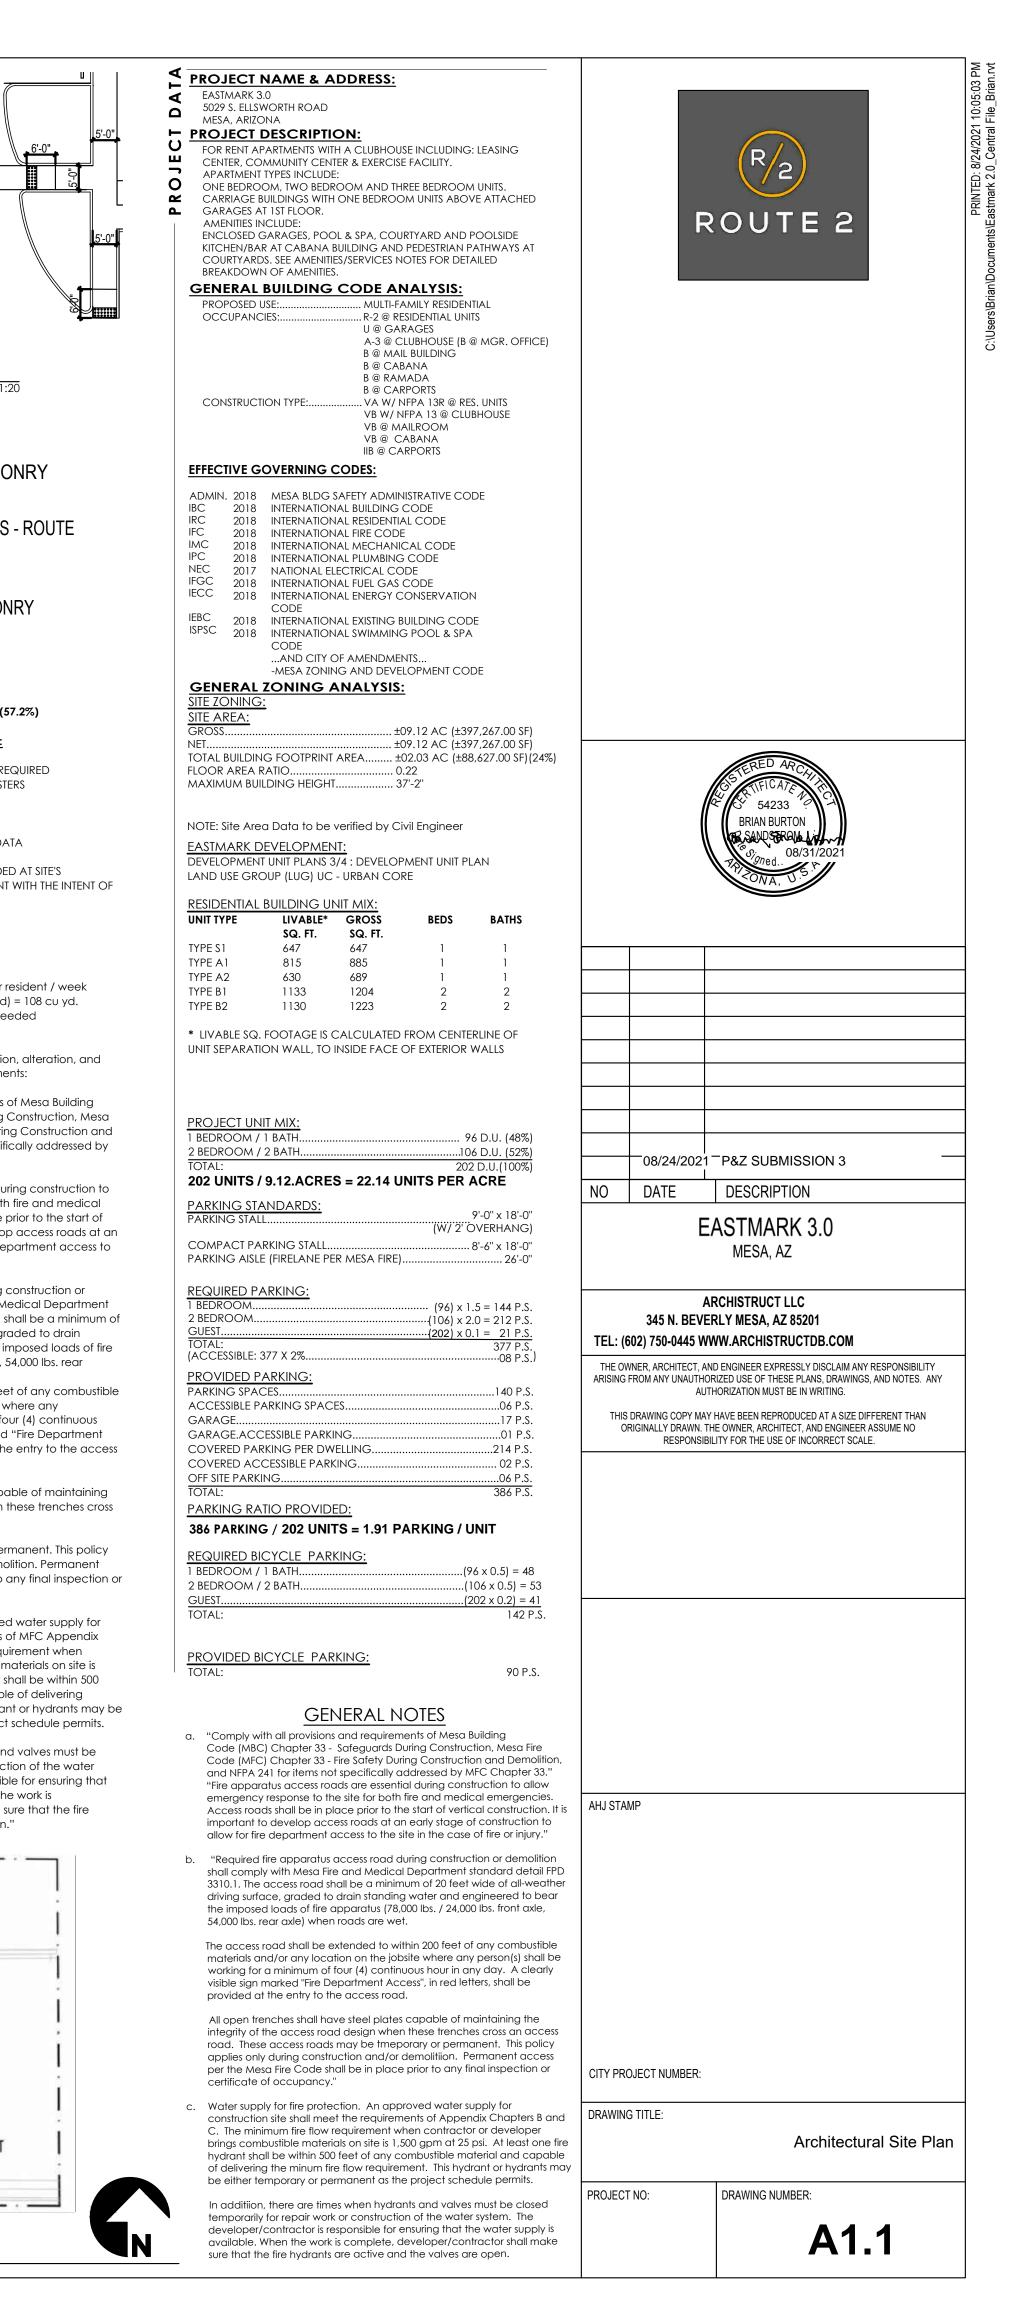



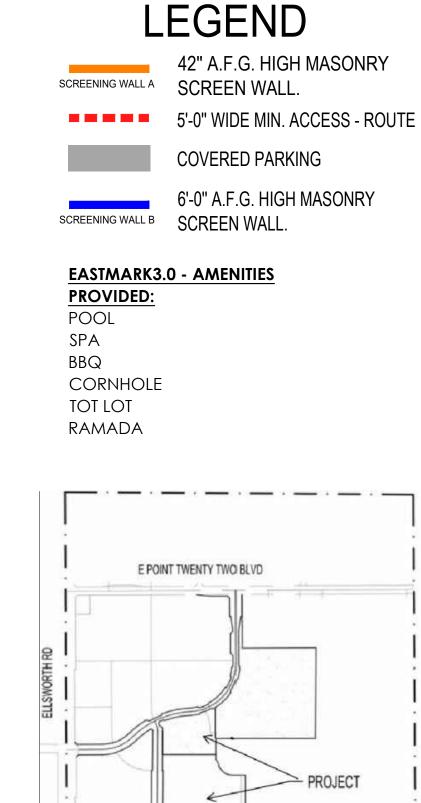

RAY ROAD

_ · __ · __ ·

VICINITY MAP

PROJECT NAME & ADDRESS: EASTMARK 3.0 5029 S. ELLSWORTH ROAD MESA, ARIZONA PROJECT DESCRIPTION: FOR RENT APARTMENTS WITH A CLUBHOUSE INCLUDING: LEASING CENTER, COMMUNITY CENTER & EXERCISE FACILITY. APARTMENT TYPES INCLUDE: ONE BEDROOM, TWO BEDROOM AND THREE BEDROOM UNITS. CARRIAGE BUILDINGS WITH ONE BEDROOM UNITS ABOVE ATTACHED GARAGES AT 1ST FLOOR. AMENITIES INCLUDE: ENCLOSED GARAGES, POOL & SPA, COURTYARD AND POOLSIDE KITCHEN/BAR AT CABANA BUILDING AND PEDESTRIAN PATHWAYS AT COURTYARDS. SEE AMENITIES/SERVICES NOTES FOR DETAILED BREAKDOWN OF AMENITIES. PROPOSED USE: PROPOSED USE: U @ GARAGES A-3 @ CLUBHOUSE (B @ MGR. OFFICE) B @ MAIL BUILDING B @ CABANA B @ RAMADA B @ CABANA B @ RAMADA B @ CABRORTS CONSTRUCTION TYPE: VA W/ NFPA 13R @ RES. UNITS VB W/ NFPA 13R @ CLUBHOUSE VB @ MAILROOM VB @ CABANA	ROUTE 2
IB @ CARPORTS FFFECTIVE GOVERNING CODES: ADMIN. 2018 MESA BLDG SAFETY ADMINISTRATIVE CODE IBC 2018 INTERNATIONAL BUILDING CODE IRC 2018 INTERNATIONAL RESIDENTIAL CODE IFC 2018 INTERNATIONAL FIRE CODE IMC 2018 INTERNATIONAL FIRE CODE IFC 2018 INTERNATIONAL PLUMBING CODE IFC 2018 INTERNATIONAL PLUMBING CODE IFC 2018 INTERNATIONAL ELECTRICAL CODE IFC 2018 INTERNATIONAL ENERGY CONSERVATION CODE IEC 2018 INTERNATIONAL EXISTING BUILDING CODE IFC 2018 INTERNATIONAL EXISTING BUILDING CODE IFSC 2018 INTERNATIONAL EXISTING BUILDING CODE IFSPSC 2018 INTERNATIONAL SWIMMING POOL & SPA CODEAND CITY OF AMENDMENTSMESA ZONING AND DEVELOPMENT CODE GENERAL ZONING ANALYSIS: SITE ZONING: SITE AREA: GROSS	FRED ARC FICATOR SAUDESRAUALI SAUDESRAUALI SONDESRAUALI SONDESRAUALI SONDESRAUALI SONDESRAUALI SAUDESRAUALI
LASTMARK DEVELOPMENT.DEVELOPMENT UNIT PLANS 3/4 : DEVELOPMENT UNIT PLAN LAND USE GROUP (LUG) UC - URBAN CORERESIDENTIAL BUILDING UNIT MIX: UNIT TYPEUNIT TYPELIVABLE*GROSSBEDSBATHSSQ. FT.SQ. FT.SQ. FT.TYPE S164764711TYPE A181588511TYPE A263068911TYPE B11133120422TYPE B21130122322* LIVABLE SQ. FOOTAGE IS CALCULATED FROM CENTERLINE OF UNIT SEPARATION WALL, TO INSIDE FACE OF EXTERIOR WALLS	
PROJECT UNIT MIX: 1 BEDROOM / 1 BATH	NO DATE DESCRIPTION EASTMARK 3.0 MESA, AZ
REQUIRED PARKING: 1 BEDROOM	345 N. BEVERLY MESA, AZ 85201 TEL: (602) 750-0445 WWW.ARCHISTRUCTDB.COM THE OWNER, ARCHITECT, AND ENGINEER EXPRESSLY DISCLAIM ANY RESPONSIBILITY ARISING FROM ANY UNAUTHORIZED USE OF THESE PLANS, DRAWINGS, AND NOTES. ANY AUTHORIZATION MUST BE IN WRITING. THIS DRAWING COPY MAY HAVE BEEN REPRODUCED AT A SIZE DIFFERENT THAN ORIGINALLY DRAWN. THE OWNER, ARCHITECT, AND ENGINEER ASSUME NO RESPONSIBILITY FOR THE USE OF INCORRECT SCALE.
PARKING RATIO PROVIDED: 386 PARKING / 202 UNITS = 1.91 PARKING / UNIT REQUIRED BICYCLE PARKING: 1 BEDROOM / 1 BATH	
TOTAL: 90 P.S. <u>GENERAL NOTES</u> "Comply with all provisions and requirements of Mesa Building Code (MBC) Chapter 33 - Safeguards During Construction, Mesa Fire Code (MFC) Chapter 33 - Fire Safety During Construction and Demolition, and NFPA 241 for items not specifically addressed by MFC Chapter 33." "Fire apparatus access roads are essential during construction to allow emergency response to the site for both fire and medical emergencies. Access roads shall be in place prior to the start of vertical construction. It is important to develop access roads at an early stage of construction to allow for fire department access to the site in the case of fire or injury."	AHJ STAMP
"Required fire apparatus access road during construction or demolition shall comply with Mesa Fire and Medical Department standard detail FPD 3310.1. The access road shall be a minimum of 20 feet wide of all-weather driving surface, graded to drain standing water and engineered to bear the imposed loads of fire apparatus (78,000 lbs. / 24,000 lbs. front axle, 54,000 lbs. rear axle) when roads are wet. The access road shall be extended to within 200 feet of any combustible materials and/or any location on the jobsite where any person(s) shall be working for a minimum of four (4) continuous hour in any day. A clearly visible sign marked "Fire Department Access", in red letters, shall be	
provided at the entry to the access road. All open trenches shall have steel plates capable of maintaining the integrity of the access road design when these trenches cross an access road. These access roads may be tmeporary or permanent. This policy applies only during construction and/or demolitiion. Permanent access per the Mesa Fire Code shall be in place prior to any final inspection or certificate of occupancy." Water supply for fire protection. An approved water supply for construction site shall meet the requirements of Appendix Chapters B and C. The minimum fire flow requirement when contractor or developer brings combustible materials on site is 1,500 gpm at 25 psi. At least one fire	CITY PROJECT NUMBER: DRAWING TITLE: Architectural Dim. Control Site Plan
bings combastible indicates on site is 1,000 gpm at 20 part and capable of delivering the minum fire flow requirement. This hydrant or hydrants may be either temporary or permanent as the project schedule permits. In additiion, there are times when hydrants and valves must be closed temporarily for repair work or construction of the water system. The developer/contractor is responsible for ensuring that the water supply is available. When the work is complete, developer/contractor shall make sure that the fire hydrants are active and the valves are open.	PROJECT NO: DRAWING NUMBER: A1.2