

GENERAL NOTES

- DIMENSIONS ARE TO FACE OF FRAMING UNLESS NOTED OTHERWISE
- 4. SEE INTERIOR DESIGN SHEETS FOR INTERIOR FINISHES
- & INTERIOR DRAWINGS FOR TYPE AND LOCATION OF FIXTURES COORDINATE WITH ELECTRICAL / MECHANICAL AND FIRE FOR TYPE AND LOCATION OF FIXTURES

om Sched	lule
	Area

ROOHI Schedule				
Name	Area			
MECH.	Not Placed			
UNISEX	Not Placed			
FIRE RISER	24 SF			
STORAGE	47 SF			
STORAGE	86 SF			
WOMEN	100 SF			
MEN	100 SF			
OFFICE	137 SF			
ASSITANT MANAGER	139 SF			
OFFICE	157 SF			
MANAGER	176 SF			
MAILBOXES	220 SF			
CONFERENCE ROOM	243 SF			
LOFT	543 SF			
LOBBY	671 SF			
GYM AREA	940 SF			
DINING/ENTERTAINING	1,204 SF			
GROSS BUILDING AREA	4,788 SF			

SYMBOLS

WALL PARTITION INDICATOR, REFER TO AX.X TYPICAL EXTERIOR WALL TYPE C/A7.1 U.N.O.

DOOR TYPE, REFER TO DRAWING AX.X

WINDOW TYPE, REFER TO DRAWING AX.X

SEMI-RECESSED FIRE EXTINGUISHER CABINET AS PER DETAIL -/-

ROOF SLOPE DIRECTION - (3/8" PER FOOT MINIMUM @ MECHANICAL WELL)

_ CRICKET SLOPE DIRECTION - 1/4" PER ---- DRAFT STOP/ SHEAR PANEL

ROOF ACCESS HATCH, EFER TO DETAIL

ROOFTOP CONDENSER UNITPER MECHANICAL REFER TO DETAIL X/AX.X

ATTIC FLAT ROO VENT REFER TO DETAIL X/X.X

ROOF & OVER FLOW DRAIN REFER TO DETAIL X/AX.X

DRYER VENTS LOCATIO X/AXX



	7/26/2021	CITY REVIEW (P&Z)		
NO	DATE	DESCRIPTION		
EASTMARK 2.0				

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TEL: (602) 750-0445 WWW.ARCHISTRUCTDB.COM

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AHJ STAMP


CITY PROJECT NUMBER:

DRAWING TITLE:
CLUBHOUSE_LEVEL 2 - LOFT FLOOR

B6-A202


DRAWING NUMBER:

PROJECT NO:

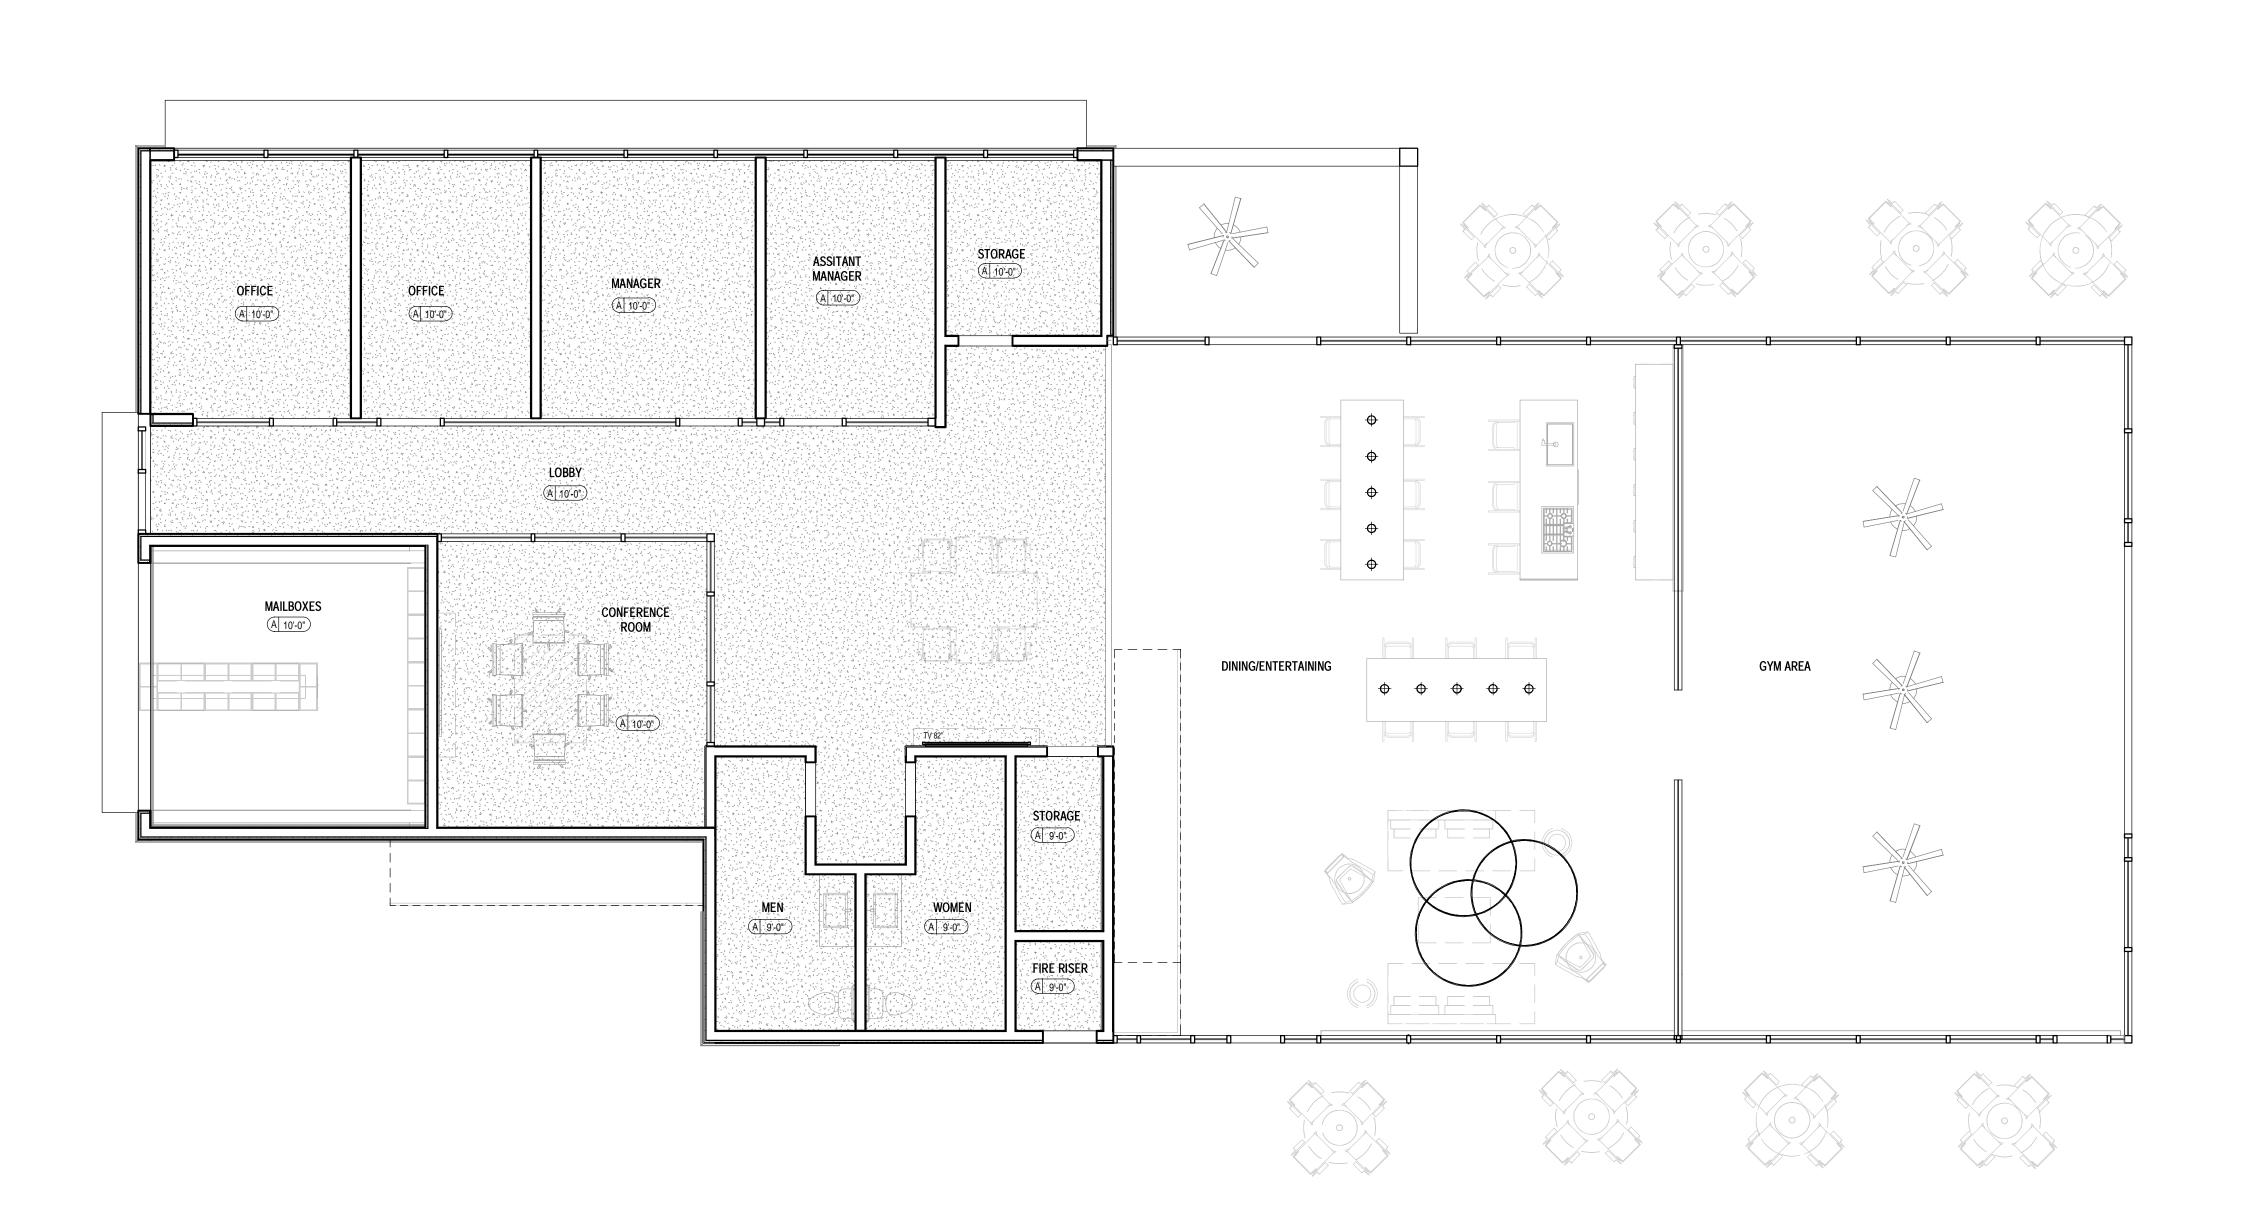

1 LEVEL 1 - REFLECTED CEILING PLAN

B6-A301 SCALE: 3/16" = 1'-0"

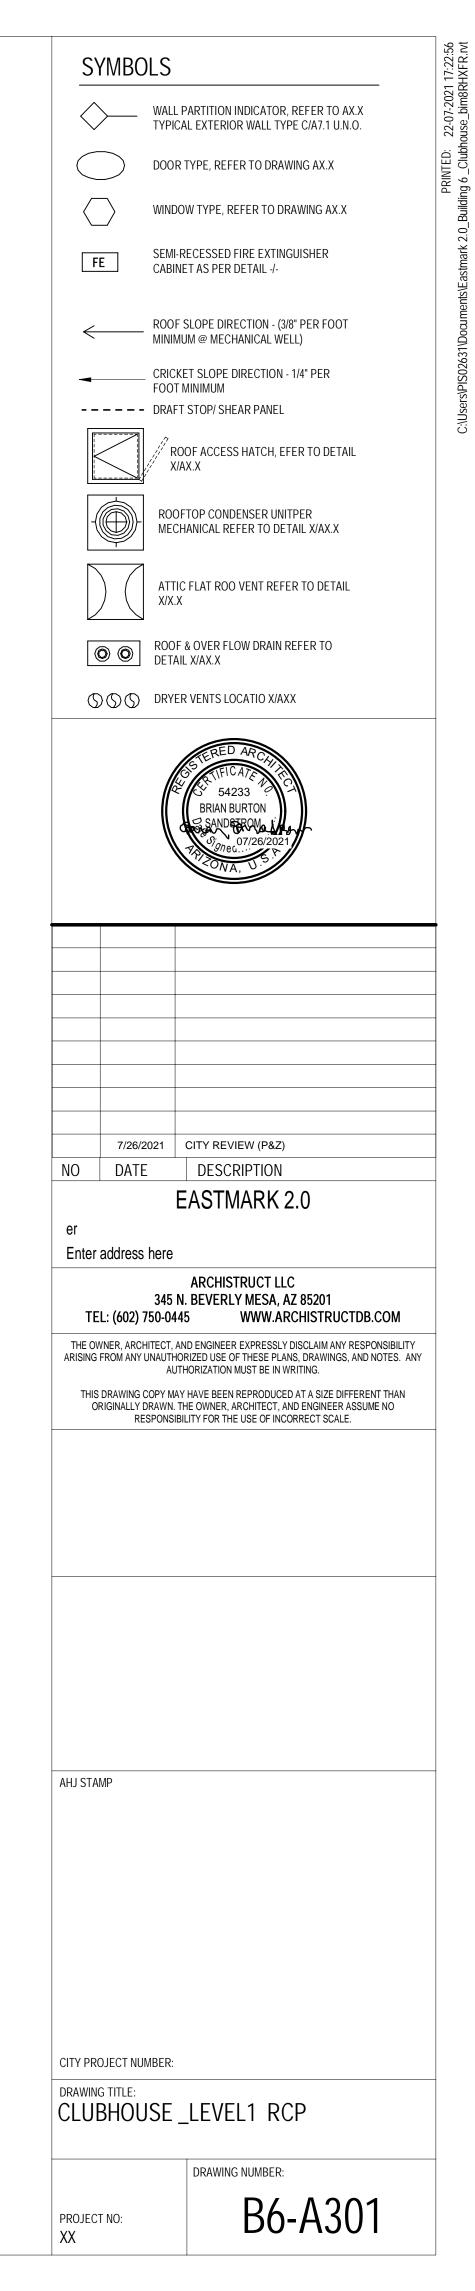

RCP LEGENDS

L HEIGHT - FEET AND INCHES


FINISH
A: GYPSUM BOARD
B: EXTERIOR GYPSUM BOARD
C: SOFFIT BOARD
D: WOOD PANELING

SURFACE MOUNTED LIGHT FIXTURE

EXTERIOR WALL MOUNTED LIGHT FIXTURE

SUSPENDED LIGHT FIXTURE

€ EXIT LIGHT

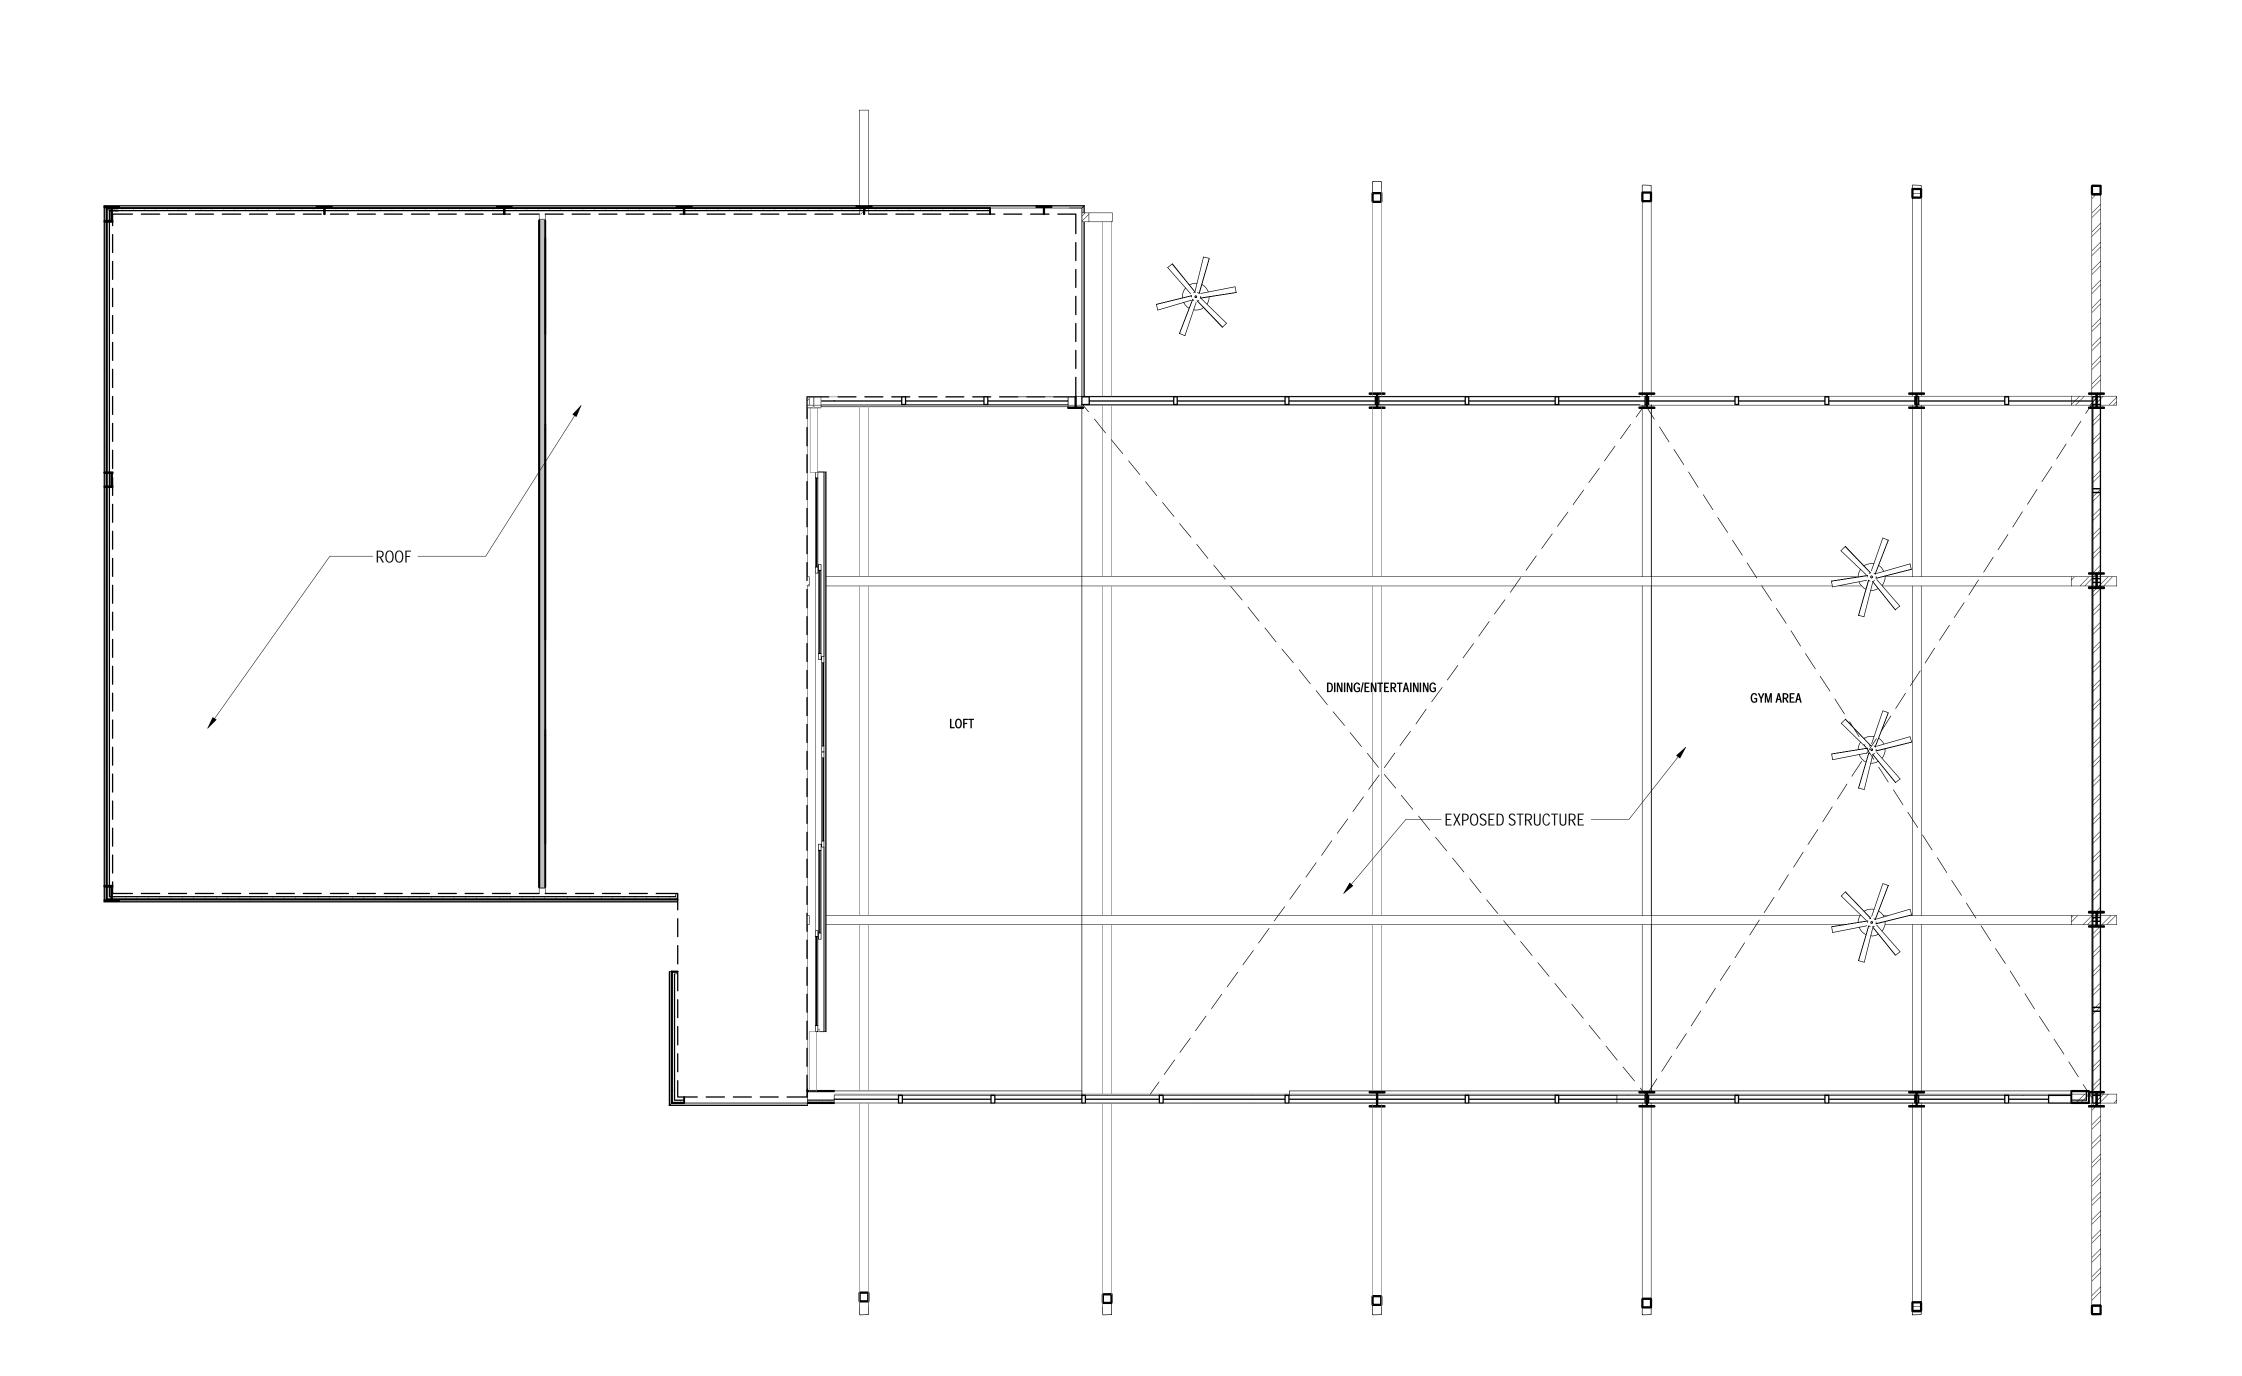

1 LOFT - REFLECTED CEILING PLAN B6-A302 SCALE: 3/16" = 1'-0"

RCP LEGENDS

HEIGHT - FEET AND INCHES
FINISH
A: GYPSUM BOARD
B: EXTERIOR GYPSUM BOARD
C: SOFFIT BOARD
D: WOOD PANELING

 SURFACE MOUNTED LIGHT FIXTURE SUSPENDED LIGHT FIXTURE

EXTERIOR WALL MOUNTED LIGHT FIXTURE

EXIT LIGHT



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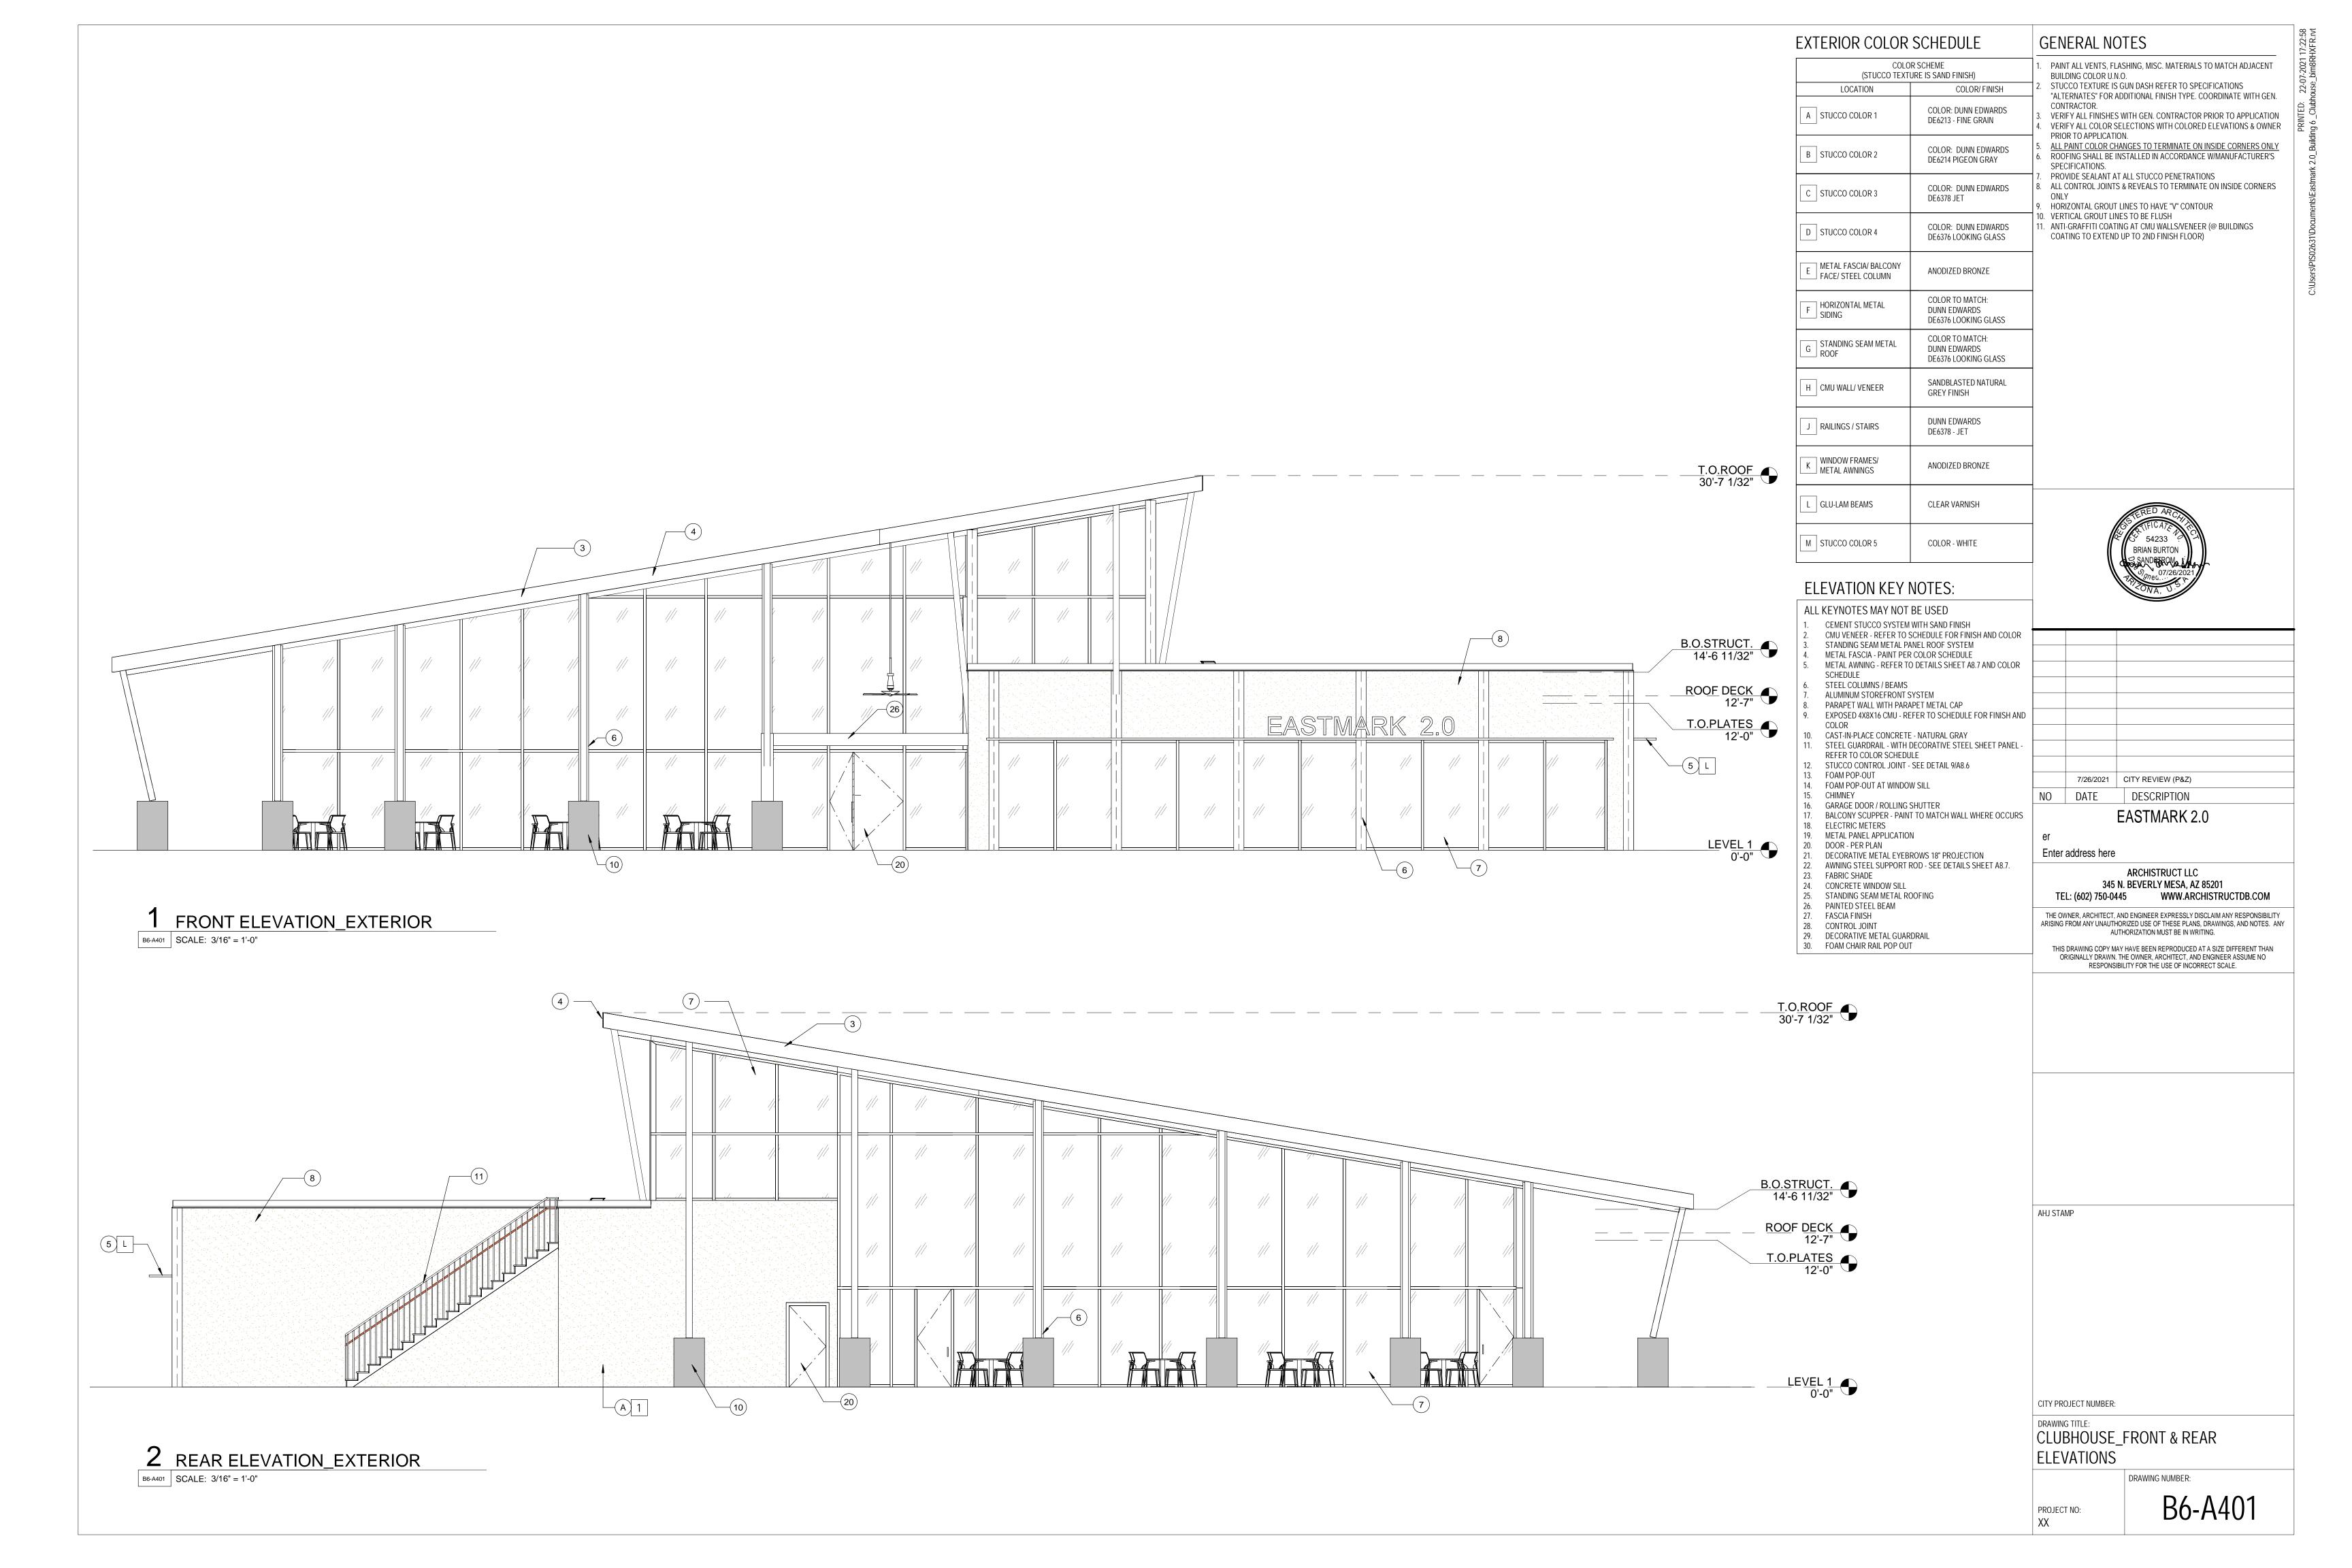
AHJ STAMP


CITY PROJECT NUMBER:

DRAWING TITLE:
CLUBHOUSE_LEVEL 2 - LOFT RCP


DRAWING NUMBER: B6-A302

PROJECT NO:



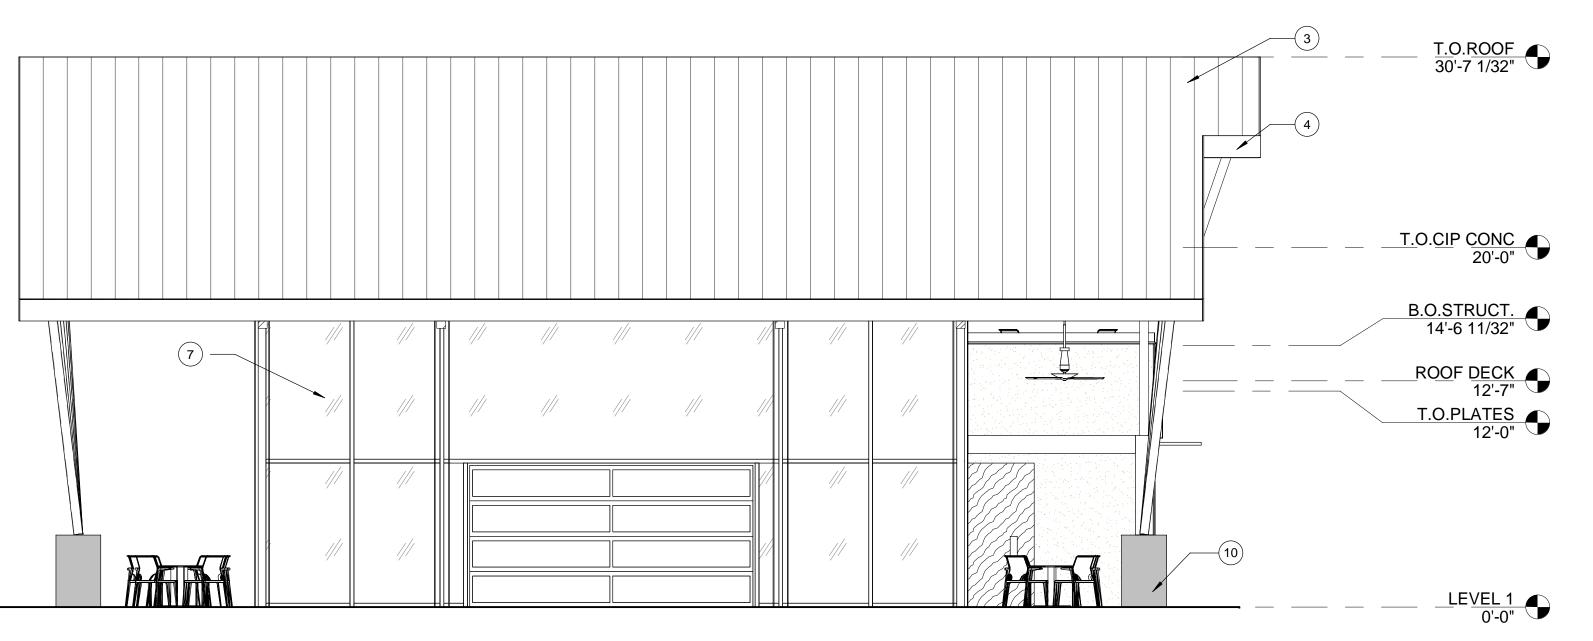

3 LIV ELEVATION_EXTERIOR B6-A402 SCALE: 3/16" = 1'-0"

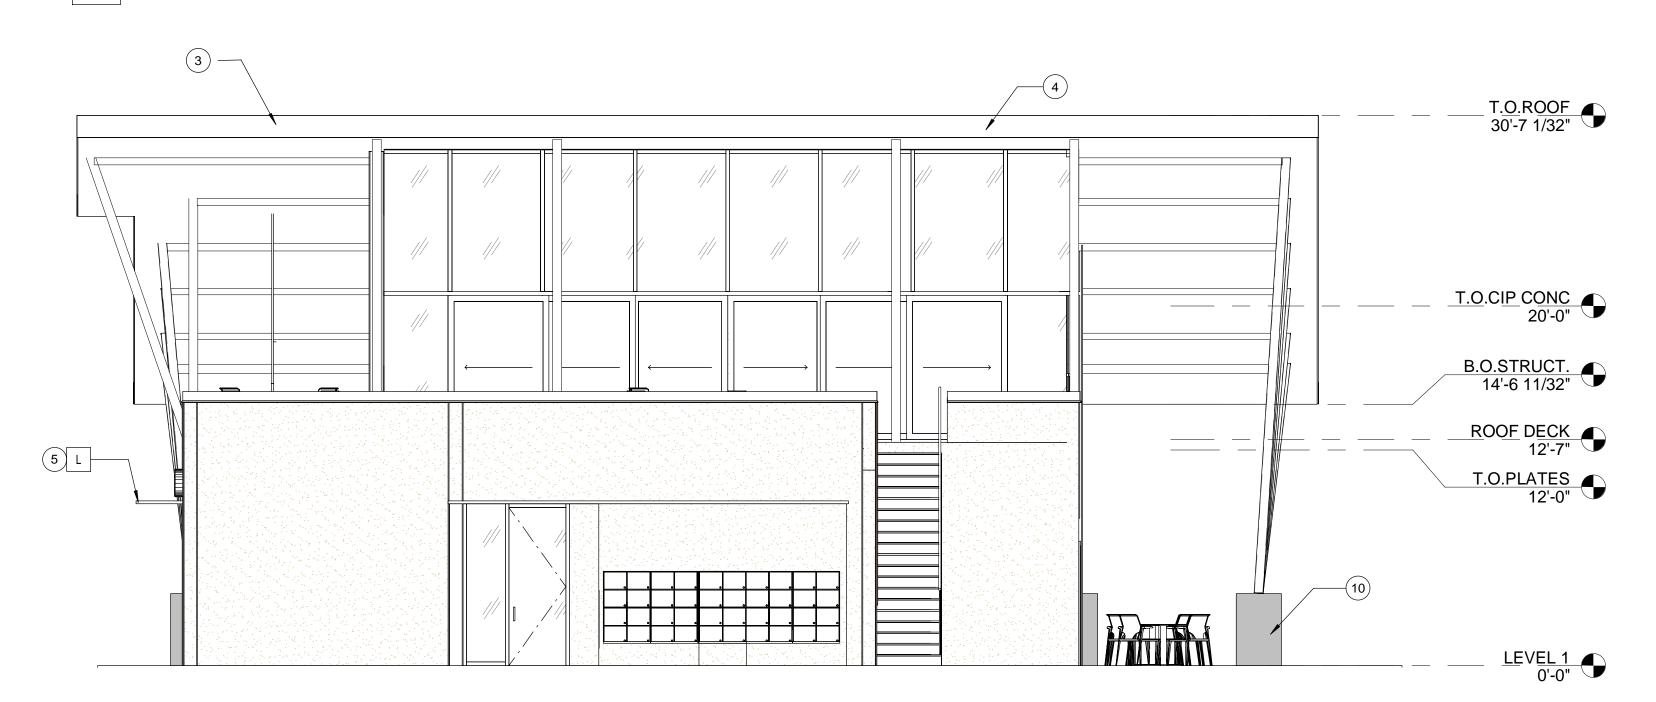

4 BIZ ELEVATION_EXTERIOR B6-A402 | SCALE: 3/16" = 1'-0"



5 3D VIEW B6-A402 SCALE:

EXTERIOR COLOR SCHEDULE

	OR SCHEME TURE IS SAND FINISH)
LOCATION	COLOR/ FINISH
A STUCCO COLOR 1	COLOR: DUNN EDWARDS DE6213 - FINE GRAIN
B STUCCO COLOR 2	COLOR: DUNN EDWARDS DE6214 PIGEON GRAY
C STUCCO COLOR 3	COLOR: DUNN EDWARDS DE6378 JET
D STUCCO COLOR 4	COLOR: DUNN EDWARDS DE6376 LOOKING GLASS
E METAL FASCIA/ BALCONY FACE/ STEEL COLUMN	ANODIZED BRONZE
F HORIZONTAL METAL SIDING	COLOR TO MATCH: DUNN EDWARDS DE6376 LOOKING GLASS
G STANDING SEAM METAL ROOF	COLOR TO MATCH: DUNN EDWARDS DE6376 LOOKING GLASS
H CMU WALL/ VENEER	SANDBLASTED NATURAL GREY FINISH
J RAILINGS / STAIRS	DUNN EDWARDS DE6378 - JET
K WINDOW FRAMES/ METAL AWNINGS	ANODIZED BRONZE
L GLU-LAM BEAMS	CLEAR VARNISH
M STUCCO COLOR 5	COLOR - WHITE

ELEVATION KEY NOTES:

- ALL KEYNOTES MAY NOT BE USED 1. CEMENT STUCCO SYSTEM WITH SAND FINISH
- 2. CMU VENEER REFER TO SCHEDULE FOR FINISH AND COLOR 3. STANDING SEAM METAL PANEL ROOF SYSTEM
- METAL FASCIA PAINT PER COLOR SCHEDULE
 METAL AWNING REFER TO DETAILS SHEET A8.7 AND COLOR

- 6. STEEL COLUMNS / BEAMS
 7. ALUMINUM STOREFRONT SYSTEM
 8. PARAPET WALL WITH PARAPET METAL CAP
 9. EXPOSED 4X8X16 CMU REFER TO SCHEDULE FOR FINISH AND
- 10. CAST-IN-PLACE CONCRETE NATURAL GRAY
 11. STEEL GUARDRAIL WITH DECORATIVE STEEL SHEET PANEL -
- REFER TO COLOR SCHEDULE 12. STUCCO CONTROL JOINT - SEE DETAIL 9/A8.6
- 13. FOAM POP-OUT 14. FOAM POP-OUT AT WINDOW SILL
- 15. CHIMNEY16. GARAGE DOOR / ROLLING SHUTTER
- 17. BALCONY SCUPPER PAINT TO MATCH WALL WHERE OCCURS 18. ELECTRIC METERS
 19. METAL PANEL APPLICATION
- 20. DOOR PER PLAN
- 21. DECORATIVE METAL EYEBROWS 18" PROJECTION
 22. AWNING STEEL SUPPORT ROD SEE DETAILS SHEET A8.7.
 23. FABRIC SHADE
- 24. CONCRETE WINDOW SILL
- 25. STANDING SEAM METAL ROOFING26. PAINTED STEEL BEAM
- 27. FASCIA FINISH
- 28. CONTROL JOINT
 29. DECORATIVE METAL GUARDRAIL
 30. FOAM CHAIR RAIL POP OUT



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NO	DATE	DESCRIPTION		
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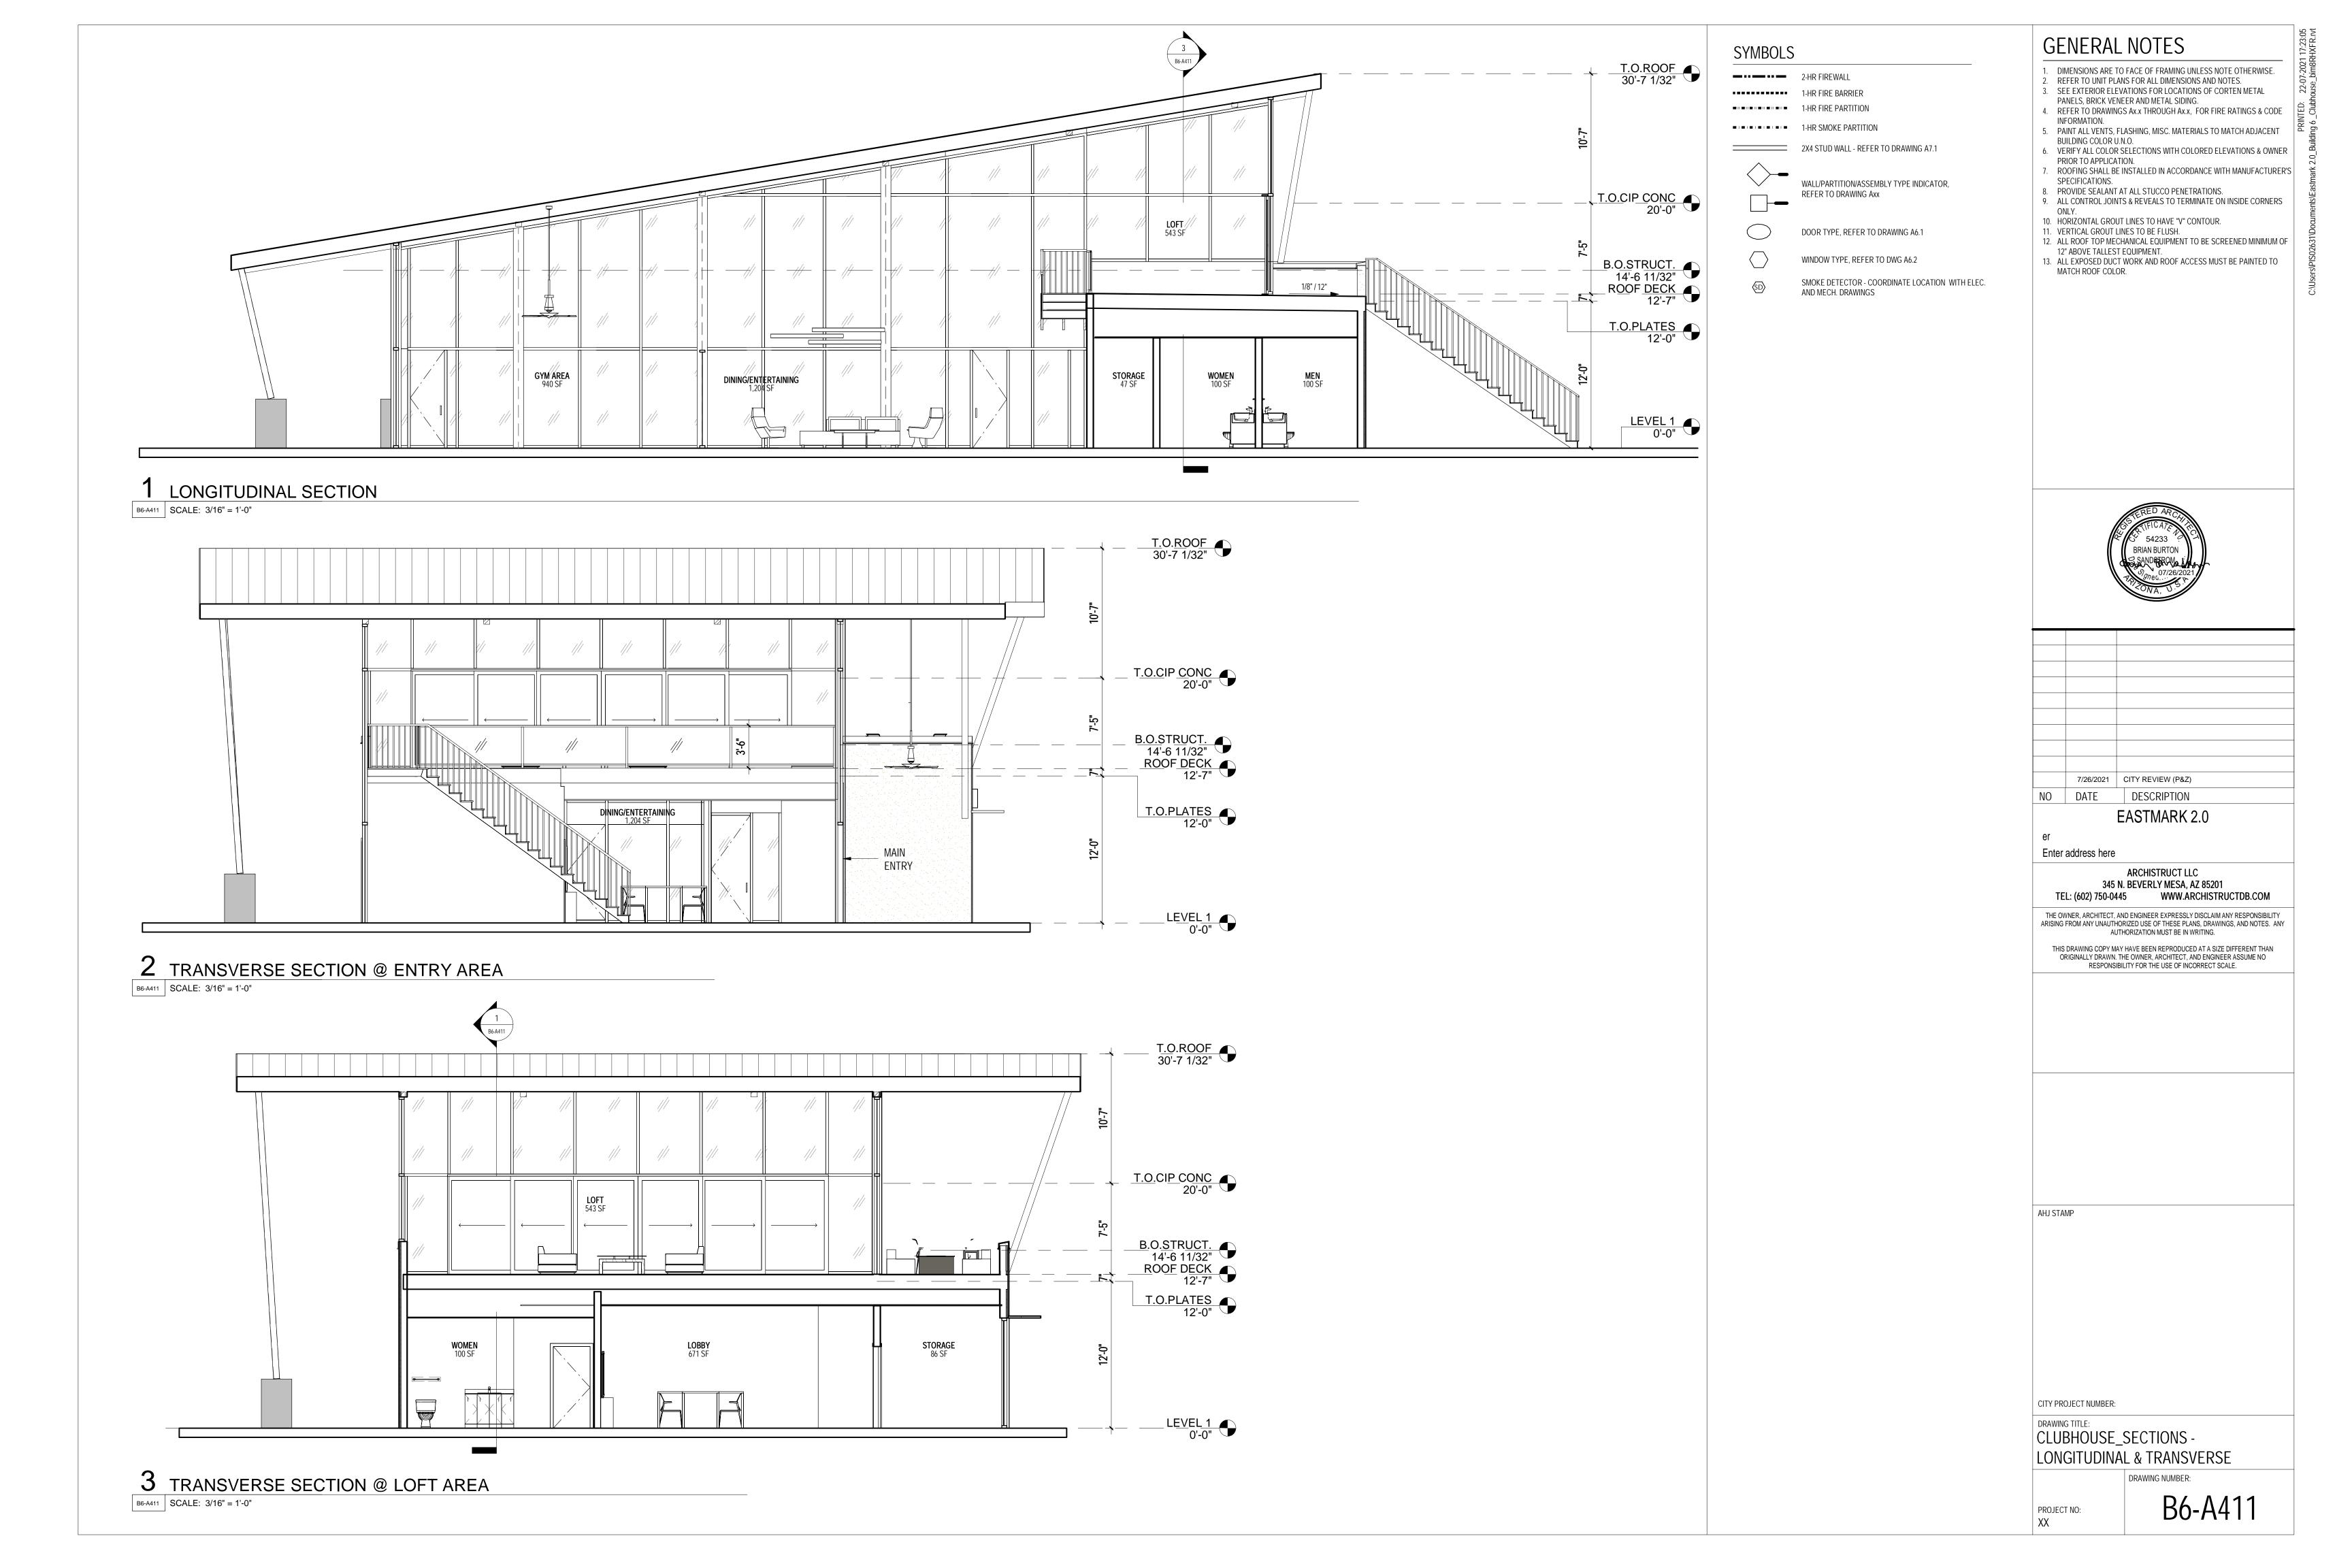
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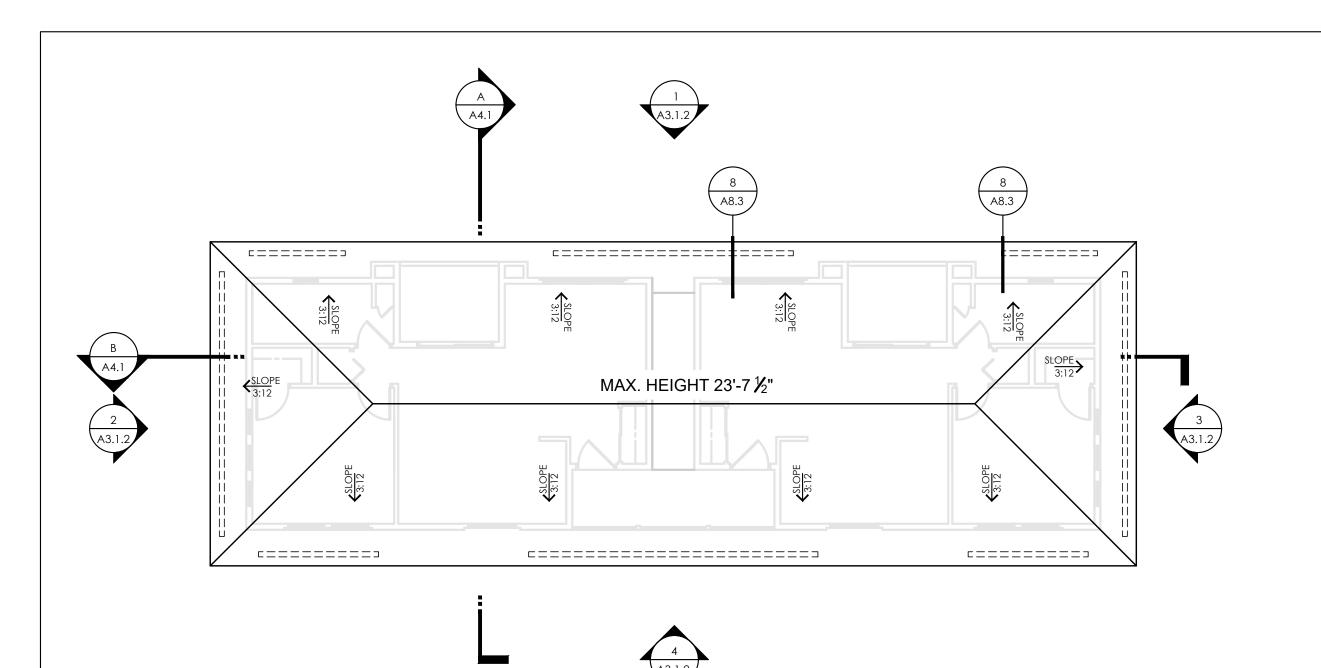
DRAWING TITLE: CLUBHOUSE_LIV & BIZ ELEVATIONS

DRAWING NUMBER:

B6-A402


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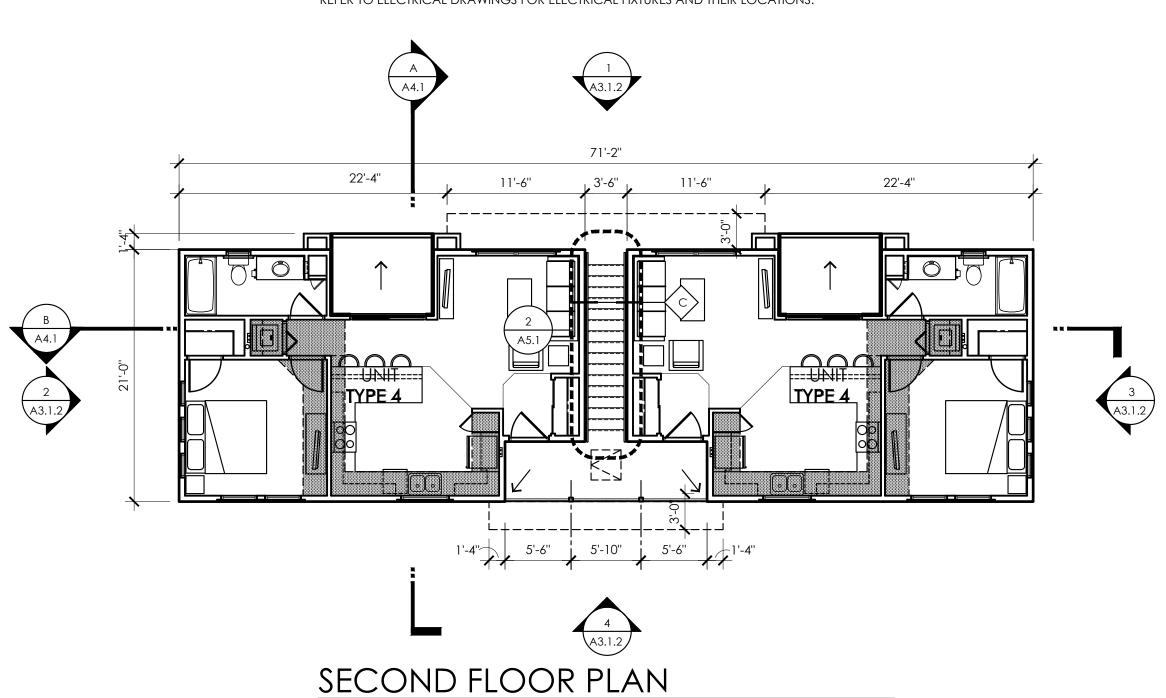
EQUAL. (NET FREE AREA SHALL BE THE SAME OR MEET THE REQUIREMENTS OF THE CALCULATION TABLE).


	ATTIC VENTILATION CALCULATIONS						
ATTIC AREA #	ATTIC AREA (SQ. FT.)	REQUIRED VENT AREA FORMULA (AREA x 144 SQ. IN. PER SQ.FT/ 300 SQ. FT.)	REQUIRED VENT AREA (SQ. IN.)	LOW VENTING SOFFIT PANEL (5 S.I. NET FREE AR./LF)	VENTING PROVIDED GENERAL METALS NET FREE AREA = 247 SQ. IN. (REQ'D AREA SQ. IN./247 SQ. IN.)	TOTAL VENTS	TOTAL VENT AREA PROVIDED (SQ. IN.)
AREA 1	846 SQ. FT.	x144 / 300	406 SQ. IN.		/247 = 1.6	2	494 SQ. IN.
AREA 2	410 SQ. FT.	x144 / 300	197 SQ. IN.	40'-0" LFx 5 = 200 S.I.			200 SQ. IN.
AREA 3	410 SQ. FT.	x144 / 300	197 SQ. IN.	40'-0" LFx 5 = 200 S.I.			200 SQ. IN.
AREA 4	207 SQ. FT.	x144 / 300	100 SQ. IN.	20'-0" LFx 5 = 100 S.I.			100 SQ. IN.
AREA 5	53 SQ. FT.	x144 / 300	26 SQ. IN.	6'-0" LFx 5 = 30 S.I.		·	30 SQ. IN.
TOTALS			926 SQ. IN.			2	1,024 SQ. IN.



SECOND FLOOR RCP


REFER TO ELECTRICAL DRAWINGS FOR ELECTRICAL FIXTURES AND THEIR LOCATIONS.

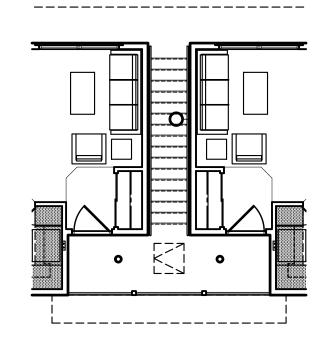

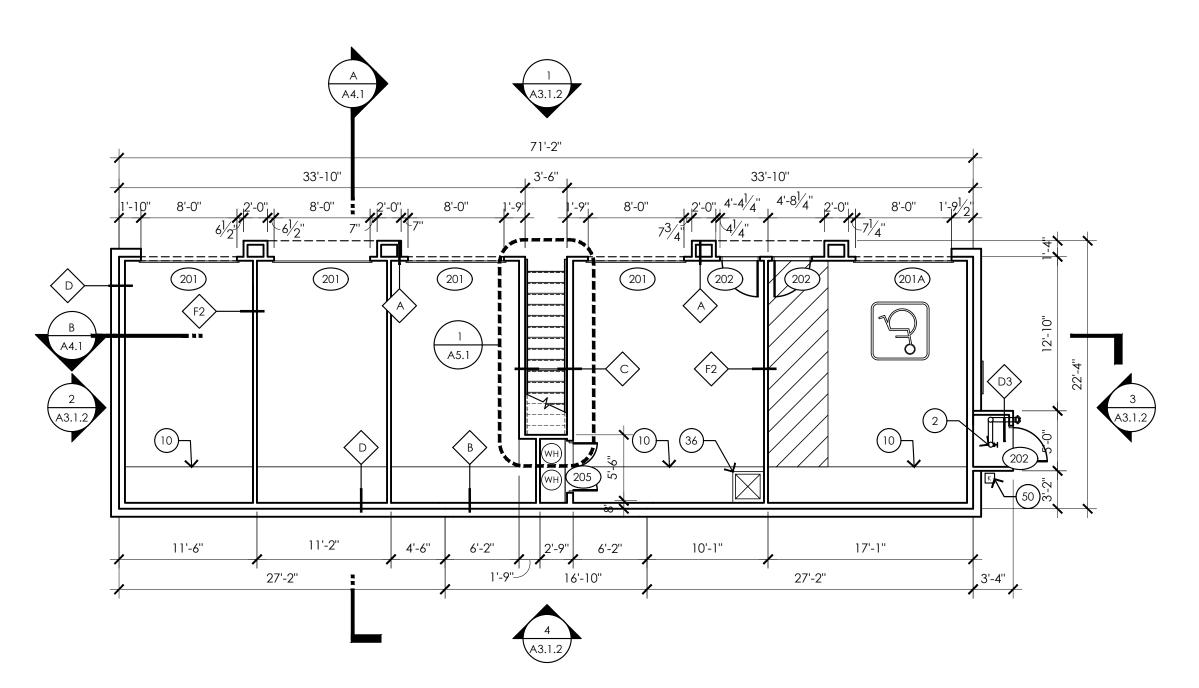

FIRST FLOOR PLAN ALT.

BUILDING #14

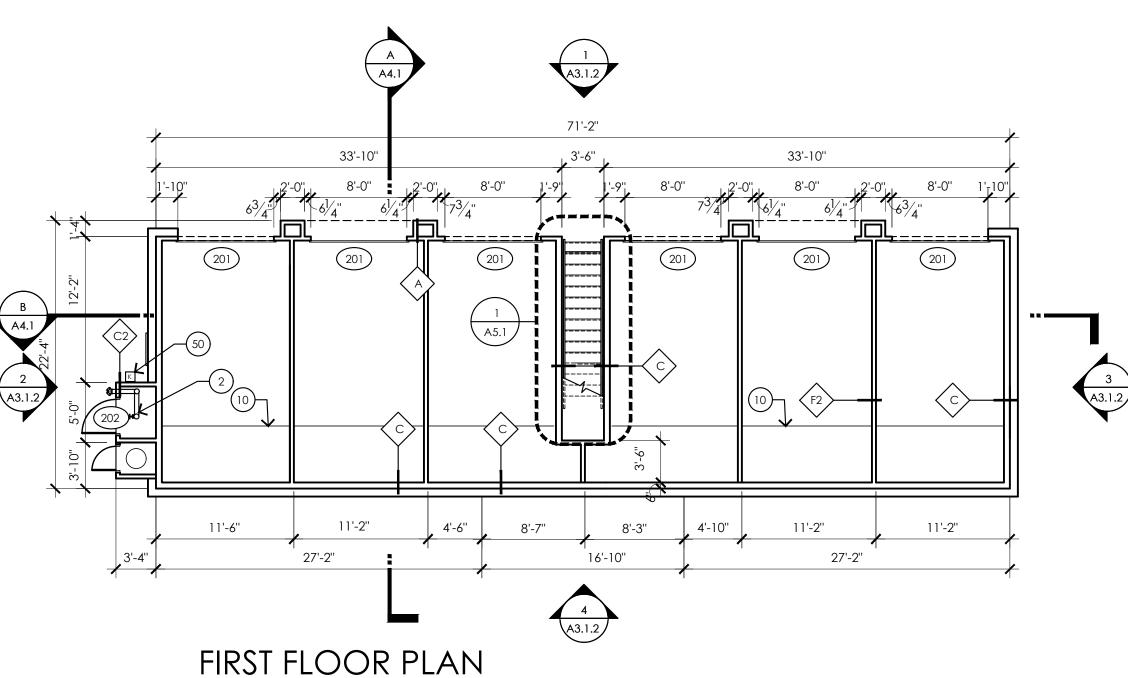

*ALL KEYNOTES MAY NOT BE USED

POWER METER(S); SEE SITE PLAN FOR LOCATION AT EACH BUILDING FIRE SPRINKLER RISER

FDC CONNECTION FOR SPRINKLER SYSTEM - REFER TO SITE PLAN ON FOR LOCATION FOR SPRINKLER SYSTEM - REFER TO SITE PLAN FOR LOCATION

4. PRECAST CONCRETE STAIR TREADS WITH STEEL CHANNEL STRINGERS.

SEE SHEET A5.3

5. LOW PATIO WALL, 2X8 CMU

ORNAMENTAL IRON RAILING, SEE EXTERIOR ELEVATIONS 7. ROOF OVERHANG ABOVE 8. ROOF BELOW

Z 9. EXTERIOR CONCRETE TO HAVE BROOM FINISH, MEDIUM ✓ 11. EXTENT OF STUCCO (FINISHES AT INSIDE CORNERS) - 3/A8.8 (SIM.)
 ✓ 12. LINE OF BALCONY ABOVE
 ✓ 13. DIMENSION TO CENTERLINE OF UNIT DEMISING WALL
 ✓ CAS EIDED ACT

 14. GAS FIREPLACE
 15. ELECTRICAL OUTLET ABOVE FIREPLACE FOR TV - SEE ELECTRICAL
 16. 2" FURRING AT BATHROOM 17. GAS BBQ
18. COUNTERTOP AT KITCHEN
19. COUNTERTOP AT BATHROOM

COUNTERTOP AT BATHROOM
 ELECTRICAL OUTLETS FOR VENDING MACHINES - SEE ELECTRICAL
 ACCESSIBLE / STANDARD DRINKING FOUNTAINS
 STEEL COLUMN / BEAM - SEE STRUCTURAL
 8" CMU WALL
 ACCESSIBLE GRAB BARS - SEE SHEET A/0.2.3 FOR SIZES AND MOUNTING HEIGHTS
 2X4 WOOD STUD WALL
 2X4 WOOD STUD WALL - BOTTOM AT 27" TO CEILING
 CLEAR FLOOR SPACE - SEE ACCESSIBLE SHEETS
 STOREFRONT GLAZING SYSTEM
 POCKET DOOR

29. POCKET DOOR
30. COUNTERTOP, CABINETS BELOW
31. NOT USED

32. MOP SINK
33. SITE WALL - SEE LANDSCAPE PLANS
34. NOT USED
35. UPPER CABINETS

36. (4) FOUR LEG JANITOR SINK - HOT AND COLD WATER
37. MIRROR - +36" A.F.F.
38. GAS BBQ
39. 6"X17" RECESSED DOOR CLOSER PER DOOR SCHEDULE, BASE

RECESSES INTO SLAB 4 1/16"

40. WOOD PANELING - SEE SPECIFICATIONS

41. STANDING SEAM METAL PANEL ROOF SYSTEM

42. BUILT UP ROOF WITH TORCH APPLIED CAP SHEET

43. RIDGE 43. RIDGE
44. LOW WALL - SEE INTERIOR ELEVATIONS FOR HEIGHT
45. COUNTERTOP
46. 30" WORKSPACE - NO CABINET BELOW
47. METAL SINK - HOT AND COLD WATER
48. OPENING TO DAYLIGHT AT FLOOR/CEILING
49. ROOF HATCH

50. KNOX BOX 51. WATER CLOSET 52. LAVATORY
53. MAILBOXES
54. ADA COMPLIANT DRINKING FOUNTAIN

55. GLU-LAM BEAMS
56. GLASS PANEL SECTIONAL GARAGE DOORS
57. TRASH CONTAINER
58. CAST-IN-PLACE CONCRETE WALL

ROOF NOTES

ROOF SYSTEM - SEE SPECIFICATIONS

CRICKET WITH MIN. VALLEY SLOPE OF 1/4"/FT. . ROOF ACCESS HATCH, SEE DETAIL 7/A8.3 4. FLAT ROOF VENT 5. ROOF DRAIN/LEADER AND OVERFLOW

6. THRU-WALL SCUPPER 7. CANT STRIP 8. DRAFTSTOP TO THE UNDERSIDE OF THE ROOF DECKING. PROVIDE ACCESS DOOR IN DRAFTSTOP

BETWEEN ATTIC AREAS 9. PARAPET WALL 10. STANDING SEAM METAL ROOF

SEE DRAWING A0.1 FOR ADDITIONAL NOTES

1. DIMENSIONS ARE TO FACE OF FRAMING UNLESS NOTED SITE PLAN GOVERNS FINAL LOCATIONS OF METERS REFER TO DRAWING A0.4 FOR FIRE RATINGS & CODE INFORMATION

SEE INTERIOR DESIGN SHEETS FOR INTERIOR FINISHES LIGHT FIXTURES ARE FOR REFERENCE ONLY - REFER TO ELECTRICAL & INTERIOR DRAWINGS FOR TYPE AND LOCATION OF FIXTURES COORDINATE WITH ELECTRICAL / MECHANICAL AND FIRE FOR TYPE AND LOCATION OF FIXTURES

SEE ROOF PLAN FOR CLEARSTORY WINDOW LOCATIONS


SEE DRAWING A0.1 FOR ADDITIONAL SYMBOLS L HEIGHT - FEET AND INCHES

A: GYPSUM BOARD
B: EXTERIOR GYPSUM BOARD
C: SOFFIT BOARD
D: WOOD PANELING

 SURFACE MOUNTED LIGHT FIXTURE SUSPENDED LIGHT FIXTURE

EXTERIOR WALL MOUNTED LIGHT FIXTURE EXIT LIGHT

SEE DRAWING A0.1 FOR ADDITIONAL SYMBOLS

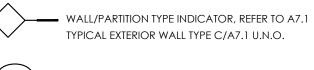

DOOR TYPE, REFER TO DRAWING A6.1

WINDOW TYPE, REFER TO DWG A6.2

SEMI-RECESSED FIRE EXTINGUISHER CABINET

ROOF SLOPE DIRECTION -(3/8" PER FOOT MINIMUM @ MECHANICAL WELL) CRICKET SLOPE DIRECTION - 1/4" PER FOOT MINIMUM


ROOF ACCESS HATCH, REFER TO DETAIL 7/A8.3

■■■■■ DRAFT STOP/SHEAR PANEL

ROOFTOP CONDENSER UNIT PER MECHANICAL

REFER TO DETAIL 6/A8.3 ATTIC FLAT ROOF VENT REFER TO DETAIL 4/A8.3

ROOF & OVER FLOW DRAIN REFER TO DETAIL 3/A8.3 DRYER VENTS LOCATION REFER TO DETAIL 5/A8.3

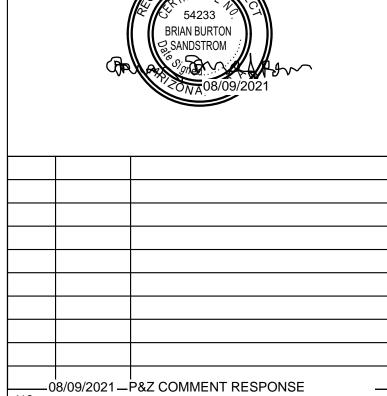

THE PREMIERE AT EASTMARK 2.0

JENNINGS HOLDINGS L.L.C. 5029 S. ELLSWORTH RD. MESA, AZ

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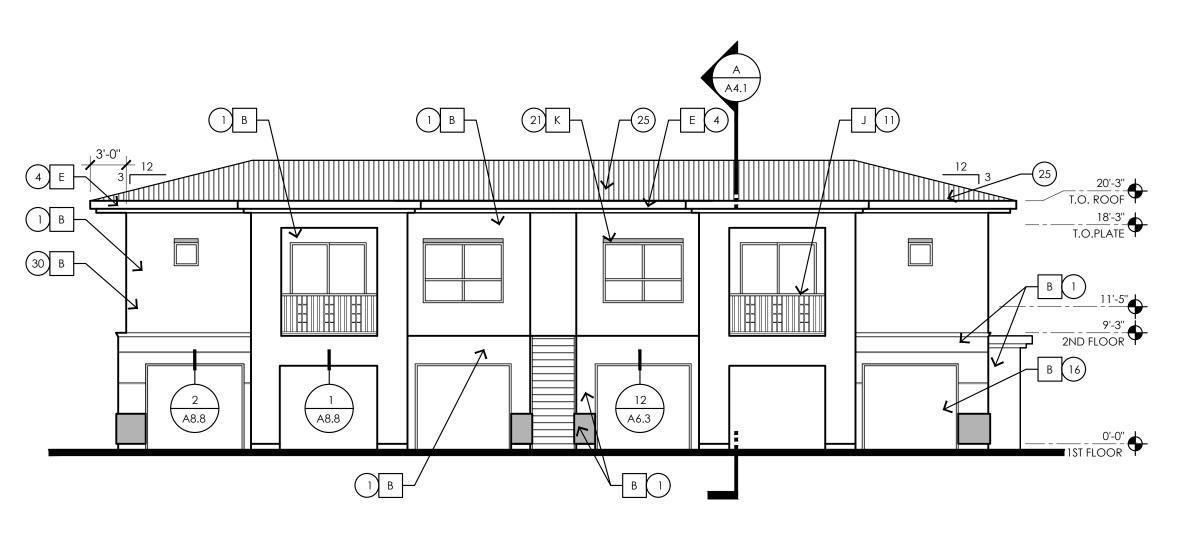
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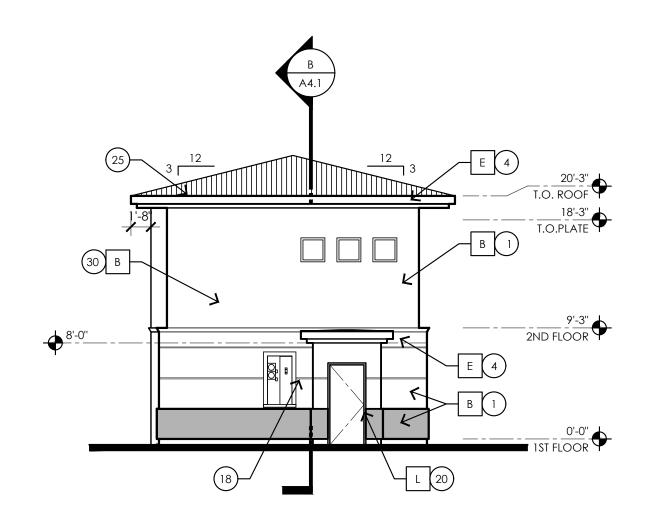
Building Type 1 1st, 2nd, 1st Flr. Alt. RCP & Roof Plans


A3.1.1

DRAWING NUMBER:




FRONT ELEVATION



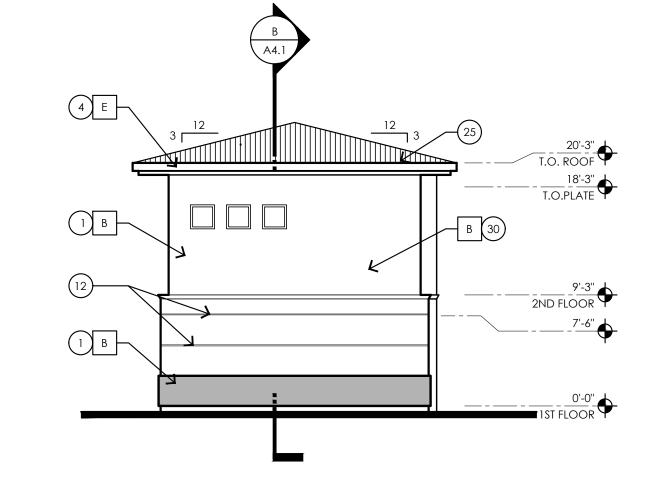

RIGHT SIDE ELEVATION



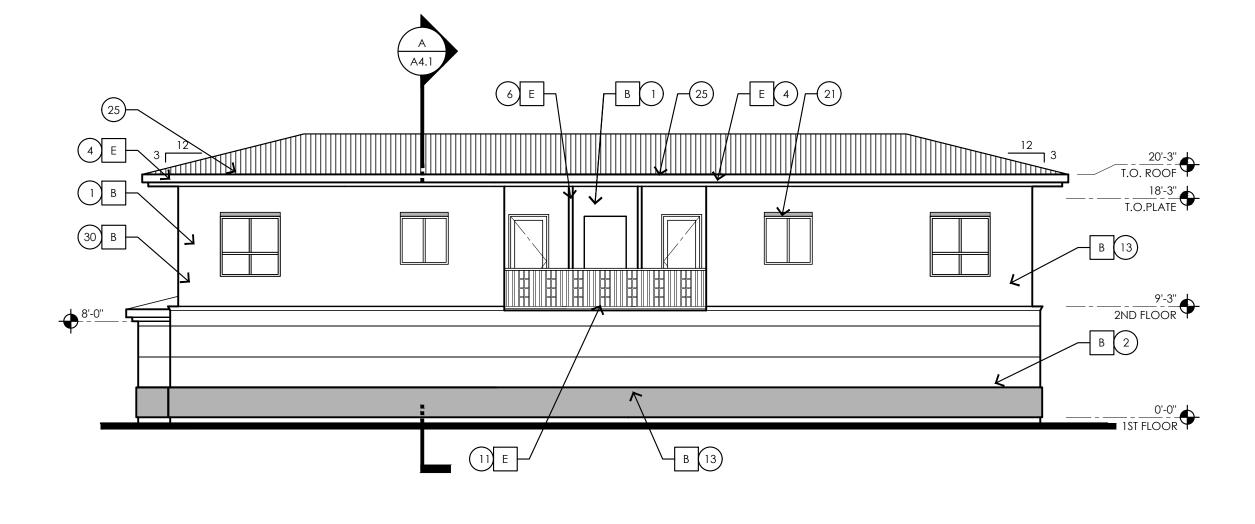

REAR ELEVATION

ALTERNATE EXTERIOR ELEVATION ELEMENT SUBSTITUTIONS AND/OR DELETIONS:

1. METAL SIDING CAN BE REDUCED TO 6'-8" (EYE LEVEL) FROM GROUND. AREA FROM WHICH METAL SIDING WAS REMOVED SHALL BE REPLACED WITH STUCCO.

ALL KEYNOTES MAY NOT BE USED CEMENT STUCCO SYSTEM WITH SAND FINISH
 CMU VENEER - REFER TO SCHEDULE FOR FINISH AND COLOR STANDING SEAM METAL PANEL ROOF SYSTEM METAL FASCIA - PAINT PER COLOR SCHEDULE METAL AWNING - REFER TO DETAILS SHEET A8.7 AND COLOR **SCHEDULE** STEEL COLUMNS / BEAMS ALUMINUM STOREFRONT SYSTEM
PARAPET WALL WITH PARAPET METAL CAP 9. EXPOSED 4X8X16 CMU - REFER TO SCHEDULE FOR FINISH AND CAST-IN-PLACE CONCRETE - NATURAL GRAY
STEEL GUARDRAIL - WITH DECORATIVE STEEL SHEET PANEL -REFER TO COLOR SCHEDULE STUCCO CONTROL JOINT - SEE DETAIL 9/A8.6 12. SIUCCO COMME 13. FOAM POP-OUT > 14. FOAM POP-OUT AT WINDOW SILL ■ 15. CHIMNEY ☐ 16. GARAGE DOOR 16. GARAGE DOOR
17. BALCONY SCUPPER - PAINT TO MATCH WALL WHERE OCCURS
18. ELECTRIC METERS
19. METAL PANEL APPLICATION
20. DOOR - PER PLAN
21. DECORATIVE METAL EYEBROWS 18" PROJECTION
22. AWNING STEEL SUPPORT ROD - SEE DETAILS SHEET A8.7.
23. FABRIC SHADE 24. CONCRETE WINDOW SILL
25. STANDING SEAM METAL ROOFING 26. PAINTED STEEL BEAM 27. FASCIA FINISH 28. CONTROL JOINT 29. DECORATIVE METAL GUARDRAIL 30. FOAM CHAIR RAIL POP OUT PAINT ALL VENTS, FLASHING, MISC. MATERIALS TO MATCH ADJACENT BUILDING COLOR U.N.O. STUCCO TEXTURE IS GUN DASH REFER TO SPECIFICATIONS "ALTERNATES" FOR ADDITIONAL FINISH TYPE. COORDINATE WITH GEN. CONTRACTOR. VERIFY ALL FINISHES WITH GEN. CONTRACTOR PRIOR TO APPLICATION VERIFY ALL COLOR SELECTIONS WITH COLORED ELEVATIONS & OWNER PRIOR TO APPLICATION. ALL PAINT COLOR CHANGES TO TERMINATE ON INSIDE CORNERS ONLY . ROOFING SHALL BE INSTALLED IN ACCORDANCE W/MANUFACTURER'S SPECIFICATIONS. PROVIDE SEALANT AT ALL STUCCO PENETRATIONS ALL CONTROL JOINTS & REVEALS TO TERMINATE ON INSIDE CORNERS ONLY 9. HORIZONTAL GROUT LINES TO HAVE "V" CONTOUR 10. VERTICAL GROUT LINES TO BE FLUSH 11. ANTI-GRAFFITI COATING AT CMU WALLS/VENEER (@ BUILDINGS COATING TO EXTEND UP TO 2ND FINISH FLOOR) 12. ALL EXTERIOR MISC. METALS TO BE FILLED PAINTED, OR POWDER COATED AS PER OWNER REQUIRMENT. COLOR SCHEME (STUCCO TEXTURE IS SAND FINISH) COLOR/ FINISH LOCATION COLOR: DUNN EDWARDS Ö | A | STUCCO COLOR 1 NO DATE DESCRIPTION DE6213 - FINE GRAIN THE PREMIERE AT EASTMARK 2.0 COLOR: DUNN EDWARDS DE6214 PIGEON GRAY O B STUCCO COLOR 2 JENNINGS HOLDINGS L.L.C. 5029 S. ELLSWORTH RD. MESA, AZ COLOR: DUNN EDWARDS ARCHISTRUCT LLC C STUCCO COLOR 3 345 N. BEVERLY MESA, AZ 85201 TEL: (602) 750-0445 WWW.ARCHISTRUCTDB.COM COLOR: DUNN EDWARDS 쁘미 D STUCCO COLOR 4 THE OWNER. ARCHITECT. AND ENGINEER EXPRESSLY DISCLAIM ANY RESPONSIBILITY DE6376 LOOKING GLASS ARISING FROM ANY UNAUTHORIZED USE OF THESE PLANS, DRAWINGS, AND NOTES. ANY AUTHORIZATION MUST BE IN WRITING. E METAL FASCIA/ BALCONY FACE/ STEEL COLUMN THIS DRAWING COPY MAY HAVE BEEN REPRODUCED AT A SIZE DIFFERENT THAN ORIGINALLY DRAWN. THE OWNER, ARCHITECT, AND ENGINEER ASSUME NO RESPONSIBILITY FOR THE USE OF INCORRECT SCALE. ANODIZED BRONZE COLOR TO MATCH: F HORIZONTAL METAL SIDING DUNN EDWARDS DE6376 LOOKING GLASS G STANDING SEAM METAL ROOF COLOR TO MATCH: DUNN EDWARDS DE6376 LOOKING GLASS SANDBLASTED NATURAL H CMU WALL/ VENEER GREY FINISH DUNN EDWARDS DE6378 - JET J RAILINGS / STAIRS K WINDOW FRAMES/ METAL AWNINGS ANODIZED BRONZE L GLU-LAM BEAMS CLEAR VARNISH AHJ STAMP

ADDRESSING

Approved Building Addressing must comply with City of Mesa Fire Detail FPD 505.1.

Approved street addressed, including building/suite numbers, shall be placed on all new and existing buildings in such a position as to be plainly visible and legible from the street or road fronting the property. Said numbers shall contrast with their background.

No street address or building number shall be posted under a gable or obstructed by any feature or follage.

Address numbers should be no lower than the first story or on a DRAWING TITLE: sign at each entrance facing the designated property address. Numbers shall be a minimum 12" high with a 2" stroke and contrast the facility colors.

CITY PROJECT NUMBER:

Building Type 1 Exterior Elevations

PROJECT NO: DRAWING NUMBER: A3.1.2

☐ 16. GARAGE DOOR

18. ELECTRIC METERS

O 5. METAL AWNING - REFER TO DETAILS SHEET A8.7 AND COLOR

SCHEDULE

6. STEEL COLUMNS / BEAMS

7. ALUMINUM STOREFRONT SYSTEM

8. PARAPET WALL WITH PARAPET METAL CAP

9. EXPOSED 4X8X16 CMU - REFER TO SCHEDULE FOR FINISH AND

Z COLOR

10. CAST-IN-PLACE CONCRETE - NATURAL GRAY

11. STEEL GUARDRAIL - WITH DECORATIVE STEEL SHEET PANEL REFER TO COLOR SCHEDULE

12. STUCCO CONTROL JOINT - SEE DETAIL 9/A8.6

13. FOAM POP-OUT

14. FOAM POP-OUT AT WINDOW SILL

15. CHIMNEY

16. GARAGE DOOR

19. METAL PANEL APPLICATION 20. DOOR - PER PLAN


21. DECORATIVE METAL EYEBROWS 18" PROJECTION 22. AWNING STEEL SUPPORT ROD - SEE DETAILS SHEET A8.7. 23. FABRIC SHADE


17. BALCONY SCUPPER - PAINT TO MATCH WALL WHERE OCCURS

24. CONCRETE WINDOW SILL 25. STANDING SEAM METAL ROOFING 26. PAINTED STEEL BEAM

27. FASCIA FINISH
28. CONTROL JOINT
29. DECORATIVE METAL GUARDRAIL
30. FOAM CHAIR RAIL POP OUT



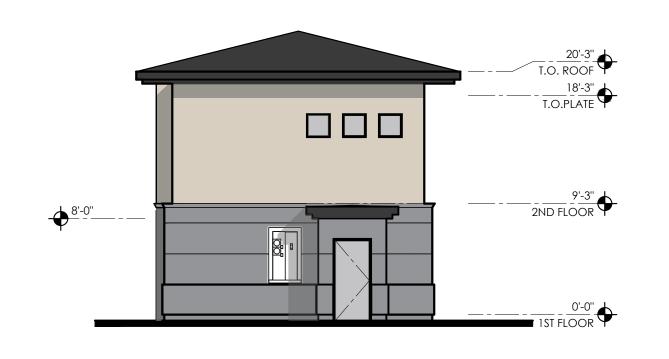

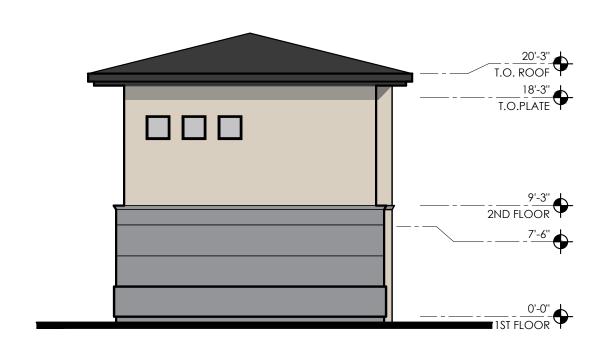


T.O. ROOF

_____18'-3"_ T.O.PLATE

(2) RIGHT SIDE ELEVATION



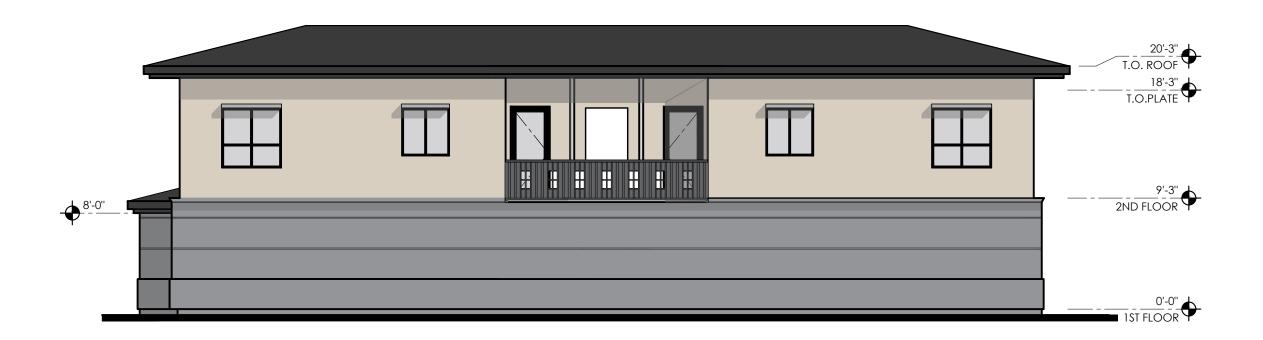



1. PAINT ALL VENTS, FLASHING, MISC. MATERIALS TO MATCH ADJACENT BUILDING COLOR U.N.O.

 $oldsymbol{Z}$ 2. STUCCO TEXTURE IS GUN DASH REFER TO SPECIFICATIONS "ALTERNATES" FOR ADDITIONAL FINISH TYPE. COORDINATE WITH GEN. CONTRACTOR.

2 3. VERIFY ALL FINISHES WITH GEN. CONTRACTOR PRIOR TO **M** APPLICATION

VERIFY ALL COLOR SELECTIONS WITH COLORED ELEVATIONS & OWNER PRIOR TO APPLICATION.

ALL PAINT COLOR CHANGES TO TERMINATE ON INSIDE CORNERS ONLY

6. ROOFING SHALL BE INSTALLED IN ACCORDANCE

W/MANUFACTURER'S SPECIFICATIONS. 7. PROVIDE SEALANT AT ALL STUCCO PENETRATIONS

8. ALL CONTROL JOINTS & REVEALS TO TERMINATE ON INSIDE CORNERS ONLY

9. HORIZONTAL GROUT LINES TO HAVE "V" CONTOUR

10. VERTICAL GROUT LINES TO BE FLUSH

11. ANTI-GRAFFITI COATING AT CMU WALLS/VENEER (@ BUILDINGS COATING TO EXTEND UP TO 2ND FINISH FLOOR)

12. ALL EXTERIOR MISC. METALS TO BE FILLED PAINTED, OR

COLOR SCHEME						
COLC (STUCCO TEXT LOCATION A STUCCO COLOR 1	TURE IS SAND FINISH)					
LOCATION	COLOR/ FINISH					
A STUCCO COLOR 1	COLOR: DUNN EDWARDS DE6213 - FINE GRAIN					
B STUCCO COLOR 2	COLOR: DUNN EDWARDS DE6214 PIGEON GRAY					
C STUCCO COLOR 3	COLOR: DUNN EDWARDS DE6378 JET					
D STUCCO COLOR 4	COLOR: DUNN EDWARDS DE6376 LOOKING GLASS					
E METAL FASCIA/ BALCON FACE/ STEEL COLUMN	ANODIZED BRONZE					
F HORIZONTAL METAL SIDING	COLOR TO MATCH: DUNN EDWARDS DE6376 LOOKING GLASS					
G STANDING SEAM METAL ROOF	COLOR TO MATCH: DUNN EDWARDS DE6376 LOOKING GLASS					
H CMU WALL/ VENEER	SANDBLASTED NATURAL GREY FINISH					
J RAILINGS / STAIRS	DUNN EDWARDS DE6378 - JET					
K WINDOW FRAMES/ METAL AWNINGS	ANODIZED BRONZE					
L GLU-LAM BEAMS	CLEAR VARNISH					

ADDRESSING

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Address numbers should be no lower than the first story or on a DRAWING TITLE: sign at each entrance facing the designated property address. Numbers shall be a minimum 12" high with a 2" stroke and contrast the facility colors.



NO	DATE	DESCRIPTION		
Т	HE PRE	MIERE AT EASTMARK 2.0		
	JEN	NNINGS HOLDINGS L.L.C.		
	5029 S.	S. ELLSWORTH RD. MESA, AZ		
		ARCHISTRUCT LLC		
		/ERLY MESA, AZ 85201		
TEL: (6	02) 750-0445 W	WWW.ARCHISTRUCTDB.COM		
THE OW	VNER, ARCHITECT, /	AND ENGINEER EXPRESSLY DISCLAIM ANY RESPONSIBILITY		
ARISING I		HORIZED USE OF THESE PLANS, DRAWINGS, AND NOTES. AN' AUTHORIZATION MUST BE IN WRITING.		
THIS	DRAWING COPY MA	MAY HAVE BEEN REPRODUCED AT A SIZE DIFFERENT THAN		
OF		I. THE OWNER, ARCHITECT, AND ENGINEER ASSUME NO SIBILITY FOR THE USE OF INCORRECT SCALE.		


CITY PROJECT NUMBER:

AHJ STAMP


Building Type 1 Exterior Elevations

PROJECT NO:

A3.1.2

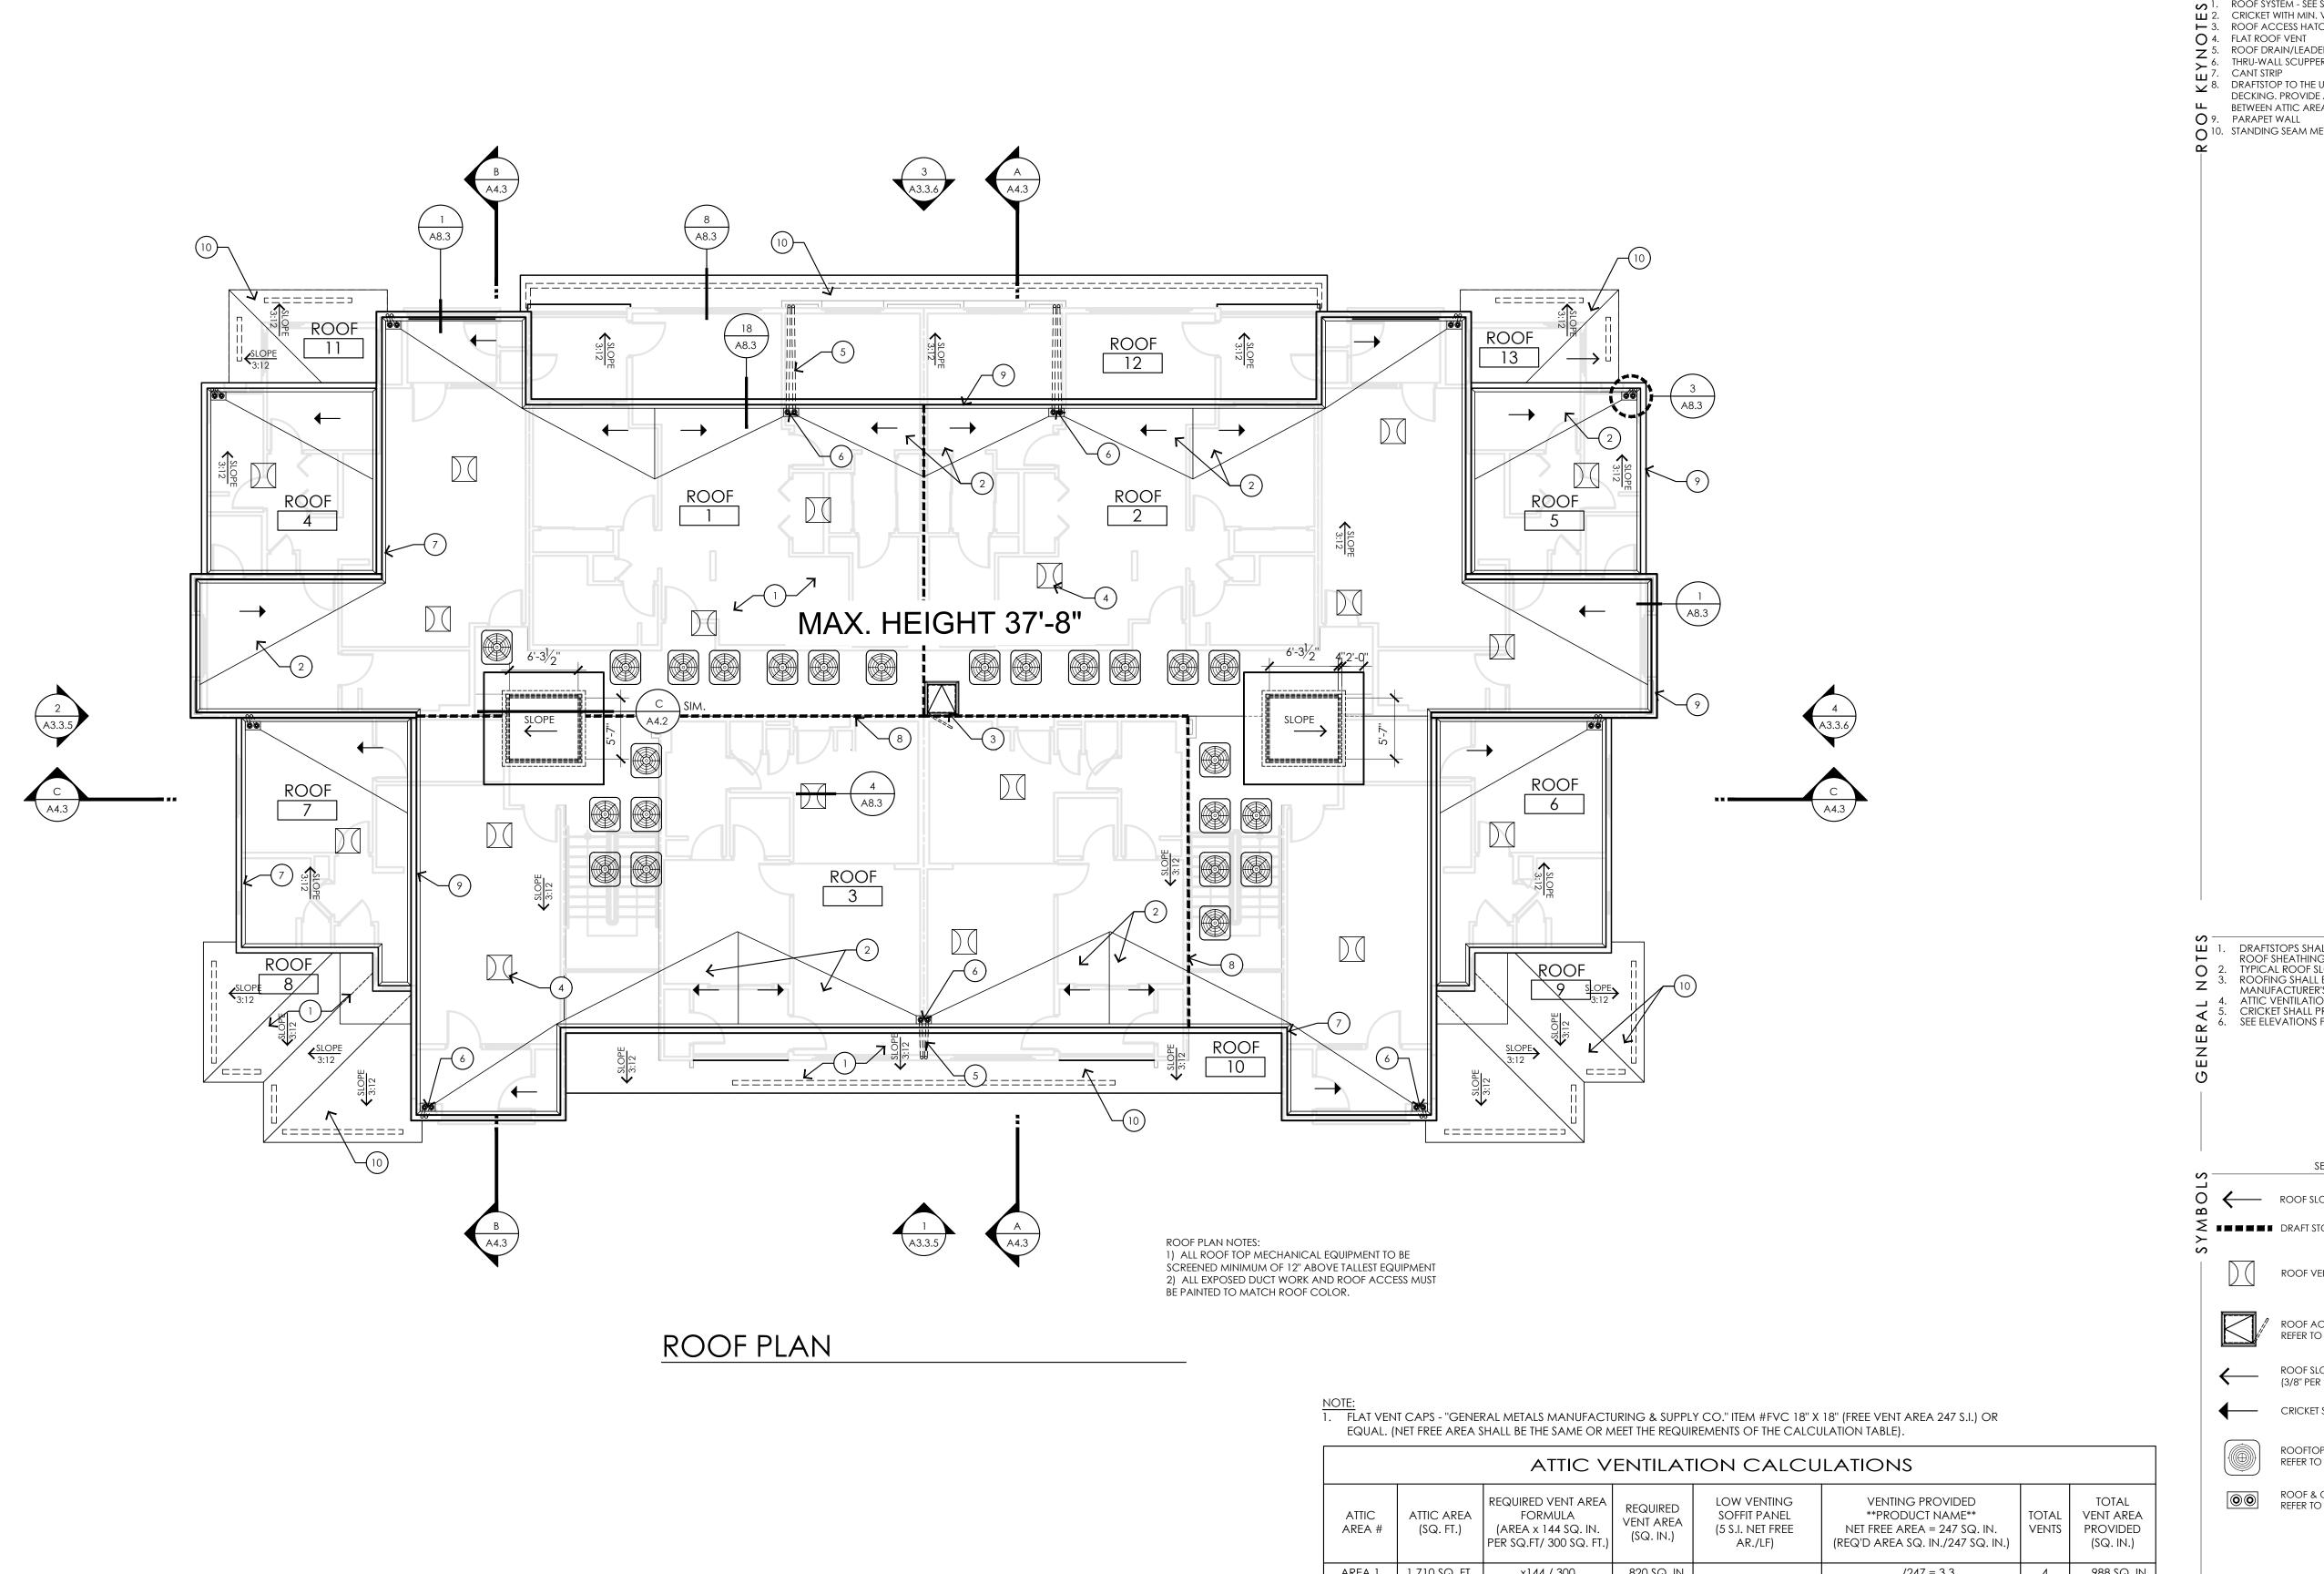

ATTIC VENTILATION CALCULATIONS							
ATTIC AREA #	ATTIC AREA (SQ. FT.)	REQUIRED VENT AREA FORMULA (AREA x 144 SQ. IN. PER SQ.FT/ 300 SQ. FT.)	REQUIRED VENT AREA (SQ. IN.)	LOW VENTING SOFFIT PANEL (5 S.I. NET FREE AR./LF)	VENTING PROVIDED **PRODUCT NAME** NET FREE AREA = 247 SQ. IN. (REQ'D AREA SQ. IN./247 SQ. IN.)	TOTAL VENTS	TOTAL VENT AREA PROVIDED (SQ. IN.)
AREA 1	1,710 SQ. FT.	x144 / 300	820 SQ. IN.		/247 = 3.3	4	988 SQ. IN.
AREA 2	2,408 SQ. FT.	x144 / 300	1,155 SQ. IN.		/247 = 4.6	5	1,235 SQ. IN.
AREA 3	2,089 SQ. FT.	x144 / 300	1,002 SQ. IN.		/247 = 4.1	5	1,235 SQ. IN.
AREA 4	264 SQ. FT.	x144 / 300	126 SQ. IN.		/247 = 1	1	247 SQ. IN.
AREA 5	264 SQ. FT.	x144 / 300	126 SQ. IN.		/247 = 1	1	247 SQ. IN.
AREA 6	336 SQ. FT.	x144 / 300	161 SQ. IN.		/247 = 1	1	247 SQ. IN.
AREA 7	336 SQ. FT.	x144 / 300	161 SQ. IN.		/247 = 1	1	247 SQ. IN.
AREA 8	298 SQ. FT.	x144 / 300	143 SQ. IN.	29'-0" LFx 5 = 145 S.I.			145 SQ. IN.
AREA 9	298 SQ. FT.	x144 / 300	143 SQ. IN.	29'-0" LFx 5 = 145 S.I.			145 SQ. IN.
AREA 10	360 SQ. FT.	x144 / 300	173 SQ. IN.	35'-0" LFx 5 = 175 S.I.			175 SQ. IN.
AREA 11	117 SQ. FT.	x144 / 300	57 SQ. IN.	12'-0" LFx 5 = 60 S.I.			60 SQ. IN.
AREA 12	820 SQ. FT.	x144 / 300	394 SQ. IN.	79'-0" LFx 5 = 395 S.I.			395 SQ. IN.
AREA 13	117 SQ. FT.	x144 / 300	57 SQ. IN.	12'-0" LFx 5 = 60 S.I.			60 SQ. IN.
TOTALS			4,518 SQ. IN.			18	5,426 SQ. IN.

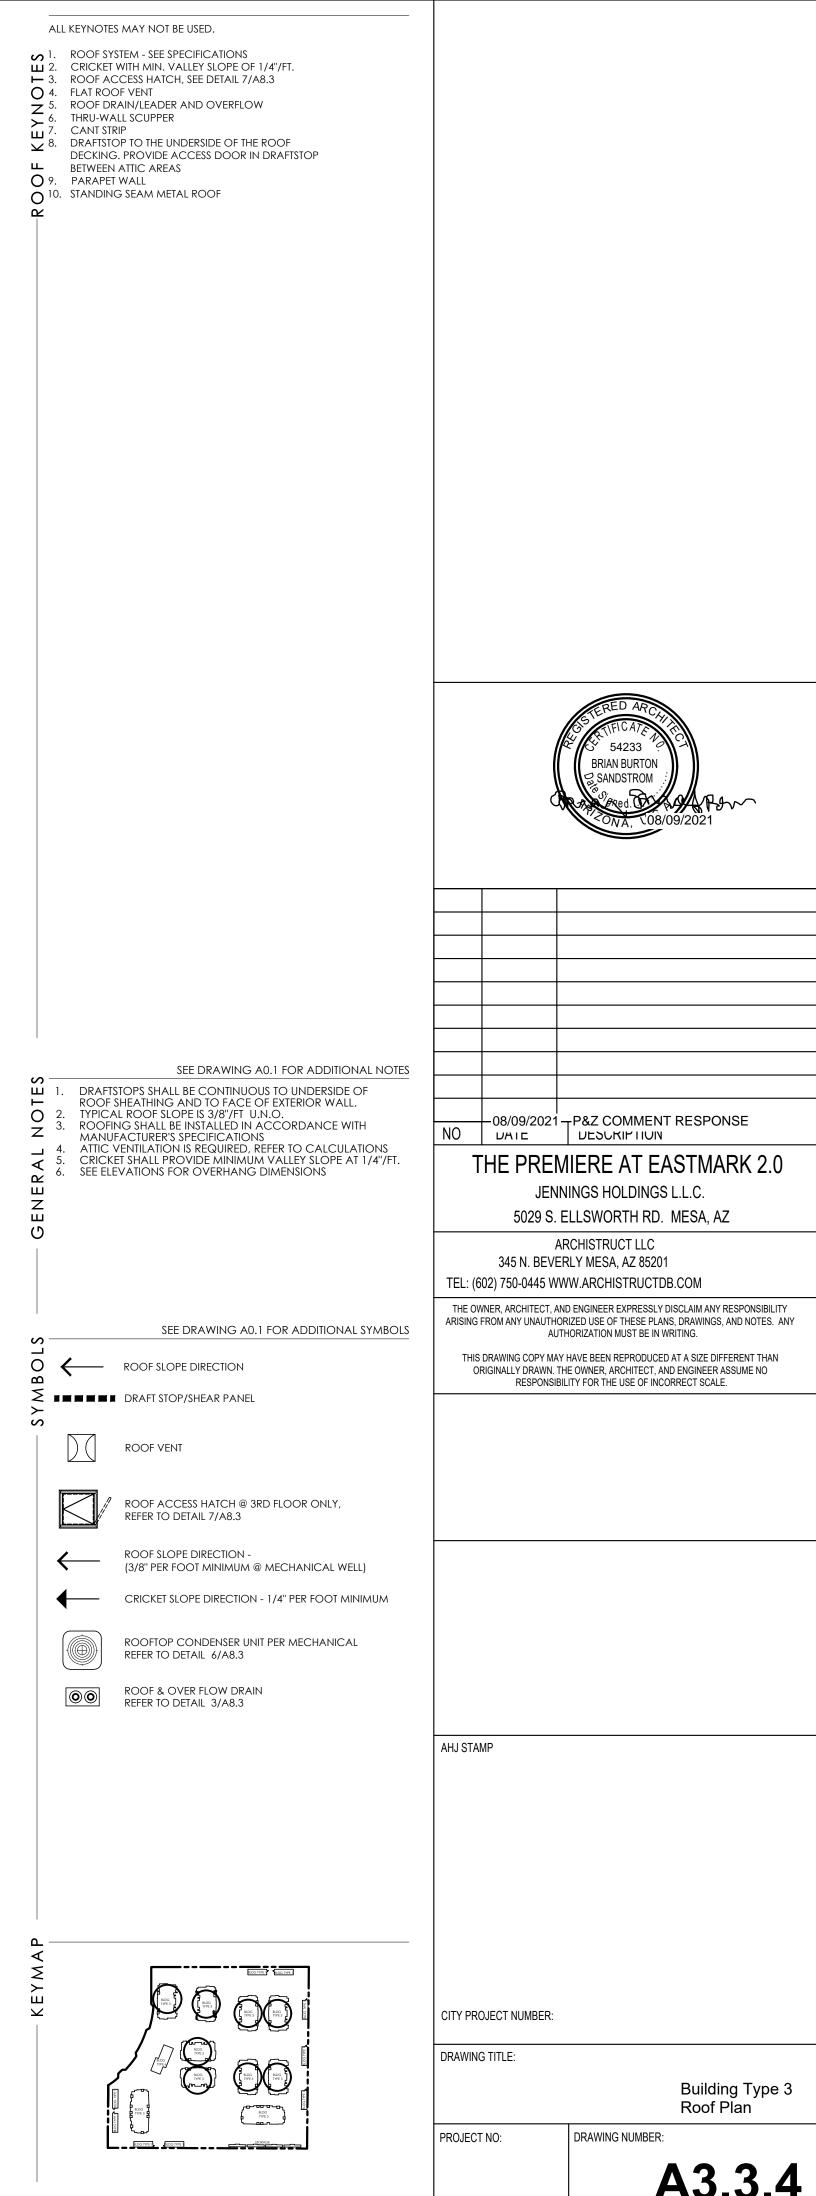

- METAL SIDING CAN BE REDUCED TO 6'-8" (EYE LEVEL) FROM GROUND.
 AREA FROM WHICH METAL SIDING WAS REMOVED SHALL BE REPLACED
 WITH STUCCO.
- ALL SECOND LEVEL AWNINGS CAN BE REMOVED WITH OWNER APPROVAL.

T.O. PARAPET

T.O. PARAPET

T.O. PARAPET T.O.

3RD FLOOR

_____10'-3" 2ND FLOOR

3. ALL METAL AWNINGS WITH WIRE MESH CAN BE REPLACED WITH FABRIC AWNINGS.

ALL KEYNOTES MAY NOT BE USED

■ 15. CHIMNEY

- CEMENT STUCCO SYSTEM WITH SAND FINISH
 CMU VENEER REFER TO SCHEDULE FOR FINISH AND COLOR
 STANDING SEAM METAL PANEL ROOF SYSTEM
- 4. METAL FASCIA PAINT PER COLOR SCHEDULE
 5. METAL AWNING REFER TO DETAILS SHEET A8.7 AND COLOR SCHEDULE
 6. STEEL COLUMNS / BEAMS
- 7. ALUMINUM STOREFRONT SYSTEM
 8. PARAPET WALL WITH PARAPET METAL CAP
 9. EXPOSED 4X8X16 CMU REFER TO SCHEDULE FOR FINISH AND
- COLOR

 O. CAST-IN-PLACE CONCRETE NATURAL GRAY

 1. STEEL GUARDRAIL WITH DECORATIVE STEEL SHEET PANEL -
- REFER TO COLOR SCHEDULE

 STUCCO CONTROL JOINT SEE DETAIL 9/A8.6
- 12. STUCCO CONTROL JOINT SEE DETAIL 9/A8.6
 13. FOAM POP-OUT
 14. FOAM POP-OUT AT WINDOW SILL
- 16. GARAGE DOOR
 17. BALCONY SCUPPER PAINT TO MATCH WALL WHERE OCCURS
 18. ELECTRIC METERS
- 19. METAL PANEL APPLICATION
 20. DOOR PER PLAN
 21. DECORATIVE METAL EYEBROWS 18" PROJECTION
- 22. AWNING STEEL SUPPORT ROD SEE DETAILS SHEET A8.7.
 23. FABRIC SHADE
- 24. CONCRETE WINDOW SILL
 25. STANDING SEAM METAL ROOFING
- 25. STANDING SEAM METAL ROOFING
 26. PAINTED STEEL BEAM
 27. FASCIA FINISH
- 27. FASCIA FINISH
 28. CONTROL JOINT
 29. DECORATIVE METAL GUARDRAIL
 30. FOAM CHAIR RAIL POP OUT
- 1. PAINT ALL VENTS, FLASHING, MISC. MATERIALS TO MATCH ADJACENT BUILDING COLOR U.N.O.
- Z 2. STUCCO TEXTURE IS GUN DASH REFER TO SPECIFICATIONS
 "ALTERNATES" FOR ADDITIONAL FINISH TYPE. COORDINATE WITH
 GEN. CONTRACTOR.
- Z
 4. VERIFY ALL COLOR SELECTIONS WITH COLORED ELEVATIONS & OWNER PRIOR TO APPLICATION.

ALL PAINT COLOR CHANGES TO TERMINATE ON INSIDE CORNERS ONLY

- 6. ROOFING SHALL BE INSTALLED IN ACCORDANCE W/MANUFACTURER'S SPECIFICATIONS.
- 7. PROVIDE SEALANT AT ALL STUCCO PENETRATIONS
- 8. ALL CONTROL JOINTS & REVEALS TO TERMINATE ON INSIDE CORNERS ONLY
- 9. HORIZONTAL GROUT LINES TO HAVE "V" CONTOUR
- 10. VERTICAL GROUT LINES TO BE FLUSH
- 11. ANTI-GRAFFITI COATING AT CMU WALLS/VENEER (@ BUILDINGS COATING TO EXTEND UP TO 2ND FINISH FLOOR)
- 12. ALL EXTERIOR MISC. METALS TO BE FILLED PAINTED, OR POWDER COATED AS PER OWNER REQUIRMENT.

'							
JLE	COLOR SCHEME (STUCCO TEXTURE IS SAND FINISH)						
	LOCATION	COLOR/ FINISH					
SCHEDULE	A STUCCO COLOR 1	COLOR: DUNN EDWARDS DE6213 - FINE GRAIN					
XTERIOR COLOR	B STUCCO COLOR 2	COLOR: DUNN EDWARDS DE6214 PIGEON GRAY					
O C	C STUCCO COLOR 3	COLOR: DUNN EDWARDS DE6378 JET					
EXTERI	D STUCCO COLOR 4	COLOR: DUNN EDWARDS DE6376 LOOKING GLASS					
	E METAL FASCIA/ BALCONY FACE/ STEEL COLUMN	anodized bronze					
	F HORIZONTAL METAL SIDING	COLOR TO MATCH: DUNN EDWARDS DE6376 LOOKING GLASS					
	G STANDING SEAM METAL ROOF	COLOR TO MATCH: DUNN EDWARDS DE6376 LOOKING GLASS					
	H CMU WALL/ VENEER	SANDBLASTED NATURAL GREY FINISH					
	J RAILINGS / STAIRS	DUNN EDWARDS DE6378 - JET					
	K WINDOW FRAMES/ METAL AWNINGS	anodized bronze					
	L GLU-LAM BEAMS	CLEAR VARNISH					


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NO DATE DESCRIPTION THE PREMIERE AT EASTMARK 2.0

JENNINGS HOLDINGS L.L.C. 5029 S. ELLSWORTH RD. MESA, AZ

ARCHISTRUCT LLC 345 N. BEVERLY MESA, AZ 85201 TEL: (602) 750-0445 WWW.ARCHISTRUCTDB.COM

THE OWNER, ARCHITECT, AND ENGINEER EXPRESSLY DISCLAIM ANY RESPONSIBILITY ARISING FROM ANY UNAUTHORIZED USE OF THESE PLANS, DRAWINGS, AND NOTES. ANY AUTHORIZATION MUST BE IN WRITING.

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CITY PROJECT NUMBER:

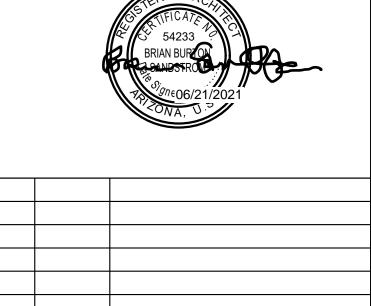
DRAWING TITLE:

AHJ STAMP

Building Type 3
Front and Left-side
Exterior Elevations

PROJECT NO: DRAWING NUMBER:

A3.3.5

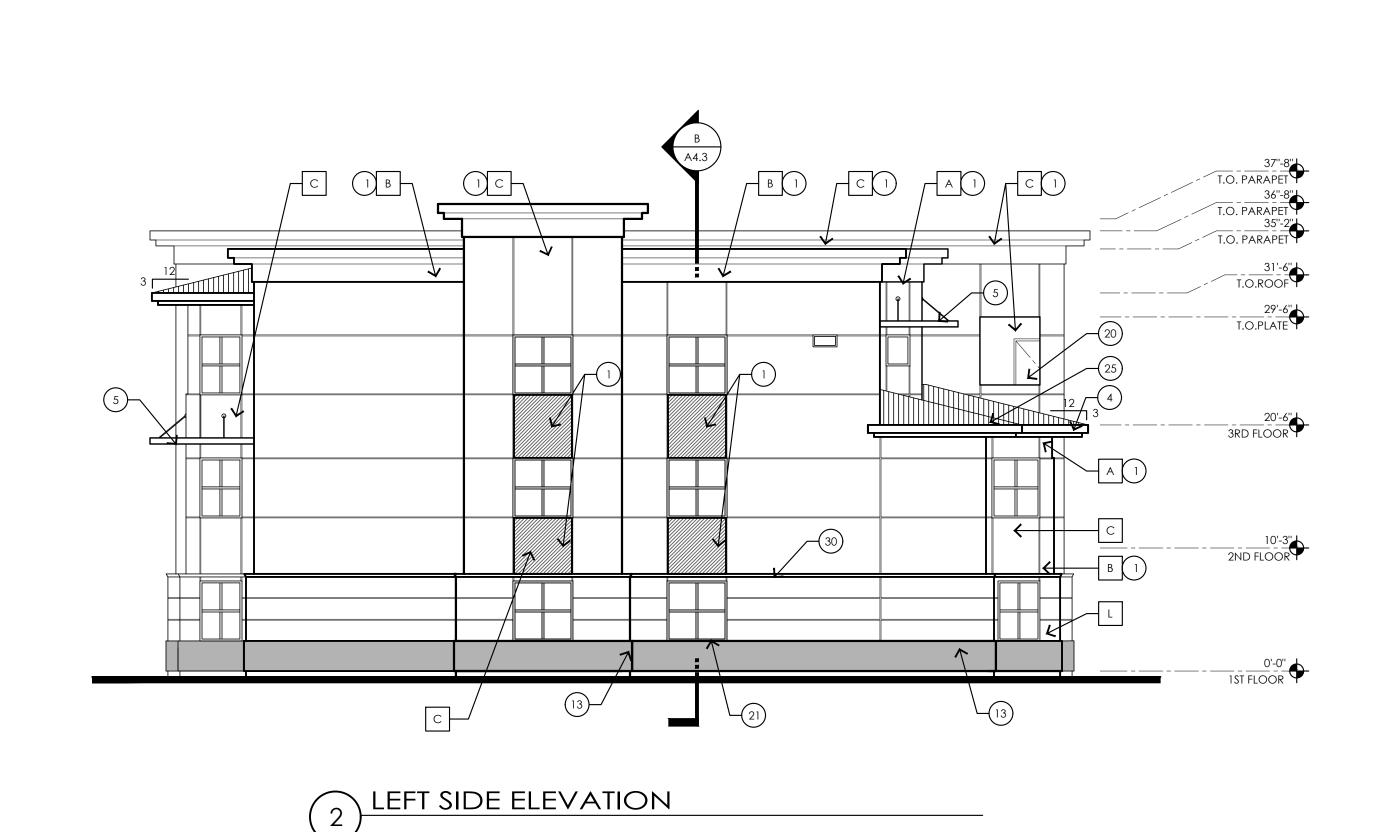

FRONT ELEVATION

- 1. METAL SIDING CAN BE REDUCED TO 6'-8" (EYE LEVEL) FROM GROUND. AREA FROM WHICH METAL SIDING WAS REMOVED SHALL BE REPLACED WITH STUCCO.
- 2. ALL SECOND LEVEL AWNINGS CAN BE REMOVED WITH OWNER
- 3. ALL METAL AWNINGS WITH WIRE MESH CAN BE REPLACED WITH FABRIC AWNINGS.
- ALL KEYNOTES MAY NOT BE USED
- 1. CEMENT STUCCO SYSTEM WITH SAND FINISH 2. CMU VENEER - REFER TO SCHEDULE FOR FINISH AND COLOR ■ 3. STANDING SEAM METAL PANEL ROOF SYSTEM
- METAL FASCIA PAINT PER COLOR SCHEDULE O 5. METAL AWNING - REFER TO DETAILS SHEET A8.7 AND COLOR
- SCHEDULE

 SCHEDULE

 6. STEEL COLUMNS / BEAMS

 7. ALUMINUM STOREFRONT SYSTEM

 8. PARAPET WALL WITH PARAPET METAL CAP

 9. EXPOSED 4X8X16 CMU REFER TO SCHEDULE FOR FINISH AND
- COLOR

 COLOR

 10. CAST-IN-PLACE CONCRETE NATURAL GRAY

 11. STEEL GUARDRAIL WITH DECORATIVE STEEL SHEET PANEL REFER TO COLOR SCHEDULE

 12. STUCCO CONTROL JOINT SEE DETAIL 9/A8.6

 13. FOAM POP-OUT

 14. COMMANDON OUT AT WINDOW SILL
- > 14. FOAM POP-OUT AT WINDOW SILL ■ 15. CHIMNEY
- 16. GARAGE DOOR
 17. BALCONY SCUPPER PAINT TO MATCH WALL WHERE OCCURS 18. ELECTRIC METERS
- 20. DOOR PER PLAN 21. DECORATIVE METAL EYEBROWS 18" PROJECTION
- 22. AWNING STEEL SUPPORT ROD SEE DETAILS SHEET A8.7. 23. FABRIC SHADE
- 24. CONCRETE WINDOW SILL 25. STANDING SEAM METAL ROOFING

19. METAL PANEL APPLICATION

- 26. PAINTED STEEL BEAM
- 27. FASCIA FINISH
- 28. CONTROL JOINT
 29. DECORATIVE METAL GUARDRAIL
 30. FOAM CHAIR RAIL POP OUT

PAINT ALL VENTS, FLASHING, MISC. MATERIALS TO MATCH ADJACENT BUILDING COLOR U.N.O.

- Z 2. STUCCO TEXTURE IS GUN DASH REFER TO SPECIFICATIONS "ALTERNATES" FOR ADDITIONAL FINISH TYPE. COORDINATE WITH GEN. CONTRACTOR.
- VERIFY ALL FINISHES WITH GEN. CONTRACTOR PRIOR TO APPLICATION
- VERIFY ALL COLOR SELECTIONS WITH COLORED ELEVATIONS & OWNER PRIOR TO APPLICATION.
- ALL PAINT COLOR CHANGES TO TERMINATE ON INSIDE CORNERS ONLY
- 6. ROOFING SHALL BE INSTALLED IN ACCORDANCE W/MANUFACTURER'S SPECIFICATIONS.
- 7. PROVIDE SEALANT AT ALL STUCCO PENETRATIONS 8. ALL CONTROL JOINTS & REVEALS TO TERMINATE ON INSIDE CORNERS ONLY
- 9. HORIZONTAL GROUT LINES TO HAVE "V" CONTOUR
- 10. VERTICAL GROUT LINES TO BE FLUSH
- 11. ANTI-GRAFFITI COATING AT CMU WALLS/VENEER (@ BUILDINGS COATING TO EXTEND UP TO 2ND FINISH FLOOR)
- 12. ALL EXTERIOR MISC. METALS TO BE FILLED PAINTED, OR POWDER COATED AS PER OWNER REQUIRMENT.

7	COLOR S (STUCCO TEXTUR	
<u> </u>	LOCATION	COLOR/ FINISH
	A STUCCO COLOR 1	COLOR: DUNN EDWARDS DE6213 - FINE GRAIN
	B STUCCO COLOR 2	COLOR: DUNN EDWARDS DE6214 PIGEON GRAY
ر ا ∠ ا	C STUCCO COLOR 3	COLOR: DUNN EDWARDS DE6378 JET
	D STUCCO COLOR 4	COLOR: DUNN EDWARDS DE6376 LOOKING GLASS
<u> </u>	E METAL FASCIA/ BALCONY FACE/ STEEL COLUMN	anodized bronze
	F HORIZONTAL METAL SIDING	COLOR TO MATCH: DUNN EDWARDS DE6376 LOOKING GLASS
	G STANDING SEAM METAL ROOF	COLOR TO MATCH: DUNN EDWARDS DE6376 LOOKING GLASS
	H CMU WALL/ VENEER	SANDBLASTED NATURAL GREY FINISH
	J RAILINGS / STAIRS	DUNN EDWARDS DE6378 - JET
	K WINDOW FRAMES/ METAL AWNINGS	ANODIZED BRONZE
	L GLU-LAM BEAMS	CLEAR VARNISH

ADDRESSING

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NO DATE DESCRIPTION THE PREMIERE AT EASTMARK 2.0

JENNINGS HOLDINGS L.L.C. 5029 S. ELLSWORTH RD. MESA, AZ ARCHISTRUCT LLC

345 N. BEVERLY MESA, AZ 85201 TEL: (602) 750-0445 WWW.ARCHISTRUCTDB.COM THE OWNER, ARCHITECT, AND ENGINEER EXPRESSLY DISCLAIM ANY RESPONSIBILITY ARISING FROM ANY UNAUTHORIZED USE OF THESE PLANS, DRAWINGS, AND NOTES. ANY

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AUTHORIZATION MUST BE IN WRITING.


AHJ STAMP


CITY PROJECT NUMBER:

DRAWING TITLE: Building Type 3 Rear and Right-side Exterior Elevations

PROJECT NO: DRAWING NUMBER:

A3.3.6

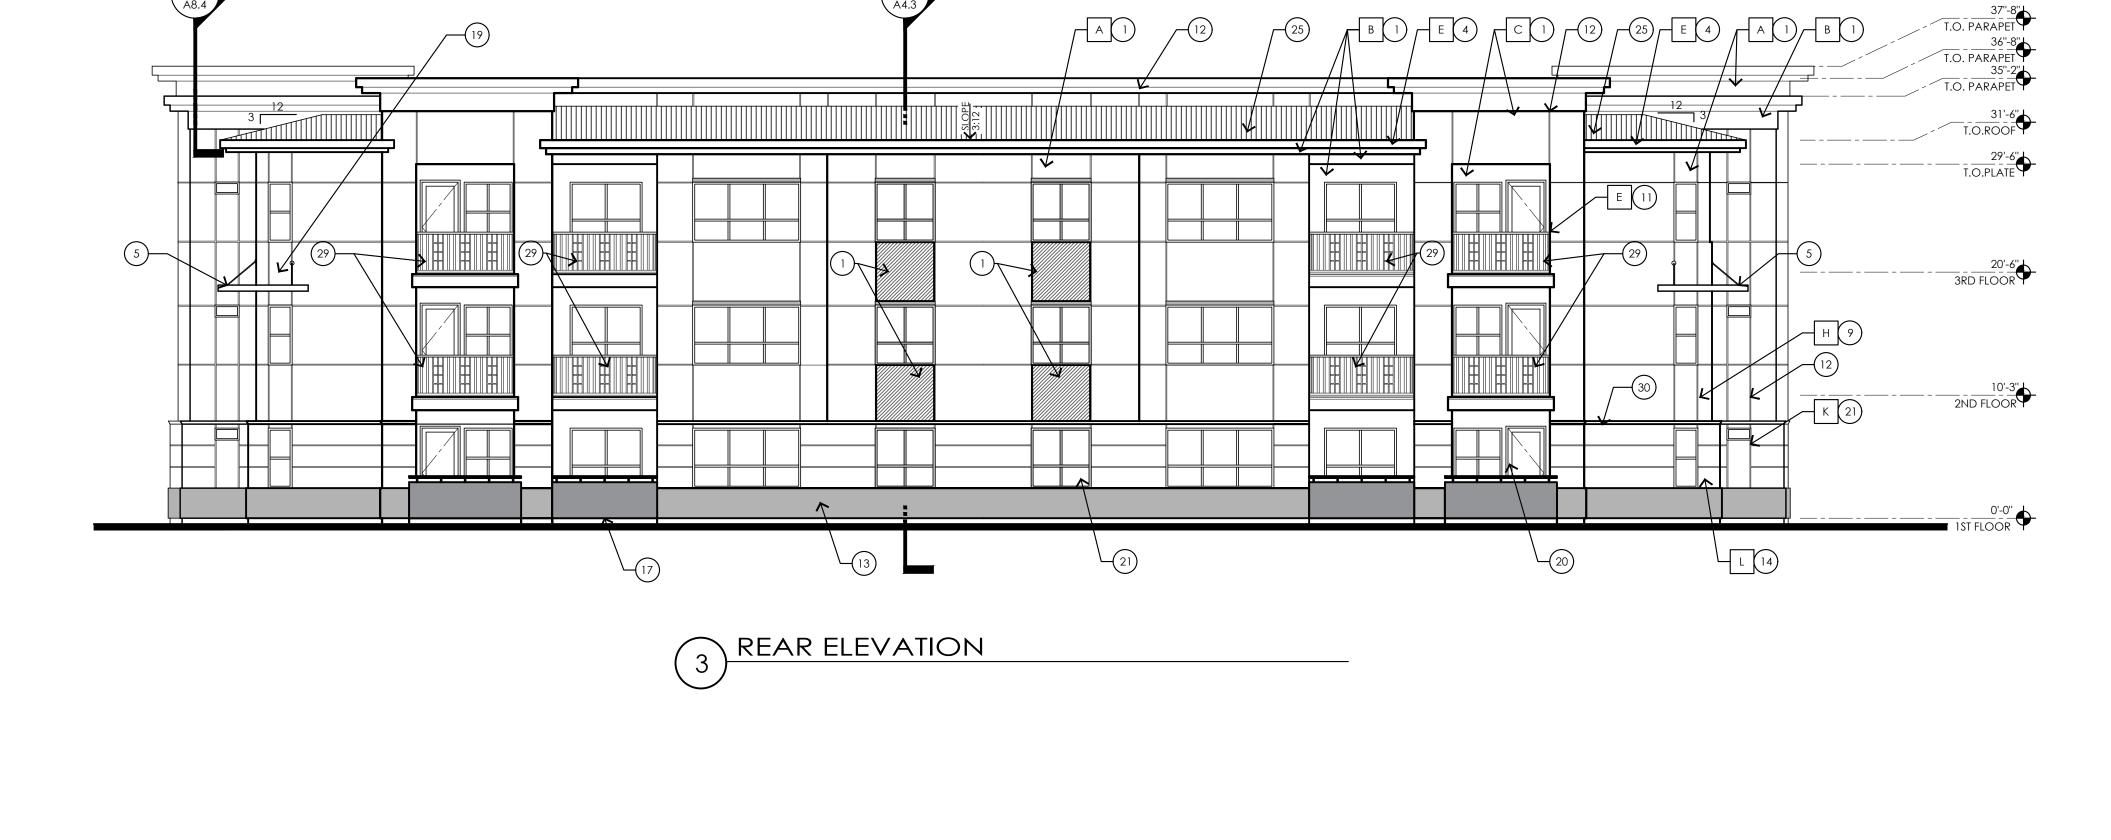

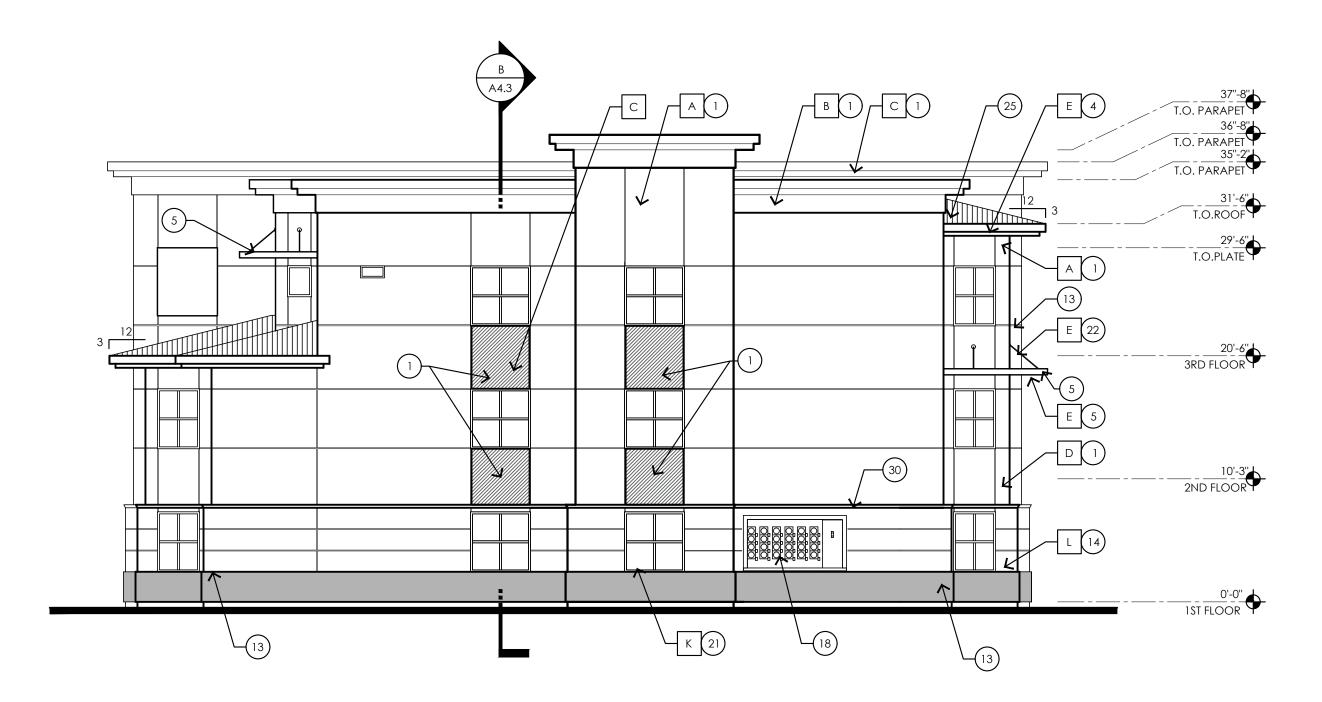

\ RIGHT SIDE ELEVATION

ALTERNATE EXTERIOR ELEVATION ELEMENT SUBSTITUTIONS AND/OR DELETIONS:

- 1. METAL SIDING CAN BE REDUCED TO 6'-8" (EYE LEVEL) FROM GROUND. AREA FROM WHICH METAL SIDING WAS REMOVED SHALL BE REPLACED
- WITH STUCCO. 2. ALL SECOND LEVEL AWNINGS CAN BE REMOVED WITH OWNER
- 3. ALL METAL AWNINGS WITH WIRE MESH CAN BE REPLACED WITH FABRIC AWNINGS.

 CEMENT STUCCO SYSTEM WITH SAND FINISH
 2. CMU VENEER - REFER TO SCHEDULE FOR FINISH AND COLOR ■ 3. STANDING SEAM METAL PANEL ROOF SYSTEM
■ 4. METAL FASCIA - PAINT PER COLOR SCHEDULE

ALL KEYNOTES MAY NOT BE USED

- METAL AWNING REFER TO DETAILS SHEET A8.7 AND COLOR METAL AWNING - RELEATE SEELING
 SCHEDULE
 STEEL COLUMNS / BEAMS
 ALUMINUM STOREFRONT SYSTEM
 PARAPET WALL WITH PARAPET METAL CAP
 EXPOSED 4X8X16 CMU - REFER TO SCHEDULE FOR FINISH AND
- COLOR

 10. CAST-IN-PLACE CONCRETE NATURAL GRAY

 11. STEEL GUARDRAIL WITH DECORATIVE STEEL SHEET PANEL REFER TO COLOR SCHEDULE

 12. STUCCO CONTROL JOINT SEE DETAIL 9/A8.6

 13. FOAM POP-OUT
- > 14. FOAM POP-OUT AT WINDOW SILL ■ 15. CHIMNEY ■ 16. GARAGE DOOR 17. BALCONY SCUPPER - PAINT TO MATCH WALL WHERE OCCURS
- 18. ELECTRIC METERS
 19. METAL PANEL APPLICATION 20. DOOR - PER PLAN 21. DECORATIVE METAL EYEBROWS 18" PROJECTION
- 22. AWNING STEEL SUPPORT ROD SEE DETAILS SHEET A8.7. 23. FABRIC SHADE
- 24. CONCRETE WINDOW SILL 25. STANDING SEAM METAL ROOFING 26. PAINTED STEEL BEAM
- 27. FASCIA FINISH
 28. CONTROL JOINT
 29. DECORATIVE METAL GUARDRAIL
 30. FOAM CHAIR RAIL POP OUT



FRONT ELEVATION



2 LEFT SIDE ELEVATION

ú	o	
Ц Н	<u>í</u> 1.	PAINT ALL VENTS, FLASHING, MISC. MATERIALS TO MATCH ADJACENT BUILDING COLOR U.N.O.
2	Z 2.	STUCCO TEXTURE IS GUN DASH REFER TO SPECIFICATIONS "ALTERNATES" FOR ADDITIONAL FINISH TYPE, COORDINATE WITH GEN. CONTRACTOR.
0	☑ 3. ⊔	VERIFY ALL FINISHES WITH GEN. CONTRACTOR PRIOR TO APPLICATION
Ц	Z 山 ^{4.} り	VERIFY ALL COLOR SELECTIONS WITH COLORED ELEVATIONS & OWNER PRIOR TO APPLICATION.
	5.	ALL PAINT COLOR CHANGES TO TERMINATE ON INSIDE CORNERS ONLY
	6.	ROOFING SHALL BE INSTALLED IN ACCORDANCE W/MANUFACTURER'S SPECIFICATIONS.
	7.	PROVIDE SEALANT AT ALL STUCCO PENETRATIONS
	8.	ALL CONTROL JOINTS & REVEALS TO TERMINATE ON INSIDE CORNERS ONLY
	9.	HORIZONTAL GROUT LINES TO HAVE "V" CONTOUR
	10.	VERTICAL GROUT LINES TO BE FLUSH
	11.	ANTI-GRAFFITI COATING AT CMU WALLS/VENEER (@ BUILDINGS COATING TO EXTEND UP TO 2ND FINISH FLOOR)
	12.	ALL EXTERIOR MISC. METALS TO BE FILLED PAINTED, OR POWDER COATED AS PER OWNER REQUIRMENT.

ш =	COLOR SCHEME (STUCCO TEXTURE IS SAND FINISH)					
2	LOCATION	COLOR/ FINISH				
THU CHHO		COLOR: DUNN EDWARDS DE6213 - FINE GRAIN				
XTERIOR COLOR	B STUCCO COLOR 2	COLOR: DUNN EDWARDS DE6214 PIGEON GRAY				
ر م	C STUCCO COLOR 3	COLOR: DUNN EDWARDS DE6378 JET				
FXTFR		COLOR: DUNN EDWARDS DE6376 LOOKING GLASS				
	E METAL FASCIA/ BALCONY FACE/ STEEL COLUMN	anodized bronze				
	F HORIZONTAL METAL SIDING	COLOR TO MATCH: DUNN EDWARDS DE6376 LOOKING GLASS				
	G STANDING SEAM METAL ROOF	COLOR TO MATCH: DUNN EDWARDS DE6376 LOOKING GLASS				
	H CMU WALL/ VENEER	SANDBLASTED NATURAL GREY FINISH				
	J RAILINGS / STAIRS	DUNN EDWARDS DE6378 - JET				
	K WINDOW FRAMES/ METAL AWNINGS	anodized bronze				
	L GLU-LAM BEAMS	CLEAR VARNISH				


ADDRESSING

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TEL: (602) 750-0445 WWW.ARCHISTRUCTDB.COM

AHJ STAMP

CITY PROJECT NUMBER:

DRAWING TITLE:

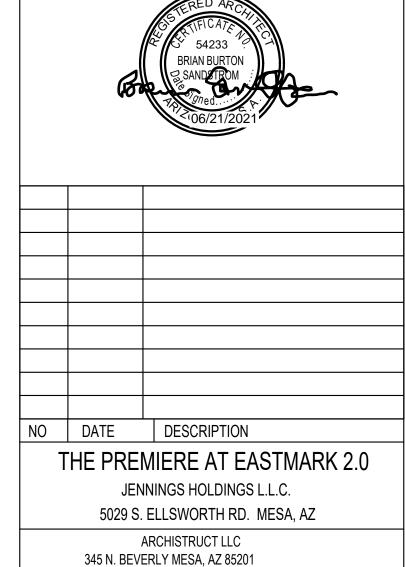Building Type 3 Front and Left-side Exterior Elevations

DRAWING NUMBER: A3.3.5

ALTERNATE EXTERIOR ELEVATION ELEMENT SUBSTITUTIONS AND/OR DELETIONS:

- 1. METAL SIDING CAN BE REDUCED TO 6'-8" (EYE LEVEL) FROM GROUND. AREA FROM WHICH METAL SIDING WAS REMOVED SHALL BE REPLACED
- 2. ALL SECOND LEVEL AWNINGS CAN BE REMOVED WITH OWNER
- APPROVAL. 3. ALL METAL AWNINGS WITH WIRE MESH CAN BE REPLACED WITH FABRIC AWNINGS.

T.O. PARAPET T.O.

- ALL KEYNOTES MAY NOT BE USED
 - CEMENT STUCCO SYSTEM WITH SAND FINISH
 CMU VENEER REFER TO SCHEDULE FOR FINISH AND COLOR
 STANDING SEAM METAL PANEL ROOF SYSTEM METAL FASCIA - PAINT PER COLOR SCHEDULE
 - O 5. METAL AWNING REFER TO DETAILS SHEET A8.7 AND COLOR SCHEDULE STEEL COLUMNS / BEAMS ALUMINUM STOREFRONT SYSTEM
 PARAPET WALL WITH PARAPET METAL CAP
 - 9. EXPOSED 4X8X16 CMU REFER TO SCHEDULE FOR FINISH AND
 - 9. EXPOSED 4X8X16 CMU REFER TO SCHEDULE FOR FINISH AND COLOR

 10. CAST-IN-PLACE CONCRETE NATURAL GRAY

 11. STEEL GUARDRAIL WITH DECORATIVE STEEL SHEET PANEL REFER TO COLOR SCHEDULE

 12. STUCCO CONTROL JOINT SEE DETAIL 9/A8.6

 13. FOAM POP-OUT

 14. FOAM POP-OUT AT WINDOW SILL

 15. CHIMNEY


 16. GARAGE DOOR

 17. BALCONY SCUPPER PAINT TO MATCH WALL WHERE OCCURS

 18. ELECTRIC METERS

 19. METAL PANEL APPLICATION

 20. DOOR PER PLAN
 - 20. DOOR PER PLAN
 21. DECORATIVE METAL EYEBROWS 18" PROJECTION
 22. AWNING STEEL SUPPORT ROD SEE DETAILS SHEET A8.7.
 - 23. FABRIC SHADE
 - 24. CONCRETE WINDOW SILL
 25. STANDING SEAM METAL ROOFING 26. PAINTED STEEL BEAM 27. FASCIA FINISH
 - 28. CONTROL JOINT 29. DECORATIVE METAL GUARDRAIL 30. FOAM CHAIR RAIL POP OUT

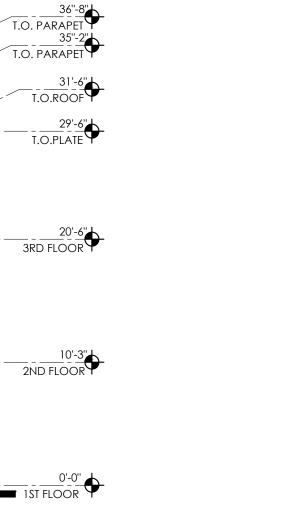

PAINT ALL VENTS, FLASHING, MISC. MATERIALS TO MATCH ADJACENT BUILDING COLOR U.N.O. Z 2. STUCCO TEXTURE IS GUN DASH REFER TO SPECIFICATIONS "ALTERNATES" FOR ADDITIONAL FINISH TYPE. COORDINATE WITH GEN. CONTRACTOR.

2 3. VERIFY ALL FINISHES WITH GEN. CONTRACTOR PRIOR TO APPLICATION VERIFY ALL COLOR SELECTIONS WITH COLORED ELEVATIONS & OWNER PRIOR TO APPLICATION.

ALL PAINT COLOR CHANGES TO TERMINATE ON INSIDE CORNERS ONLY

6. ROOFING SHALL BE INSTALLED IN ACCORDANCE W/MANUFACTURER'S SPECIFICATIONS.

7. PROVIDE SEALANT AT ALL STUCCO PENETRATIONS 8. ALL CONTROL JOINTS & REVEALS TO TERMINATE ON INSIDE CORNERS ONLY

9. HORIZONTAL GROUT LINES TO HAVE "V" CONTOUR 10. VERTICAL GROUT LINES TO BE FLUSH 11. ANTI-GRAFFITI COATING AT CMU WALLS/VENEER (@ BUILDINGS COATING TO EXTEND UP TO 2ND FINISH FLOOR)

12. ALL EXTERIOR MISC. METALS TO BE FILLED PAINTED, OR POWDER COATED AS PER OWNER REQUIRMENT.

	LOR SCHEME XTURE IS SAND FINISH)
LOCATION	COLOR/ FINISH
A STUCCO COLOR 1	COLOR: DUNN EDWARD DE6213 - FINE GRAIN
B STUCCO COLOR 2	COLOR: DUNN EDWARI DE6214 PIGEON GRAY
C STUCCO COLOR 3	COLOR: DUNN EDWARD DE6378 JET
D STUCCO COLOR 4	COLOR: DUNN EDWARD DE6376 LOOKING GLASS
E METAL FASCIA/ BALCO FACE/ STEEL COLUMN	ANODIZED BRONZE
F HORIZONTAL METAL SIDING	COLOR TO MATCH: DUNN EDWARDS DE6376 LOOKING GLASS
G STANDING SEAM META	COLOR TO MATCH: DUNN EDWARDS DE6376 LOOKING GLASS
H CMU WALL/ VENEER	SANDBLASTED NATURAL GREY FINISH
J RAILINGS / STAIRS	DUNN EDWARDS DE6378 - JET
K WINDOW FRAMES/ METAL AWNINGS	ANODIZED BRONZE
L GLU-LAM BEAMS	CLEAR VARNISH

ADDRESSING

Approved Building Addressing must comply with City of Mesa Fire Detail FPD 505.1.

Approved street addressed, including building/suite numbers, shall be placed on all new and existing buildings in such a position as to be plainly visible and legible from the street or road fronting the property. Said numbers shall contrast with their background.

No street address or building number shall be posted under a gable or obstructed by any feature or follage.

Address numbers should be no lower than the first story or on a sign at each entrance facing the designated property address. Numbers shall be a minimum 12" high with a 2" stroke and contrast the facility colors.



NO	DATE	DESCRI	PTION	

THE PREMIERE AT EASTMARK 2.0 JENNINGS HOLDINGS L.L.C.

5029 S. ELLSWORTH RD. MESA, AZ ARCHISTRUCT LLC

345 N. BEVERLY MESA, AZ 85201 TEL: (602) 750-0445 WWW.ARCHISTRUCTDB.COM

THE OWNER, ARCHITECT, AND ENGINEER EXPRESSLY DISCLAIM ANY RESPONSIBILITY ARISING FROM ANY UNAUTHORIZED USE OF THESE PLANS, DRAWINGS, AND NOTES. ANY AUTHORIZATION MUST BE IN WRITING.

THIS DRAWING COPY MAY HAVE BEEN REPRODUCED AT A SIZE DIFFERENT THAN ORIGINALLY DRAWN. THE OWNER, ARCHITECT, AND ENGINEER ASSUME NO RESPONSIBILITY FOR THE USE OF INCORRECT SCALE.

CITY PROJECT NUMBER:


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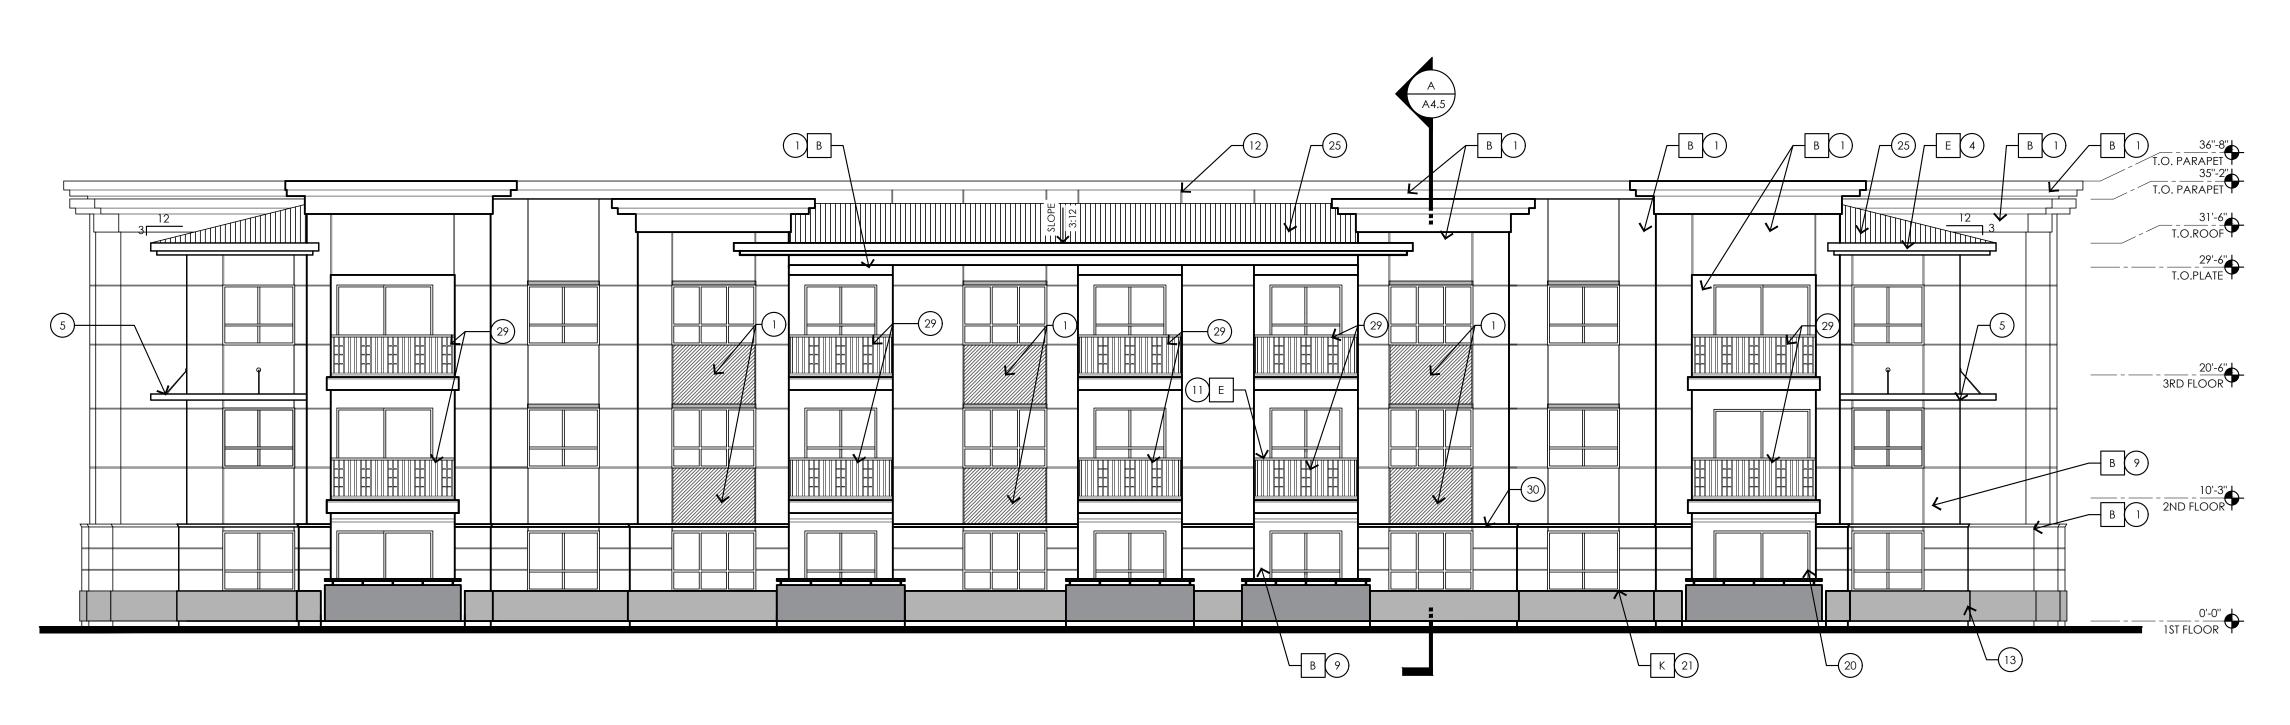
Building Type 3
Rear and Right-side Exterior Elevations

DRAWING NUMBER: PROJECT NO: A3.3.6




RIGHT SIDE ELEVATION



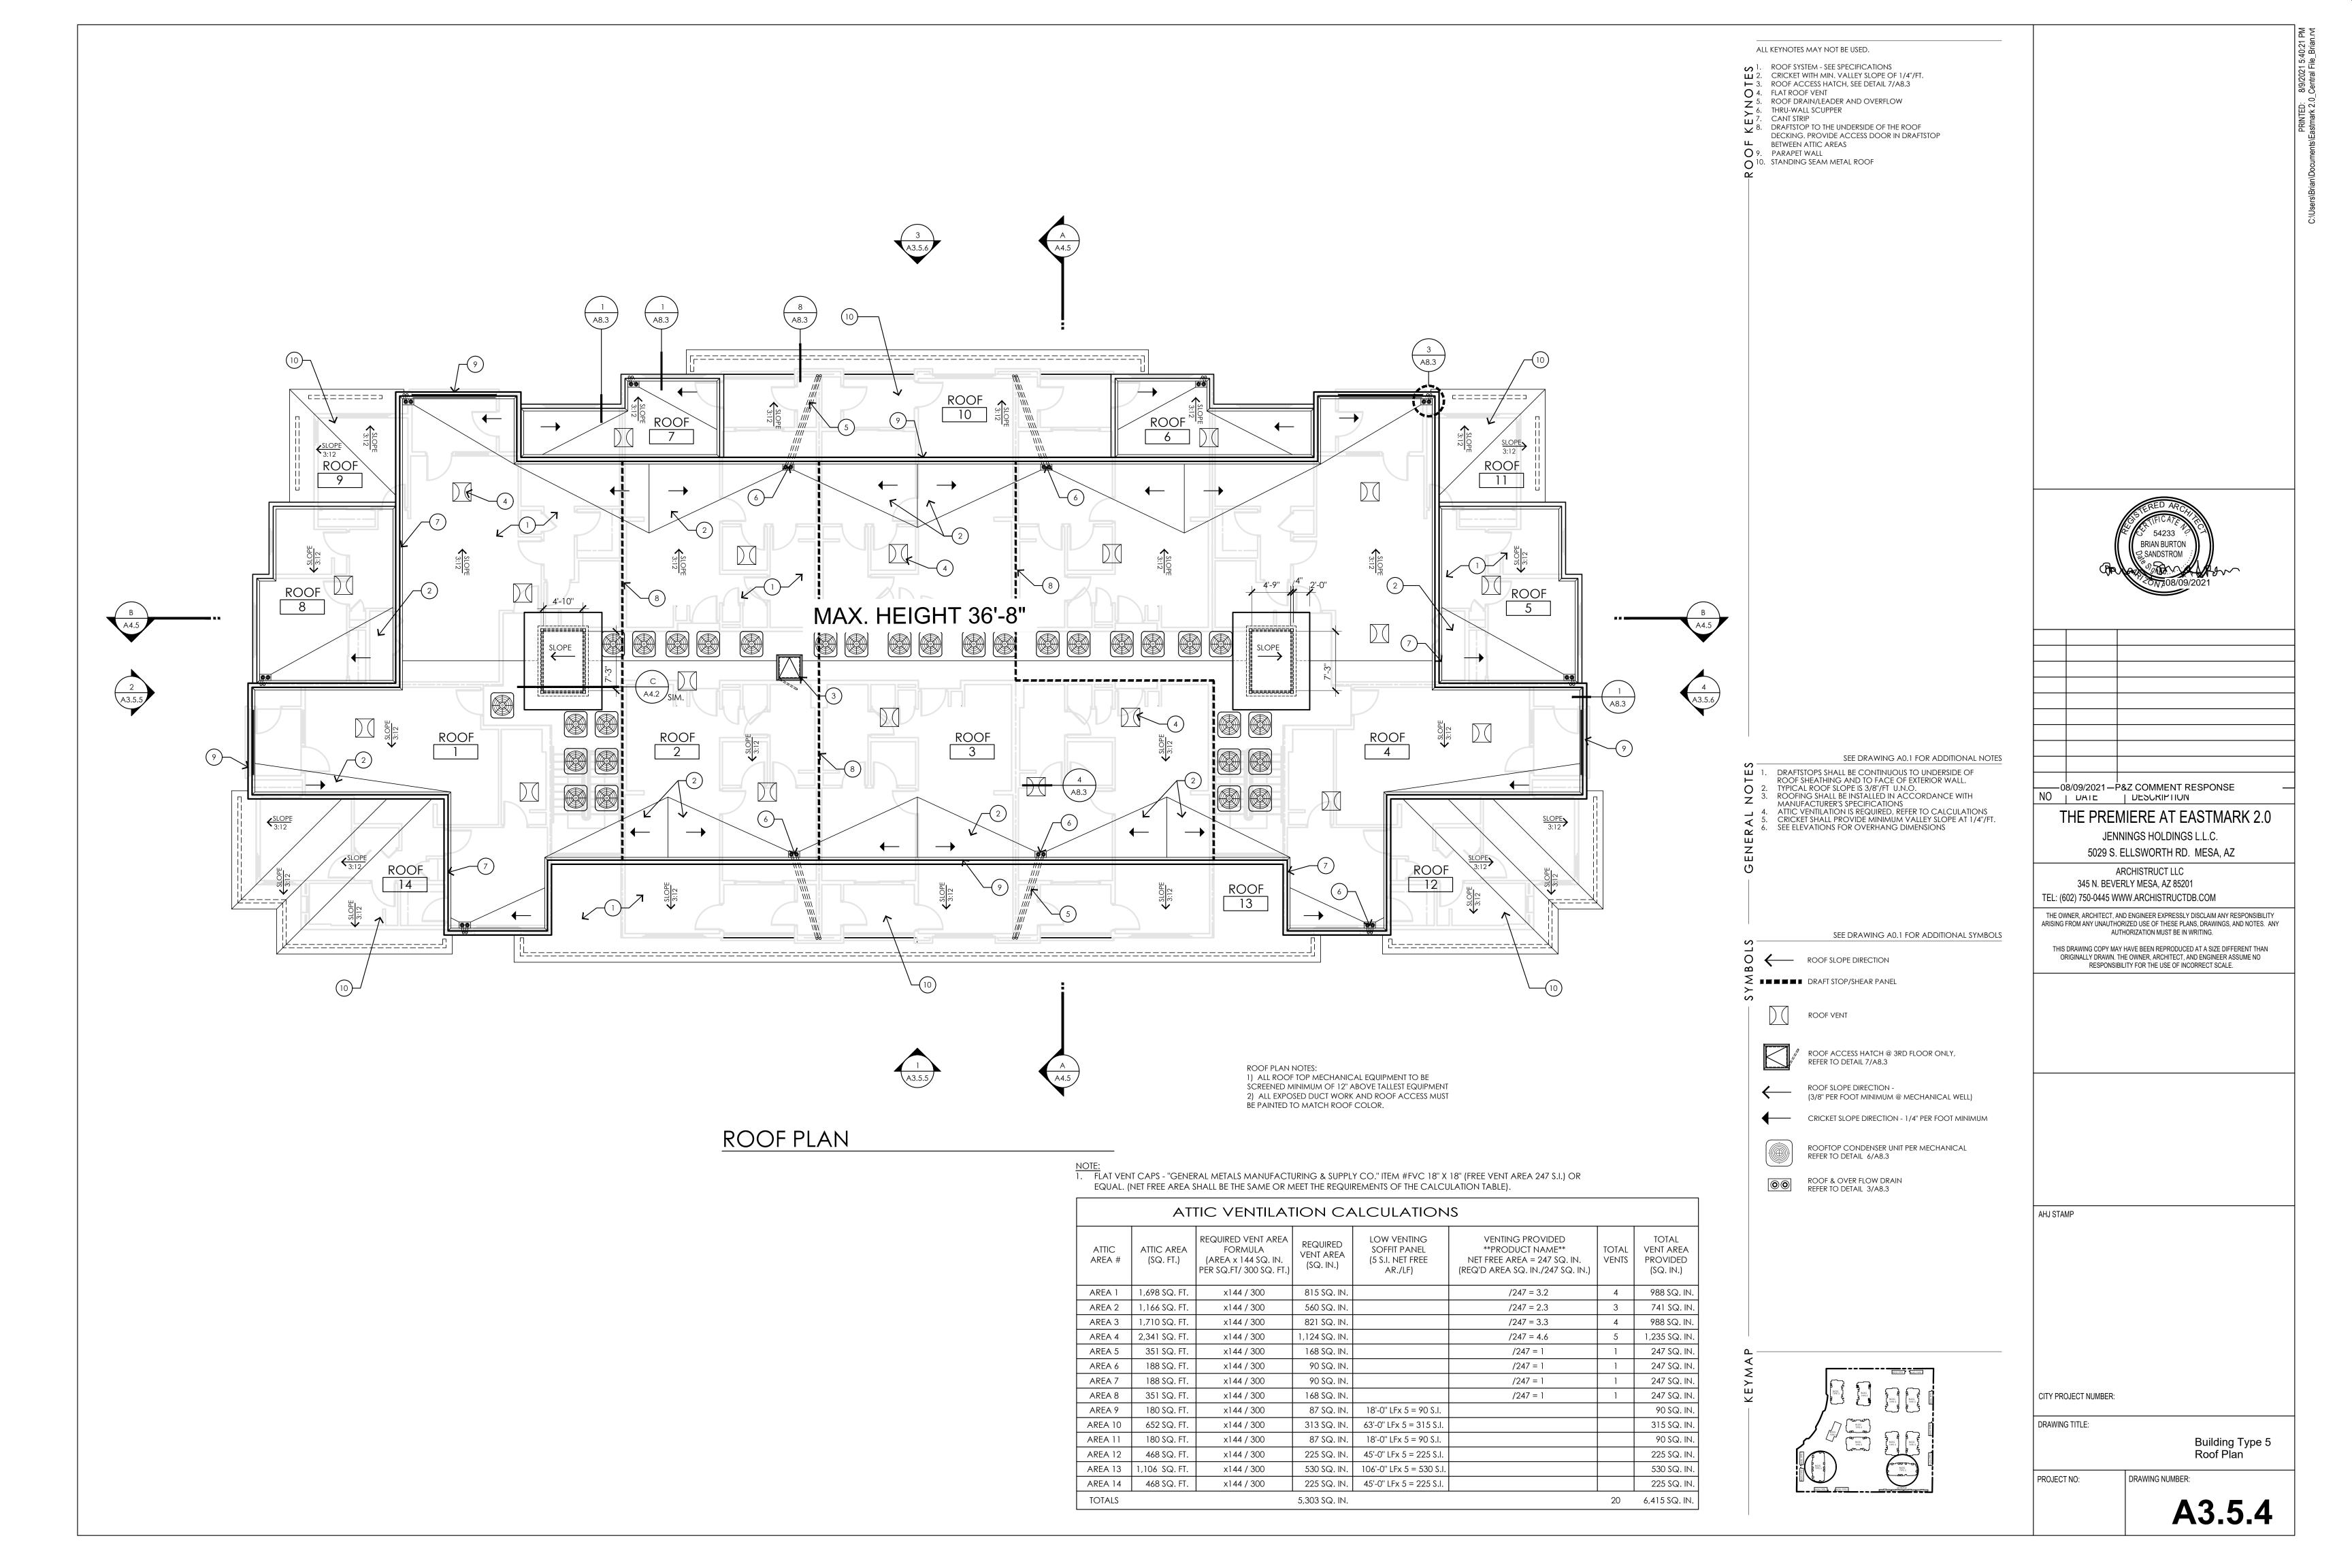


REAR ELEVATION

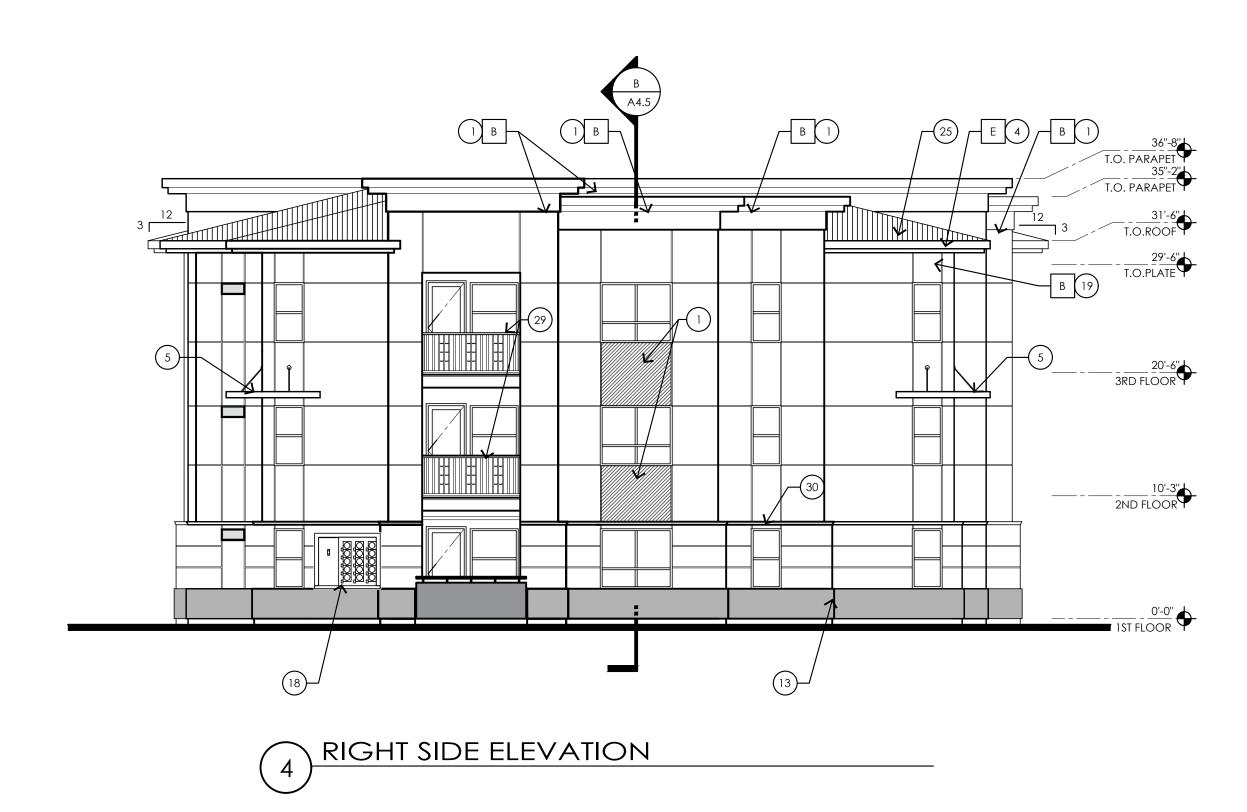


BUILDING TYPE 5
REAR AND RIGHT SIDE
EXTERIOR ELEVATIONS

SCALE: 1/8"=1'-0"

ALL KEYNOTES MAY NOT BE USED 1. CEMENT STUCCO SYSTEM WITH SAND FINISH CEMENT STUCCO STSTEM WITH SAND FINISH
2. CMU VENEER - REFER TO SCHEDULE FOR FINISH AND COLOR
3. STANDING SEAM METAL PANEL ROOF SYSTEM
4. METAL FASCIA - PAINT PER COLOR SCHEDULE
5. METAL FASCIA - REFER TO DETAILS SHEET A8.7 AND COLOR SCHEDULE STEEL COLUMNS / BEAMS ALUMINUM STOREFRONT SYSTEM B. PARAPET WALL WITH PARAPET METAL CAP 9. EXPOSED 4X8X16 CMU - REFER TO SCHEDULE FOR FINISH AND Z COLOR
10. CAST-IN-PLACE CONCRETE - NATURAL GRAY O 11. STEEL GUARDRAIL - WITH DECORATIVE STEEL SHEET PANEL REFER TO COLOR SCHEDULE 12. STUCCO CONTROL JOINT - SEE DETAIL 9/A8.6
13. FOAM POP-OUT > 14. FOAM POP-OUT AT WINDOW SILL ☐ 15. CHIMNEY ☐ 16. GARAGE DOOR ☐ 17. BALCONY SCUPPER - PAINT TO MATCH WALL WHERE OCCURS 18. ELECTRIC METERS 19. METAL PANEL APPLICATION 20. DOOR - PER PLAN 21. DECORATIVE METAL EYEBROWS 18" PROJECTION 22. AWNING STEEL SUPPORT ROD - SEE DETAILS SHEET A8.7.
23. FABRIC SHADE 24. CONCRETE WINDOW SILL 25. STANDING SEAM METAL ROOFING
26. PAINTED STEEL BEAM
27. FASCIA FINISH 28. CONTROL JOINT 29. DECORATIVE METAL GUARDRAIL 30. FOAM CHAIR RAIL POP OUT PAINT ALL VENTS, FLASHING, MISC. MATERIALS TO MATCH ADJACENT BUILDING COLOR U.N.O. Z 2. STUCCO TEXTURE IS GUN DASH REFER TO SPECIFICATIONS
"ALTERNATES" FOR ADDITIONAL FINISH TYPE. COORDINATE WITH GEN. CONTRACTOR. APPLICATION VERIFY ALL COLOR SELECTIONS WITH COLORED ELEVATIONS & OWNER PRIOR TO APPLICATION. . ROOFING SHALL BE INSTALLED IN ACCORDANCE W/MANUFACTURER'S SPECIFICATIONS. 7. PROVIDE SEALANT AT ALL STUCCO PENETRATIONS 8. ALL CONTROL JOINTS & REVEALS TO TERMINATE ON INSIDE CORNERS ONLY 9. HORIZONTAL GROUT LINES TO HAVE "V" CONTOUR 10. VERTICAL GROUT LINES TO BE FLUSH 11. ANTI-GRAFFITI COATING AT CMU WALLS/VENEER (@ BUILDINGS COATING TO EXTEND UP TO 2ND FINISH FLOOR) 12. ALL EXTERIOR MISC. METALS TO BE FILLED PAINTED, OR POWDER COATED AS PER OWNER REQUIRMENT. COLOR SCHEME (STUCCO TEXTURE IS SAND FINISH) COLOR/ FINISH COLOR: DUNN EDWARDS NO DATE DESCRIPTION O A STUCCO COLOR 1 DE6213 - FINE GRAIN THE PREMIERE AT EASTMARK 2.0 COLOR: DUNN EDWARDS DE6214 PIGEON GRAY O B STUCCO COLOR 2 JENNINGS HOLDINGS L.L.C. 5029 S. ELLSWORTH RD. MESA, AZ COLOR: DUNN EDWARDS ARCHISTRUCT LLC C STUCCO COLOR 3 DE6378 JET 345 N. BEVERLY MESA, AZ 85201 TEL: (602) 750-0445 WWW.ARCHISTRUCTDB.COM COLOR: DUNN EDWARDS UD STUCCO COLOR 4 THE OWNER, ARCHITECT, AND ENGINEER EXPRESSLY DISCLAIM ANY RESPONSIBILITY DE6376 LOOKING GLASS ARISING FROM ANY UNAUTHORIZED USE OF THESE PLANS, DRAWINGS, AND NOTES. ANY AUTHORIZATION MUST BE IN WRITING. E METAL FASCIA/ BALCONY FACE/ STEEL COLUMN THIS DRAWING COPY MAY HAVE BEEN REPRODUCED AT A SIZE DIFFERENT THAN ANODIZED BRONZE ORIGINALLY DRAWN. THE OWNER, ARCHITECT, AND ENGINEER ASSUME NO RESPONSIBILITY FOR THE USE OF INCORRECT SCALE. COLOR TO MATCH: F HORIZONTAL METAL SIDING DUNN EDWARDS DE6376 LOOKING GLASS COLOR TO MATCH: DUNN EDWARDS G STANDING SEAM METAL ROOF DE6376 LOOKING GLASS SANDBLASTED NATURAL GREY FINISH H CMU WALL/ VENEER DUNN EDWARDS DE6378 - JET J RAILINGS / STAIRS K WINDOW FRAMES/ METAL AWNINGS ANODIZED BRONZE L GLU-LAM BEAMS CLEAR VARNISH AHJ STAMP **ADDRESSING** Approved Building Addressing must comply with City of Mesa Fire Detail FPD 505.1. Approved street addressed, including building/suite numbers, shall be placed on all new and existing buildings in such a position as to be plainly visible and legible from the street or road fronting the property. Said numbers shall contrast with their background. No street address or building number shall be posted under a CITY PROJECT NUMBER: gable or obstructed by any feature or follage. Address numbers should be no lower than the first story or on a DRAWING TITLE: Building Type 5 Rear and Right-side sign at each entrance facing the designated property address. Numbers shall be a minimum 12" high with a 2" stroke and **Exterior Elevations** contrast the facility colors. DRAWING NUMBER: PROJECT NO: A3.5.6

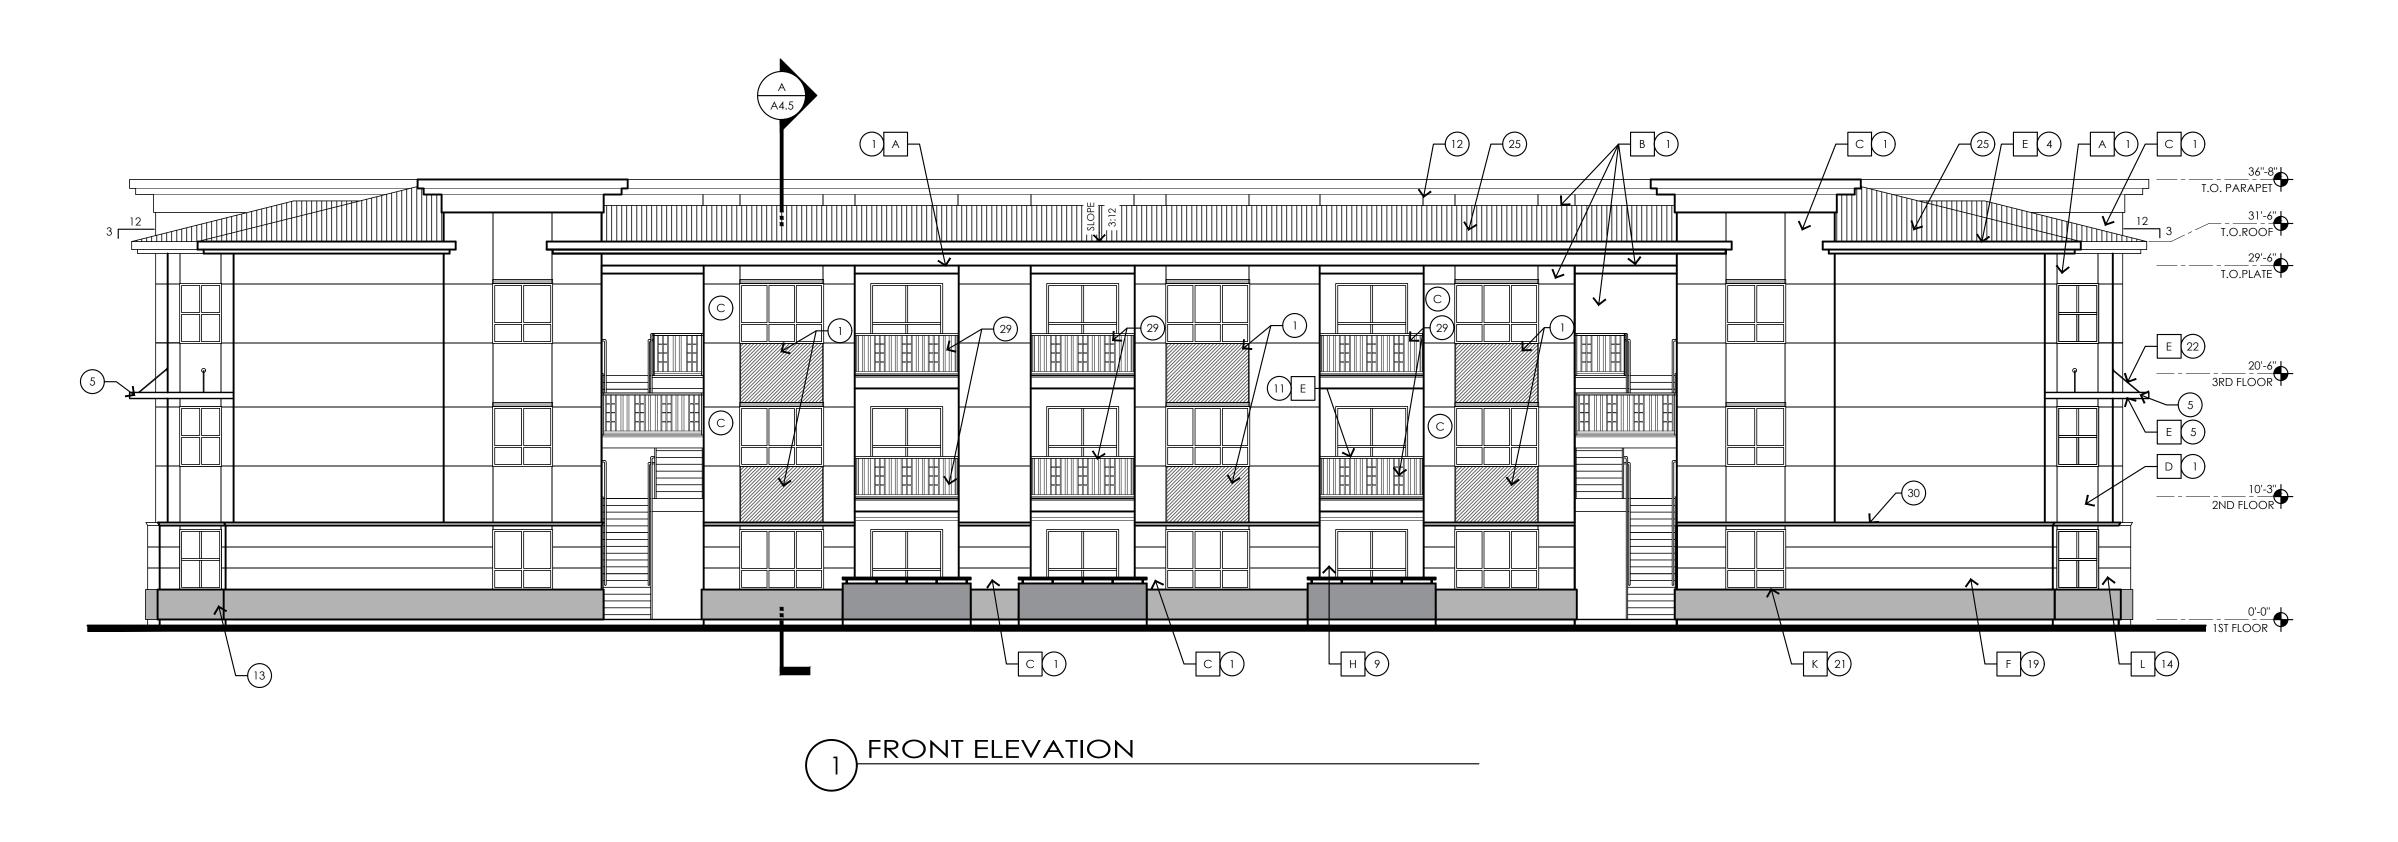

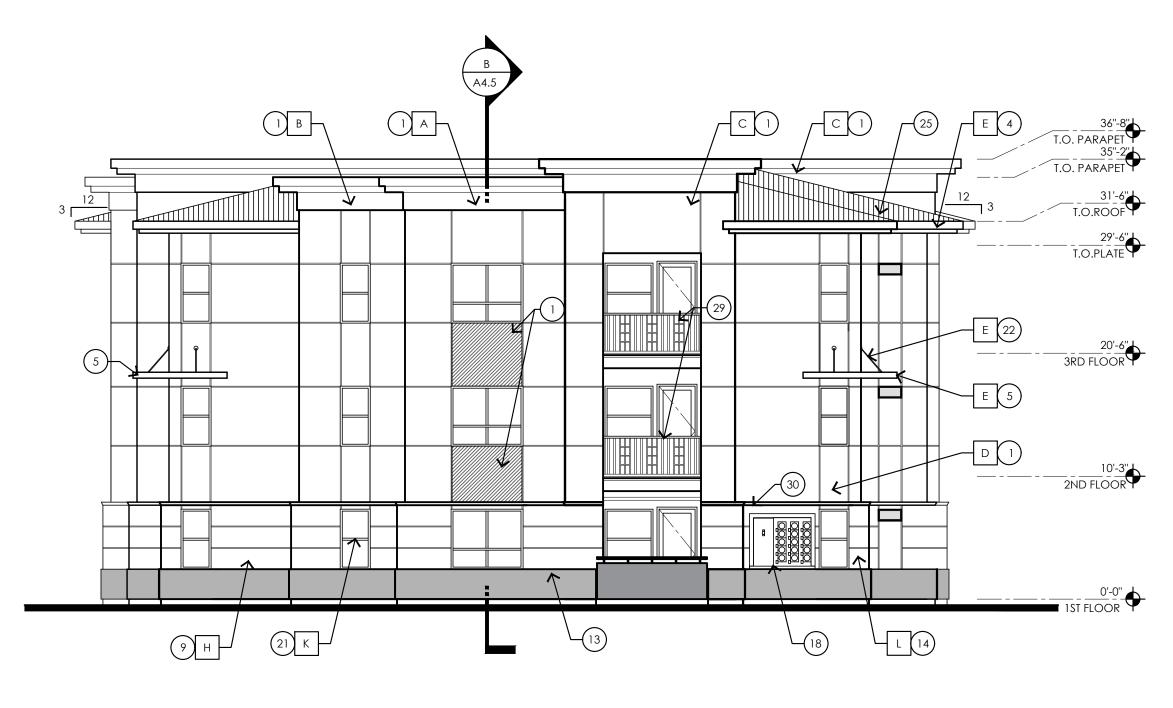

(2) LEFT SIDE ELEVATION

ALL KEYNOTES MAY NOT BE USED

- CEMENT STUCCO SYSTEM WITH SAND FINISH
 CMU VENEER REFER TO SCHEDULE FOR FINISH AND COLOR
 STANDING SEAM METAL PANEL ROOF SYSTEM
 METAL FASCIA PAINT PER COLOR SCHEDULE
 METAL AWNING REFER TO DETAILS SHEET A8.7 AND COLOR
- SCHEDULE STEEL COLUMNS / BEAMS
- 7. ALUMINUM STOREFRONT SYSTEM
 8. PARAPET WALL WITH PARAPET METAL CAP
 9. EXPOSED 4X8X16 CMU REFER TO SCHEDULE FOR FINISH AND
- 9. EXPOSED 4X8X16 CMU REFER TO SCHEDULE FOR FINISH AND COLOR

 10. CAST-IN-PLACE CONCRETE NATURAL GRAY

 11. STEEL GUARDRAIL WITH DECORATIVE STEEL SHEET PANEL REFER TO COLOR SCHEDULE

 12. STUCCO CONTROL JOINT SEE DETAIL 9/A8.6

 13. FOAM POP-OUT

 14. FOAM POP-OUT AT WINDOW SILL

 15. CHIMNEY

 16. GARAGE DOOR

- 16. GARAGE DOOR
 17. BALCONY SCUPPER PAINT TO MATCH WALL WHERE OCCURS
 18. ELECTRIC METERS
 19. METAL PANEL APPLICATION
- 20. DOOR PER PLAN
 21. DECORATIVE METAL EYEBROWS 18" PROJECTION
 22. AWNING STEEL SUPPORT ROD SEE DETAILS SHEET A8.7.

- 22. AWNING STEEL SUPPORT ROD SEE D
 23. FABRIC SHADE
 24. CONCRETE WINDOW SILL
 25. STANDING SEAM METAL ROOFING
 26. PAINTED STEEL BEAM
 27. FASCIA FINISH
 28. CONTROL JOINT
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 30. FOAM CHAIR RAIL POP OUT

PAINT ALL VENTS, FLASHING, MISC. MATERIALS TO MATCH ADJACENT BUILDING COLOR U.N.O.

. STUCCO TEXTURE IS GUN DASH REFER TO SPECIFICATIONS "ALTERNATES" FOR ADDITIONAL FINISH TYPE. COORDINATE WITH GEN. CONTRACTOR.

VERIFY ALL FINISHES WITH GEN. CONTRACTOR PRIOR TO APPLICATION

VERIFY ALL COLOR SELECTIONS WITH COLORED ELEVATIONS & OWNER PRIOR TO APPLICATION.

ALL PAINT COLOR CHANGES TO TERMINATE ON INSIDE CORNERS ONLY

ROOFING SHALL BE INSTALLED IN ACCORDANCE W/MANUFACTURER'S SPECIFICATIONS.

7. PROVIDE SEALANT AT ALL STUCCO PENETRATIONS

8. ALL CONTROL JOINTS & REVEALS TO TERMINATE ON INSIDE CORNERS ONLY


9. HORIZONTAL GROUT LINES TO HAVE "V" CONTOUR

10. VERTICAL GROUT LINES TO BE FLUSH

11. ANTI-GRAFFITI COATING AT CMU WALLS/VENEER (@ BUILDINGS COATING TO EXTEND UP TO 2ND FINISH FLOOR)

12. ALL EXTERIOR MISC. METALS TO BE FILLED PAINTED, OR POWDER COATED AS PER OWNER REQUIRMENT.

COLOR SCHEME (STUCCO TEXTURE IS SAND FINISH)				
LOCATION	COLOR/ FINISH			
A STUCCO COLOR 1	COLOR: DUNN EDWARDS DE6213 - FINE GRAIN			
B STUCCO COLOR 2	COLOR: DUNN EDWARD: DE6214 PIGEON GRAY			
C STUCCO COLOR 3	COLOR: DUNN EDWARDS DE6378 JET			
D STUCCO COLOR 4	COLOR: DUNN EDWARDS DE6376 LOOKING GLASS			
E METAL FASCIA/ BALCON FACE/ STEEL COLUMN	ANODIZED BRONZE			
F HORIZONTAL METAL SIDING	COLOR TO MATCH: DUNN EDWARDS DE6376 LOOKING GLASS			
G STANDING SEAM METAL ROOF	COLOR TO MATCH: DUNN EDWARDS DE6376 LOOKING GLASS			
H CMU WALL/ VENEER	SANDBLASTED NATURAL GREY FINISH			
J RAILINGS / STAIRS	DUNN EDWARDS DE6378 - JET			
K WINDOW FRAMES/ METAL AWNINGS	ANODIZED BRONZE			
L GLU-LAM BEAMS	CLEAR VARNISH			

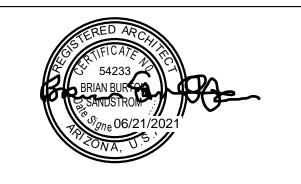

DESCRIPTION NO DATE THE PREMIERE AT EASTMARK 2.0 JENNINGS HOLDINGS L.L.C.

> 5029 S. ELLSWORTH RD. MESA, AZ ARCHISTRUCT LLC

345 N. BEVERLY MESA, AZ 85201 TEL: (602) 750-0445 WWW.ARCHISTRUCTDB.COM THE OWNER, ARCHITECT, AND ENGINEER EXPRESSLY DISCLAIM ANY RESPONSIBILITY

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ARISING FROM ANY UNAUTHORIZED USE OF THESE PLANS, DRAWINGS, AND NOTES. ANY AUTHORIZATION MUST BE IN WRITING.

AHJ STAMP

CITY PROJECT NUMBER:

DRAWING TITLE:

Building Type 5 Front and Left-side **Exterior Elevations**

DRAWING NUMBER: PROJECT NO: A3.5.5



(3) REAR ELEVATION



(4) RIGHT SIDE ELEVATION

		ALL KEYNOTES MAY NOT BE USED CEMENT STUCCO SYSTEM WIT CMU VENEER - REFER TO SCH STANDING SEAM METAL PANI METAL FASCIA - PAINT PER CO METAL AWNING - REFER TO D SCHEDULE STEEL COLUMNS / BEAMS ALUMINUM STOREFRONT SYST PARAPET WALL WITH PARAPE EXPOSED 4X8X16 CMU - REFE COLOR CAST-IN-PLACE CONCRETE - I STEEL GUARDRAIL - WITH DEC REFER TO COLOR SCHEDULE STUCCO CONTROL JOINT - SE FOAM POP-OUT HE FOAM POP-OUT AT WINDOW CHIMNEY GARAGE DOOR ABALCONY SCUPPER - PAINT TO BALCONY SCUPPER - PAINT TO ARAGE DOOR FABALCONY SCUPPER - PAINT TO ARAGE DOOR THE BALCONY SCUPPER - PAINT TO COLOR STEEL SUPPORT ROC AWNING STEEL SUPPORT ROC CANCRETE WINDOW SILL STANDING SEAM METAL ROC AND THE STEEL BEAM FASCIA FINISH CONTROL JOINT CONTROL PREPER TO CONTROL JOINT CONTROL PREPER TO CONTROL PREPER TO CONTROL TO	DEDULE FOR FINISH AND COLOR EL ROOF SYSTEM OLOR SCHEDULE DETAILS SHEET A8.7 AND COLOR TEM T METAL CAPER TO SCHEDULE FOR FINISH AND NATURAL GRAY CORATIVE STEEL SHEET PANEL - SEE DETAIL 9/A8.6 SILL O MATCH WALL WHERE OCCURS WS 18" PROJECTION D - SEE DETAILS SHEET A8.7.			
	GENE CENE	ADJACENT BUILDING COLOR 2. STUCCO TEXTURE IS GUN DAS "ALTERNATES" FOR ADDITIONA GEN. CONTRACTOR. 3. VERIFY ALL FINISHES WITH GEN APPLICATION 4. VERIFY ALL COLOR SELECTION OWNER PRIOR TO APPLICATION 5. ALL PAINT COLOR CHANGES CORNERS ONLY 6. ROOFING SHALL BE INSTALLED W/MANUFACTURER'S SPECIFIC 7. PROVIDE SEALANT AT ALL STUG 8. ALL CONTROL JOINTS & REVE. CORNERS ONLY	U.N.O. H REFER TO SPECIFICATIONS AL FINISH TYPE. COORDINATE WITH N. CONTRACTOR PRIOR TO NS WITH COLORED ELEVATIONS & DN. TO TERMINATE ON INSIDE D IN ACCORDANCE CATIONS. CCO PENETRATIONS FALS TO TERMINATE ON INSIDE		B	SERED ARCHITCA 54233 BRIAN BURTON SANDATROM PARTICIPATION SANDATROM PARTICIPATION PARTICI
	1	 P. HORIZONTAL GROUT LINES TO O. VERTICAL GROUT LINES TO BE 1. ANTI-GRAFFITI COATING AT C COATING TO EXTEND UP TO 2 	FLUSH CMU WALLS/VENEER (@ BUILDINGS			
	1	ALL EXTERIOR MISC. METALS TO POWDER COATED AS PER OW	O BE FILLED PAINTED, OR VNER REQUIRMENT.			
=	DULE	COLOR (STUCCO TEXTUR LOCATION	SCHEME E IS SAND FINISH) COLOR/ FINISH			
:	CHE	A STUCCO COLOR 1	COLOR: DUNN EDWARDS DE6213 - FINE GRAIN	NO	DATE	DESCRIPTION
•	S S			T		IERE AT EASTMARK 2.0 INGS HOLDINGS L.L.C.
-	0	B STUCCO COLOR 2	COLOR: DUNN EDWARDS DE6214 PIGEON GRAY		-	
(- ((R COL	C STUCCO COLOR 3			5029 S. E.	LLSWORTH RD. MESA, AZ CHISTRUCT LLC LY MESA, AZ 85201
(((((((((((((((((((TERIOR COL		DE6214 PIGEON GRAY COLOR: DUNN EDWARDS	THE OW	5029 S. El AR 345 N. BEVER 02) 750-0445 WW NER, ARCHITECT, AND	CHISTRUCT LLC LY MESA, AZ 85201 W.ARCHISTRUCTDB.COM ENGINEER EXPRESSLY DISCLAIM ANY RESPONSIBILITY
	OR COL	C STUCCO COLOR 3	DE6214 PIGEON GRAY COLOR: DUNN EDWARDS DE6378 JET COLOR: DUNN EDWARDS	THE OW ARISING F	5029 S. El AR 345 N. BEVER 02) 750-0445 WW NER, ARCHITECT, AND ROM ANY UNAUTHORI AUTH DRAWING COPY MAY H IGINALLY DRAWN. THE	CHISTRUCT LLC LY MESA, AZ 85201 W.ARCHISTRUCTDB.COM
	XTERIOR COL	C STUCCO COLOR 3 D STUCCO COLOR 4 E METAL FASCIA/ BALCONY	COLOR: DUNN EDWARDS DE6378 JET COLOR: DUNN EDWARDS DE6376 LOOKING GLASS ANODIZED BRONZE COLOR TO MATCH: DUNN EDWARDS	THE OW ARISING F	5029 S. El AR 345 N. BEVER 02) 750-0445 WW NER, ARCHITECT, AND ROM ANY UNAUTHORI AUTH DRAWING COPY MAY H IGINALLY DRAWN. THE	CHISTRUCT LLC LY MESA, AZ 85201 W.ARCHISTRUCTDB.COM ENGINEER EXPRESSLY DISCLAIM ANY RESPONSIBILITY ZED USE OF THESE PLANS, DRAWINGS, AND NOTES. ANY ORIZATION MUST BE IN WRITING. IAVE BEEN REPRODUCED AT A SIZE DIFFERENT THAN E OWNER, ARCHITECT, AND ENGINEER ASSUME NO
	XTERIOR COL	C STUCCO COLOR 3 D STUCCO COLOR 4 E METAL FASCIA/ BALCONY FACE/ STEEL COLUMN	DE6214 PIGEON GRAY COLOR: DUNN EDWARDS DE6378 JET COLOR: DUNN EDWARDS DE6376 LOOKING GLASS ANODIZED BRONZE COLOR TO MATCH:	THE OW ARISING F	5029 S. El AR 345 N. BEVER 02) 750-0445 WW NER, ARCHITECT, AND ROM ANY UNAUTHORI AUTH DRAWING COPY MAY H IGINALLY DRAWN. THE	CHISTRUCT LLC LY MESA, AZ 85201 W.ARCHISTRUCTDB.COM ENGINEER EXPRESSLY DISCLAIM ANY RESPONSIBILITY ZED USE OF THESE PLANS, DRAWINGS, AND NOTES. ANY ORIZATION MUST BE IN WRITING. IAVE BEEN REPRODUCED AT A SIZE DIFFERENT THAN E OWNER, ARCHITECT, AND ENGINEER ASSUME NO
	XTERIOR COL	C STUCCO COLOR 3 D STUCCO COLOR 4 E METAL FASCIA/ BALCONY FACE/ STEEL COLUMN F HORIZONTAL METAL SIDING C STANDING SEAM METAL	COLOR: DUNN EDWARDS DE6378 JET COLOR: DUNN EDWARDS DE6376 LOOKING GLASS ANODIZED BRONZE COLOR TO MATCH: DUNN EDWARDS DE6376 LOOKING GLASS COLOR TO MATCH: DUNN EDWARDS DE6376 LOOKING GLASS	THE OW ARISING F	5029 S. El AR 345 N. BEVER 02) 750-0445 WW NER, ARCHITECT, AND ROM ANY UNAUTHORI AUTH DRAWING COPY MAY H IGINALLY DRAWN. THE	CHISTRUCT LLC LY MESA, AZ 85201 W.ARCHISTRUCTDB.COM ENGINEER EXPRESSLY DISCLAIM ANY RESPONSIBILITY ZED USE OF THESE PLANS, DRAWINGS, AND NOTES. ANY ORIZATION MUST BE IN WRITING. IAVE BEEN REPRODUCED AT A SIZE DIFFERENT THAN E OWNER, ARCHITECT, AND ENGINEER ASSUME NO
	XTERIOR COL	C STUCCO COLOR 3 D STUCCO COLOR 4 E METAL FASCIA/ BALCONY FACE/ STEEL COLUMN F HORIZONTAL METAL SIDING G STANDING SEAM METAL ROOF	COLOR: DUNN EDWARDS DE6378 JET COLOR: DUNN EDWARDS DE6376 LOOKING GLASS ANODIZED BRONZE COLOR TO MATCH: DUNN EDWARDS DE6376 LOOKING GLASS COLOR TO MATCH: DUNN EDWARDS DE6376 LOOKING GLASS COLOR TO MATCH: DUNN EDWARDS DE6376 LOOKING GLASS SANDBLASTED NATURAL	THE OW ARISING F	5029 S. El AR 345 N. BEVER 02) 750-0445 WW NER, ARCHITECT, AND ROM ANY UNAUTHORI AUTH DRAWING COPY MAY H IGINALLY DRAWN. THE	CHISTRUCT LLC LY MESA, AZ 85201 W.ARCHISTRUCTDB.COM ENGINEER EXPRESSLY DISCLAIM ANY RESPONSIBILITY ZED USE OF THESE PLANS, DRAWINGS, AND NOTES. ANY ORIZATION MUST BE IN WRITING. IAVE BEEN REPRODUCED AT A SIZE DIFFERENT THAN E OWNER, ARCHITECT, AND ENGINEER ASSUME NO
	XTERIOR COL	C STUCCO COLOR 3 D STUCCO COLOR 4 E METAL FASCIA/ BALCONY FACE/ STEEL COLUMN F HORIZONTAL METAL SIDING G STANDING SEAM METAL ROOF H CMU WALL/ VENEER	COLOR: DUNN EDWARDS DE6378 JET COLOR: DUNN EDWARDS DE6376 LOOKING GLASS ANODIZED BRONZE COLOR TO MATCH: DUNN EDWARDS DE6376 LOOKING GLASS COLOR TO MATCH: DUNN EDWARDS DE6376 LOOKING GLASS SANDBLASTED NATURAL GREY FINISH	THE OW ARISING F	5029 S. El AR 345 N. BEVER 02) 750-0445 WW NER, ARCHITECT, AND ROM ANY UNAUTHORI AUTH DRAWING COPY MAY H IGINALLY DRAWN. THE	CHISTRUCT LLC LY MESA, AZ 85201 W.ARCHISTRUCTDB.COM ENGINEER EXPRESSLY DISCLAIM ANY RESPONSIBILITY ZED USE OF THESE PLANS, DRAWINGS, AND NOTES. ANY ORIZATION MUST BE IN WRITING. IAVE BEEN REPRODUCED AT A SIZE DIFFERENT THAN E OWNER, ARCHITECT, AND ENGINEER ASSUME NO
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(2) LEFT SIDE ELEVATION

ALL KEYNOTES MAY NOT BE USED

1. CEMENT STUCCO SYSTEM WITH SAND FINISH

2. CMU VENEER - REFER TO SCHEDULE FOR FINISH AND COLOR

3. STANDING SEAM METAL PANEL ROOF SYSTEM

4. METAL FASCIA - PAINT PER COLOR SCHEDULE

O 5. METAL AWNING - REFER TO DETAILS SHEET A8.7 AND COLOR SCHEDULE

6. STEEL COLUMNS / BEAMS

7. ALUMINUM STOREFRONT SYSTEM

8. PARAPET WALL WITH PARAPET METAL CAP

9. EXPOSED 4X8X16 CMU - REFER TO SCHEDULE FOR FINISH AND COLOR

COLOR

10. CAST-IN-PLACE CONCRETE - NATURAL GRAY

11. STEEL GUARDRAIL - WITH DECORATIVE STEEL SHEET PANEL - REFER TO COLOR SCHEDULE

12. STUCCO CONTROL JOINT - SEE DETAIL 9/A8.6

13. FOAM POP-OUT

14. FOAM POP-OUT AT WINDOW SILL

15. CHIMNEY

16. GARAGE DOOR

17. BALCONY SCUPPER - PAINT TO MATCH WALL WHERE OCCURS

18. ELECTRIC METERS

19. METAL PANEL APPLICATION

20. DOOR - PER PLAN

21. DECORATIVE METAL EYEBROWS 18" PROJECTION

22. AWNING STEEL SUPPORT ROD - SEE DETAILS SHEET A8.7.

23. FABRIC SHADE

24. CONCRETE WINDOW SILL

25. STANDING SEAM METAL ROOFING

26. PAINTED STEEL BEAM

27. FASCIA FINISH

28. CONTROL JOINT

PAINT ALL VENTS, FLASHING, MISC. MATERIALS TO MATCH ADJACENT BUILDING COLOR U.N.O.

Z 2. STUCCO TEXTURE IS GUN DASH REFER TO SPECIFICATIONS
"ALTERNATES" FOR ADDITIONAL FINISH TYPE. COORDINATE WITH

29. DECORATIVE METAL GUARDRAIL

30. FOAM CHAIR RAIL POP OUT

GEN. CONTRACTOR.

2 3. VERIFY ALL FINISHES WITH GEN. CONTRACTOR PRIOR TO APPLICATION

4. VERIFY ALL COLOR SELECTIONS WITH COLORED ELEVATIONS & OWNER PRIOR TO APPLICATION.

CORNERS ONLY

6. ROOFING SHALL BE INSTALLED IN ACCORDANCE W/MANUFACTURER'S SPECIFICATIONS.

7. PROVIDE SEALANT AT ALL STUCCO PENETRATIONS8. ALL CONTROL JOINTS & REVEALS TO TERMINATE ON INSIDE

9. HORIZONTAL GROUT LINES TO HAVE "V" CONTOUR

10. VERTICAL GROUT LINES TO BE FLUSH

11. ANTI-GRAFFITI COATING AT CMU WALLS/VENEER (@ BUILDINGS COATING TO EXTEND UP TO 2ND FINISH FLOOR)

12. ALL EXTERIOR MISC. METALS TO BE FILLED PAINTED, OR

COLOR S (STUCCO TEXTUR)	
LOCATION	COLOR/ FINISH
A STUCCO COLOR 1	COLOR: DUNN EDWARDS DE6213 - FINE GRAIN
B STUCCO COLOR 2	COLOR: DUNN EDWARDS DE6214 PIGEON GRAY
C STUCCO COLOR 3	COLOR: DUNN EDWARDS DE6378 JET
D STUCCO COLOR 4	COLOR: DUNN EDWARDS DE6376 LOOKING GLASS
E METAL FASCIA/ BALCONY FACE/ STEEL COLUMN	ANODIZED BRONZE
F HORIZONTAL METAL SIDING	COLOR TO MATCH: DUNN EDWARDS DE6376 LOOKING GLASS
G STANDING SEAM METAL ROOF	COLOR TO MATCH: DUNN EDWARDS DE6376 LOOKING GLASS
H CMU WALL/ VENEER	SANDBLASTED NATURAL GREY FINISH
J RAILINGS / STAIRS	DUNN EDWARDS DE6378 - JET
K WINDOW FRAMES/ METAL AWNINGS	ANODIZED BRONZE
L GLU-LAM BEAMS	CLEAR VARNISH

ADDRESSING

Approved Building Addressing must comply with City of Mesa Fire Detail FPD 505.1.

Approved street addressed, including building/suite numbers, shall be placed on all new and existing buildings in such a position as to be plainly visible and legible from the street or road fronting the property. Said numbers shall contrast with their background.

No street address or building number shall be posted under a gable or obstructed by any feature or follage.

Address numbers should be no lower than the first story or on a sign at each entrance facing the designated property address.

Numbers shall be a minimum 12" high with a 2" stroke and contrast the facility colors.



NO	DATE	DESCRIPTION
7	THE PRE	MIERE AT EASTMARK 2.0
	JEN	ININGS HOLDINGS L.L.C.
	5029 S.	ELLSWORTH RD. MESA, AZ
		ARCHISTRUCT LLC
TEL: (ERLY MESA, AZ 85201 WW.ARCHISTRUCTDB.COM
	FROM ANY UNAUTH	AND ENGINEER EXPRESSLY DISCLAIM ANY RESPONSIBILITY IORIZED USE OF THESE PLANS, DRAWINGS, AND NOTES. AN' UTHORIZATION MUST BE IN WRITING.
	RIGINALLY DRAWN.	AY HAVE BEEN REPRODUCED AT A SIZE DIFFERENT THAN THE OWNER, ARCHITECT, AND ENGINEER ASSUME NO IBILITY FOR THE USE OF INCORRECT SCALE.

AHJ STAMP

CITY PROJECT NUMBER:

Building Type 5
Front and Left-side
Exterior Elevations

PROJECT NO: DRAWING NUMBER: A3.5.5

NOTE: LOWER SIDE OF RACKS TO FACE ADJACENT SIDEWALK OR AWAY FROM ADJACENT WALLS

2" SQ. RUSTED STEEL TUBE.
SEAL PER OWNERS DIRECTIONS.
MOUNT TO CONCRETE SLAB
PER SHOP DRAWINGS ———

BICYCLE RACK

ELEVATION


1/2"=1'



Construction

1/2"=1'

anderson

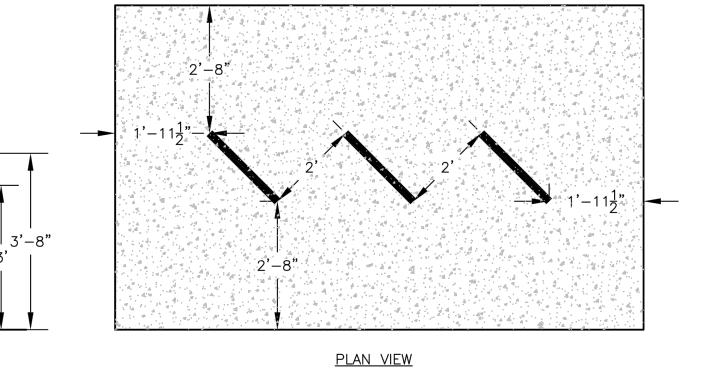

1/2"=1'

1/2"=1' drawn by checked by

jd, la, jc, sb 217-002-19 project number sheet number

08.23.2021

issued for

bid package 🔘 construction (

L6.1

