
**Drawing Number** 


TOP <u>OF FRAMING</u> (1980.33') 18'-4" 9.04 -FINISHED FLOOR ELEVATION (1962') 0'-0"
POOL DECK ELEVATION (1960.5') -1'-6" 5.05 -4.02 — FINISHED FLOOR ELEVATION (1959') -3'-0" T.O<u>.W.</u> = <u>55.3</u>3' BOULDERS FROM SIDE BY LANDSCAPE CONTRACTOR

## **SOUTH ELEVATION**

SCALE: 3/16" = 1'-0"

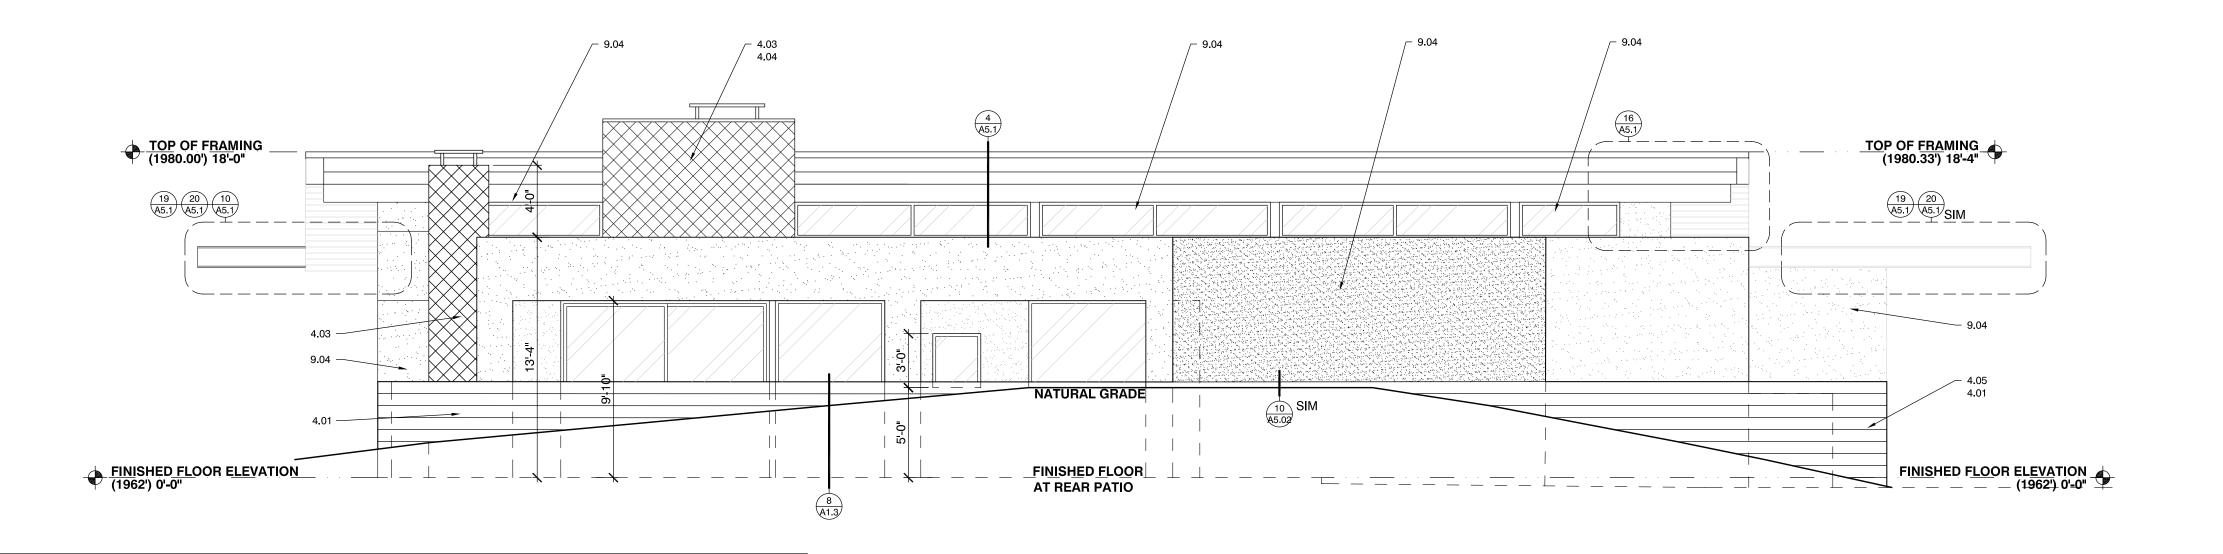

NORTH ELEVATION SCALE: 3/16" = 1'-0"

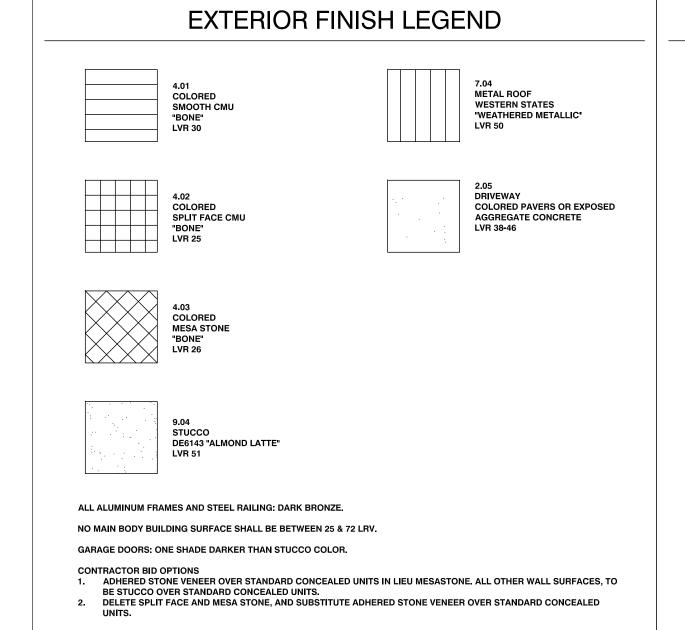

REFER TO SPECIFICATIONS FOR DESCRIPTION OF MATERIALS REFER TO ENGINEERING DRAWINGS FOR COMPONENTS AND EQUIPMENT LISTED IN KEYNOTES ALL NOTES NOT NECESSARILY USED ON EACH SHEET

GENERAL

1.01 LINE OF ROOF OVERHANG ABOVE 1.02 LINE OF ROOF GUTTER

1.04 FINISH GRADE 1.05 LINE OF FOOTING BELOW

1.06 LINE EXISTING GRADE 1.07 LINE OF CEILING TRANSITION ABOVE

1.08 LINE OF WALL BEYOND

1.09 OUTLINE OF HOUSE BELOW 1.10 EDGE OF ROOF 1.11 RIDGE LINE

1.03 LINE OF BEAM ABOVE

1.12 LINE OF FOOTING BELOW 1.13 LINE OF CHANGE IN CEILING HEIGHT
1.14 LINE OF FLOOR TRANSITION

SITEWORK
2.01 RE-GRADE SITE TO NEW GRADES, SEE CIVIL

2.02 EXISTING CONTOUR LINES 2.03 STEEL POOL FENCE AND GATES. WALL TO MAINTAIN 5' POOL

SAFETY BARRIER 2.04 NOT USED. 2.05 CONCRETE PAVERS OR COLORED EXPOSED AGGREGATE

CONCRETE. 2.06 LARGE BOULDERS FOR RETAINING ALONG STEEP SLOPES.

3.01 CONCRETE FLATWORK, SANDBLASTED OR ACID ETCHED.

3.02 4" CONCRETE SLAB ON 4" ABC 3.03 CONCRETE FOOTING, SEE FOUNDATION PLAN 3.04 PRECAST CONCRETE WINDOW SILL. 3.05 FRONT POOL RETAINING WALL - COLORED CONCRETE.

3.06 NOT USED. 3.07 CONCRETE STEPS ON 4" ABC 3.08 NOT USED.

3.09 CONCRETE HEARTH 3.10 NOT USED. 3.11 RECESSED CONCRETE FLOOR WITH EPOXY FINISH AT GARAGE, SLOPE TO EXTERIOR

3.12 CONCRETE TURN DOWN AT SLAB EDGE

MASONRY 4.01 SMOOTH FACE CMU. 4.02 SPLIT FACE CMU. 4.03 MESASTONE.

4.04 CMU CHIMNEY TO BE NOT MORE THAN 4' ABOVE AND NOT LESS THAN 2' ABOVE ANY ROOF WITHIN 10'. 4.05 CMU SITE RETAINING WALL. 4.06 CAP BLACK. - INVERTED 'U' WITH REBAR AND GROUT.

METAL 5.01 STEEL COLUMN 5.02 STEEL BEAM

5.03 CUSTOM STEEL BEAM WITH DRAINAGE CHANNEL 5.04 STEEL HANDRAIL 5.05 STEEL RAILING 5.06 STEEL GATE AND FENCE

WIRE MESH SPARK ARRESTOR WOOD, PLASTICS, AND COMPOSITES
6.01 TYPICAL INTERIOR WOOD STUD WALL: 2x4 AT 24" ON CENTER

WITH 5/8" GYP BOARD ON EACH SIDE 6.02 2x6 STUD WALL BEHIND PLUMBING FIXTURES OR OTHER THICKENED WALL WITH 5/8" GYP BOARD AT INTERIOR SIDE 6.03 WOOD STUD WALL FURR-OUT OVER CMU EXTERIOR WALL: 2x4 AT 24" ON CENTER WITH 5/8" GYP BOARD AT

INTERIOR SIDE 6.04 2x6 AT 16" ON CENTER EXTERIOR WALL (WITH STUCCO FINISH WHERE NOTED)

6.05 WOOD TRUSSES 6.06 GLU-LAM BEAM 6.07 WOOD JOISTS 6.08 TJI JOISTS

6.09 WOOD POST 6.10 WOOD CEILING BOARDS 6.11 PLYWOOD SHEATHING.

THERMAL & MOISTURE PROTECTION
7.01 BELOW GRADE WATERPROOF MEMBRANE WITH PROTECTION BOARD

7.02 PERFORATED DRAINS FOR UNDERGROUND WALLS, SLOPE TO DAYLIGHT 7.03 WATERPROOF ROOF MEMBRANE

7.04 STANDING SEAM METAL ROOFING 7.05 METAL FASCIA, REVEAL AND DRIP EDGE, SEE DETAIL 7.06 COATED FOAM ROOFING 7.07 CONTINUOUS SPRAY-IN OPEN CELL ESR-3102 FOAM INSULATION IN ALL WALLS AND ROOF FOR R-VALUES

IN SPECIFICATIONS. 7.08 CRICKETS SLOPED TO DRAIN.

8.01 CUSTOM FRONT DOOR SEE DETAIL.

5.07 CHIMNEY CAP 1/4" THICK STEEL RAIN PROTECTION CAP AND 8.02 ALUMINUM WINDOW WALL 8.03 INTERIOR WOOD DOOR & FRAME 8.04 INTERIOR WOOD POCKET DOOR

**KEYNOTES** 

8.05 ALUMINUM FRAME AND GLASS DOOR 8.06 ALUMINUM FRAME SLIDING DOORS 8.07 FIXED INSULATED GLAZING IN ALUMINUM FRAME 8.08 FIBER GLASS DOOR.

8.09 ALUMINUM OPERABLE WINDOW. 8.10 FRAME INFILL WALL WITH BREAK METAL 8.11 SECTIONAL GARAGE DOOR

9.01 5/8" THICK GYPSUM WALL BOARD - TYPICAL THROUGHOUT INTERIOR (PAINT U.N.O.) 9.02 5/8" THICK DENS-GLASS GOLD BOARD AT STUCCO SOFFITS

AND WET ROOMS. 9.03 METAL BEAD BETWEEN DISSIMILAR MATERIALS - TYPICAL 9.04 STUCCO 9.05 STONE PATIO TILE.

AND CONTRACTOR

9.09 TILE (BATHS) 9.10 CARPET FLOORING OVER CONCRETE SLAB.

9.08 EXPOSED INTERIOR CONCRETE FLOOR.

9.06 TILE SHOWER - FLOORS, NICHES, FULL HEIGHT WALLS 9.07 RECESSED WALL NICHE FOR SOAP AND BOTTLES, LOCATION AND CONFIGURATION TO BE COORDINATED WITH OWNER

PLUMBING FIXTURES 22.01 GAS METER 22.02 GAS CONNECTION 22.03 GAS SHUT OFF VALVE 22.04 WATER HEATER - ELEVATED 18" ABOVE FLOOR

FIRE SPRINKLERS 21.01 FIRE RISER

22.05 TRENCH DRAIN AT ALL SHOWERS 22.06 INTERIOR PLUMBING FIXTURES AND TRIM UNDER ALLOWANCE 22.07 NOT USED.

SPECIALTIES
10.01 RECESSED ROLLER SHADE POCKET

12.01 WINDOW SHADES - PROVIDE POWER.

12.03 STONE OR QUARTZ COUNTERTOP

12.04 SOLID SURFACE COUNTERTOP

CONTRACTOR.

SPECIFICATIONS.

UNDER ALLOWANCE

10.02 1/2" THICK TEMPERED CLEAR GLASS SHOWER DOOR 10.03 1/2" THICK TEMPERED TRANSLUCENT GLASS SHOWER

12.02 CASEWORK, CABINETS, SHELVING AND ACCESSORIES

10.04 SAFE PROVIDED BY OWNER AND INSTALLED BY

10.05 ELECTRIC FLOOR HEATING IN MASTER BATH. SEE

22.08 WATER SOFTENING SYSTEM. 22.09 ROOF AND OVERFLOW DRAIN.


HEATING VENTILATION AND AIR CONDITIONING 23.01 MECHANICAL AIR HANDLER 23.02 MECHANICAL CONDENSER UNIT 23.03 MECHANICAL FLOOR MOUNTED AIR SUPPLY DIFFUSER 23.04 MECHANICAL WALL MOUNTED RETURN AIR DIFFUSER


ELECTRICAL
26.01 ELECTRICAL SERVICE ENTRANCE 26.02 ELECTRICAL SUB PANEL


Project Number

2018019

**Drawing Number** 

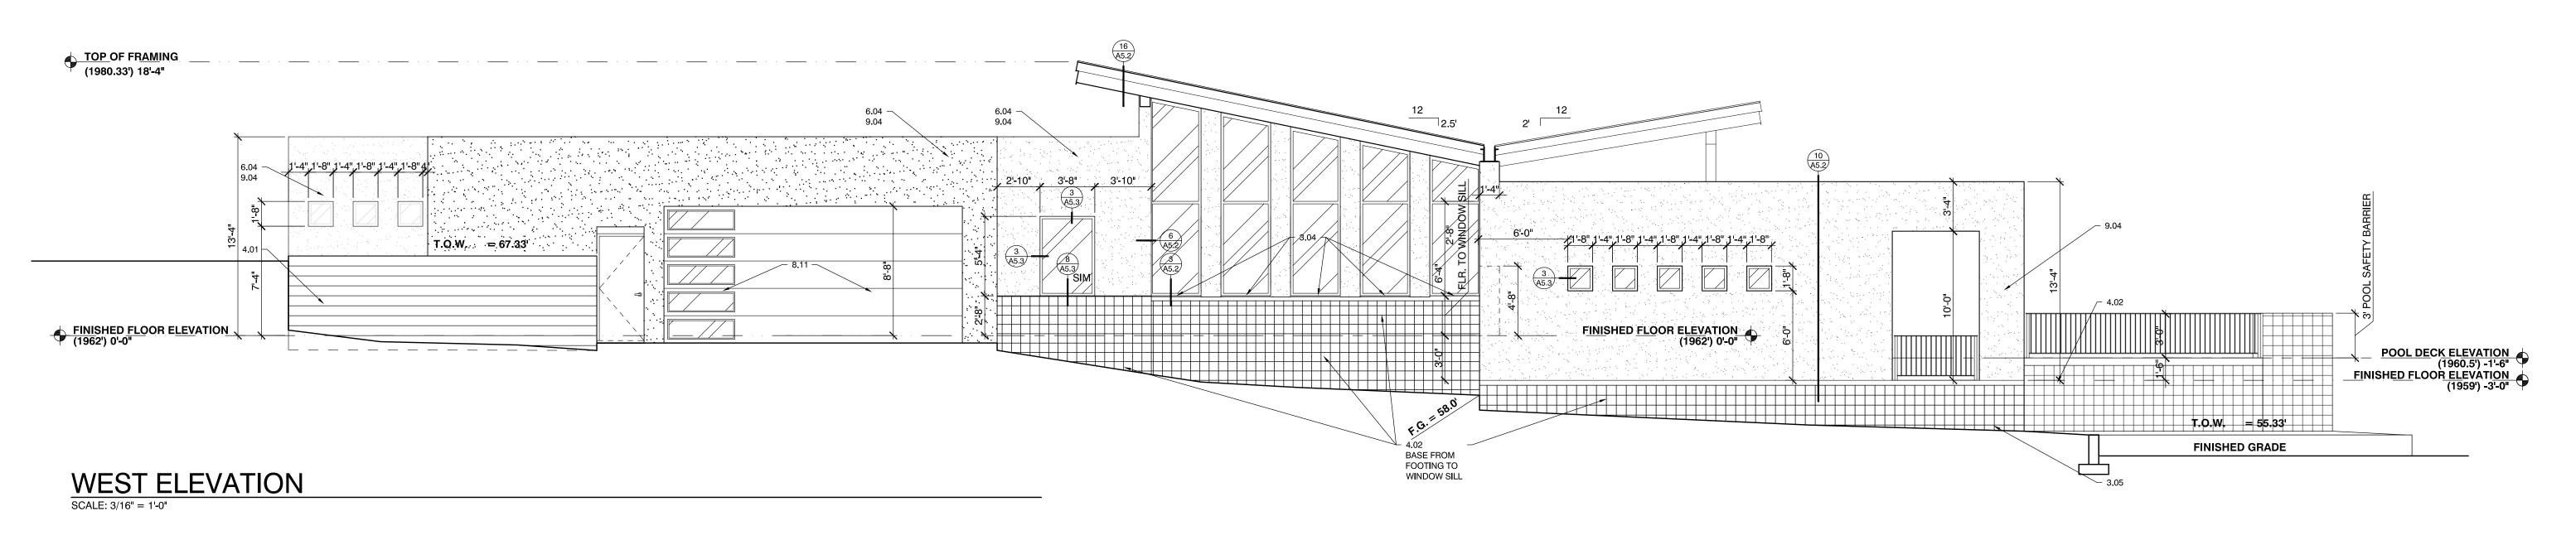

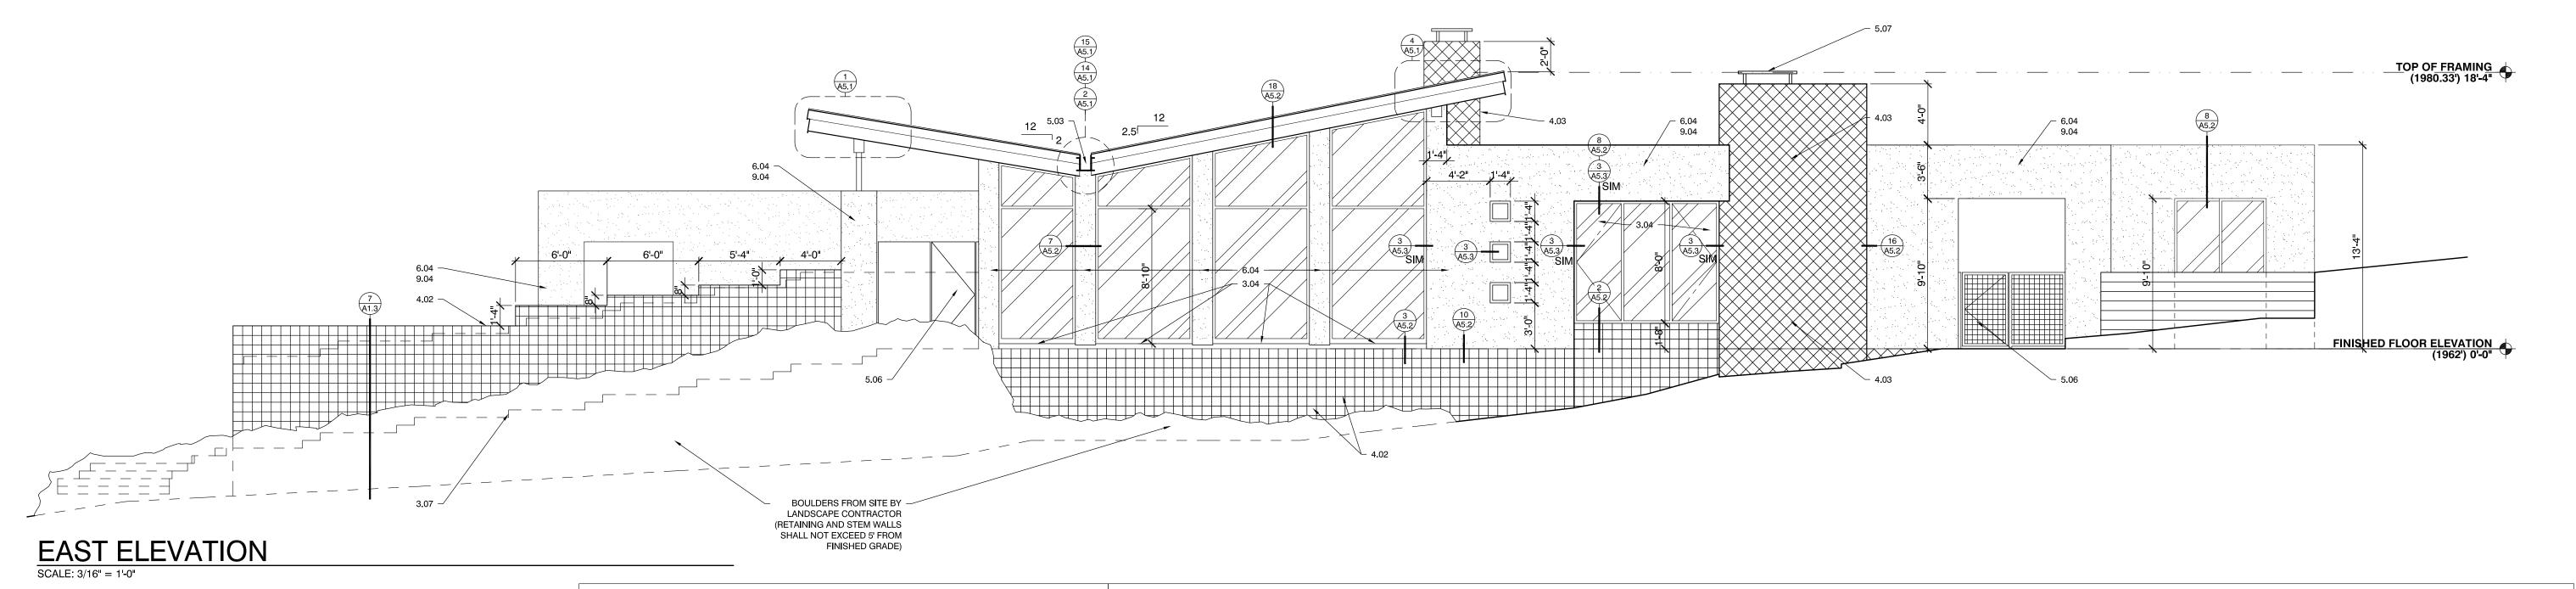

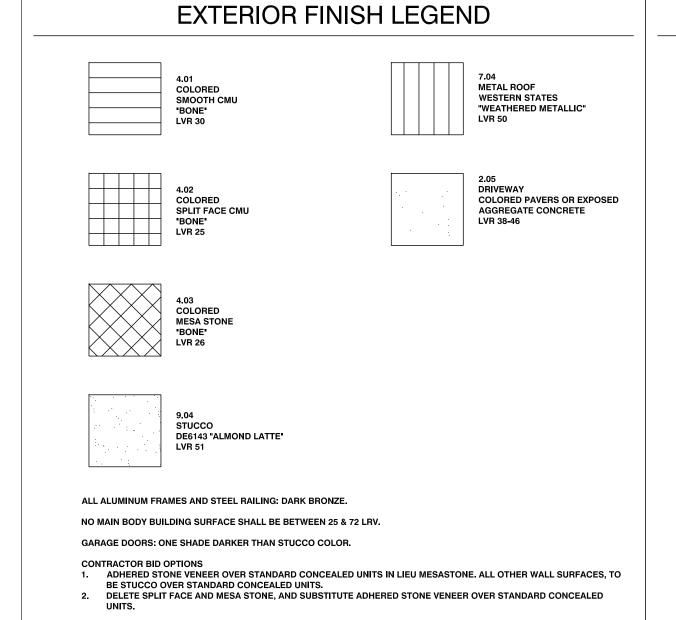

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2.01 RE-GRADE SITE TO NEW GRADES, SEE CIVIL 2.02 EXISTING CONTOUR LINES 2.03 STEEL POOL FENCE AND GATES. WALL TO MAINTAIN 5' POOL SAFETY BARRIER

2.04 NOT USED. 2.05 CONCRETE PAVERS OR COLORED EXPOSED AGGREGATE CONCRETE. 2.06 LARGE BOULDERS FOR RETAINING ALONG STEEP SLOPES.

3.01 CONCRETE FLATWORK, SANDBLASTED OR ACID ETCHED. 3.02 4" CONCRETE SLAB ON 4" ABC

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WALL: 2x4 AT 24" ON CENTER WITH 5/8" GYP BOARD AT INTERIOR SIDE 6.04 2x6 AT 16" ON CENTER EXTERIOR WALL (WITH STUCCO

FINISH WHERE NOTED) 6.05 WOOD TRUSSES 6.06 GLU-LAM BEAM

6.07 WOOD JOISTS 6.10 WOOD CEILING BOARDS 6.11 PLYWOOD SHEATHING.

> SPECIFICATIONS. 12.01 WINDOW SHADES - PROVIDE POWER. 12.02 CASEWORK, CABINETS, SHELVING AND ACCESSORIES

OPENINGS 8.01 CUSTOM FRONT DOOR SEE DETAIL.

**KEYNOTES** 

8.02 ALUMINUM WINDOW WALL
8.03 INTERIOR WOOD DOOR & FRAME 8.04 INTERIOR WOOD POCKET DOOR 8.05 ALUMINUM FRAME AND GLASS DOOR 8.06 ALUMINUM FRAME SLIDING DOORS 8.07 FIXED INSULATED GLAZING IN ALUMINUM FRAME

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26.01 ELECTRICAL SERVICE ENTRANCE 26.02 ELECTRICAL SUB PANEL

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