PROPERTY DESCRIPTION

THAT PORTION OF THE EAST HALF OF THE NORTHEAST QUARTER OF THE SOUTHEAST QUARTER OF SECTION 19, TOWNSHIP 1 NORTH, RANGE 5 EAST OF THE GILA AND SALT RIVER BASE AND MERIDIAN, MARICOPA COUNTY, ARIZONA, DESCRIBED AS FOLLOWS:

BEGINNING AT THE NORTHEAST CORNER OF THE SOUTHEAST QUARTER OF SAID SECTION 19;

THENCE SOUTH 00 DEGREES 42 MINUTES 04 SECONDS WEST, ALONG AN ASSUMED BEARING AND ALONG THE EAST LINE OF THE SOUTHEAST QUARTER OF SAID SECTION 19, A DISTANCE OF 1319.69 FEET TO THE SOUTHEAST CORNER OF THE NORTHEAST QUARTER OF THE SOUTHEAST QUARTER OF SAID SECTION 19;

THENCE SOUTH 89 DEGREES 54 MINUTES 52 SECONDS WEST, ALONG THE SOUTH LINE OF THE NORTHEAST QUARTER OF THE SOUTHEAST QUARTER OF SAID SECTION 19 DISTANCE OF 55.00 FEET TO A POINT ON THE WEST RIGHT-OF-WAY LINE OF DOBSON ROAD;

THENCE CONTINUING SOUTH 89 DEGREES 54 MINUTES 52 SECONDS WEST, ALONG THE SOUTH LINE OF THE NORTHEAST QUARTER OF THE SOUTHEAST QUARTER OF SAID SECTION 19, A DISTANCE OF 606.61 FEET TO THE SOUTHWEST CORNER OF THE EAST HALF OF THE NORTHEAST QUARTER OF THE SOUTHEAST QUARTER OF SAID SECTION

THENCE NORTH 00 DEGREES 45 MINUTES 33 SECONDS EAST, ALONG THE WEST LINE OF THE EAST HALF OF THE NORTHEAST QUARTER OF THE SOUTHEAST QUARTER OF SAID SECTION 19, A DISTANCE OF 240.00 FEET TO THE TRUE POINT OF BEGINNING OF THE HEREIN DESCRIBED PARCEL;

THENCE NORTH 89 DEGREES 54 MINUTES 31 SECONDS EAST, A DISTANCE OF 606.36 FEET TO A POINT ON THE WEST RIGHT-OF-WAY LINE OF DOBSON ROAD, SAID POINT LIES WESTERLY 55.00 FEET FROM THE EAST LINE OF THE SOUTHEAST QUARTER OF SAID SECTION 19;

THENCE NORTH 00 DEGREES 42 MINUTES 04 SECONDS EAST, PARALLEL TO AND 55.00 FEET WEST OF THE EAST LINE OF SOUTHEAST QUARTER OF SAID SECTION 19, A DISTANCE OF 171.80 FEET;

THENCE NORTH 89 DEGREES 24 MINUTES 08 SECONDS WEST, A DISTANCE OF 606.12 FEET;

THENCE SOUTH 00 DEGREES 45 MINUTES 33 SECONDS WEST, ALONG THE WEST LINE OF THE EAST HALF OF THE NORTHEAST QUARTER OF THE SOUTHEAST QUARTER OF SAID SECTION 19, A DISTANCE OF 179.02 FEET TO THE TRUE POINT OF BEGINNING

PROJECT DATA

APN 134-33-002H PROPERTY: OWNER OF RECORD: WJC, LLC PROJECT NAME: MEKONG 88 COMMERCIAL / RETAIL PROJECT ADDRESS: 66 S. DOBSON ROAD ZONING: PARCEL AREA: 108,357 SF (2.44 AC.) 1B, AUTOMATIC SPRINKLER PER IBC CONSTRUCTION TYPE:


FIRE ACCESS AND SITE NOTES

- 1. REQUIRED FIRE APPARATUS ACCESS ROAD DURING CONSTRUCTION OR DEMOLITION. THE ACCESS ROAD SHALL BE A MINIMUM OF 20 FEET WIDE AND SHALL BE AN ALL-WEATHER DRIVING SURFACE, GRADED TO DRAIN STANDING WATER AND ENGINEERED TO BEAR THE IMPOSED LOADS OF FIRE APPARATUS (74,000 LBS./24,000LBS PER AXLE) WHEN ROADS ARE WET. THE ACCESS ROAD SHALL BE EXTENDED TO WITHIN 200 FEET OF ANY COMBUSTIBLE MATERIALS AND/OR ANY LOCATION ON THE JOBSITE WHERE ANY PERSON(S) SHALL BE WORKING FOR A MINIMUM OF FOUR (4) CONTINUOUS HOURS IN ANY DAY. A CLEARLY VISIBLE SIGN MARKED "FIRE DEPARTMENT ACCESS", IN RED LETTERS, SHALL BE PROVIDED AT THE ENTRY TO THE ACCESS ROAD.
- 2. ALL OPEN TRENCHES SHALL HAVE STEEL PLATES CAPABLE OF MAINTAINING THE INTEGRITY OF THE ACCESS ROAD DESIGN WHEN THESE TRENCHES CROSS AN ACCESS ROAD. THESE ACCESS ROADS MAY BE TEMPORARY OR PERMANENT. THIS POLICY APPLIES ONLY DURING CONSTRUCTION AND/OR DEMOLITION. PERMANENT ACCESS PER THE MESA FIRE CODE SHALL BE IN PLACE PRIOR TO ANY FINAL INSPECTION OR CERTIFICATE OF
- 3. WATER SUPPLY FOR FIRE PROTECTION. AN APPROVED WATER SUPPLY FOR CONSTRUCTION SITE SHALL MEET THE REQUIREMENTS OF APPENDIX CHAPTERS B AND C. THE MINIMUM FIRE FLOW REQUIREMENT WHEN CONTRACTOR OR DEVELOPER BRINGS COMBUSTIBLE MATERIALS ON SITE IS 1,500 GPM AT 25 PSI. AT LEAST ONE FIRE HYDRANT SHALL BE WITHIN 500 FEET OF ANY COMBUSTIBLE MATERIAL AND CAPABLE OF DELIVERING THE MINIMUM FIRE FLOW REQUIREMENT. THIS HYDRANT OR HYDRANTS MAY BE EITHER TEMPORARY OR PERMANENT AS THE PROJECT SCHEDULE PERMITS. IN ADDITION, THERE ARE TIMES WHEN HYDRANTS AND VALVES MUST BE CLOSED TEMPORARILY FOR REPAIR WORK OR CONSTRUCTION OF THE WATER SYSTEM. THE DEVELOPER/CONTRACTOR IS RESPONSIBLE FOR ENSURING THAT THE WATER SUPPLY IS ALWAYS AVAILABLE. WHEN THE WORK IS COMPLETE, DEVELOPER/CONTRACTOR SHALL MAKE SURE THAT THE FIRE HYDRANTS ARE ACTIVE, AND THE VALVES ARE OPEN.
- 4. COMPLIANCE IS REQUIRED WITH ALL PROVISIONS AND REQUIREMENTS OF IBC CHAPTER 33, SAFEGUARDS DURING CONSTRUCTION, AND IFC CHAPTER 33 AND NFPA 241, FIRE SAFETY DURING CONSTRUCTION AND DEMOLITION.

PRELIMINARY GRADING, DRAINAGE, & UTILITY PLANS FOR

MEKONG 88

66 S. DOBSON ROAD MESA, ARIZONA

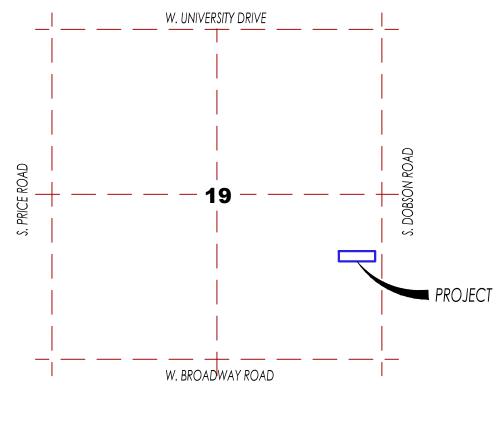

VICINITY MAP

NOT TO SCALE

OWNER / APPLICANT

66 S. DOBSON ROAD #132 MESA, AZ 85202

ARCHITECT

3RD STORY 16074 N. 78TH ST. D204 SCOTTSDALE, AZ 85260 PH: 480.607.3337 CONTACT: RICK DAUGHERTY, RA EMAIL: RICK@3RDSTORY.COM

ENGINEER

KBELL ENGINEERING LLC 1355 N 86TH PLACE MESA, AZ 85207 PH: 602.980.8246 CONTACT: KELLY BELL, P.E. EMAIL: KBELL@KBELLENG.COM

PROJECT DESCRIPTION

PROPOSED COMMERCIAL/RETAIL DEVELOPMENT ON 2.2 CURRENTLY UNDEVELOPED ACRES WITH UNDERGROUND RETENTION, BLEEDOFF LINE, PARKING, PROPOSED CROSS ACCESS & UTILITIES.

SHEET INDEX

C-1 COVER SHEET C-2 PRELIMINARY GRADING AND DRAINAGE PLAN C-3 CROSS SECTIONS C-4 PRELIMINARY UTILITY PLAN

BASIS OF BEARING

GRID NORTH, AZSPC, CENTRAL, NAD83(92)

PROJECT BENCHMARK

POINT NAME: NAVD88 ELEV: 1,204.603

DESCRIPTION: 3" MCHD BC IN HH 0.8' DN NO STAMPING. INTERSECTION OF W. BROADWAY RD & S. ROOSEVELT RD. PROVIDED BY:

SITE BENCHMARK

POINT NAME: 102 NAVD88 ELEV: 1155.30

DESCRIPTION: FOUND BRASS CAP FLUSH AT THE INTERSECTION OF 195TH DRIVE AND INDIANOLA COURT

FLOOD INSURANCE RATE MAP (FIRM) DATA

SUBJECT PROPERTY LIES IN FLOOD ZONE "X". FLOOD INSURANCE RATE MAP (FIRM) COMMUNITY NUMBER 040048, PANEL NO 2145, EFFECTIVE DATE OCTOBER 16, 2013. ZONE X IS DESCRIBED AS "AREAS OF 0.2% ANNUAL CHANCE FLOOD; AREAS OF 1% ANNUAL CHANCE FLOOD WITH AVERAGE DEPTHS OF LESS THAN 1 FOOT OR WITH DRAINAGE AREAS LESS THAN 1 SQUARE MILE; AND AREAS PROTECTED BY LEVEES FROM 1% ANNUAL CHANCE FLOOD".

SHEET INDEX

COVER SHEET

C-2 PRELIMINARY GRADING AND DRAINAGE PLAN

C-3 SITE SECTIONS AND DETAILS C-4 PRELIMINARY UTILITY PLAN


LEGEND **ABBREVIATIONS** SOUTH BOLLARD METER EAST VALVE WEST

MANHOLE ASSESSORS PARCEL NUMBER WATER LINE EXISTING HYD SEWER LINE HYDRANT BOUNDARY LINE PROPOSED PROP CENTER LINE PHASE ACCESSIBLE ROUTE


ARCHITECTURE INTERIOR DESIGN LAND PLANNING

16074 N. 78th St, Scottsdale AZ 85260 480.607.3337 connect@3rdstory.com

KBELL

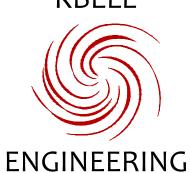

1355 N 86TH PLACE MESA, ARIZONA 85207 PH: 602.980.8246 Copyright © 2020

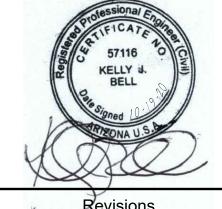

Revisions

description

Project Name: MEKONG 88

88 S. DOBSON RD. MESA, AZ 85202

Date: 10/19/2020 Scale: N/A


Drn: JB

Chk: KB

Sheet Name: **COVER**

SHEET

Sheet No.

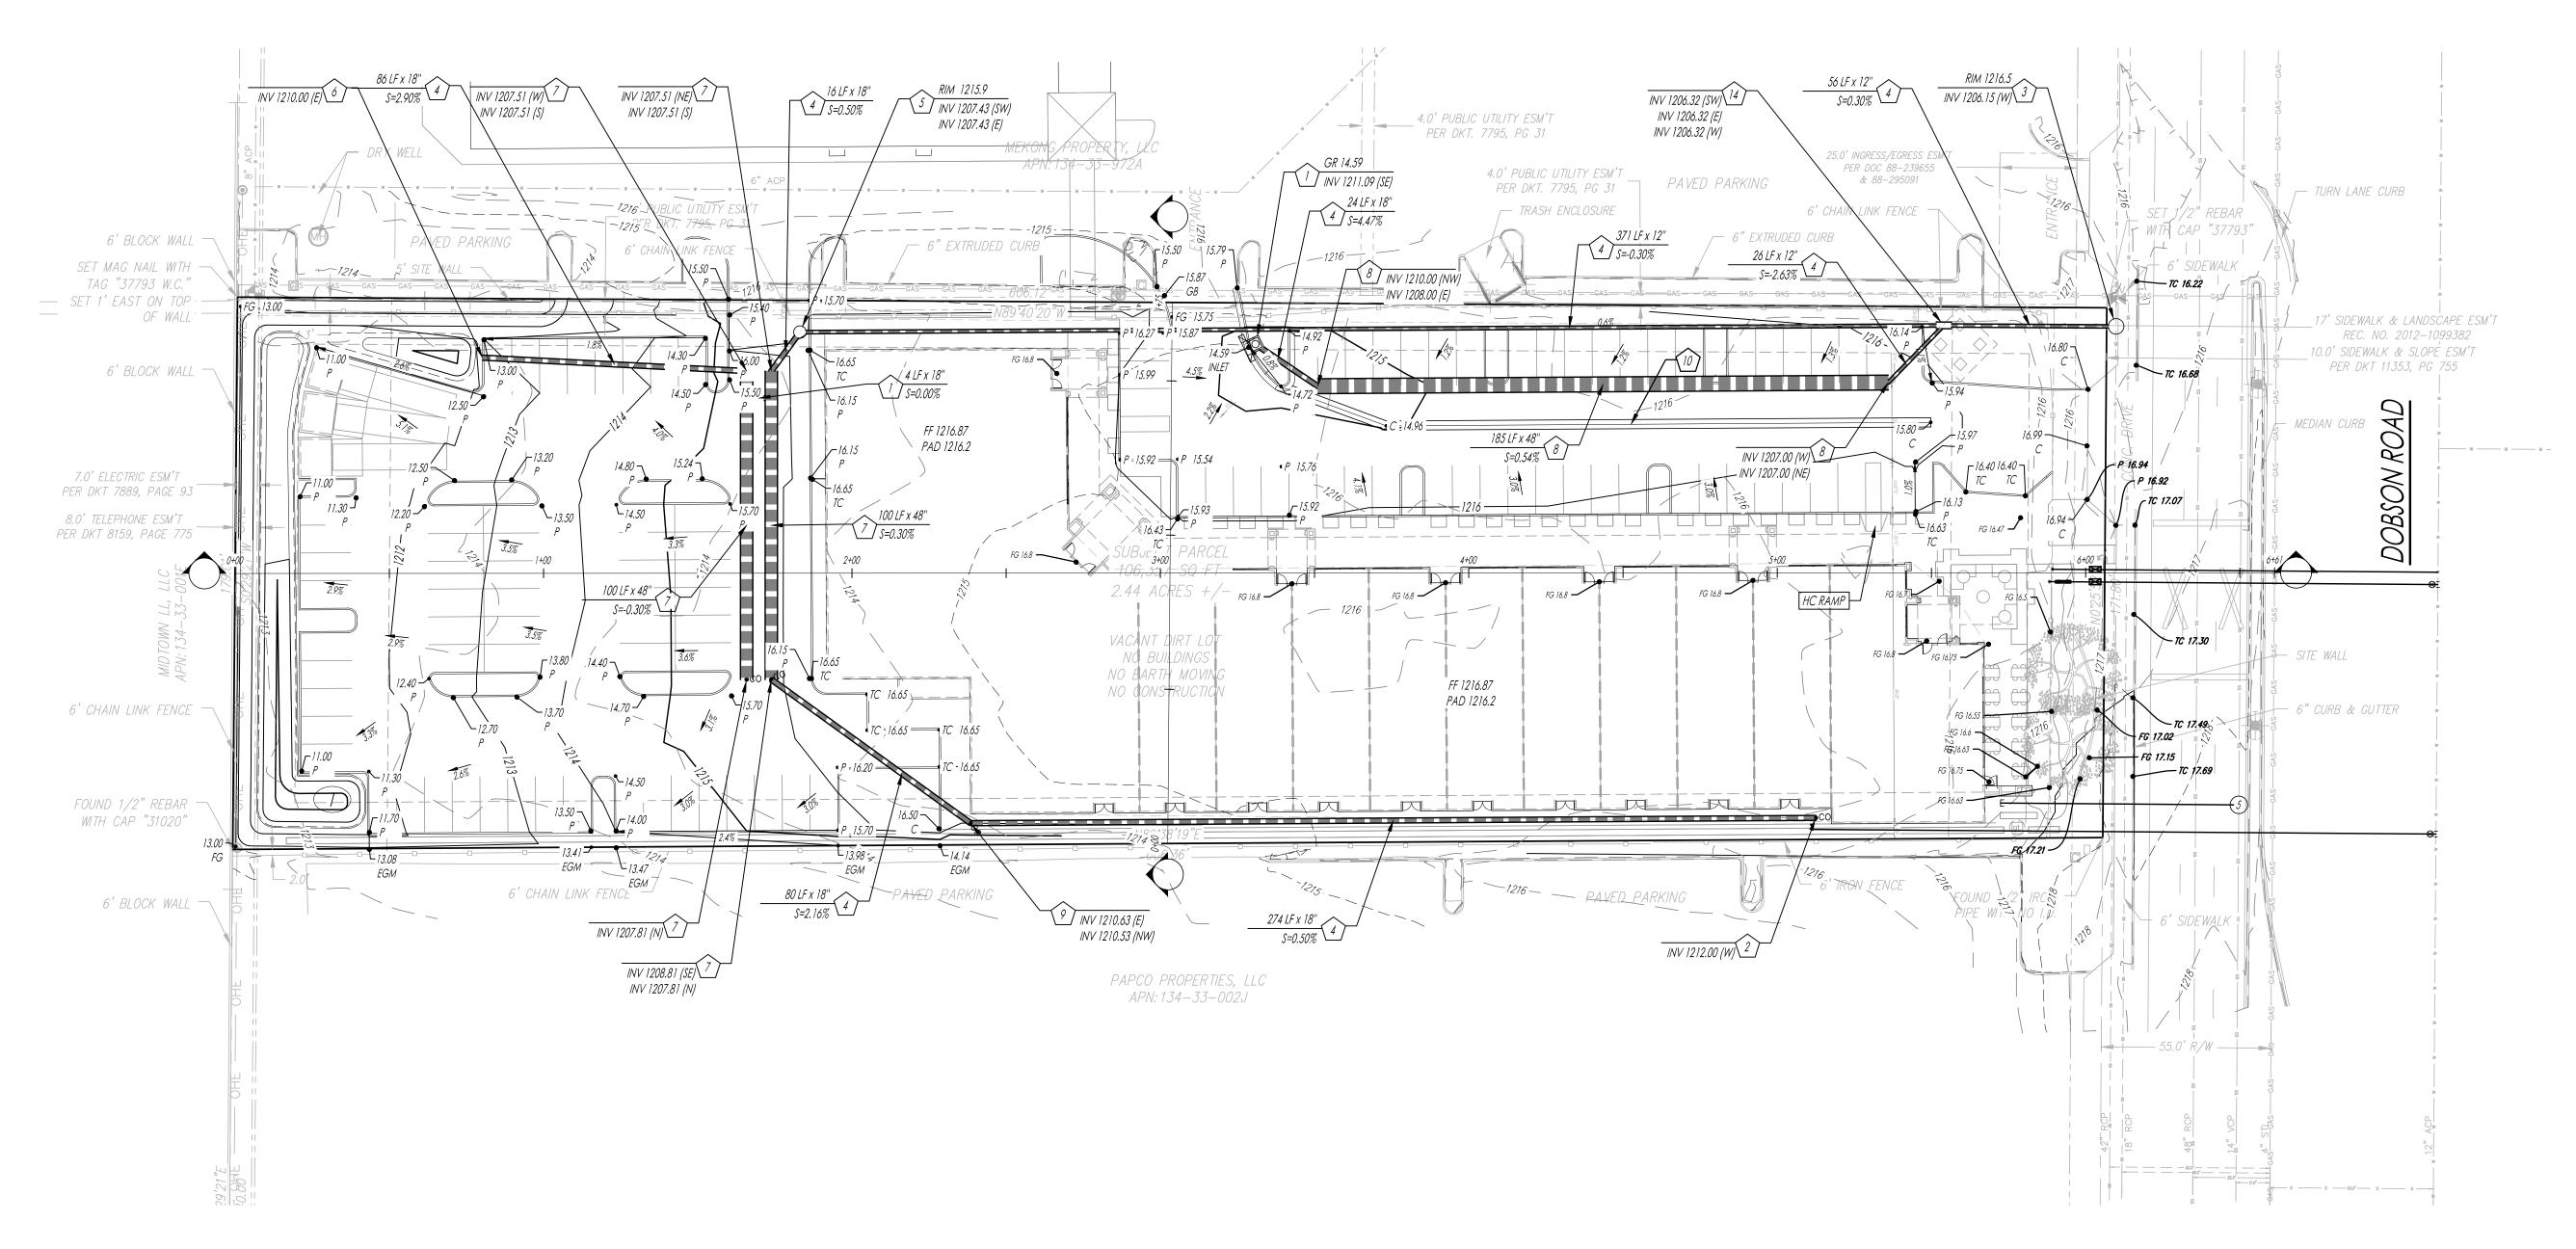

LEG	<u>END</u>	ABBREVIATIONS		
	PROP SURFACE FLOW DIRECTION	С	CONCRETE	
-\	EX SURFACE FLOW DIRECTION	FFE	FINISHED FLOOR ELEVATION	
	PIPE FLOW DIRECTION	FG	FINISH GRADE	
	CATCH BASIN	G	GUTTER	
	DRY WELL	GR	GRATE	
(SD)	STORM DRAIN MANHOLE	(N)	NORTH	
	STORM DRAIN PIPE	(S)	SOUTH	
	SECTION LINE	(E)	EAST	
	BOUNDARY LINE	(W)	WEST	
	CENTER LINE	AC	ACRES	
	EXISTING CONTOURS	CFS	CUBIC FEET PER SECOND	
	PROPOSED CONTOURS	DA	DRAINAGE AREA	
		EX	EXISTING	
	BUILDING AREA	PROP	PROPOSED	
	ASPHALT PAVEMENT	Q ₁₀	10 YEAR FLOW	
		Q ₂₅	25 YEAR FLOW	
	CONCRETE	Q ₁₀₀	100 YEAR FLOW	
		SD	STORM DRAIN	
	RIPRAP	Tc	TIME OF CONCENTRATION	
		TD	TRENCH DRAIN	

REQUIRED VOLUME CALCULATION:

 $V(r) = C^*D/12^*A$

WHERE:

V(r) = REQUIRED VOLUME (CF)

C = C VALUE FOR THE SITE = USE 0.95

A = AREA (SF)

P = TWO HOUR RAINFALL VALUE FOR EVENT OF INTEREST (INCHES) = 2.2 IN

PER SECTION 806.4 OF THE MESA EDS

V(r) = 0.95*2.2/12*106,286= 18,511 CF

V(p) = 18,559 CF (3390 SURFACE, 385 LF x 4' CMP & RCP)

NOTES:

1. THERE ARE NO WATER PRODUCTION WELLS, UNDERGROUND STORAGE TANKS OR FUEL DISPENSING AREAS WITHIN 100 FEET OF THE PROPOSED DRY WELL.

2. THERE ARE NO HAZARDOUS OR TOXIC SUBSTANCES TO BE HANDLED ON SITE

3. THE DRYWELLS ARE NOT LOCATED WITHIN A LOADING DOCK.


4.THE VOLUME OF STORM WATER TO BE DRAINED VIA DRYWELLS SHALL NOT EXCEED A

MAXIMUM OF 9,300 CF PER DRYWELL.

5. HEADWALLS MUST HAVE SAFETY RAILINGS PER MESA STANDARD DETAIL M-65. TRASH RACKS ARE REQUIRED AT HEADWALLS FOR LINES LARGER THAN 8" IN DIAMETER.

PRELIMINARY GRADING AND STORM DRAIN KEYNOTES

- INSTALL CATCH BASIN TYPE C PER MAG STD DTL 532.
- CONNECT TO ROOF LEADER PLUMBING.
- LOCATE AND CONNECT TO EX CITY OF MESA STORM DRAIN. INSTALL MANHOLE PER
- MAG STD DTL 520 & 522. INSTALL NEW HDPE ONSITE STORM DRAIN PIPE.
- INSTALL 4' STORM DRAIN MANHOLE PER MAG STD DTL 520 & 522. INSTALL PIPE THROUGH WALL WITH PEST BARRIER SCREEN.
- INSTALL 4' ID CMP STORAGE PIPE.
- INSTALL 4' ID RCP (CL IV) STORAGE PIPE.
- INSTALL CLEANOUT PER MAG STD DTL 441.
- 10. INSTALL BLEEDOFF VALVE AT CONNECTION TO CITY OF MESA STORM DRAIN. VALVE TO
- BE NORMALLY CLOSED.
- 11. INSTALL RETENTION BASIN AS SHOWN, MAX SIDE SLOPE 4:1. 12. INSTALL BAMBOO FENCE, MATCH EG AT PROPERTY LINE. SEE ARCH SITE PLAN FOR
- DETAILS.
- 13. INSTALL 3' CONCRETE VALLEY GUTTER. 14. INSTALL WYE CONNECTION.

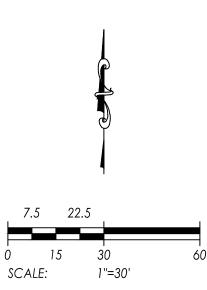

ARCHITECTURE

INTERIOR DESIGN LAND PLANNING

480.607.3337 connect@3rdstory.com

16074 N. 78th St, Scottsdale AZ 85260





Project Name:

MEKONG 88

88 S. DOBSON RD. MESA, AZ 85202

Date: 10/19/2020


Drn: JB

Scale: 1"=30'

Chk: KB Sheet Name:

PRELIMINARY **GRADING AND** DRAINAGE PLAN


Sheet No.

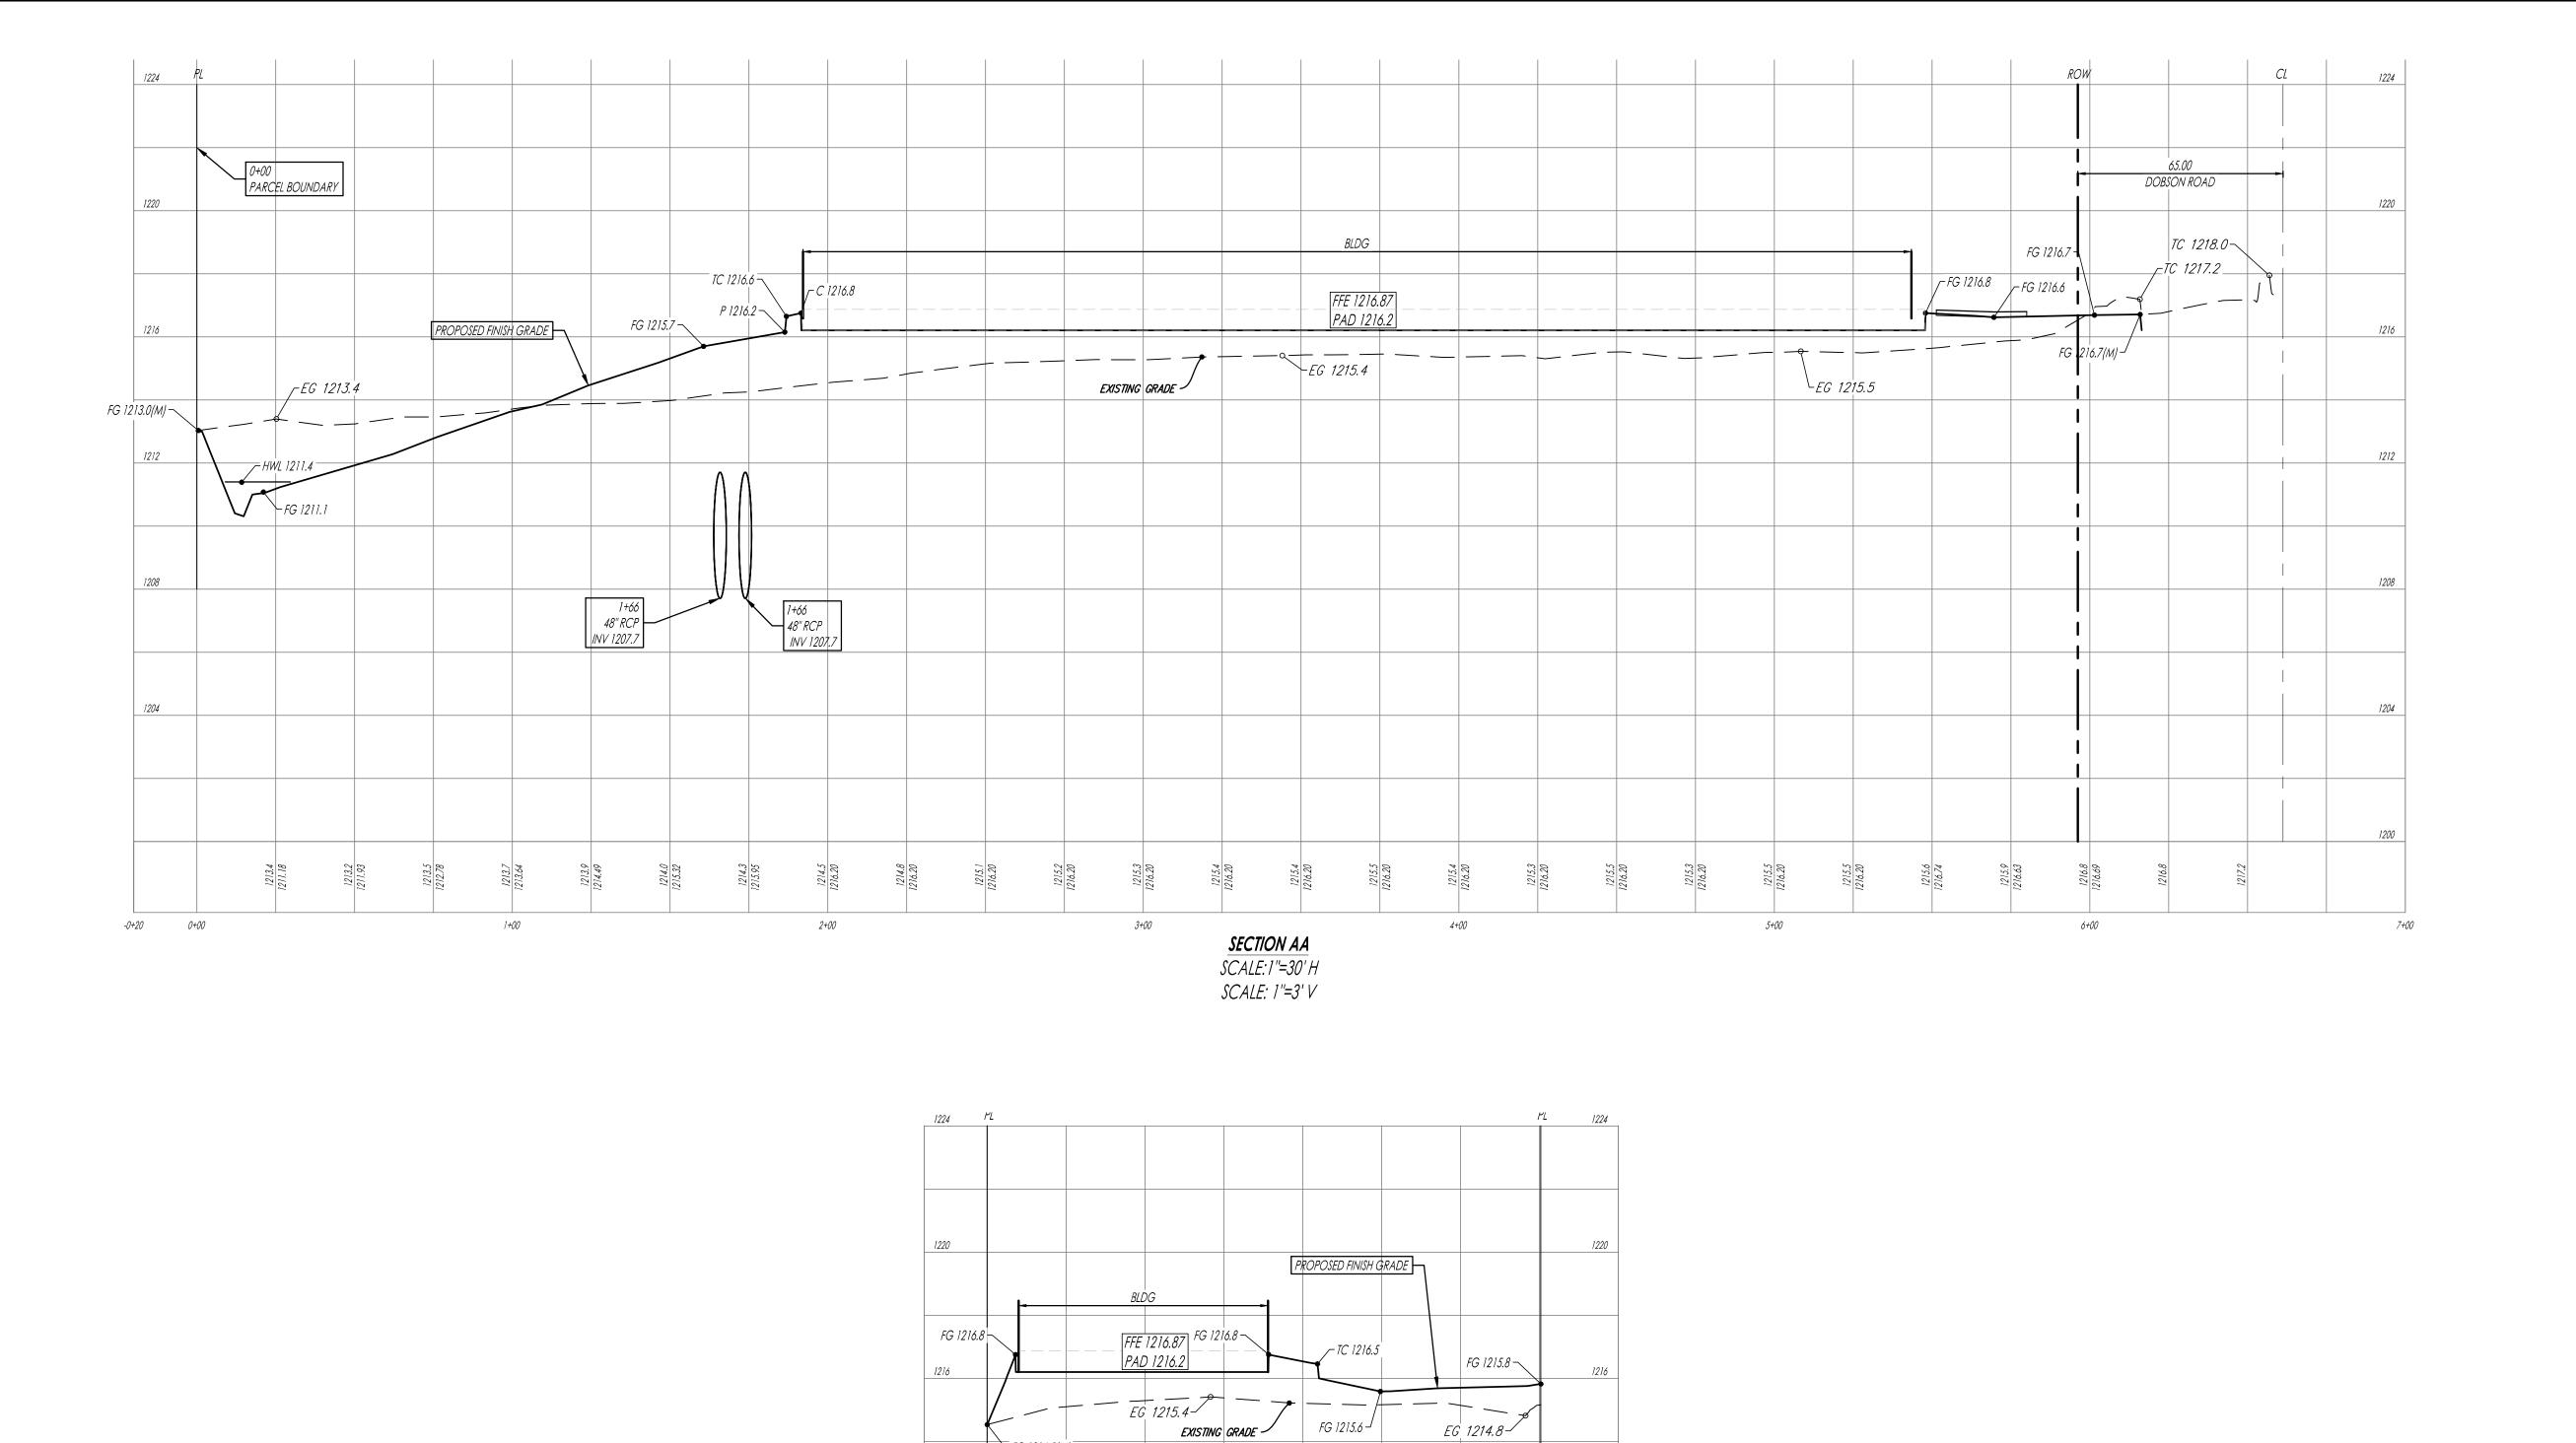

SECTION BB SCALE: 1"=30" H SCALE: 1"=3" V

FG 1214.5(M)

-0+20 0+00

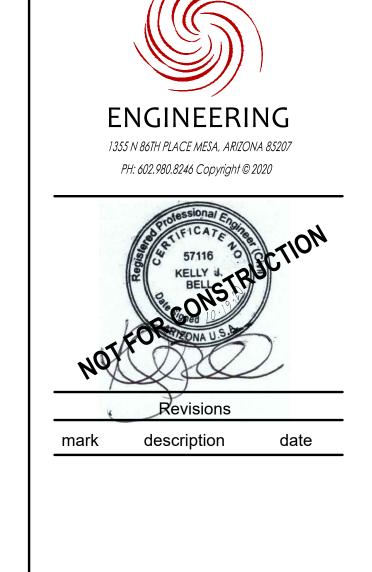

ARCHITECTURE

INTERIOR DESIGN

LAND PLANNING

16074 N. 78th St, Scottsdale AZ 85260 480.607.3337 connect@3rdstory.com

Project Name: MEKONG 88

88 S. DOBSON RD. MESA, AZ 85202

Date: 10/19/2020 Scale: 1"=30' H & 1"=3'V

Drn: JB


Chk: KB

Sheet Name:

CROSS

SECTIONS

등 Sheet No.

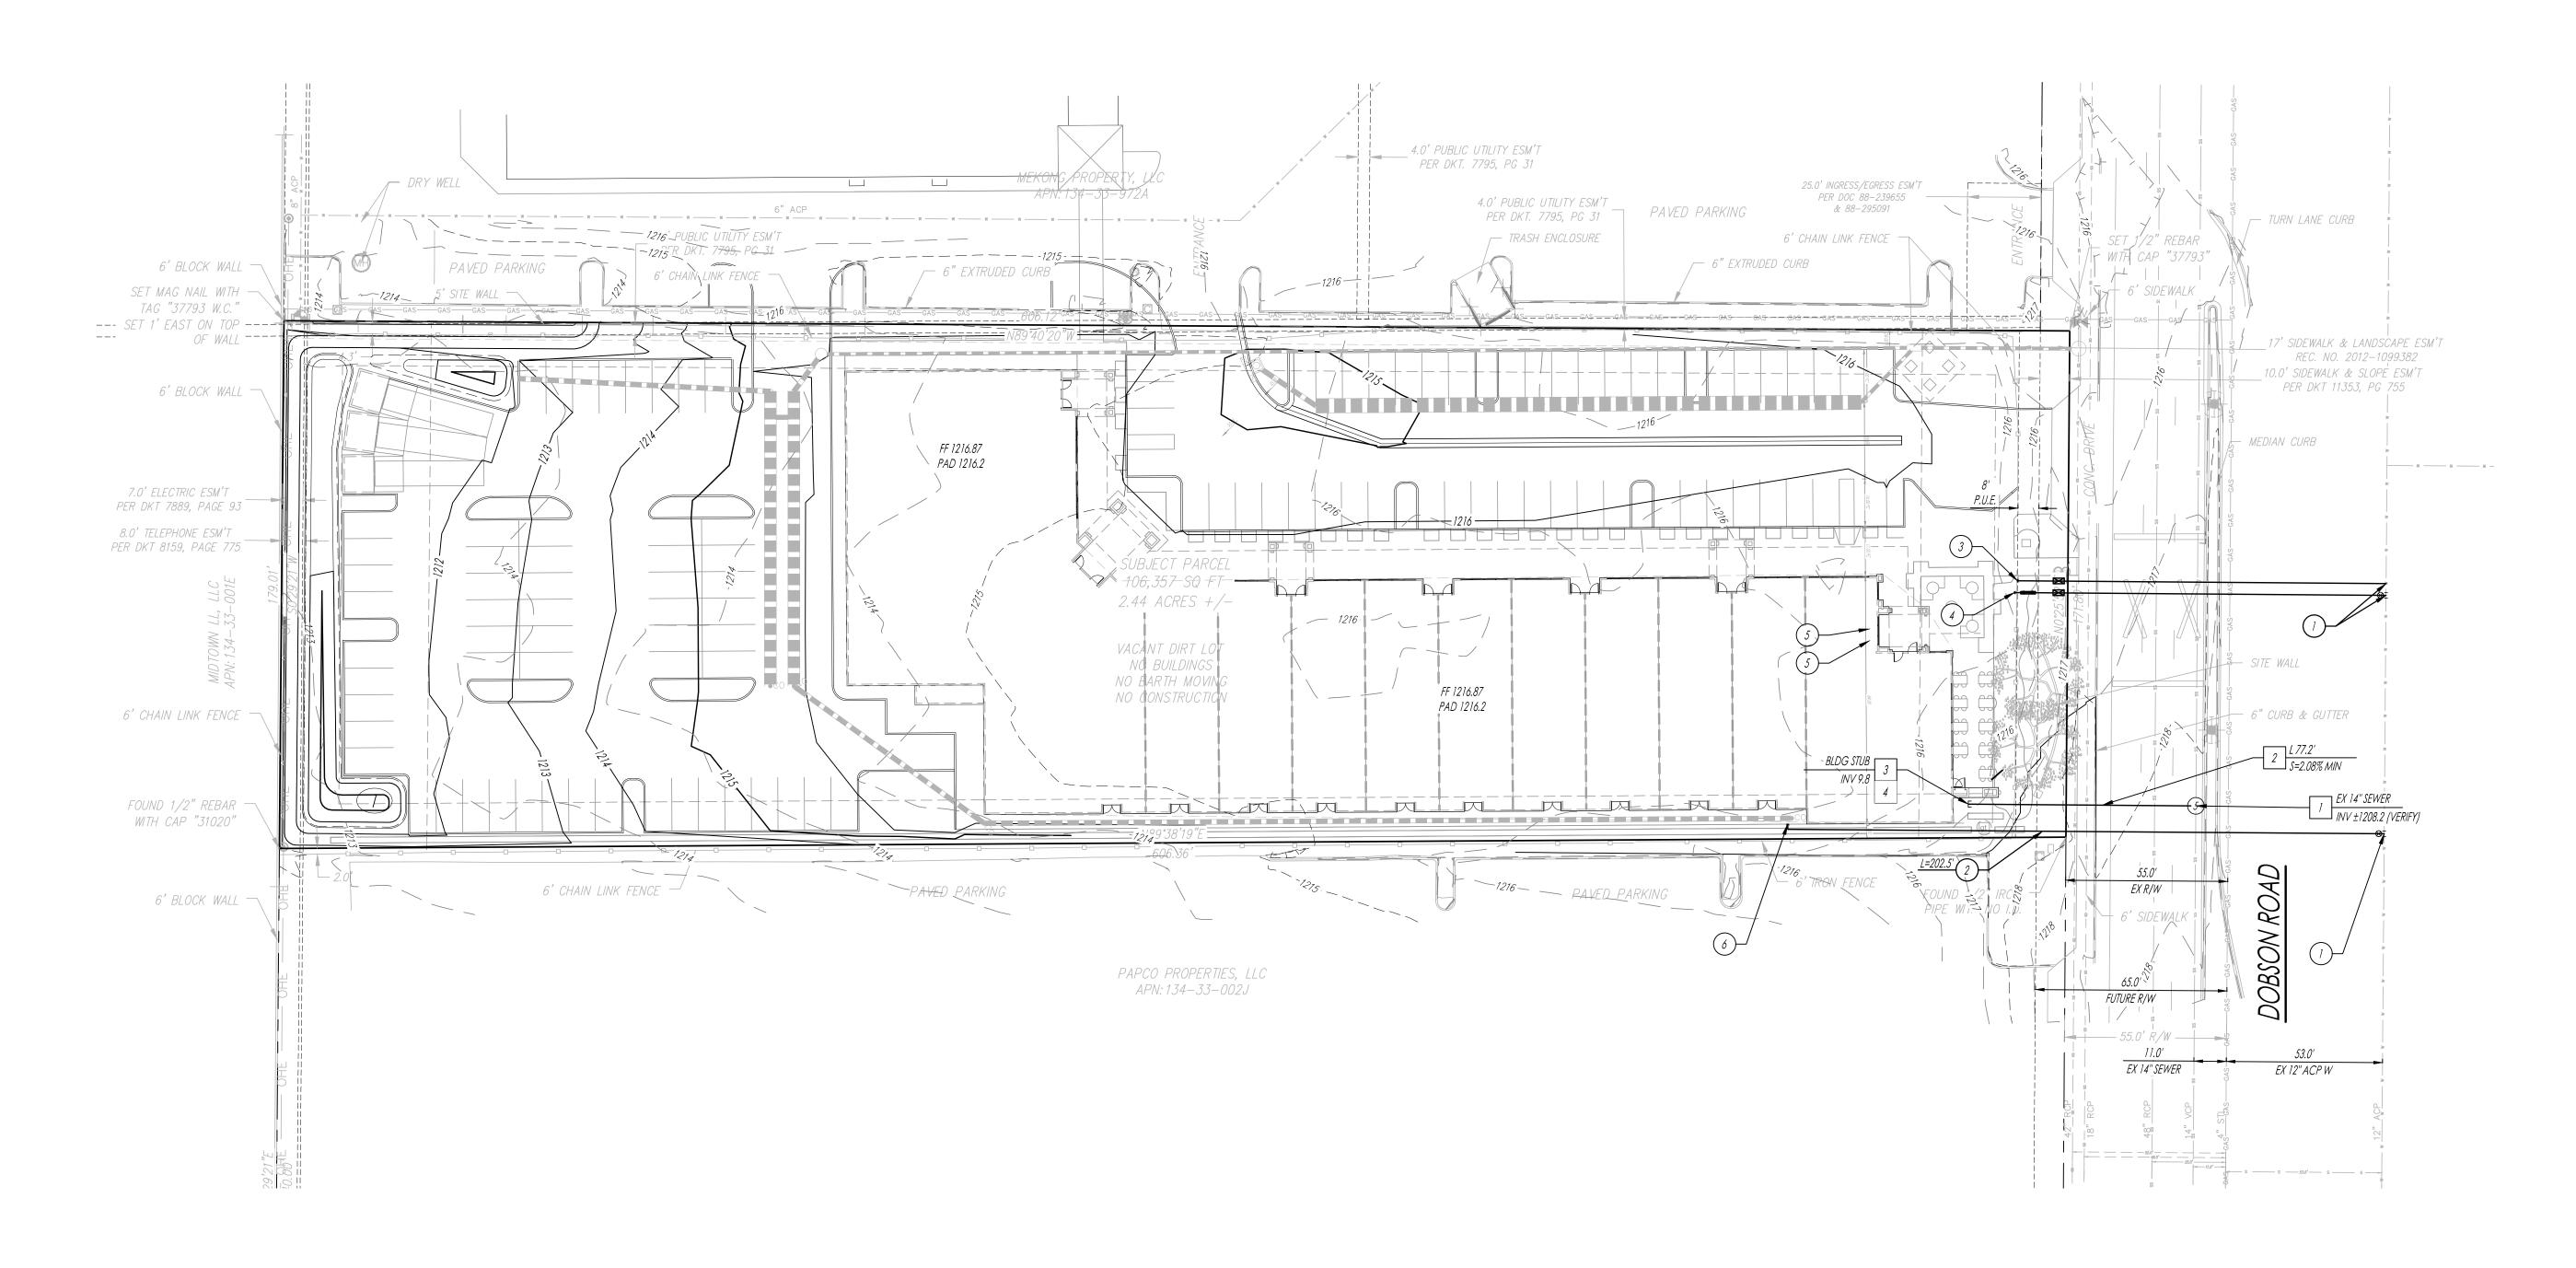


LEGEND		ABBREVIATIONS					
\bigcirc	SEWER MANHOLE	МН	MANHOLE	(E)	EAST		
•	HYDRANT	FFE	FINISHED FLOOR ELEVATION	(W)	WEST		
\otimes	WATER VALVE	FG	FINISH GRADE	EX	EXISTING		
	– WATER LINE	G	GUTTER	PROP	PROPOSED		
	- BOUNDARY LINE	GR	GRATE	SD	STORM DRAIN		
	- CENTER LINE	(N)	NORTH	TD	TRENCH DRAIN		
====	EXISTING CONTOURS	<i>(S)</i>	SOUTH	W	WATER		
	PROPOSED CONTOURS						

PRELIMINARY UTILITY PLAN WATER KEYNOTES

- NNECTTO EV 12" W
- CONNECT TO EX 12" W. INSTALL NEW FIRE LINE SUPPLY AND BACKFLOW PREVENTOR
- INSTALL NEW SERVICE AND METER
 INSTALL NEW LANDSCAPE SERVICE AND METER
 CONNECT TO BUILDING PUMBING
- 5. CONNECT TO BUILDING PLUMBING6. CONNECT TO BUILDING FIRE LINE PLUMBING

PRELIMINARY UTILITY PLAN SEWER KEYNOTES

CONNECT TO 14" SEWER.
 INSTALL NEW 6" SEWER
 INSTALL NEW CLEANOUT
 CONNECT TO BUILDING PLUMBING

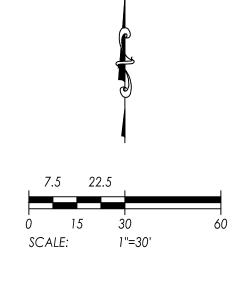



ARCHITECTURE INTERIOR DESIGN LAND PLANNING

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mark description

Project Name: MEKONG 88

88 S. DOBSON RD. MESA, AZ 85202

Date: 10/19/2020

Scale: 1"=30'

Drn: JB Chk: KB

Sheet Name:

PRELIMINARY UTILITY PLAN

e PLLC dba 3rd st Sylvania (on the standard standard)

o. **C-**