



4600
EAST INDIAN SCHOOL RD
PHOENIX, ARIZONA 85018
602-840-2929 P
602-840-6646 F

GATEWAY COMMERCE CENTER
7132 E. SEAVIER AVE
MESA, AZ 85212


1ST ISSUED:
Revisions

PROJECT NO:
DRAWN BY: CDS
CHK'D BY: MRH
COPYRIGHT 2020: DEUTSCH
ARCHITECTURE GROUP

PHOTOMETRICS
SITE
PLAN

PH1.0


ALL CONCEPTS, DESIGNS, AND DATA INDICATED ON THESE DOCUMENTS ARE THE SOLE PROPERTY OF THE PETERSON ASSOC. ENGINEERS, INC. AND SHALL NOT BE USED FOR ANY OTHER PURPOSE THAN ORIGINALLY INTENDED WITHOUT THE WRITTEN PERMISSION OF THE ENGINEER.

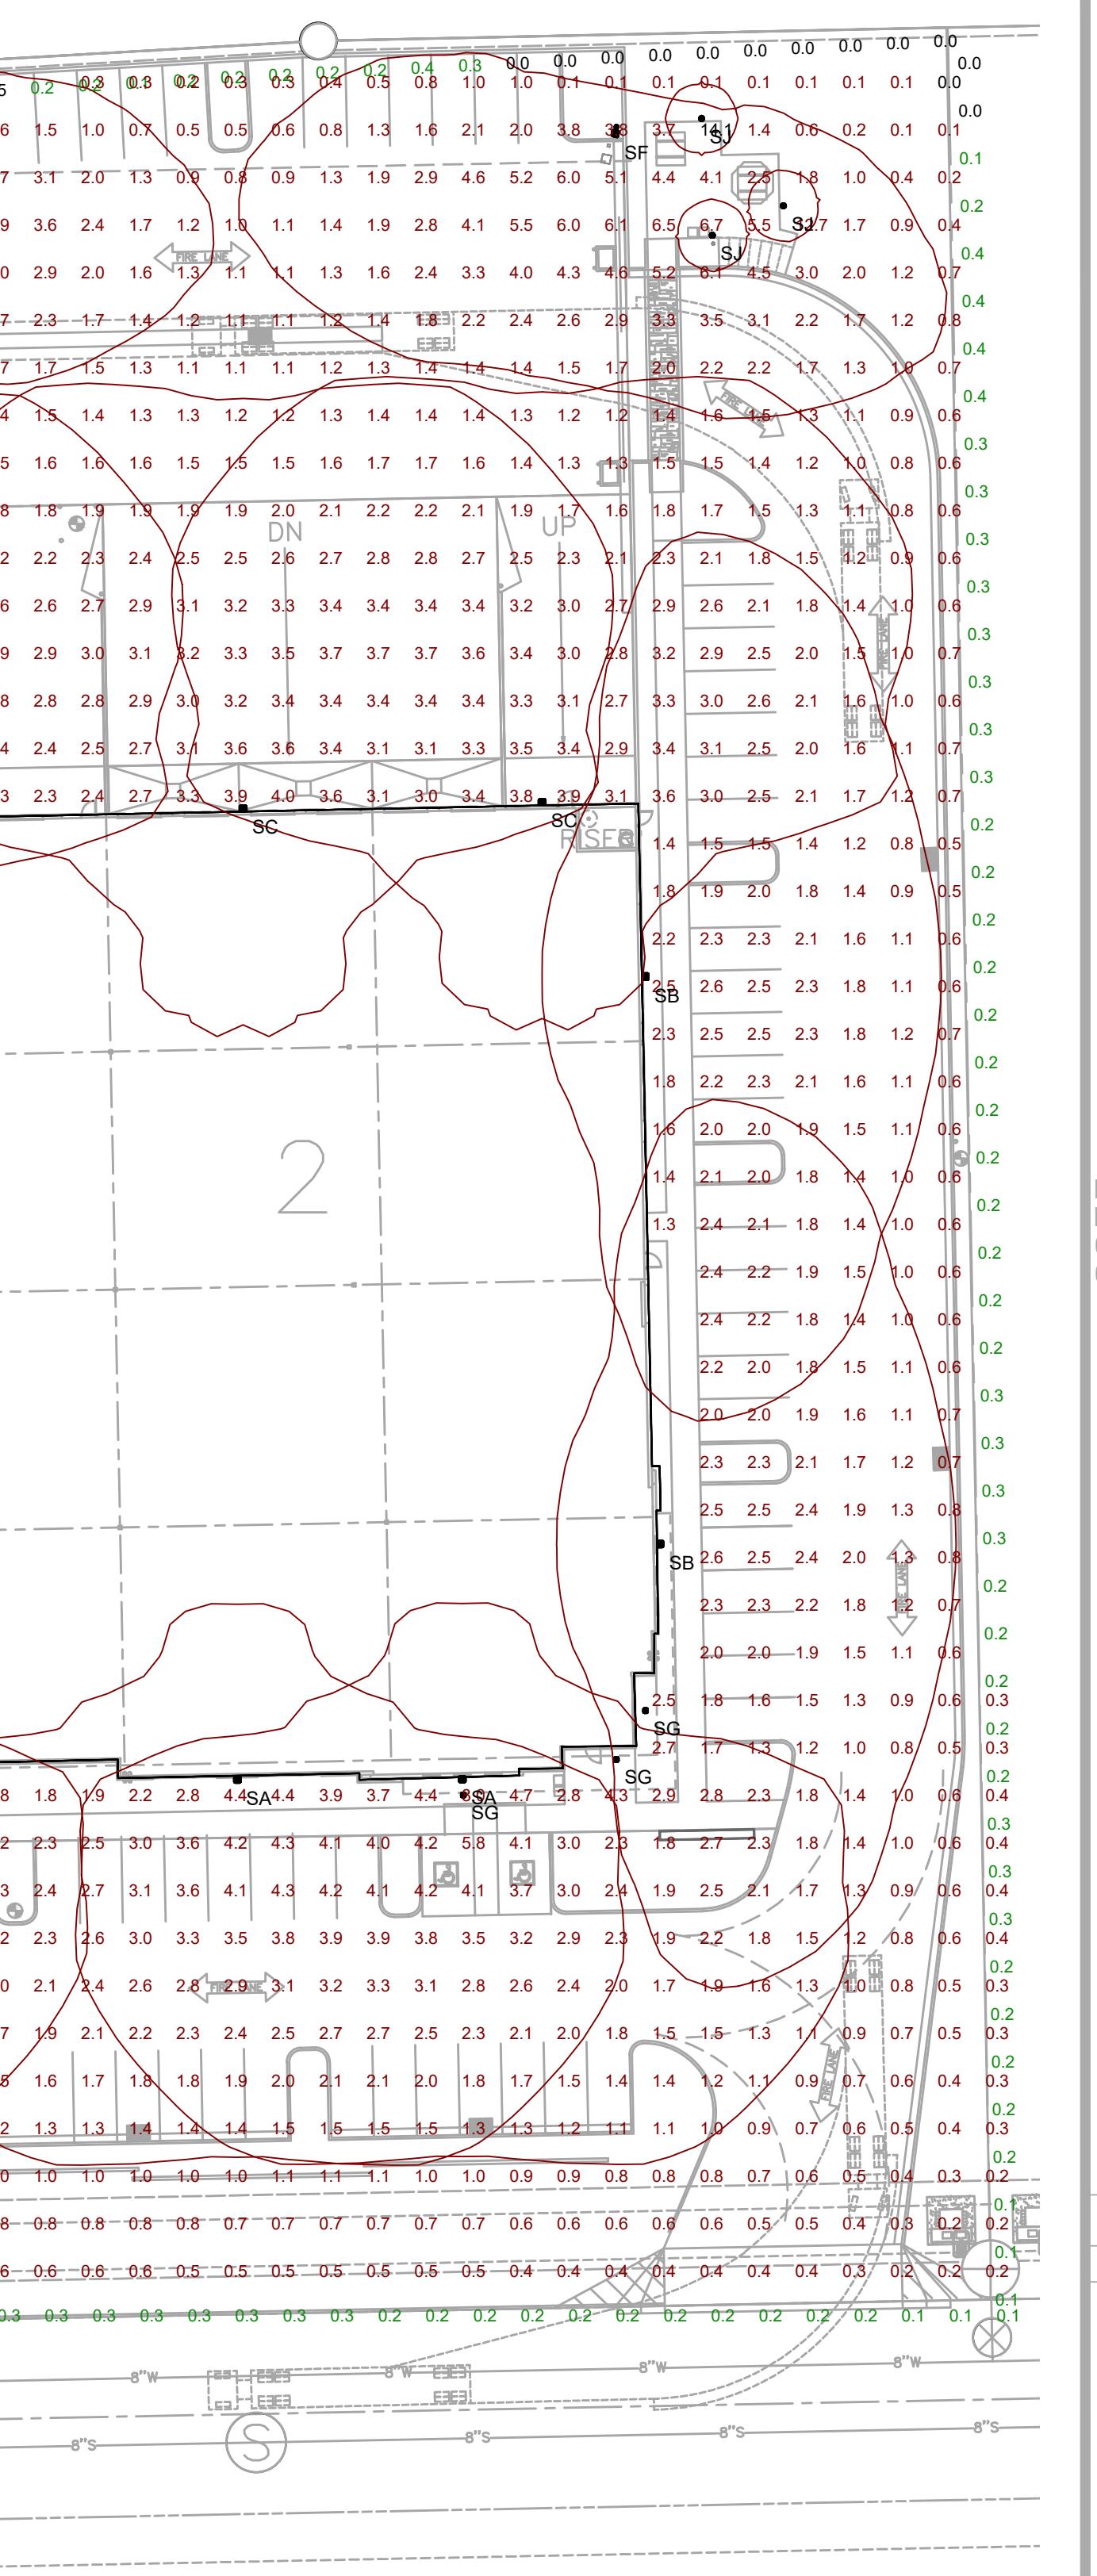

PHOTOMETRIC SITE PLAN
1"=40'-0"


Statistics									
Description	Symbol	Avg	Max	Min	Max/Min	Avg/Min			
FC ON SITE AT GRADE2	+	1.8 fc	14.1 fc	0.0 fc	N/A	N/A			
PROP LINE AT 3'	◆	0.2 fc	0.5 fc	0.0 fc	N/A	N/A			

Schedule											
Symbol	Label	QTY	Manufacturer	Catalog Number	Description	Lamp	Number Lamps	Lumen Multiple	LLF	Wattage	Notes
□	SA	8	Lithonia Lighting	DSX1 LED P9 30K T4M MVOLT/WBA30'	DSX1 LED P9 30K T4M MVOLT	LED	1	25059	1	241	
□	SB	2	Lithonia Lighting	DSX1 LED P7 30K T2M MVOLT/WBA30'	DSX1 LED P7 30K T2M MVOLT	LED	1	19205	1	183	
□	SC	11	Lithonia Lighting	DSX1 LED P9 30K TFTM MVOLT/WBA30'	DSX1 LED P9 30K TFTM MVOLT	LED	1	25600	1	241	
□	SD	3	Lithonia Lighting	DSX1 LED P9 30K T3M MVOLT/HSS 22.5 POLE ON 2.5 BASE	DSX1 LED P9 30K T3M MVOLT with houseshield	LED	1	20151	1	241	
□	SF	2	Lithonia Lighting	DSX1 LED P9 30K BLC MVOLT/HSS 22.5 POLE ON 2.5 BASE	DSX1 LED P9 30K BLC MVOLT	LED	1	20989	1	241	
□	SG	10	ALW	Q4SM D V W 10 83 30 51	SURFACE MOUNT DOWNLIGHT- WET LOCATION	LED	1	965	1	1	6.6
□	SH	2	Lithonia Lighting	DSX1 LED P5 30K BLC MVOLT/SS 17.5' POLE ON 2.5 BASE	DSX1 LED P5 30K BLC MVOLT	LED	1	12047	1	138	
○	SJ	6	Lithonia Lighting	RADB LED P2 30K SYM DBBXD	RADB LED P2 30K SYM DBBXD		1	589	1	1	8

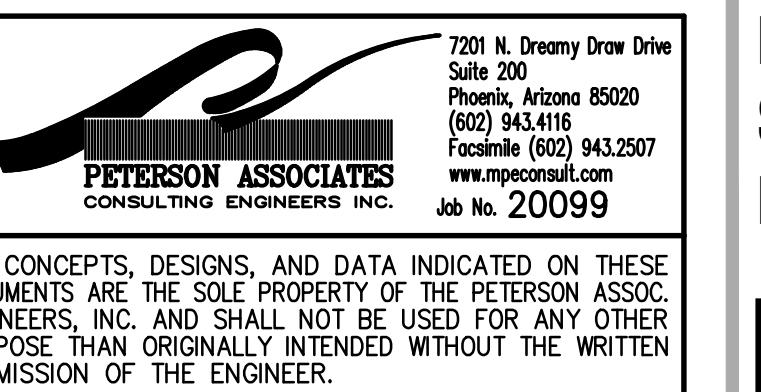

7201 N. Dreamy Draw Drive
Suite 200
Phoenix, Arizona 85020
(602) 943-4116
Fax: (602) 943-2507
www.peterson.com
Job No. 20099

ALL CONCEPTS, DESIGNS, AND DATA INDICATED ON THESE DOCUMENTS ARE THE SOLE PROPERTY OF THE PETERSON ASSOC. ENGINEERS, INC. AND SHALL NOT BE USED FOR ANY OTHER PURPOSE THAN ORIGINALLY INTENDED WITHOUT THE WRITTEN PERMISSION OF THE ENGINEER.

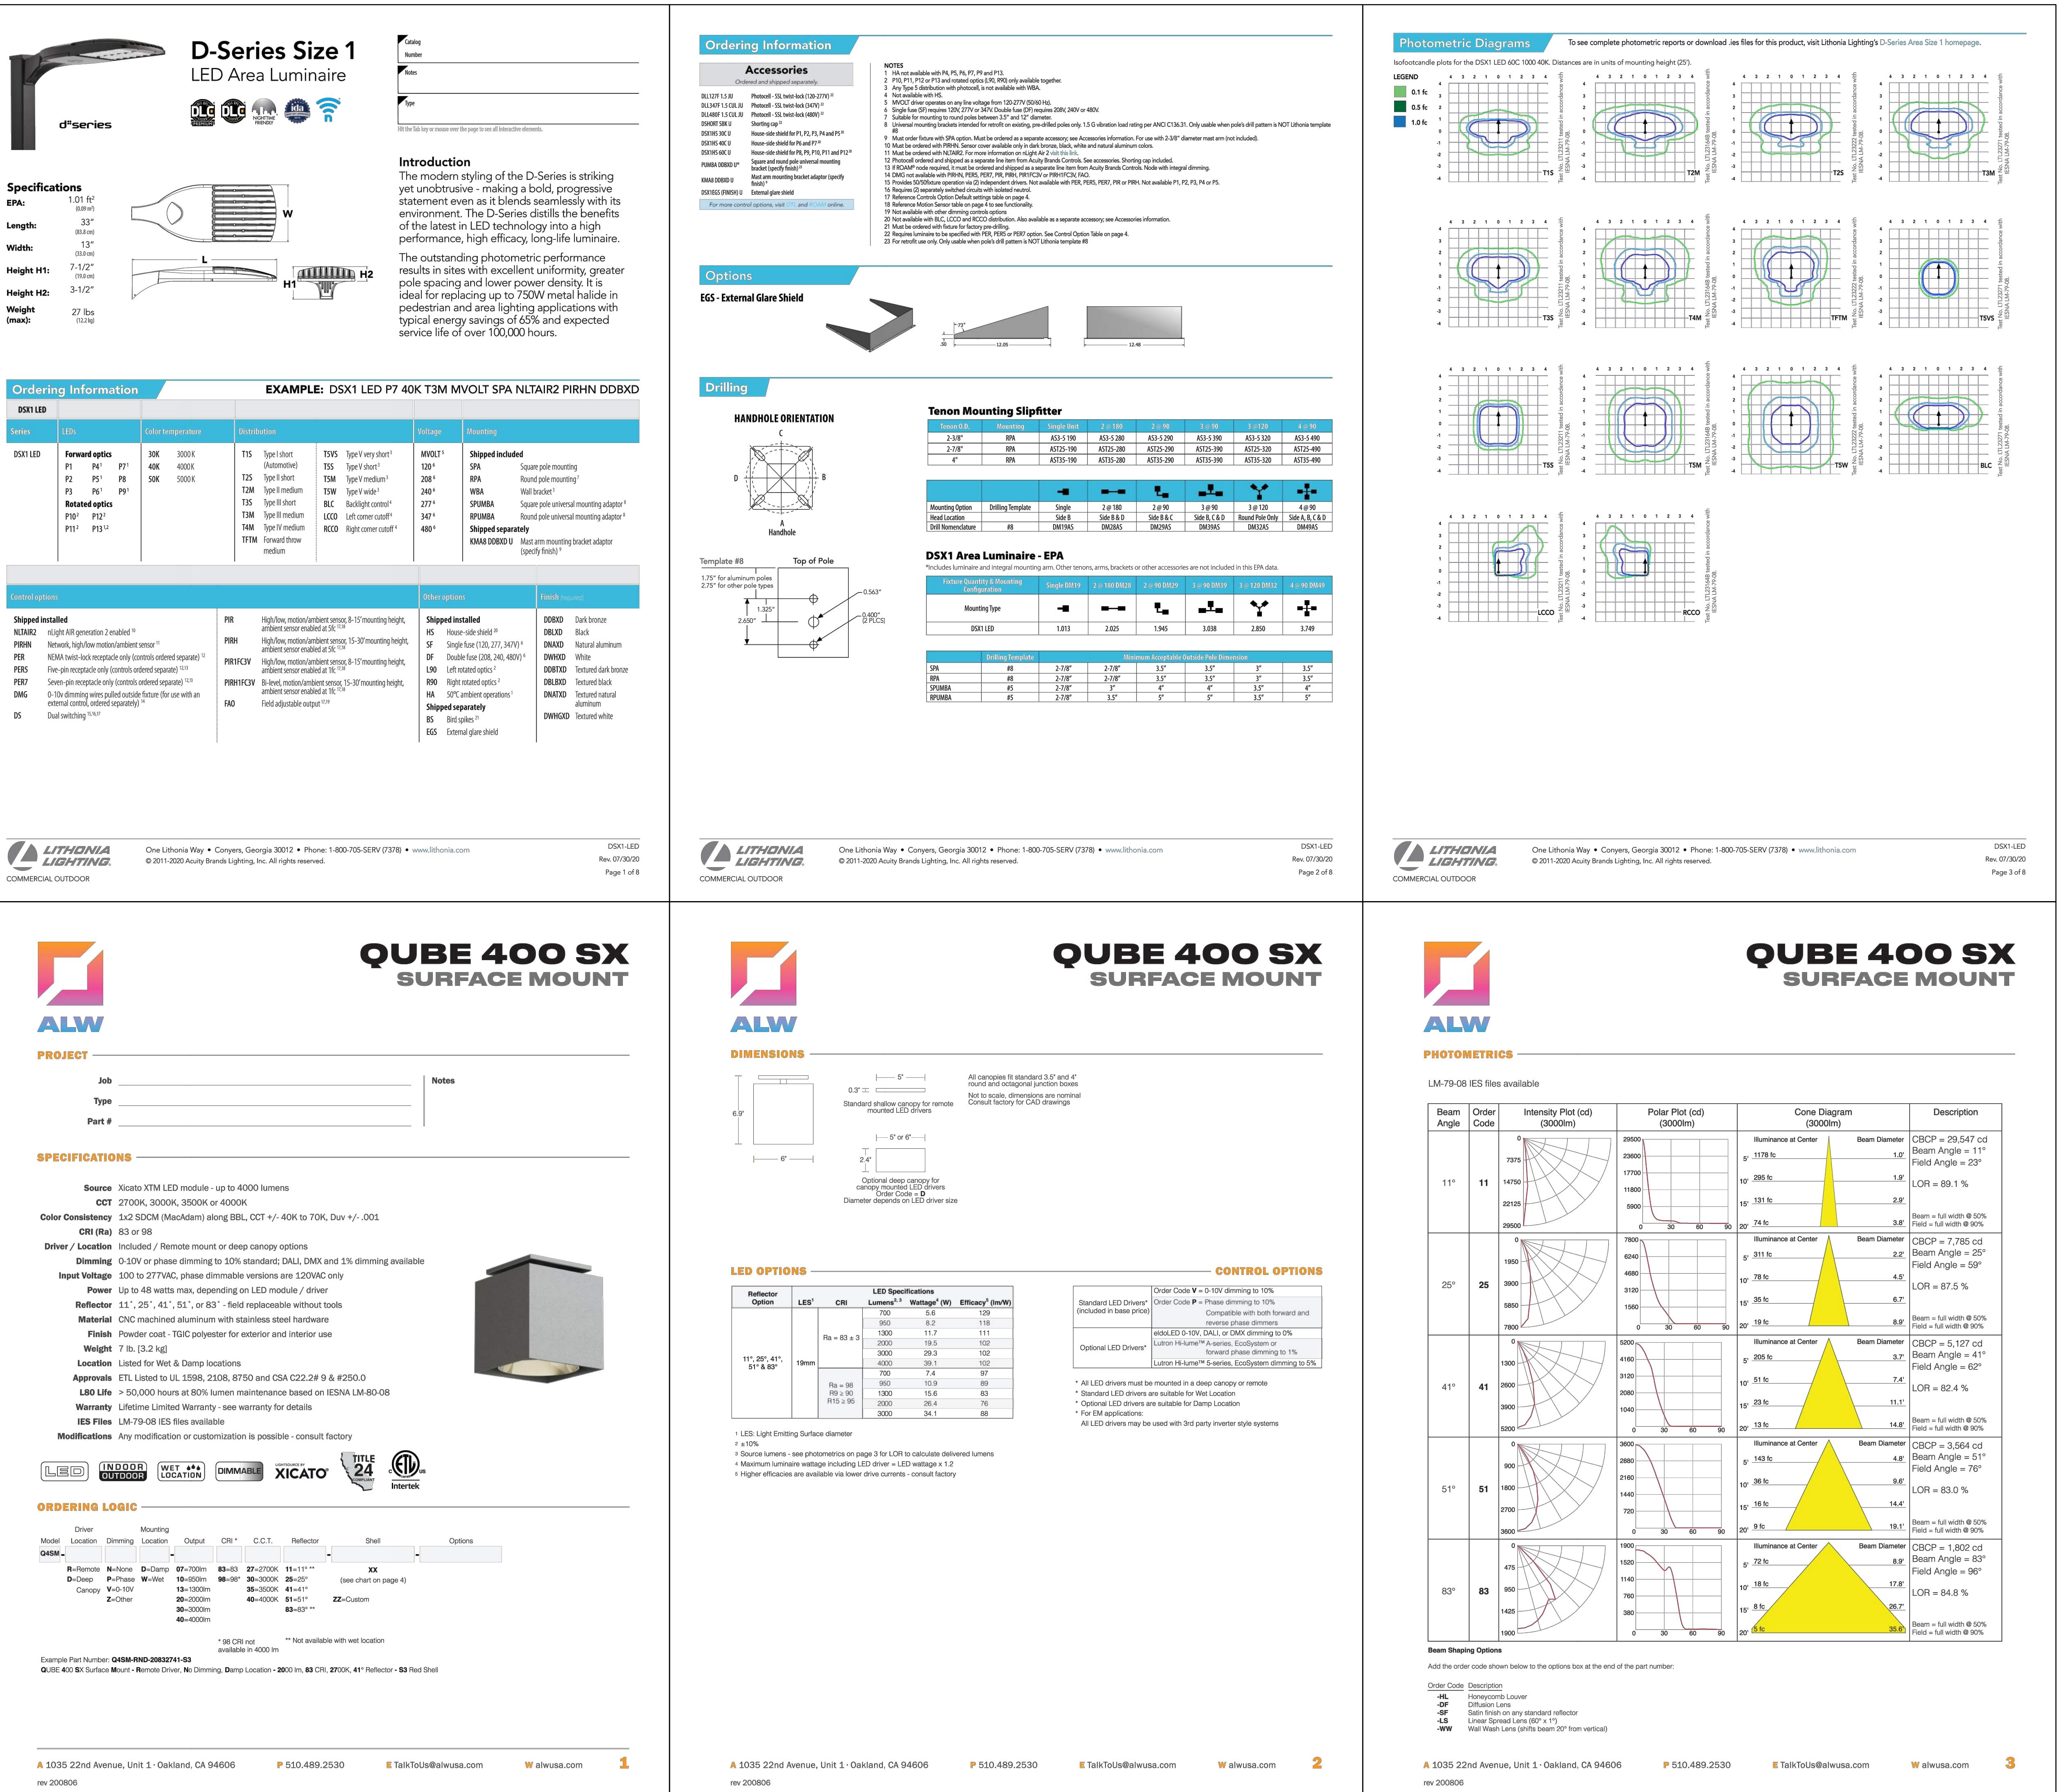

The image is a detailed product page for the RADEAN Bollard LED Site Luminaire. It features two main product images at the top left: a tall, black cylindrical bollard and a cross-sectional diagram of its internal structure. To the right of these images is the product title 'RADEAN Bollard LED Site Luminaire' in bold black text. Below the title are two small icons: 'NIGHTTIME FRIENDLY' and 'IDA'. The page is organized into several sections: 'Catalog Number' (with fields for Notes and Type), 'Introduction' (describing the luminaire as an award-winning, energy-saving, long-life solution), 'Specifications' (including dimensions D=8.25", H=41.5", weight 20lbs/9.07Kg, and finish options like BCC, BCF, and BCF), 'Ordering Information' (with a table showing various model numbers and their characteristics), 'Options' (with diagrams for PIR, FAQ, E7WH, and PE features), 'Photometric Diagrams' (showing isofootcandle plots for different models), 'Performance Data' (with tables for DNAXD Finish), 'Projected LED Lumen Maintenance' (a table for P1-P5 models), 'Lumen Ambient Temperature (LAT) Multipliers' (a table for ambient temperatures 0-40°C), 'FEATURES & SPECIFICATIONS' (sections for Intended Use, Construction, Listings, Finish, and Warranty), and 'ELECTRICAL' (information about the electrical load and power requirements). The bottom of the page includes the Lithonia Lighting logo and contact information for commercial outdoor products.