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ASSURED WATER SUPPLY. C. ALL NEW OR RELOCATED UTILITIES WILL BE PLACED

D. STRUCTURES AND LANDSCAPING WITHIN A TRIANGLE MEASUREDBACK 10'-0" FROM THE PROPERTY LINE AND 20'-0" ALONG THE PROPERTY LINE ON EACH SIDE OF THE DRIVEWAY ENTRANCES WILL BE MAINTAINED AT A MAXIMUM HEIGHT OF

MEASURING 33' x 33' ALONG THE PROPERTY LINES WILL BE MAINTAINED AT A MAXIMUM HEIGHT OF 3'-0". F. ANY LIGHTING WILL BE PLACED SO AS TO DIRECT LIGHT AWAY FROM RESIDENTIAL DISTRICTS AND WILL NOT EXCEED

ONE FOOT-CANDLE AT THE PROPERTY LINE. NO NOISE, ODOR, OR VIBRATION WILL BE EMITTED AT A LEVEL EXCEEDING THE GENERAL LEVEL OF NOISE, ODOR, OR VIBRATION EMITTED BY USES IN THE AREA OUTSIDE OF THE SITE. G. OWNERS OF THE PROPERTY ADJACENT TO PUBLIC RIGHTS-

LANDSCAPING LOCATED WITHIN THE RIGHT-OF-WAY, IN ACCORDANCE WITH APPROVED PLANS.

PER SECTION 702 OF THE ZONING ORDINANCE. I. AFTER FINAL APPROVAL THE PROJECT WILL BE INSPECTED FOR ZONING COMPLIANCE DURING CONSTRUCTION AND PRIOR TO OCCUPANCY. THE APPLICANT IS TO NOTIFY PDD PRIOR TO OCCUPANCY TO ARRANGE FOR INSPECTIONS. CALL 262-6981 AND REQUEST A DESIGN REVIEW INSPECTION. J. ALL ROOFTOP EQUIPMENT AND SATELLITE DISHES SHALL BE

TRASH CONTAINERS, LOADING DOCS AND TRANSFORMER, BACKFLOW PREVENTERS AND OTHER MECHANICAL OR ELECTRICAL EQUIPMENT FROM EYE LEVEL ADJACENT TO ALL PUBLIC

REGULATION III OF MARICOPA COUNTY AIR POLLUTION CONTROL RULES AND REGUALTIONS

PROTECTION AGENCY.

CERTIFICATION SHALL BE PROVIDED BY THE MESA FIRE DEPARTMENT PREVENTION BUREAU THAT ALL MANUFACTURING, STORAGE, AND WASTE PROCESSES ON THE SITE SHALL MEET SAFETY AND ENVIRONMENTAL STANDARDS AS ADMINISTERED BY THE BUREAU. S. ALL NEW SANITARY SEWER LINES WITHIN THE SITE SHALL BE PRIVATE PLUMBING LINES SUBJECT TO THE MESA PLUMBINGCODE OR THE ARIZONA DEPARTMENT OF

ENVIRONMENTAL QUALITY (ADEQ) AQUIFER PROTECTION PROGRAM (APP) GENERAL PERMIT 4.01 IN ACCORDANCE WITH ARIZONA ADMINISTRATIVE CODE TITLE 18, CHAPTER 9, SECTION E301 (AAC R-18-9-E301) WHICHEVER IS APPLICABLE T. THE SANITARY SEWER COLLECTION SYSTEM WITHIN THE PROJECT WILL BE A PRIVATE SYSTEM. OWNED AND THE SYSTEM WILL BE REVIEWED AND INSPECTED BY THE **BUILDING SAFETY SECTION OF**

U. ALL ON-SITE WATER LINES SHALL BE PRIVATE PLUMBING LINES SUBJECT TO THE MESA PLUMBING CODE. V. UPDATE ALL EXISTING OFF-SITE IMPROVEMENTS (SIDEWALKS, CURB RAMPS AND DRIVEWAYS) TO CURRENT ADA GUIDELINES.

BROKEN OR OUT OF GRADE CURB. GUTTER AND SIDEWALKS

I CONSENT TO THE REPRODUCTION OF THIS SITE PLAN FOR THE PURPOSE OF FUTURE AMENDMENTS PROVIDED THAT IF MODIFICATIONS ARE MADE, THE ARCHITECTS WHO MAKE SUCH CHANGES ASSUME FULL RESPONSIBILITY AND LIABILITY FOR THE PLAN.

256' BUILDING FACADE AT RIGHT OF WAY BY VAIRANCE OF MID-RISE TYPOLOGY

ALLEY

PROJECT DATA

EXIST. ZONING: PROPOSED ZONING: T5MSF/MID-RISE/ARCADE 1 PER DWELLING UNIT PARKING REQ'D 102 UNITS = 102 RES. PARKING

EXIST PUBLIC PKG: 76 SPACES (INCLU. 3 EV, 4 ADA)

SYSB FRONTAGE = 0'

1 PER DWELLING UNIT MIN. PROPOSED PARKING 127 RESIDENT PARKING SPACES (INCLU. 3 EV, 5 ADA) NEW PUBLIC PKG: 76 SPACES (INCLU. 3 EV, 6 ADA)

GROSS ACREAGE: 50,815 S.F. = 1.17 ACRES NET ACREAGE: 38,994 SF = .895 ACRES

DENSITY (DU/ACRE) 87.2 DU/ACRE AS ILLUSTRATED PROPOSED SETBACKS FYSB = 0' SYSB = 0'

RYSB = 0'FACADE ADDRESS BTL 85% SHOPFRONTAGE MIN. 11.9% GIVEN TO PUE

SHOPFRONT FRONTAGE TYPE VEHICULAR ENTRANCE

GROSS BUILDING AREA 216,129 S.F.

PROPOSED LOT COVG. 92%

PEPPER PLACE

20' - 10"

GARAGE GARAGE
EXIT ENTRY

EXISTING TRANSFORMER

PROJECT: MIXED USE RESIDENTIAL/RETAIL AND PUBLIC PARKING

MERCANTILE PROPOSED USES

RESTAURANT MULTI-FAMILY RENTAL (102)

BUSINESS OFFICE PROPOSED CONST: TYPE I RETAIL/GARAGE

TYPE V RESIDENTIAL **ALLOWED HEIGHT:** 85' MAX w/LEED EQUIVALENCE

85' TO TOP OF SOLAR PANELS PROPOSED HEIGHT: 72'-0' TO ROOF 7 STORIES PLUS SOLAR PANELS

PROPOSED FIRE PROT. FULLY SPRINKLERED

RESIDENTIAL CALCULATION 112 UNITS x .5 CY/UNIT = 56 CY RESIDENT TRASH 56 CY TRASH COMPACTED x .33 VOLUME = 18.48 CY


18.48 CY P.U. 1X PER WEEK...IN 3 CY CONTAINERS = 7 CONTAINERS 18.48 CY P.U. 2X PER WEEK...IN 3 CY CONTAINERS = 4 CONTAINERS

112 UNITS x .2 CY/UNIT (38.4 GALLON) = 22.4 CY RESIDENT RECYCLE 22.4 CY P.U. 1X PER WEEK... IN 3 CY CONTAINERS = 8 CONTAINERS 22.4 CY P.U. 2X PER WEEK... IN 3 CY CONTAINERS = 4 CONTAINERS **SOLUTION: PICKUP 2X PER WEEK**

PROJECT SECTIONS

		TOP OF S	OLAR 35' - 0"
	APARTMENTS	APARTMENTS LEV	72' - 0" <u>′EL 07</u>
	APARTMENTS	APARTMENTS LEV	61' - 8" <u>′EL 06</u>
	APARTMENTS	APARTMENTS LEV	51' - 4" <u>′EL 05</u>
	APARTMENTS	APARTMENTS LEV	11' - 0" <u>'EL 04</u>
LEVEL 03	GARAGE	3	30' - 8"
19' - 2" LEVEL 02	GARAGE		
9' - 7" LEVEL 01	GARAGE	RETAIL	
0"		RBHT OF WAY UNE	EXSTING CURB
		RG	lg

\ FRONTAGE CONDITION - RETAIL ARCADE WEST 1" = 30'-0"

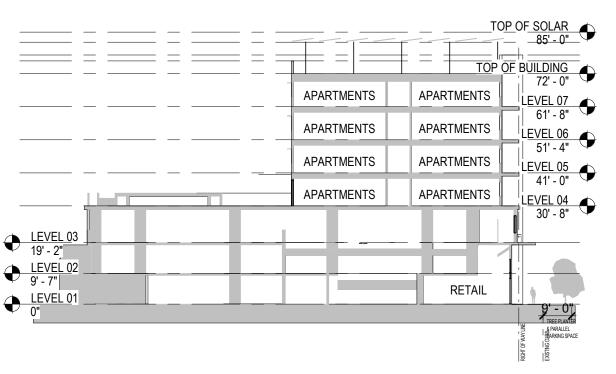

			TOP	OF SOLAR
				85' - 0"
			TOP OF	BUILDING
	APARTMENTS	APARTMENTS	APARTMENTS	72' - 0" LEVEL 07
	APARTMENTS	APARTMENTS	APARTMENTS	61' - 8" LEVEL 06
	APARTMENTS	APARTMENTS	APARTMENTS	51' - 4" LEVEL 05
	APARTMENTS	APARTMENTS	APARTMENTS	41' - 0" LEVEL 04
LEVEL 03		GARAGE		30' - 8"
19' - 2" LEVEL 02		GARAGE		
9' - 7" LEVEL 01		GARAGE		1
0"				ا سِ
				IGHTOF WAYLI



ONSITE TRANSFORMER ACCOMODATION

- 2. 3 HR COLUMNS, WALLS, AND LID
- **TRANSFORMERS**
- 5. EXISTING SWITCH CABINET, PRIMARY AND
- SECONDARIES TO MOVE PER MESA ELECTRIC 6. EXISTING TRANSFORMER POSITION @ SE AND

SW CORNER TO REMAIN



- . BUILDING SHAPING ABOVE 18'-0" AT PEPPER
- 2. 3 SUNSHADES AT SHOPFRONTAGE

22 1N 5E | 23-18 | MESA ARIZONA | 8 | 6,750 | S.F. 138-35-053 C-DT 22 1N 5E 23-18 MESA ARIZONA 8 7,155 S.F. 138-35-054 C-DT 22 1N 5E 23-18 MESA ARIZONA 8 1,350 S.F. 138-35-012 C-DT 22 1N 5E 23-18 MESA ARIZONA 13 13,095 S.F. 22 1N 5E | 23-18 | MESA ARIZONA 138-35-010A C-DT 22 1N 5E 23-18 MESA ARIZONA 11 4,432 S.F.

ZONING S/T/R MCR SUBDIVISION LOT# AREA

PROJECT TEAM

HABITAT METRO, LLC

CCBG ARCHITECTS, INC

102 E. BUCHANAN STREET

MR. BRIAN CASSIDY

PHOENIX, AZ 85004

RITOCH POWELL

MESA, AZ 85201

JESSE WESTAD

51 W. 3RD STREET

TEMPE, AZ 85281

JESSE HENSEN

221 E. INDIANOLA AVE

PHOENIX, AZ 85012

MR. STEVE LEWIS

63 E. MAIN STREET

MR. TIM SPRAGUE

844 N. 4TH AVENUE

PHOENIX, AZ 85011

602-300-4908

602.258.2211

SUITE 502

602-263-1177

SUITE 450

602-429-9922

602-430-4264

127 WEST PEPPER PLACE

MESA FORM BASED CODE

MIXED USE RESIDENTIAL WITH

GROUND FLOOR RETAIL AND

76 PUBLIC PARKING SPACES.

MESA, AZ 85201

EXISTING PARCELS & RECORDING PER CHART BELOW.

PARCELS WILL BE JOINED INTO ONE NEW PARCEL.

GROSS ACREAGE: 38,994 SF = .895 ACRES

T5MSF

WERK

SUSTAINABILITY CONSULT OCULUS STUDIO

PROPERTY INFO

OWNER/DEVELOPER

ARCHITECT OF RECORD

LANDSCAPE ARCHITECT

CIVIL ENGINEER

ADDRESS:

ZONING:

PROJECT:

PROJECT DESCRIPTION

ECO MESA is a mixed use infill residential rental community designed with sustainability and walkability in mind. Rooftop solar panels will provide over 50% of the development's energy needs, gray water capture from showers will irrigate the landscaped areas and a car share program will be available for residents. Located just one street north of the ight rail in downtown Mesa, the building is located in and designed to the T5MSF transect of the form based code. The building will be constructed in the place of the 76 parking space Purple Lot, and will provide those same 76 covered public parking spaces plus additional covered parking for residents onsite in an open parking garage. The building will yield 102 rental apartment units including studios, 1 bedroom and 2 bedroom units. The structure will feature 3 parking floors of Type I C.I.P. concrete construction below the 3 hr podium slab, and 4 residential floors of Type V wood frame above the podium slab. The top of wood frame structure at roof plane will be 72'-0". A number of rooftop appurtenances in the form of stair and elevator overrun, and a sizeable array of solar panels will be constructed below the maximum allowable height of 85' per form based code. These elements will be of non-combustible construction

APPROVAL BLOCK

VARIANCE CASE # PRA20-00450

REV FOR **ISSUANCE** Drawn CL Checked Job Numbe Drawing SITE PLAN

MESA APARTMEN Habitat Metro

CCBG

Architects, Inc

Phoenix - San Diego 102 East Buchanan Street Phoenix AZ 85004 602.258.2211 www.ccbgarchitects.com

CASSIDY

A1.0

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GENERAL SITE PLAN NOTES

ALL APPLICABLE CODES AND ORDINANCES B. THIS PROJECT IS LOCATED IN THE CITY OF MESA WATER 10 SERVICES AREA AND HAS BEEN DESIGNATED AS HAVING AN

UNDERGROUND.

E. STRUCTURES AND LANDSCAPING WITHIN A TRIANGLE

OF-WAY WILL HAVE THE RESPONSIBILITY FOR MAINTAINING ALL

H. CURB AND DUSTPROOF ALL DRIVES AND PARKING AREAS

SCREENED TO THE HEIGHT OF THE TALLEST EQUIPMENT. K. BARBED. RAZOR. OR CONCERTINA WIRE (OR SIM.) SHALL NOT BE USED ON THIS SITE WHERE VISIBLE FROM PUBLIC STREETS OR ADJACENT RESIDENTIAL AREAS. L. ALL SIGNAGE REQUIRES A SEPARATE REVIEW AND PERMIT

M. OMIT N. ALL SERVICE AREAS SHALL BE SCREENED TO CONCEAL

O. SMOKE, GAS, AND ODOR EMISSIONS SHALL COMPLY WITH

Key Value

KEYNOTES

EXISTING FIRE HYDRANT TO BE RELOCATED

TRAFFIC VISIBILITY TRIANGLES

HARDSCAPE, REF TO LANDSCAPE

BUILDING LINE ABOVE

10'X30' LOADING BEARTH

STEEL FRAME, PAINTED

PEARMEABLE PAVING

SES

NEW BUIDLING -

TRANSFORMERS

LIMITS OF 3HR -

EXISTING TRANSFORMER AND PAD TO REMAIN CONCRETE CURB

Keynote Text

TRANSFORMER SCREEN WALL, WOVEN STEEL SLATS WITHIN

P. THE DISPOSAL OF ALL WASTE MATERIALS SHALL COMPLY ARIZONA HEALTH DEPARTMENT.

WITH TITLE 9. CHAPTER 9. ARTICLES 18 & 4 OF THE HAZARDOUS WASTE REGULATIONS AS ADOPTED BY THE Q. THE AVERAGE NOISE LEVEL, MEASURED AT THE PROPERTY LINE. SHALL NOT EXCEED 55 dB (1 dn) WHEN MEASURED ON AN "A WEIGHTED" SOUND LEVEL METER AND


ACCORDING TO THE PROCEDURES OF THE ENVIRONMENTAL

R. EXPLOSIVE OR HAZARDOUS PROCESSES (IF APPLICABLE):


MAINTAINED BY THE PROPERTY OWNER(S) OR ASSOCIATION. THE PLANNING AND DEVELOPMENT SERVICES DEPARTMENT

W. REMOVE ALL UNUSED DRIVEWAYS AND REPLACE ANY ON ALL STREETS.

REFUSE CALCULATION

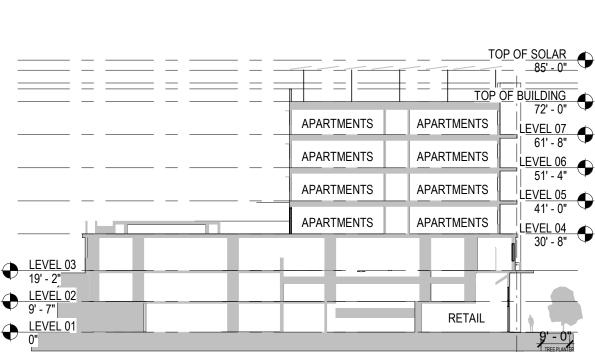

\ FRONTAGE CONDITION - RETAIL ARCADE EAST 1" = 30'-0'

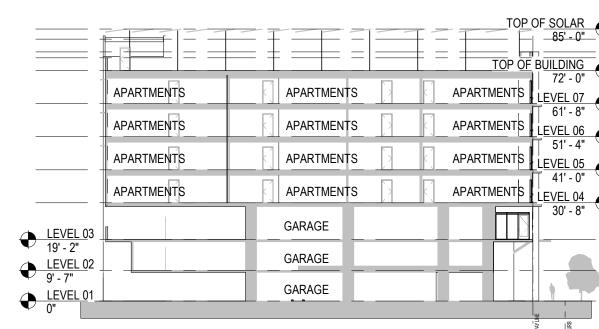

FRONTAGE CONDITION - DRIVE EXIT & TRANSFORMER

1" = 30'-0"




- 29'-6" CLEARANCE TO OBSTRUCTION
- OPEN SIDE AT ALLEY MANUEVERING AREA NEW PRIMARY FEED ROUTING AT ALLEY TO

ENCROACHMENT ELEMENTS REQUESTED

- PLACE FRONTAGE
- SOLAR PANELS AS ROOFTOP APURTENANCE RESIDENTIAL BALCONIES ABOVE 29'-0"

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Architects, Inc.

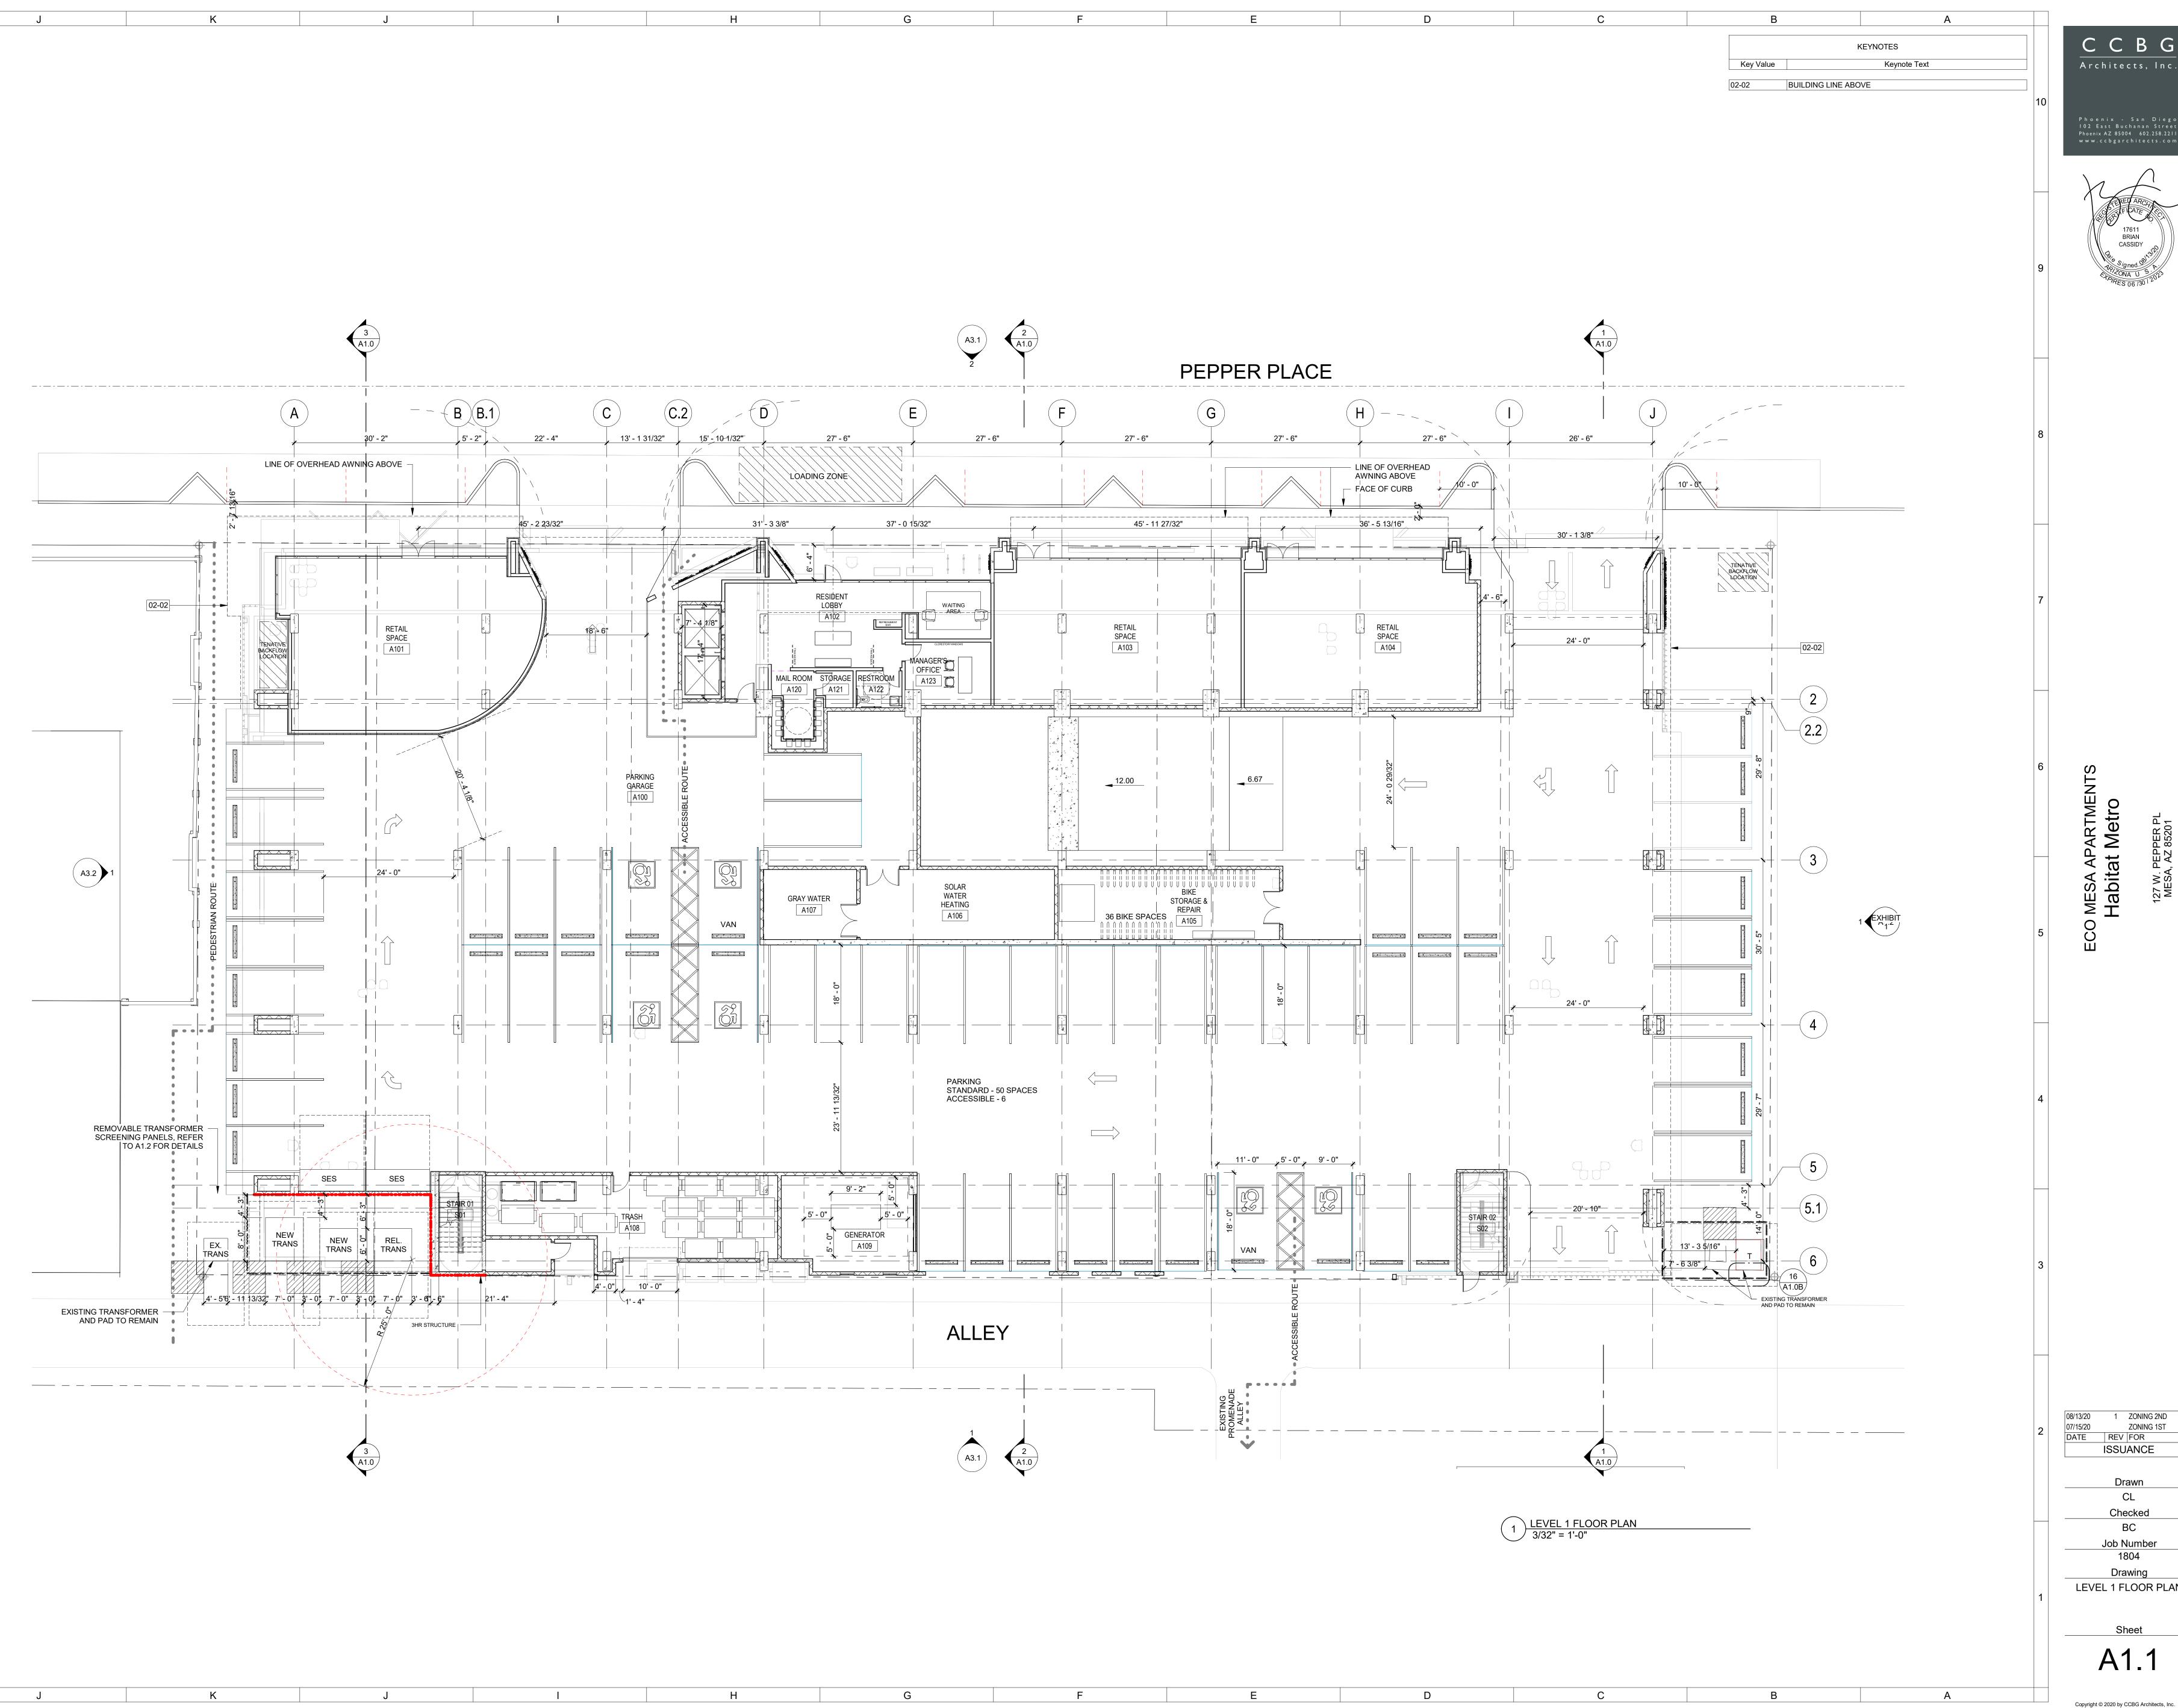

DATE REV FOR ISSUANCE

Drawn CL Checked Job Number

Drawing LEVEL 1 FLOOR PLAN

A1.1