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SELF-CERTIFIED BY: JEFF A. PIERCE

* PLANS WERE PREPARED BY OR UNDER THE DIRECT SUPERVISION OF, OR REVIEWED BY THE SELF-CERTIFIED PROFESSIONAL.

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PROJECT NAME / LOCATION


APN 135-16-041 TWO STOREY QUADPLEX

554 W RIO SALADO PKWY, MESA, ARIZONA 85201-4008

OWNER NAME / ADDRESS

JOSE CARREON /
NATIONAL
CONSULTING GROUP
LLC

636 E 6TH PLMESA, AZ 85203-6302

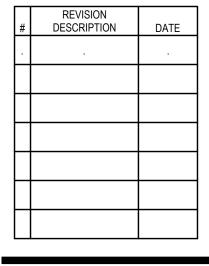

SHEET CONTENTS

COVER SHEET SITE PLAN

DRAWN BY: JGO
CHECKED BY: JSQ
DATE: 3.03.2023

SHEET NUMBER

CS 24" X 36" PAPER SIZE

KEYNOTES

- (1) 200A SERVICE PANEL
- WATER HEATER WITH DRAIN PAN. SEE GENERAL NOTE #23
- FOR DRAIN PAN COMPLIANCE (3) SHOWER WITH WATERPROOF SURROUND ON WALLS, FLOOR AND CEILING. SHOWERHEAD AT 78" AFF.
- (4) WATER CLOSET 1.5GALLON PER FLUSH
- (5) LAVATORY ON 2'10" HIGH BUILT-IN BASE CABINET
- (6) KITCHEN REFRIGERATOR
- DISHWASHER PROVIDE GFCI OUTLET AT UNDERCOUNTER FOR POWER CONNECTION
- (8) KITCHEN SINK W/ DISPOSAL GARBAGE PROVIDE SWITCH UNDER SINK CABINETRY
- (9) ELECTRIC RANGE
- (10) KITCHEN BASE CABINET
- (11) UPPER CABINET WITH 20" SPACE BETWEEN TOP OF COUNTER AND BOTTOM OF UPPER CABINET
- (12) CONDENSING UNIT MOUNTED ON 12" CONCRETE PAD
- (13) CLOTHE WASHER
- (14) CLOTHE DRYER
- (15) GARBAGE BINS BARREL SERVICE ENCLOSED IN CMU WALL SCREEN
- (16) 20" X 30" ATTIC ACCESS
- (17) LANDSCAPE / GARDEN SPACE
- (18) NEW CLOSET WITH 2' DEEP BUILT IN SHELVES AND HANGER ROD @ 6' HIGH
- (19) 2' DEEP BUILT IN SHELVES FOR W.I.C. (WALK-IN CLOSET)

DOORS & WINDOWS SCHEDULE

DOOR SO	CHEDULE (FOR EACH INDI	VIDUAL UNIT)			
	DOORS			FRAMES / FINISH	
NO.	ROOM NAME	SIZE	MATERIAL	T IIIIO	REMARKS
01	MAIN ENTRANCE/EXIT	2'-8" x 8'-0"	SOLID CORE WOOD DOOR	SOLID WOOD / PAINTED	PANEL DOOR
02	LIVING / DINING	6'-0" x 8'-0"	SOLID CORE WOOD DOOR	SOLID WOOD / PAINTED	FRENCH DOOR
03	STORAGE	2'-8" x 8'-0"	HONEYCOMB CORE WOOD DOOR	SOLID WOOD / PAINTED	PANEL DOOR
04	BEDROOMS	2'-4" x 8'-0"	HONEYCOMB CORE WOOD DOOR	SOLID WOOD / PAINTED	PANEL DOOR
05	BATHROOMS	2'-4" x 8'-0"	HONEYCOMB CORE WOOD DOOR	SOLID WOOD / PAINTED	PANEL DOOR


WINDOV	W SCHEDU	JLE (FOR EACH INDIV	/IDUAL UNIT)				
NO.	QTY.	SIZE (W x H)	MATERIAL	HDR. HT.	DUAL GLAZED	TEMPERED	REMARKS
W1	2	4'-0" x 5'-0"	VINYL/TEMPERED GLASS	8'-0"	•	•	SLIDING WINDOW
W2	1	4"-0" x 4'-0"	VINYL/TEMPERED GLASS	8'-0"	•	•	SLIDING WINDOW
W3	2	8'-0" x 4'-0"	VINYL/TEMPERED GLASS	8'-0"	•	•	SLIDING WINDOW
W4	2	2'-0" x 4'-0"	VINYL/TEMPERED GLASS	8'-0"	•	•	SMOKED AWNING

NOTE *= SAFETY GLAZING AS PER R308.4


38'-0" DWELLING UNIT

	INSULATION A	ND FENESTRATIO	N	
MAX U-FACTOR	MAX SHGC	CEILING R-VALUE	WALL R-VALUE	FLOOR R-VALUE
0.40	0.25	38	13	13

NOTE *= ALL VALUES SHALL MEET OR EXCEED THE MINIMUMS PROVIDED BY THIS TABLE WHEN SHOWING COMPLIANCE WITH THIS METHOD.

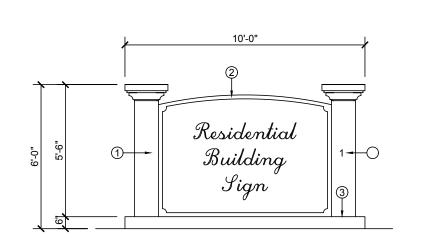


- 1. 12" SQ. CONC. BLOCK PILASTER 2. 6" THK MASONRY WALL WITH STUCCO
- 3. 6" THK. CONC. SLAB
- NOTE: SEE BLDG. ELEVATION FOR COLORS

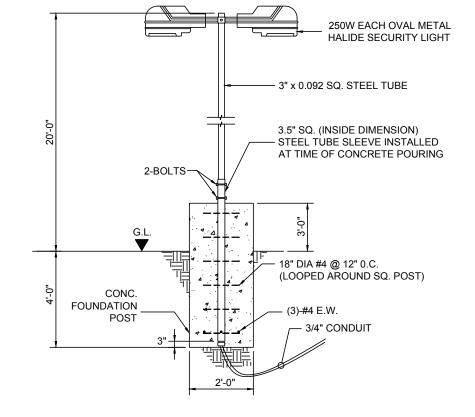





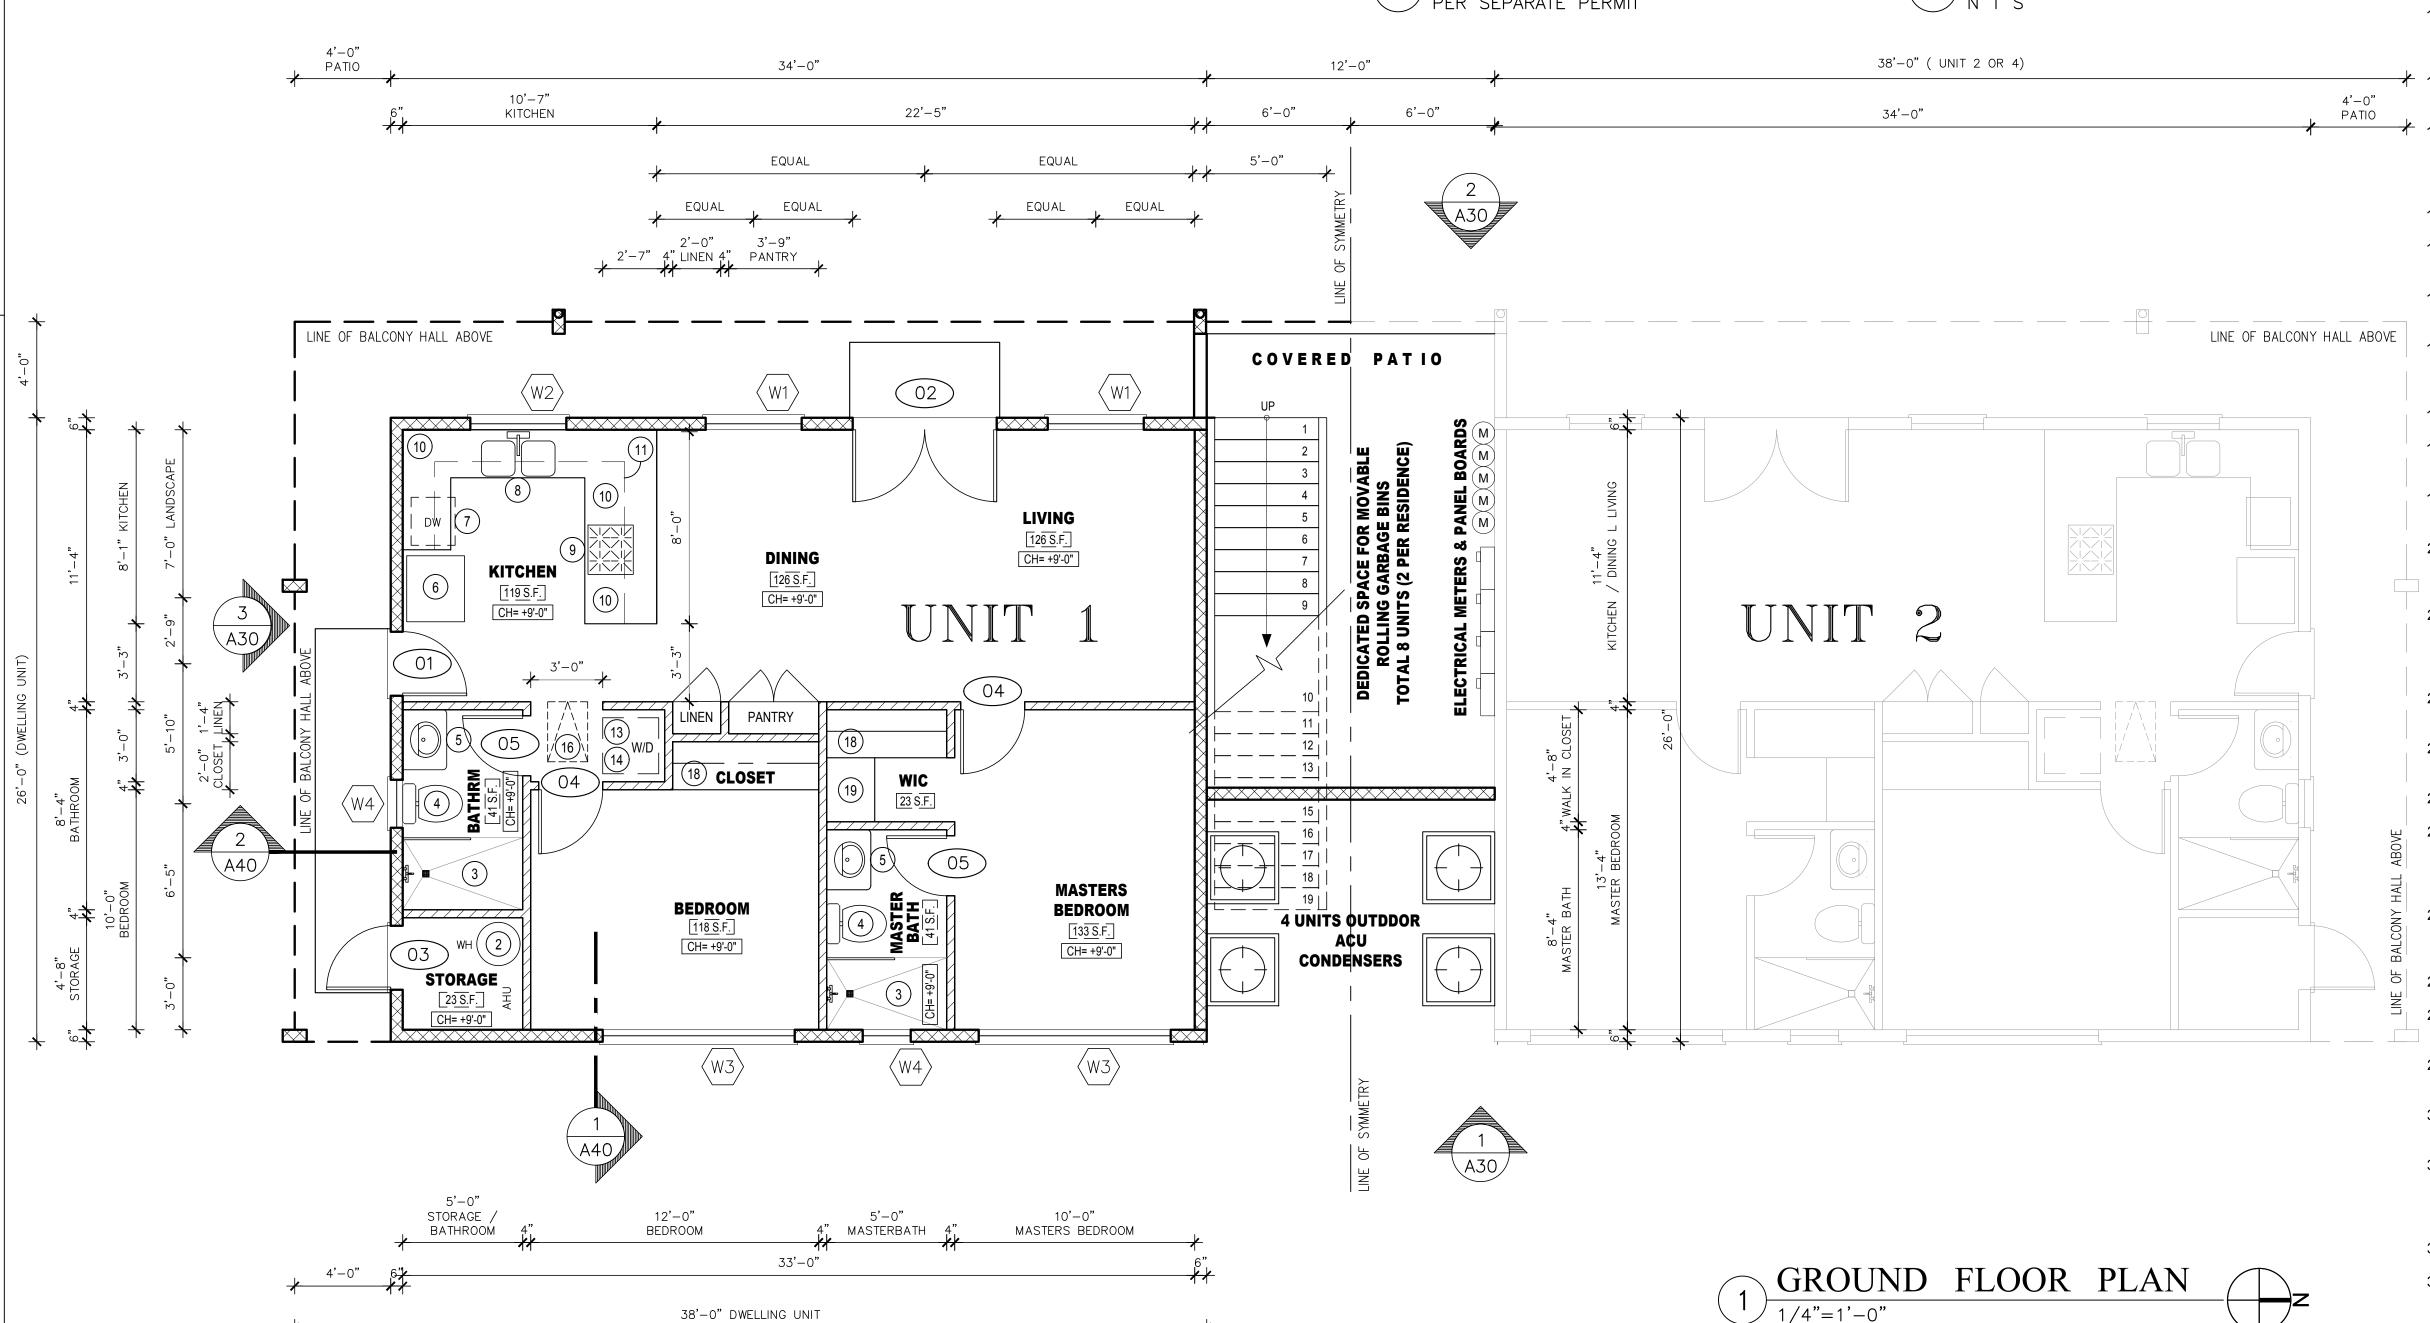

GENERAL NOTES


- CONTRACTOR SHALL FIELD VERIFY ALL DIMENSIONS
- 2. ALL WALLS BEHIND AND ADJACENT TO PLUMBING FIXTURES SHALL BE WATER RESISTANT.
- WHEN ALTERATIONS, REPAIRS, OR ADDITIONS REQUALURING A PERMIT OCCUR, OR WHEN ONE OR MORE SLEEPING ROOMS ARE ADDED OR CREATED IN EXISTING DWELLINGS, THE INDIVIDUAL DWELLING UNIT SHALL BE EQUALUIPPED WITH SMOKE ALARMS LOCATED AS REQUALUIRED FOR NEW DWELLINGS; THE SMOKE ALARMS SHALL BE INTERCONNECTED AND HARD WIRED AS PER R313.2.
- BATHTUB AND SHOWER FLOORS AND WALLS ABOVE BATHTUBS WITH INSTALLED SHOWER HEADS AND IN SHOWER COMPARTMENTS SHALL BE FINISHED WITH A NON-ABSORBENT SURFACE WITH A HEIGHT OF NOT LESS THAN 6 FEET ABOVE FLOOR (AS REQUIRED BY IRC SECTION R307.2)
- 5. CONTRACTOR SHALL USE FIBER-CEMENT BACKERS PER ASTM C 1288 OR EQUALUAL FOR CERAMIC TILE ON WALLS IN TUB AND SHOWER AREAS AND WALL PANELS IN SHOWER AREAS
- TOILETS, BATHTUBS, SINKS, AND SHOWER SPACES SHALL BE SPACED IN ACCORDANCE WITH R307.1 AND WITH ACCORDANCE WITH SECTION P2705.1.
- 7. WATER CLOSETS, URINALS, LAVATORIES AND BIDETS. A WATER CLOSET, URINAL LAVATORY OR BIDET SHALL NOT BE SET CLOSER THAN 18 INCHES FROM ITS CENTER TO ANY SIDE WALL, PARTITION, VANITY OR OTHER OBSTRUCTION, OR CLOSER THAN 30 INCHES (762MM) CENTER-TO-CENTER BETWEEN ADJACENT FIXTURES. THERE SHALL BE AT LEAST A 21-INCH (533MM) CLEARANCE IN FRONT OF THE WATER CLOSET, URINAL, LAVATORY OR BIDET TO ANY WALL, FIXTURE OR DOOR, WATER CLOSET COMPARTMENTS SHALL NOT BE LESS THAN 30 INCHES (762MM) WIDE
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- GLAZING IN WALLS, ENCLOSURES OR FENCES CONTAINING OR FACING HOT TUBS SPAS, WHIRLPOOLS, SAUNAS, STEAM ROOM, BATHTUBS, SHOWERS AND INDOOR OF OUTDOOR SWIMMING POOLS WHERE THE BOTTOM EXPOSED EDGE OF THE GLAZING IS LESS THAN 60 INCHES (1524MM) MEASURED VERTICALLY ABOVE ANY STANDING OR WALKING SURFACE SHALL BE CONSIDERED A HAZARDOUS LOCATION
- 10. ALL FLAT ROOFS ARE TO SLOPE A MINIMUM OF 2% TOWARDS ROOF DRAINS. ROUGH CARPENTER TO PROVIDE SHIMS BELOW ROOF SHEATHING TO ALLOW FOR PROPER SLOPE TO DRAIN. DO NOT ALLOW OBSTACLES TO BLOCK WATER FLOW TO DRAINS.
- PROVIDE FIRE STOP AT EAVE ENDS TO PREVENT ENTRY OF FLAME OR MEMBERS UNDER ROOFING MATERIALS.
- VENTS AND ROOF STACKS SHALL PROJECT THE MINIMUM DISTANCE REQUALUIRED BY CODE. PAINT SUCH VENTS AND STACKS TO MATCH ROOF MATERIAL COLORS. LOCATE IN AREA LEAST VISIBLE FROM STREET / DRIVE AND CONCEAL IN DORMER VENT WHEN POSSIBLE. COORDINATE EXACT LOCATION WITH ARCHITECT
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- 18. PROVIDE INSECT SCREEN MESH AT ALL OPENINGS IN ROOF, INSECT SCREEN WITH MAX 1/4" OPENINGS
- 19. PROVIDE 5/8" EXPANSION JOINTS EVERY 30 FEET IN GUTTERS. SEE EAVE DETAIL FOR **GUTTER AND DOWN SPOUT MATERIALS.**
- 20. SEE ROOF PLAN AND EXTERIOR ELEVATIONS, EAVES DETAILS FOR DOWN SPOUT LOCATION, MATERIALS, FINISH. SIZE, AND WEATHER DOWN SPOUTS ARE CONCEALED OR EXPOSED.
- 21. DOWN SPOUTS AT FLAT ROOF SHALL BE A MINIMUM OF 4' WITH OVERFLOW PER U.B.C. 1506.3. PROVIDE OVERFLOW DRAINS WITH SEPARATE DRAIN LEADER PIPE. OVERFLOW DRAINS HAVING THE SAME AS THE ROOF DRAINS WITH THE INLET FLOW LINE LOCATED 2" ABOVE THE LOW POINT OF THE ROOF
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- 23. ROOF MATERIAL FASTENERS SHALL BE RATED TO SUSTAIN A MINIMUM WIND OF 80
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- 25. CONTRACTOR SHALL TEST ALL CONCEALED DOWN SPOUTS FOR WATER LEAKS PRIOR TO CONCEALING WORK BEHINC FINISHED MATERIALS. ALL ROOFING WORK TO COME WITH A MINIMUM 10 YEAR WARRANTY. WARRANTIES TO BE ISSUED TO OWNER PRIOR TO FINAL PAYMENT.
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- 32. SWEEP ROOF SURFACE BROOM CLEAN AND COVER KNOT HOLES WITH TIN.
- 33. WATER HEATER T&P LINE TERMINATION SHALL NOT BE LESS THAN 6-INCHES AND NOT MORE THAN 12-INCHES ABOVE GRADE PER MARICOPA COUNTY AMENDMENTS FOR IRC SECTION P2803.6.1



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636 E 6TH PLMESA, AZ

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DESCRIPTION

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TYPICAL FLOOR PLAN

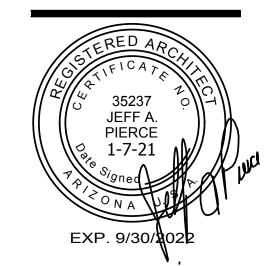DRAWN BY: **JGO** CHECKED BY: JSQ 3.03.2023

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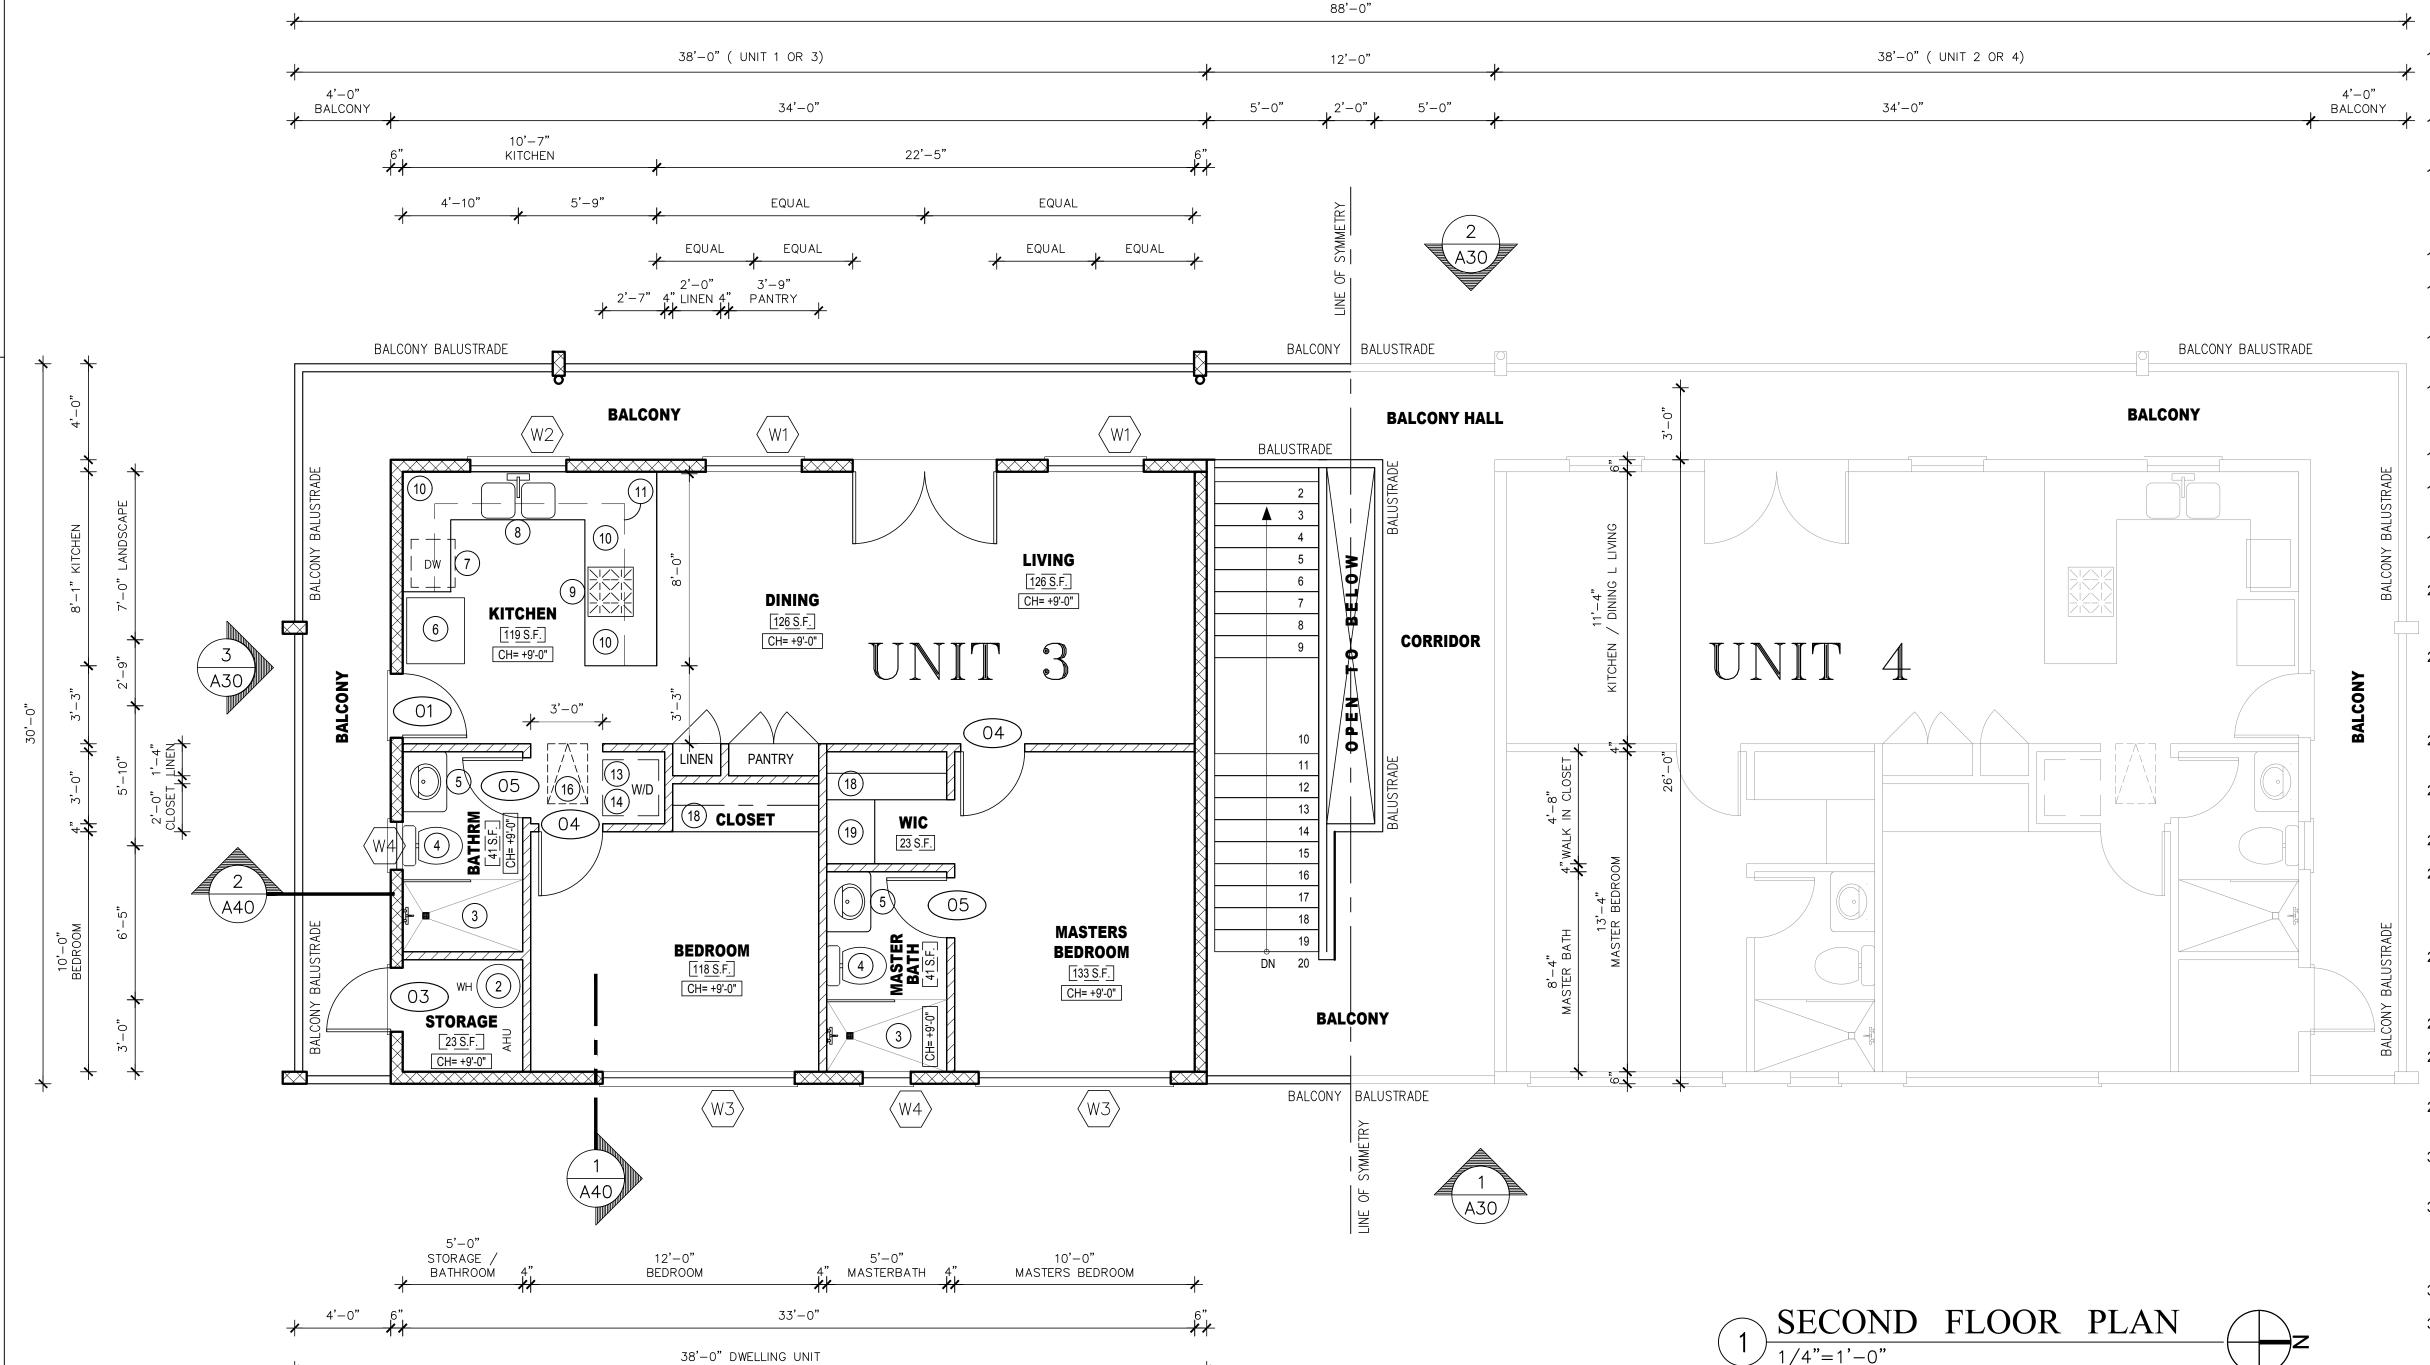
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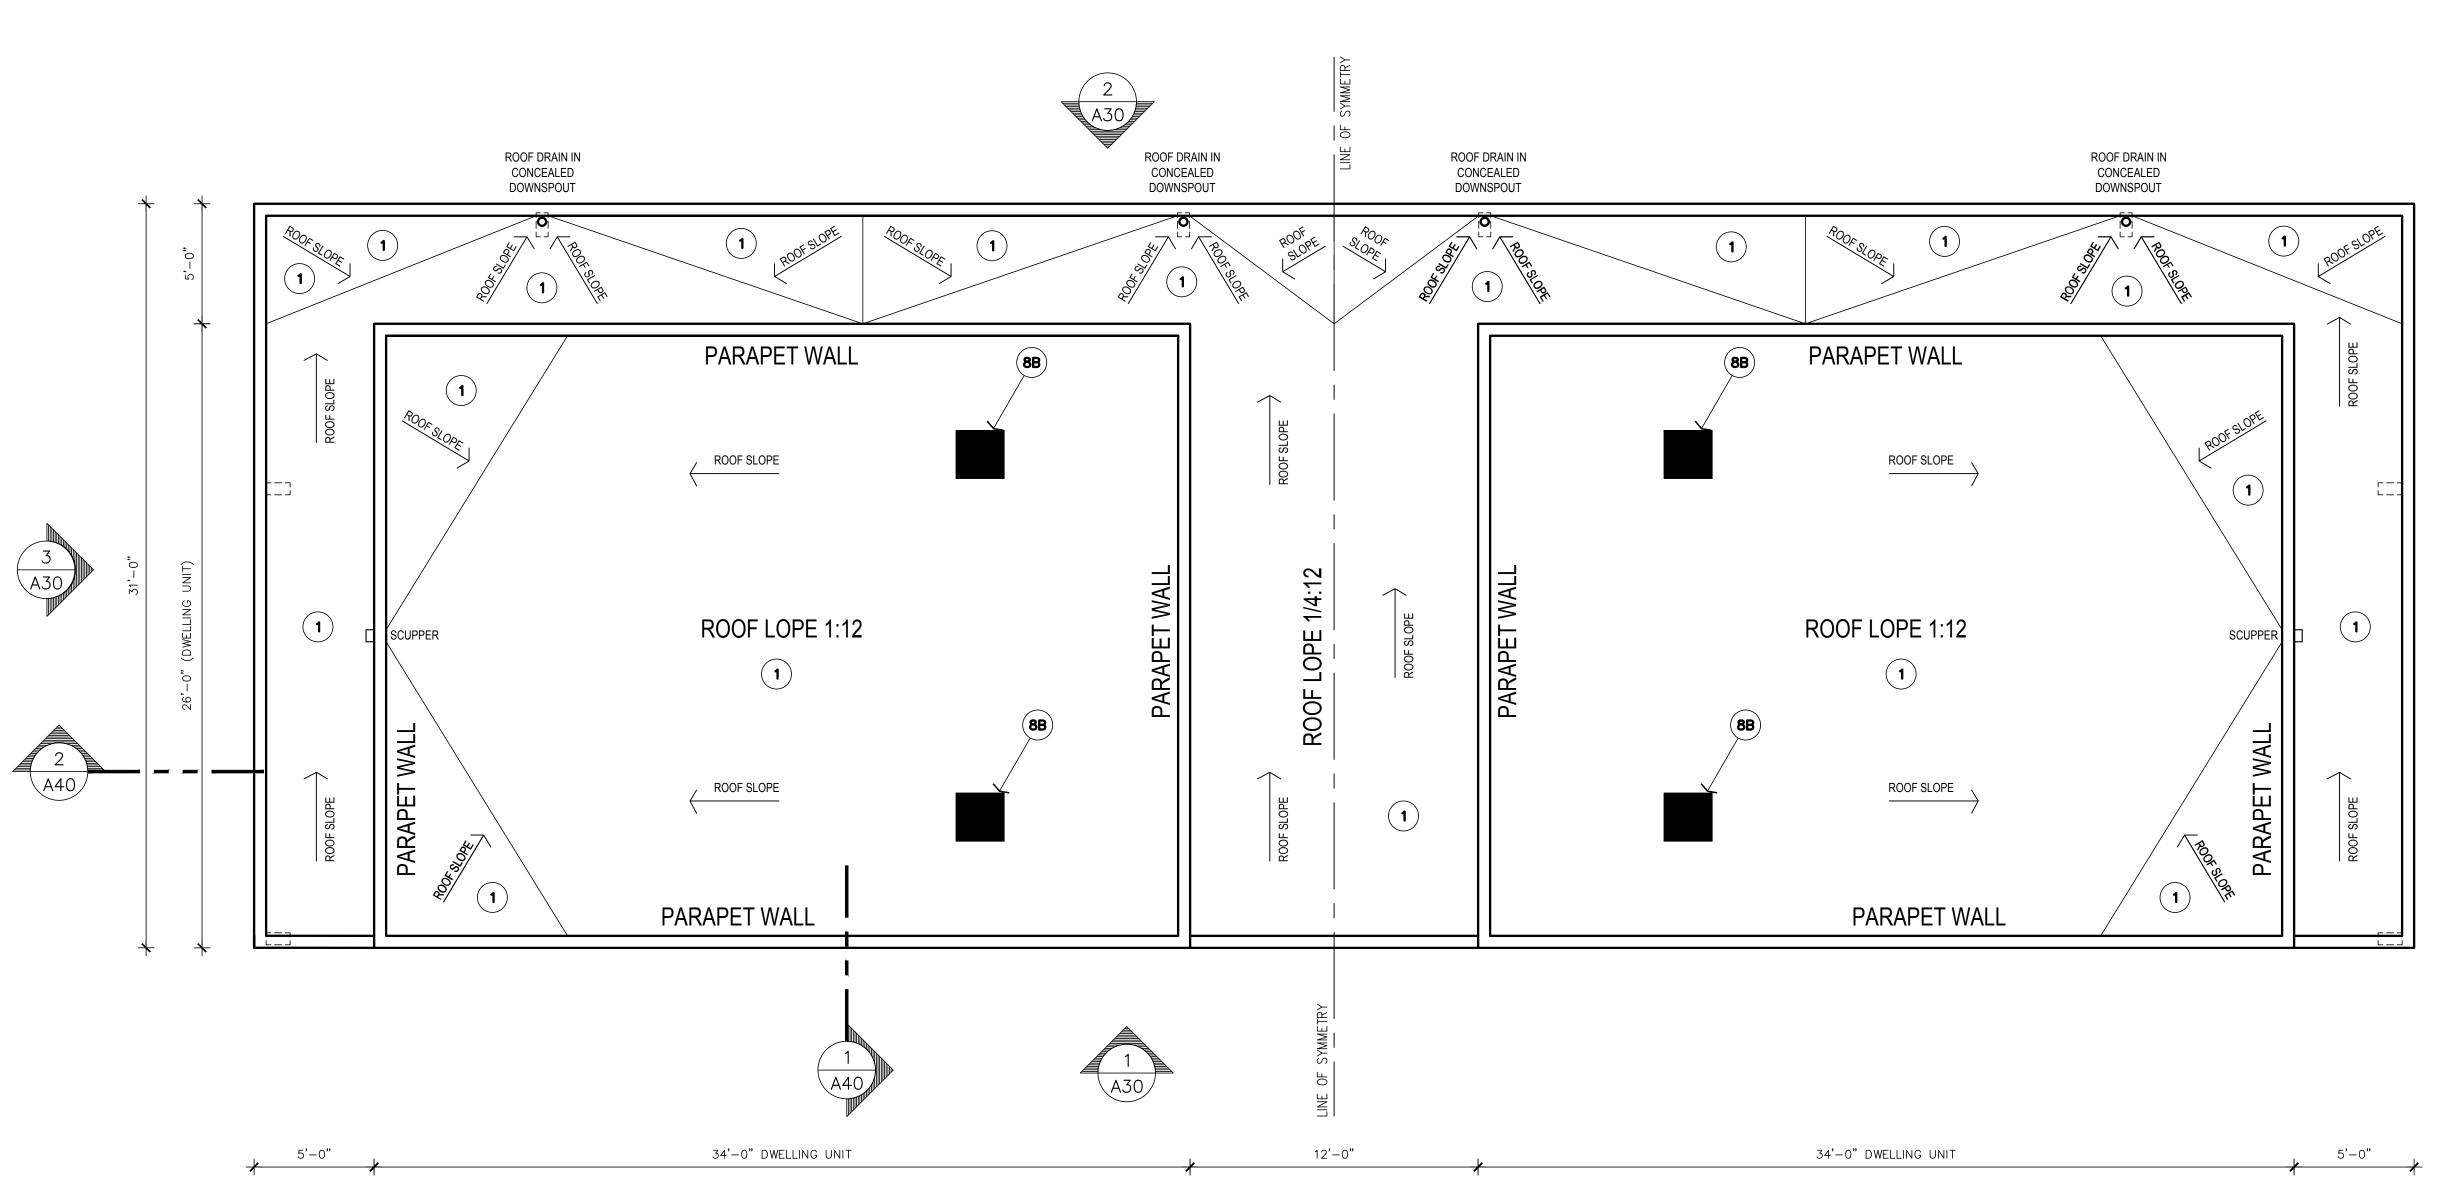


ROOF MATERIALS SPECIFICATIONS

- 1. REFER TO BID FOR ROOF FINISH
- 2. ALL FLAT ROOFS TO BE CLASS "A" TORCHED DOWN BITUMEN SYSTEM
- 3. ROOF UNDERLAYMENT FOR SLOPED ROOFS TO BE 2 LAYERS 30# FELT PAPER
- 4. PROVIDE SHEATHING PER STRUCTURAL WITH A MINIMUM 3/4' THICK MATERIAL
- 5. CAPABLE OF RESISTING ROOF LOAD6. ALL ROOFING MATERIALS TO A "CLASS A" FIRE RATING

SPRAY FOAM ROOFING NOTES:

SPRAY FOAM ROOFING SHALL BE MINIMUM 2" THICK SPRAYED IN PLACE. POLYURETHANE FOAM APPLIED TO PREPARED PLYWOOD DECK. ICC ER-3182 FOAM ROOFING ASSEMBLY, SYSTEM 3 BY RESIN TECHNOLOGY CORP. FINISH SHALL BE 3 COATS ACRYLIC ELASTOMERIC PAINT. THE 2ND COAT SHALL BE PIGMENTED TO MATCH HOUSE AND SHALL HAVE SILICA AGGREGATE BROADCAST ON WHILE PAINT IS STILL PLASTIC. A FINAL MIST COAT SHALL BE APPLIED IN SUFFICIENT QUANTITY TO INSURE ADHESION OF AGGREGATE. PROVIDE 24X24 RUBBER MAT SPLASH BLOCKS AT ALL PARAPET SLEEVES



90'-0"

GENERAL NOTES

- 1. ALL FLAT ROOFS ARE TO SLOPE A MINIMUM OF 2% TOWARDS ROOF DRAINS. ROUGH CARPENTER TO PROVIDE SHIMS BELOW ROOF SHEATHING TO ALLOW FOR PROPER SLOPE TO DRAIN. DO NOT ALLOW OBSTACLES TO BLOCK WATER FLOW TO DRAINS.
- PROVIDE FIRE STOP AT EAVE ENDS TO PREVENT ENTRY OF FLAME OR MEMBERS UNDER ROOFING MATERIALS.
- 3. VENTS AND ROOF STACKS SHALL PROJECT THE MINIMUM DISTANCE REQUIRED BY CODE. PAINT SUCH VENTS AND STACKS TO MATCH ROOF MATERIAL COLORS. LOCATE IN AREA LEAST VISIBLE FROM STREET / DRIVE AND CONCEAL IN DORMER VENT WHEN POSSIBLE. COORDINATE EXACT LOCATION WITH ARCHITECT.
- 4. ALL VENTS AND ROOF STACKS TO HAVE RAIN PROTECTION CAPS WHERE
- 5. PROVIDE CONTINUOUS WATERPROOFING AT ALL ROOF PENETRATIONS. ALL JOINTS IN FLASHING TO BE SOLDERED OR SEALED WITH MASTIC.
- 6. PROVIDE ATTIC DRAFT STOPS TO COMPLY WITH APPLICABLE CODES (IRC 302.12).
- 7. PROVIDE INSECT SCREEN MESH AT ALL OPENINGS IN ROOF. INSECT SCREEN WITH MAX 1/4" OPENINGS.
- 8. OVERFLOW DRAINS SHALL DISCHARGE TO AN APPROVED LOCATION AND SHALL NOT BE CONNECTED TO ROOF DRAIN LINES.
- 9. CONTRACTOR SHALL TEST ALL CONCEALED DOWN SPOUTS FOR WATER LEAKS PRIOR TO CONCEALING WORK BEHIND FINISHED MATERIALS. ALL ROOFING WORK TO COME WITH A MINIMUM 10 YEAR WARRANTY. WARRANTIES TO BE ISSUED TO OWNER PRIOR TO FINAL PAYMENT.
- 10. APPLY NAILING STANDARDS ARE PER LOCAL GOVERNING JURISDICTION.
- 11. USE CORROSION RESISTIVE NAILS AND FASTENERS. AVOID CONTACT BETWEEN DISSIMILAR METALS.
- 12. FOR FURNACES LOCATED IN ATTIC SPACES THEY MUST BE POSITIONED SO THAT THE REQUIRED FLUE LENGTH FROM THE FURNACE TO THE CAP IS PROVIDED WITHIN THE ATTIC, ALLOWING THE CAP TO BE A MINIMUM
- 13. SWEEP ROOF SURFACE BROOM CLEAN AND COVER KNOT HOLES WITH

HEIGHT ABOVE THE FINISHED ROOFING ALLOWED BY CODE.

KEYNOTES:

1		LIQUID -APPLIED ACRYLIC COATING APPLIED LYURETHANE FOAM PLASTIC INSULATION. ICC
		LASTIC INSULATION SHALL BE A TWO IED, POLYURETHANE FOAM PLASTIC INSULATION 2.5-3.0 PCF .
	MANUFACTURED BY HUNTS	MAN BUILDING SOLUTIONS LLC OR EQUIVALENT
2		
3	STUCCO SYSTEM (IAPMO ERACOLOR: BRUSHED CLAY, DUN	
4	SCUPPER DRAIN TOTAL ROOF AREA: FLAT ROO RAINFALL RATE: 6-INCH PER I- DRAIN SIZE: 4" @ 3,070 SF PEI 1,850 SF / 3,070 SF PER DRAIN PROVIDED: 2 - 4"x4" SCUPPER	R DRAIN I = 0.60 OR 1 DRAIN NEEDED
6	STUCCO SYSTEM (IAPMO ER/ COLOR: CASCADING WHITE, I	
	ROOF VENTILATION CALCULA NET FREE AREA REQUIRED P	
	SLOPED ROOF TOTAL AREA: CALCULATION:	1,675 SF 1,675 SF / 300 = 5.58 SF 5.60 X 144 = 803.52 SQ. IN. REQUIRED
	AVAILABLE VENTS:	12 IN. DIA (KP-12) KEEPA VENT AN ALUMINUM ROOF VENT FOR FLAT ROOFS 113 SQ.IN. NET FREE AREA (NFA)
		MASTERFLOW GAF DA1424 14" x 24" 141 SQ.IN. NET FREE AREA (NFA)
	VENT PROVIDED:	1016 SQ.IN TOTAL VENT AREA PROVIDED
8B		12 IN. DIA (KP-12) KEEPA VENT AN ALUMINUM ROOF VENT FOR FLAT ROOFS 113 SQ.IN X 4 = 452 SQ.IN. PROVIDE 4 VENTS FOR HIGH / EXHAUST VENT
8A		MASTERFLOW GAF DA1424 181 SQ.IN X 4 = 564 SQ.IN. PROVIDE 2 VENTS FOR LOW / INTAKE VENTS
9	MECHANICAL CONDENSING L PROVIDE STRUCTURAL MOUI	INITS INSTALLED ABOVE ROOF. NTING SUPPORT.

7//

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PROJECT NAME / LOCATION

APN 135-16-041 TWO STOREY QUADPLEX

554 W RIO SALADO PKWY, MESA, ARIZONA 85201-4008

OWNER NAME / ADDRESS

JOSE CARREON / NATIONAL CONSULTING GROUP LLC

636 E 6TH PLMESA, AZ 85203-6302

#	REVISION DESCRIPTION	DATE
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Н		


SHEET CONTENTS


TYPICAL FLOOR PLAN

DRAWN BY: JGO
CHECKED BY: JSQ
DATE: 3.03.2023

SHEET NUMBER

A2024" X 36" PAPER SIZE

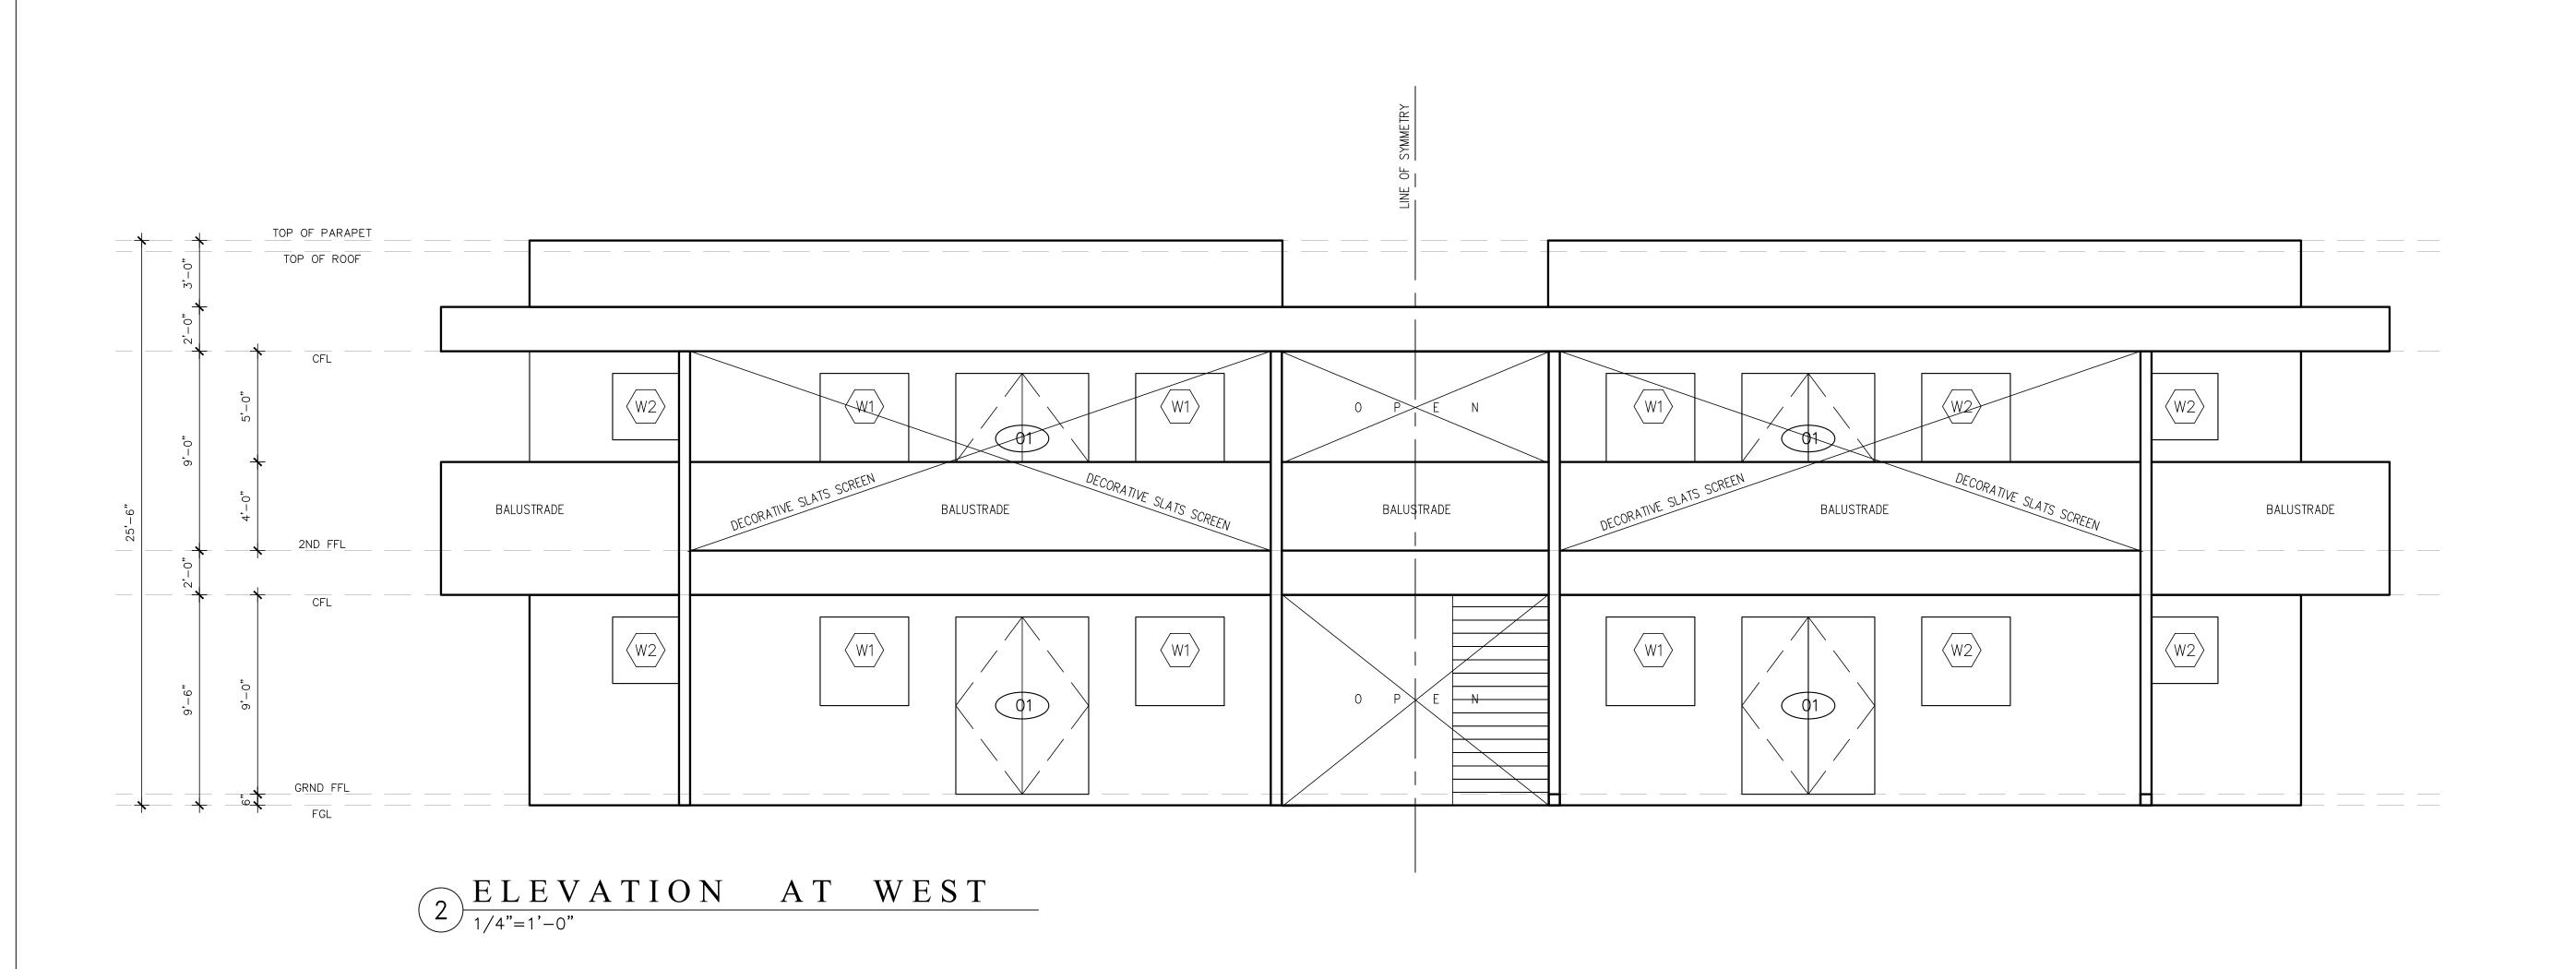

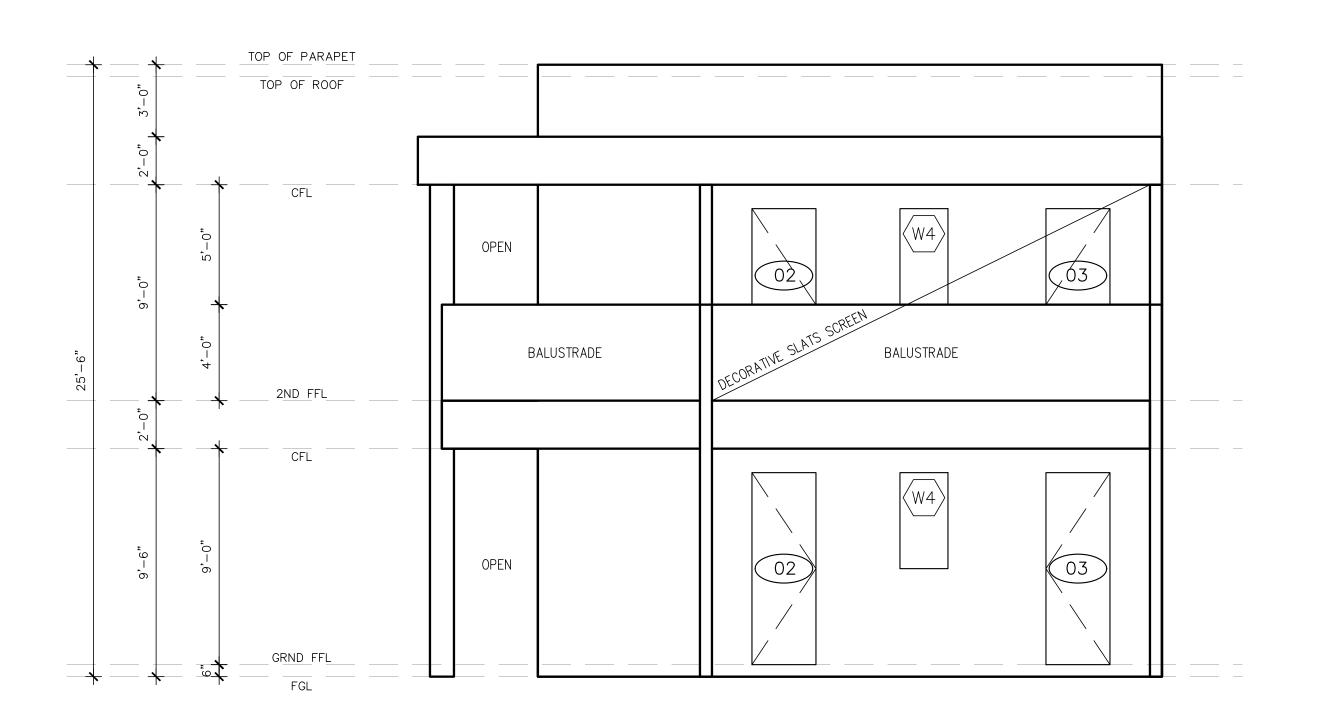

 $\underbrace{\frac{ELEVATION}{1/4"=1"-0"}} AT \underbrace{SOUTH}$

KEYNOTES:

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8A		MASTERFLOW GAF DA1424 181 SQ.IN X 4 = 564 SQ.IN. PROVIDE 2 VENTS FOR LOW / INTAKE VENTS

DOORS & WINDOWS SCHEDULE

	DOORS			FRAMES / FINISH	
NO.	ROOM NAME SIZE		MATERIAL		REMARKS
01) MAIN ENTRANCE/EXIT	2'-8" x 8'-0"	SOLID CORE WOOD DOOR	SOLID WOOD / PAINTED	PANEL DOOR
02	LIVING / DINING	6'-0" x 8'-0"	SOLID CORE WOOD DOOR	SOLID WOOD / PAINTED	FRENCH DOOR
03) STORAGE	2'-8" x 8'-0"	HONEYCOMB CORE WOOD DOOR	SOLID WOOD / PAINTED	PANEL DOOR
04) BEDROOMS	2'-4" x 8'-0"	HONEYCOMB CORE WOOD DOOR	SOLID WOOD / PAINTED	PANEL DOOR
05) BATHROOMS	2'-4" x 8'-0"	HONEYCOMB CORE WOOD DOOR	SOLID WOOD / PAINTED	PANEL DOOR

NO.	QTY.	SIZE (WxH)	MATERIAL	HDR. HT.	DUAL GLAZED	TEMPERED	REMARKS
W1	2	4'-0" x 5'-0"	VINYL/TEMPERED GLASS	8'-0"	•	•	SLIDING WINDOV
W2	1	4"-0" x 4'-0"	VINYL/TEMPERED GLASS	8'-0"	•	•	SLIDING WINDOV
(W3)	2	8'-0" x 4'-0"	VINYL/TEMPERED GLASS	8'-0"	•	•	SLIDING WINDOV
W4	2	2'-0" x 4'-0"	VINYL/TEMPERED GLASS	8'-0"	•	•	SMOKED AWNING

	INSULATION A	ND FENESTRATIO	N	
MAX U-FACTOR	MAX SHGC	CEILING R-VALUE	WALL R-VALUE	FLOOR R-VALUE
0.40	0.25	38	13	13

NOTE *= ALL VALUES SHALL MEET OR EXCEED THE MINIMUMS PROVIDED BY THIS TABLE WHEN SHOWING COMPLIANCE WITH THIS METHOD.

7///

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636 E 6TH PLMESA, AZ 85203-6302

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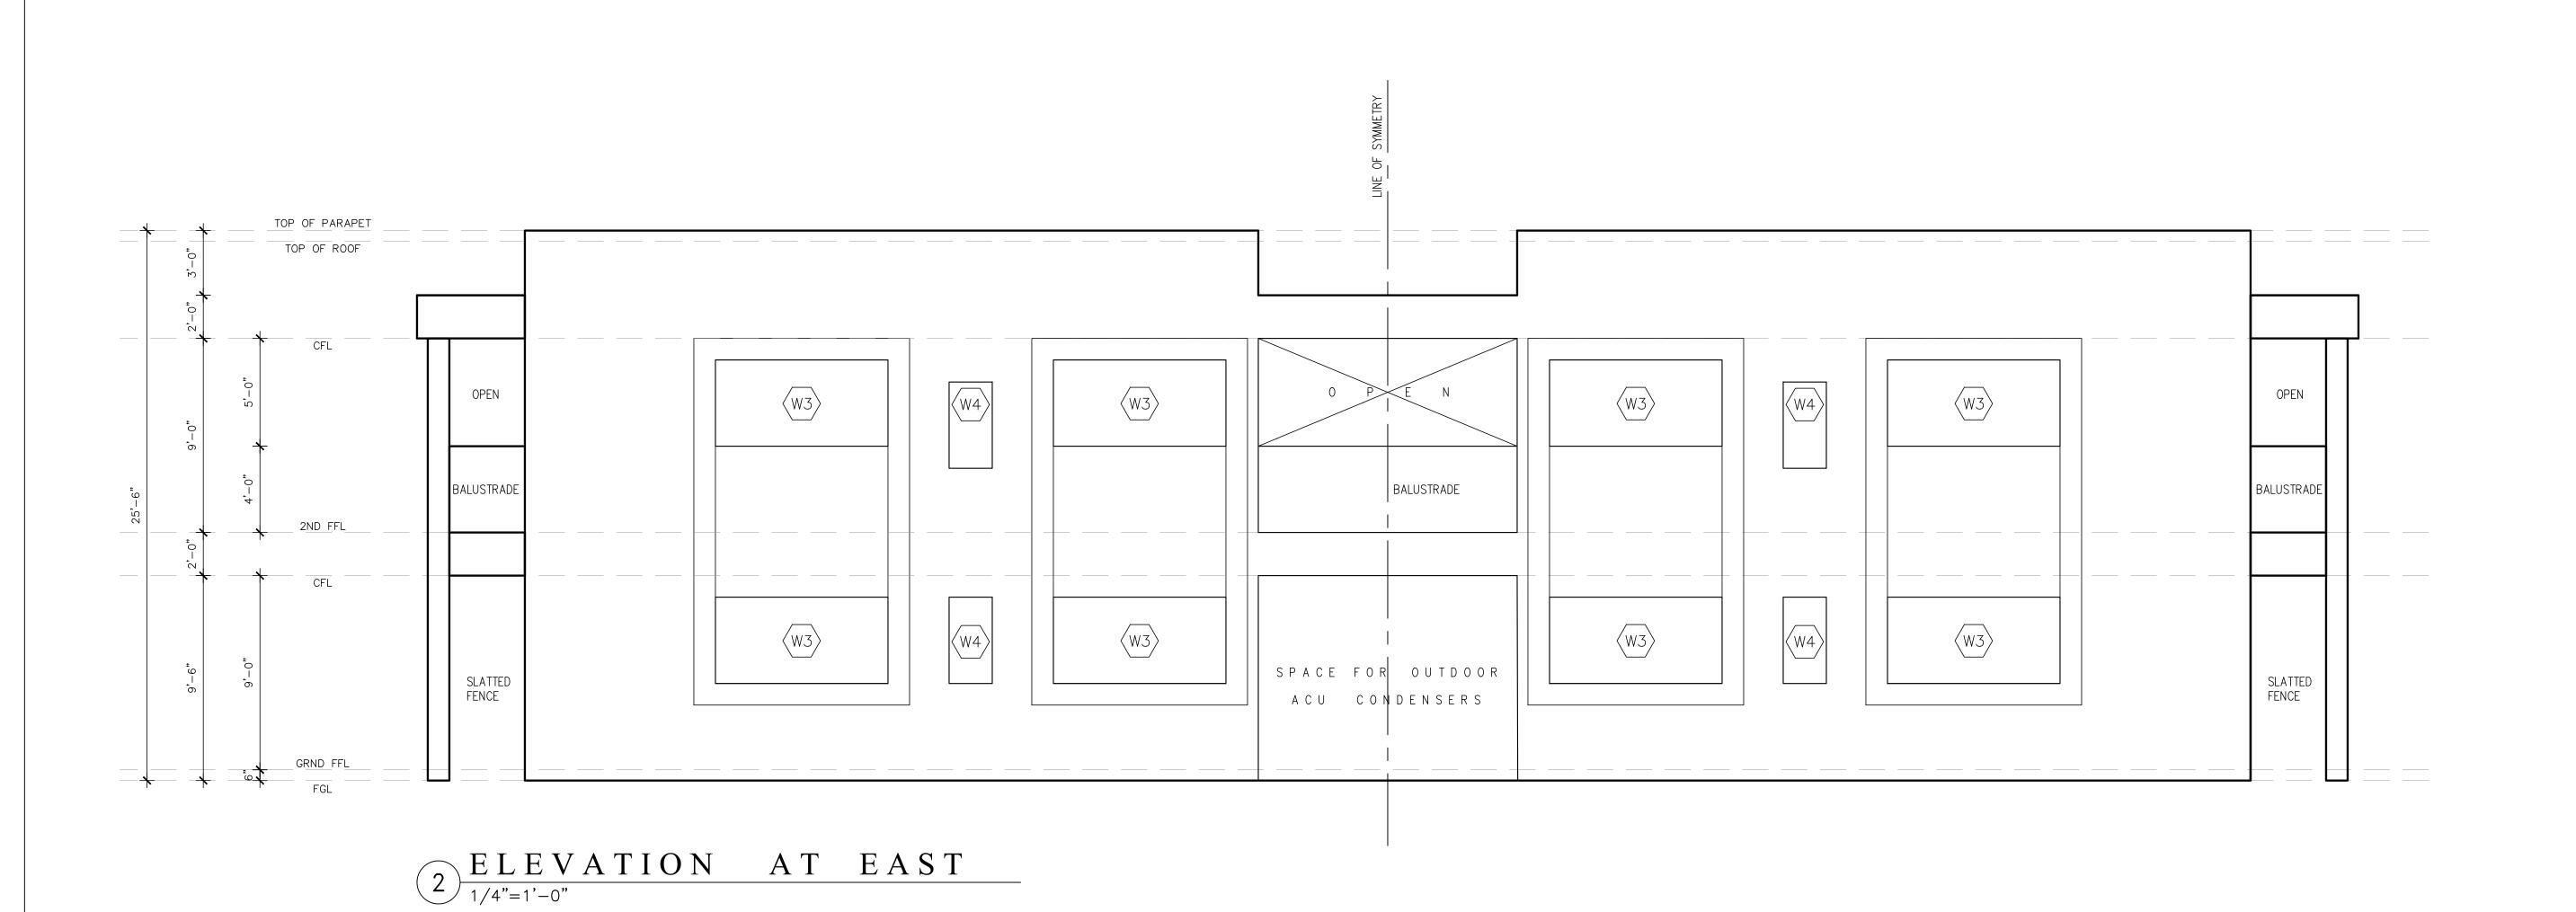
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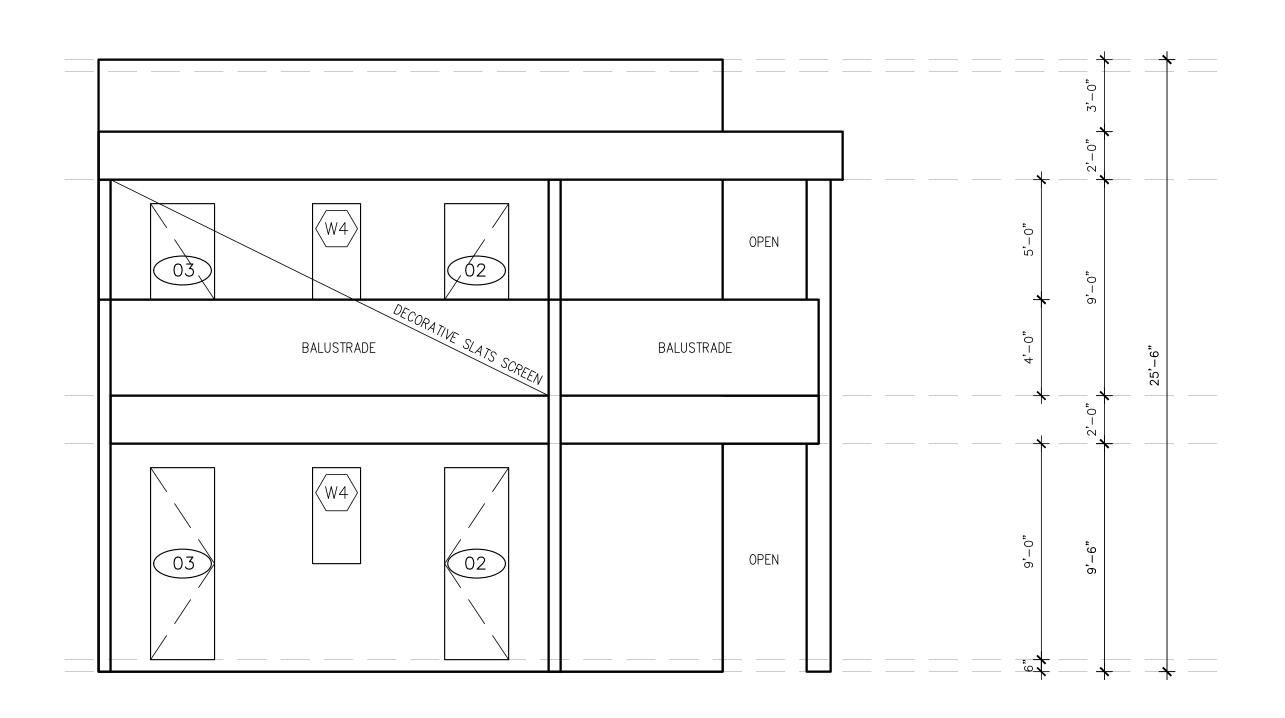
ELEVATIONS

DRAWN BY: JGO
CHECKED BY: JSQ
DATE: 3.03.2023

SHEET NUMBER

A3024" X 36" PAPER SIZE





 $\underbrace{\frac{ELEVATION}{\frac{1}{4"=1'-0"}}AT \quad NORTH}_{1/4"=1'-0"}$

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	DOORS			FRAMES / FINISH		
NO.	ROOM NAME	SIZE	MATERIAL		REMARKS	
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W4	2	2'-0" x 4'-0"	VINYL/TEMPERED GLASS	8'-0"	•	•	SMOKED AWNING

NOTE *= SAFETY GLAZING AS PER R308.4

	INSULATION A	ND FENESTRATIO	N	
MAX U-FACTOR	MAX SHGC	CEILING R-VALUE	WALL R-VALUE	FLOOR R-VALUE
0.40	0.25	38	13	13

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636 E 6TH PLMESA, AZ 85203-6302

#	REVISION DESCRIPTION	DATE
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SHEET CONTENTS

ELEVATIONS

DRAWN BY: JGO
CHECKED BY: JSQ
DATE: 3.03.2023

SHEET NUMBER

A3024" X 36" PAPER SIZE

TOP OF PARAPET TOP OF ROOF OPEN BALCONY 2ND FFL CFL OPEN GRND FFL FGL

 $\frac{TRANSVERSE}{\frac{1}{4"=1'-0"}} SECTION$

GENERAL NOTES

- A. BOTTOM PLATES SHALL BE PRESSURE TREATED WITH BORATE PER GREEN BUILDING CHECKLIST.
- B. SEE STRUCTURAL DRAWINGS FOR FRAMING SPECIFICATIONS OR DETAIL SHEETS FOR THE FOLLOWING INFORMATION: 1. NAILING SCHEDULE

2. RIPPER ATTACHMENT (WHERE APPLICABLE) 3. CEILING JOIST SCHEDÙLE

C. FIRE BLOCKING NOTES (SHALL COMPLY WITH R602.8) 1. IN CONCEALED SPACES OF STUD WALLS AND PARTITION, IN INCLUDING FURRED SPACES AND PARALLEL ROWS OF STUDS OR STAGGERED STUDS; AS FOLLOWS:

> 1.1 VERTICAL AT THE CEILING AND FLOOR LEVELS 1.2 HORIZONTAL AT INTERVALS NOT EXCEEDING 10 FEET

> 2. AT ALL INTERCONNECTIONS BETWEEN CONCEALED VERTICAL AND HORIZONTAL SPACES SUCH AS OCCUR AT SOFFITS, DROP CEILING AND COVE CEILING.

3. IN CONCEALED SPACES BETWEEN STAIR STRINGER AT THE TOP AND BOTTOM OF THE RUN. ENCLOSED SPACE UNDER STAIR SHALL COMPLY WITH SECTION R311.2.2

4. AT THE OPENING AROUND VENTS, PIPE AND DUCTS AT THE CEILING AND FLOOR LEVEL, WITH AN APPROVED MATERIAL TO RESIST THE FREE PASSAGE OF FLAME AND PRODUCTS OF COMBUSTION.

5. FOR THE FIRE BLOCKING OF CHIMNEY AND FIREPLACE, SEE SECTION R1001.16

6. FIREBLOCKING OF CORNICES OF A TWO-FAMILY DWELLING IS REQUIRED AT THE LINE OF DWELLING UNIT SEPARATION.

LEGEND:





2X4 STUDS SPACED AT 16" O.C W/ SCHEDULED SHEATHING PANEL (SEE STRUCTURAL DRAWINGS) ON BOTH SIDES OF WALL

KEYNOTES:

- $\frac{1}{2}$ " PLYWOOD SOFFIT ATTACHED TO STUDS ON EXTERIOR SIDE OF WALL
- 2x6 WOOD FASCIA WITH 1X2 WOOD TRIM WRAPPED WITH 26 GA GI
- ASPHALT SHINGLES ASTM D3018 TYP. ICC-ESR-1475 AND ICC-AC438-ESR-3267 COLOR: PEWTER GREY BRAND: TIMBERLINE
- 4 R-19 WALL INSULATION
- 5 R-38 ROOF INSULATION
- ENGINEERED TRUSS FRAMING TO STRUCTURAL ENGINEER REQUIREMENTS
- FOUNDATION PER PLAN
- 8 2x6 PARAPET STUDS @ 16" O.C.
- 9 2X PRESSURE TREATED PLATE WITH 1/2 Ø A.B.S. SEE STRUCTURAL PLAN FOR SPACING
- 10 2X PLATE W/ 16d NAILS AT 12" O.C.
- ROOF SHEATHING PER GSN 12 FLAT ROOF BUILT-UP WITH LIQUID -APPLIED ACRYLIC COATING

APPLIED OVER A SPRAY-APPLIED POLYURETHANE FOAM PLASTIC

- INSULATION. ICC ESR-3916.
- 13 | FLOOR FINISH AS SCHEDULED 14 $\frac{1}{2}$ " SAG RESISTANT GYPSUM BOARD. PAINTED FINISH.
- 15 POWDERCOATED ALUMINIUM COPING WITH ¹/₂" THK PLYWOOD BACKING.
- COLOR TO MATCH WALL FINISH 16 | 4"x4" SCUPPER DRAIN
- 17 ALUMINUM FLASHING FIXED TO WALL
- 18 ROOF VENT
- 2X4 STUDS SPACED AT 16" O.C W/ 1/2" GYPSUM BOARD ON BOTH SIDES OF WALL
- 2X6 STUDS SPACED AT 16" O.C W/ 1/2" GYPSUM BOARD ON BOTH
- SIDES OF WALL. INSULATION SHALL BE 2".
- 21 6X6 CAST ALUMINUM BAND
- 22 2X10 CEILING JOISTS
- 23 BEAM OR WALL WHERE OCCURS. REFER TO STRUCTURAL DRAWINGS
- 24 MASTERFLOW GAF DA1212 12" x 12" 60 SQ.IN. NET FREE AREA (NFA) 25 2x CANTILEVER ROOF RAFTERS OVER COVERED PATIO

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DWELLING SECTIONS

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