
| CODE COMPLIANCE | |
|---|---|
| ALL WORK AND MATERIALS SHALL BE PERFORMED AND INSTALLED IN ACCORDANCE WITH THE CURRENT EDITIONS OF THE FOLLOWING CODES AS ADOPTED BY THE LOCAL GOVERNING AUTHORITIES. NOTHING IN THESE PLANS IS TO BE CONSTRUED TO PERMIT WORK NOT CONFORMING TO THESE CODES. | |
| 2018 INTERNATIONAL BUILDING CODE WITH LOCAL AMENDMENTS 2018 INTERNATIONAL FIRE CODE (IFC) 2018 INTERNATIONAL ENERGY CONSERVATION CODE | |
| PROJECT TEAM | VICINITY M |
| SITE APPLICANT: NAME: GIGAPOWER, LLC ADDRESS: 311 S. AKARD STREET, 21ST FLOOR CITY, STATE, ZIP: DALLAS, TX 75202 CONTACT: TERRY SHAKESHAFT EMAIL: ts499d@att.com CITV. ENGINEER: INFRASTRUCTURE PARTNERS NAME: J5 INFRASTRUCTURE PARTNERS ADDRESS: P.O. BOX 190 CITY, STATE, ZIP: MIDVALE, UTAH 84074 CONTACT: KEVIN MILLER PHONE: (720) 296-6180 ELECTRICAL ENGINEER: NAME: NAME: J5 INFRASTRUCTURE PARTNERS ADDRESS: 23 MAUCHLY #110 CITY, STATE, ZIP: IRVINE, CA 92618 PROPERTY OWNER: NAME: NAME: VELDA ROSE METHODIST CHURCH OF MESA ADDRESS: 5540 E APACHE TRAIL CITY, STATE, ZIP: MESA, AZ 85205 | STE |
| SITE INFORMATION | GENERAL CONTRA |
| JURISDICTION:CITY OF MESAWIND LOADS:N/AEXPOSURE CATEGORY:CSEISMIC ZONE:1FLOOD ZONE:PARCEL ID #:141-77-057FZONING:LCLATITUDE (NAD 83):33.417403° | DO NOT SCALE DRAWINGS THESE PLANS ARE FORMATTED TO BE FULL SIZE AT 24" X PLANS AND EXISTING DIMENSIONS AND CONDITIONS IMMEDIATELY NOTIFY THE ARCHITECT/ENGINEER IN WI PROCEEDING WITH THE WORK OR MATERIAL ORDERS |
| Longitude (NAD 83): -111.711459° Accessibility requirements: Facility is an unmanned equipment | HABITATION |
| SPACE NOT INTENDED FOR HUMAN HABITATION AND ONLY FREQUENTLY VISITED BY MAINTENANCE PERSONAL. ACCESSIBILITY IS NOT REQUIRED PER IBC 2018, SECTION 1103.2.9 (EQUIPMENT SPACES) | THE FACILITY IS UNMANNED AND NOT FOR HUMAN HA AS REQUIRED FOR ROUTINE MAINTENANCE. THE PROJE DISTURBANCE OR EFFECT ON DRAINAGE; NO SANITAE TRASH DISPOSAL IS REQUIRED AND NO COMMERCIAL |
| | STATEMEN |
| POWER AGENCY: TBD TELCO PROVIDER: TBD | STRUCTURAL ANALYSIS IS NOT WITHIN THE SCOPE OF W FOR ANALYSIS OF EXISTING AND/OR PROPOSED COM PROVIDED UNDER SEPARATE COVER. |
| | |



SITE NUMBER: SITE NAME: SITE TYPE: ADDRESS:

PARCEL ID:

AZ-001 MESA EAST HUT/GENERATOR ADD 5540 EAST MAIN STREET MESA, AZ 85205 141-77-057F

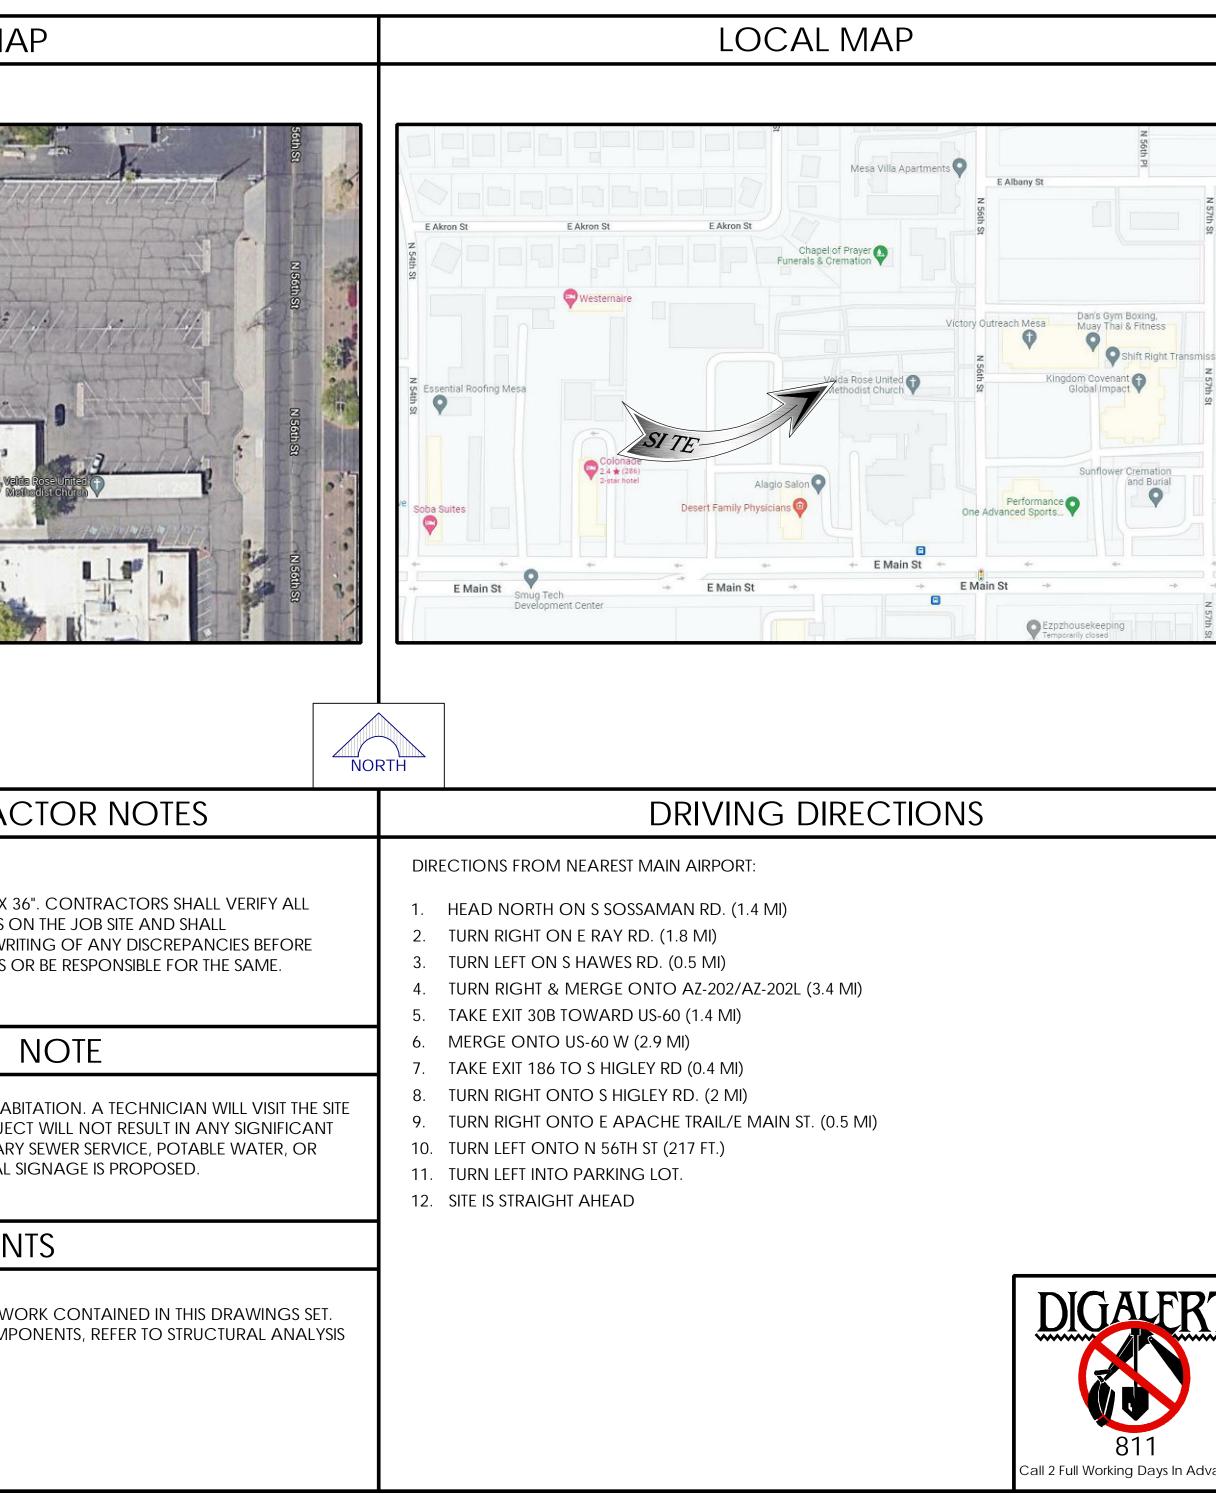

| | PROJECT DESCRIPTION | PREPARED FOR CECAPOLITER SITE SAKARD STREET , 21ST FLOOR DALLAS, TX 75202 Vendor: Vendor: SEMERASTRUCTURE 23 MAUCHLY #110 IRVINE, CA 92618 J5 PROJECT ID: P-074358 Issued For: AZ2-001 MESA EAST S540 EAST MAIN STREET MESA, AZ 85205 DALLAS, AZ 85205 |
|--|---|--|
| sions | PROPOSED SITE BUILD OF AN UNMANNED TELECOMMUNICATIONS ACIUITY, CONSISTING OF THE FOLLOWING: GUIPMENT SOW: INSTALLATION OF A GIGAPOWER 23'-0" X 55'-0" (1265 SQ. FT.) TELECOMMUNICATION COMPOUND LEASE AREA INSTALLATION OF A GIGAPOWER 23'-0" X 55'-0", 8'-0" HIGH SLUMP BRICK WALL TO MATCH EXISTING BUILDING INSTALLATION OF (1) GIGAPOWER 10-0' X 20'-0" EQUIPMENT HUT WITH A PRE-FABRICATED HUT FOUNDATION INSTALLATION OF (1) GIGAPOWER 10-0' X 20'-0" EQUIPMENT HUT WITH A PRE-FABRICATED HUT FOUNDATION INSTALLATION OF (1) GIGAPOWER 10-0' X 20'-0" EQUIPMENT HUT WITH A PRE-FABRICATED HUT FOUNDATION INSTALLATION OF (1) GIGAPOWER 10-0' X 20'-0" EQUIPMENT HUT WITH A PRE-FABRICATED HUT FOUNDATION INSTALLATION OF (1) GIGAPOWER 10-0' X 20'-0" EQUIPMENT HUT WITH A PRE-FABRICATED HUT FOUNDATION INSTALLATION OF (1) GIGAPOWER 10-0' X 20'-0" EQUIPMENT HUT WITH A PRE-FABRICATED HUT FOUNDATION INSTALLATION OF (1) GIGAPOWER 10-0' X 20'-0" EQUIPMENT HUT WITH A PRE-FABRICATED HUT FOUNDATION REMOVAL OF PARKING ISLAND AND STRIPING IN PARKING RE-STRIPING OF PARKING ISLAND AND STRIPING IN PARKING RE-STRIPING OF PARKING AREA CONSTRUCTION OF NEW 8' WIDE PARKING ISLAND INSTALLATION OF (2) NEW SECTIONS OF WROUGHT IRON FENCE ROJECT AREA: 23'-0" X 55'-0" (1265 SQ. FT.) LEASE AREA | PARCEL ID: 141-77-057F DRAWN BY: JSP CHECKED BY: KM REV DATE DESCRIPTION A 1/25/23 90% ZD ID ID |
| (((1)))))))))))))))) | SHEET INDEX REV. T-1 TITLE SHEET A GN-1 GENERAL NOTES A GN-2 GENERAL NOTES A GN-3 SITE SIGNAGE A 1A 1A CERTIFICATION A-1 SITE PLAN A A-1.1 DEMO PLAN A A-1.2 PARKING SPACE REMOVAL A A-1.3 NEW PARKING CONSTRUCTION AND RE-STRIPING PLAN A A-2 ENLARGED SITE PLAN & COMPOUND PLAN A A-3 ELEVATIONS A | Licensor: Sheet Title: TITLE SHEET Sheet Number: T1 |

GENERAL CONSTRUCTION NOTES

- 1. PLANS ARE INTENDED TO BE DIAGRAMMATIC OUTLINE ONLY, UNLESS NOTED OTHERWISE, THE WORK SHALL INCLUDE FURNISH APPURTENANCES AND LABOR NECESSARY TO COMPLETE ALL INSTALLATIONS AS INDICATED ON THE DRAWINGS.
- 2. THE CONTRACTOR SHALL OBTAIN, IN WRITING, AUTHORIZATION TO PROCEED BEFORE STARTING WORK ON ANY ITEM NOT CL THE CONTRACT DOCUMENTS.
- 3. CONTRACTOR SHALL CONTACT USA (UNDERGROUND SERVICE ALERT) AT (800) 227-2600, FOR UTILITY LOCATIONS, 48 HOURS EXCAVATION, SITE WORK OR CONSTRUCTION,
- 4. THE CONTRACTOR SHALL INSTALL ALL EQUIPMENT AND MATERIALS IN ACCORDANCE WITH MANUFACTURER'S RECOMMEND INDICATED OTHERWISE, OR WHERE LOCAL CODES OR REGULATIONS TAKE PRECEDENCE
- 5. ALL CONSTRUCTION SHALL BE IN ACCORDANCE WITH THE IBC / UBC'S REQUIREMENTS REGARDING EARTHQUAKE RESISTANC PIPING, LIGHT FIXTURES, CEILING GRID, INTERIOR PARTITIONS, AND MECHANICAL EQUIPMENT. ALL WORK MUST COMPLY WIT AND REGULATIONS.
- REPRESENTATIONS OF TRUE NORTH, OTHER THAN THOSE FOUND ON THE PLOT OF SURVEY DRAWINGS, SHALL NOT BE USED TO OF TRUE NORTH AT THE SITE. THE CONTRACTOR SHALL RELY SOLELY ON THE PLOT OF SURVEY DRAWING AND ANY SURVEYOR ESTABLISHMENT OF TRUE NORTH, AND SHALL NOTIFY THE ARCHITECT / ENGINEER PRIOR TO PROCEEDING WITH THE WORK IF BETWEEN THE VARIOUS FLEMENTS OF THE WORKING DRAWINGS AND THE TRUE NORTH ORIENTATION AS DEPICTED ON THE CL SHALL ASSUME SOLE LIABILITY FOR ANY FAILURE TO NOTIFY THE ARCHITECT / ENGINEER.
- 7. THE BUILDING DEPARTMENT ISSUING THE PERMITS SHALL BE NOTIFIED AT LEAST TWO WORKING DAYS PRIOR TO THE COMMEN OTHERWISE STIPULATED BY THE CODE ENFORCEMENT OFFICIAL HAVING JURISDICTION.
- 8. DO NOT EXCAVATE OR DISTURB BEYOND THE PROPERTY LINES OR LEASE LINES, UNLESS OTHERWISE NOTED.
- 9. ALL EXISTING UTILITIES, FACILITIES, CONDITIONS, AND THEIR DIMENSIONS SHOWN ON THE PLAN HAVE BEEN PLOTTED FROM A ARCHITECT / ENGINEER AND THE OWNER ASSUME NO RESPONSIBILITY WHATSOEVER AS TO THE SUFFICIENCY OR THE ACCUR SHOWN ON THE PLANS, OR THE MANNER OF THEIR REMOVAL OR ADJUSTMENT. CONTRACTORS SHALL BE RESPONSIBLE FOR OF ALL EXISTING UTILITIES AND FACILITIES PRIOR TO START OF CONSTRUCTION. CONTRACTORS SHALL ALSO OBTAIN FROM EA INFORMATION RELATIVE TO WORKING SCHEDULES AND METHODS OF REMOVING OR ADJUSTING EXISTING UTILITIES
- 10. CONTRACTOR SHALL VERIFY ALL EXISTING UTILITIES, BOTH HORIZONTAL AND VERTICALLY, PRIOR TO THE START OF CONSTRUCT DOUBTS AS TO THE INTERPRETATION OF PLANS SHOULD BE IMMEDIATELY REPORTED TO THE ARCHITECT / ENGINEER FOR RESC NO FURTHER WORK SHALL BE PERFORMED UNTIL THE DISCREPANCY IS CHECKED AND CORRECTED BY THE ARCHITECT / ENG INSTRUCTION MEANS CONTRACTOR WILL HAVE WORKED AT HIS/HER OWN RISK AND EXPENSE.
- 11. ALL NEW AND EXISTING UTILITY STRUCTURES ON SITE AND IN AREAS TO BE DISTURBED BY CONSTRUCTION SHALL BE ADJUSTED FINAL INSPECTION OF WORK.
- 12. ANY DRAIN AND/OR FIELD TILE ENCOUNTERED / DISTURBED DURING CONSTRUCTION SHALL BE RETURNED TO IT'S ORIGINAL COMPLETION OF WORK. SIZE, LOCATION AND TYPE OF ANY UNDERGROUND UTILITIES OR IMPROVEMENTS SHALL BE ACCUR. "AS-BUILT" DRAWINGS BY GENERAL CONTRACTOR, AND ISSUED TO THE ARCHITECT / ENGINEER AT COMPLETION OF PROJEC
- 13. ALL TEMPORARY EXCAVATIONS FOR THE INSTALLATION OF FOUNDATIONS, UTILITIES, ETC., SHALL BE PROPERLY LAID BACK O CORRECT OCCUPATIONAL SAFETY AND HEALTH ADMINISTRATION (OSHA) REQUIREMENTS.
- 14. INCLUDE MISC. ITEMS PER GIGAPOWER SPECIFICATIONS
- 15. IT IS A VIOLATION OF LAW FOR ANY PERSONS, UNLESS THEY ARE ACTING UNDER THE DIRECTION OF A LICENSED PROFESSIONAL ENGINEER, TO ALTER THIS DOCUMENT
- 16. ALL (N) CABLING AND EQUIPMENT MUST BE INSTALLED AND USED IN ACCORDANCE WITH THE PRODUCT'S INCLUDED INSTRUCTIONS, LISTING AND/OR LABELING REQUIREMENTS. PER NEC SECTION 110.3(B)
- 17. THE FACILITY IS UNMANNED AND NOT FOR HUMAN HABITATION. A TECHNICIAN WILL VISIT THE SITE AS REQUIRED FOR ROUTINE MAINTENANCE. THE PROJECT WILL NOT RESULT IN ANY SIGNIFICANT DISTURBANCE OR EFFECT ON DRAINAGE; NO SANITARY SEWER SERVICE, POTABLE WATER, OR TRASH DISPOSAL IS REQUIRED AND NO COMMERCIAL SIGNAGE IS PROPOSED.
- 18. PENETRATIONS SHALL BE FIRE-STOPPED AND OPENINGS SHALL BE PROTECTED THROUGH FIRE-RATED WALLS, FLOOR, ROOF AND CEILING ASSEMBLIES AS REQUIRED BY THE 2018 IBC CHAPTER 7.
- 19. STRUCTURAL ANALYSIS IS NOT WITHIN THE SCOPE OF WORK CONTAINED IN THIS DRAWINGS SET. FOR ANALYSIS OF EXISTING AND/OR PROPOSED COMPONENTS, REFER TO STRUCTURAL ANALYSIS PROVIDED BY J5 UNDER SEPARATE COVER.

APPLICABLE CODES, REGULATIONS AND STANDARDS:

- 1. SUBCONTRACTOR'S WORK SHALL COMPLY WITH ALL APPLICABLE NATIONAL, STATE, AND LOCAL CODES AS ADOPTED BY THE LOCAL AUTHORITY HAVING JURISDICTION (AHJ) FOR THE LOCATION.
- 2. THE EDITION OF THE AHJ ADOPTED CODES AND STANDARDS IN EFFECT ON THE DATE OF CONTRACT AWARD SHALL GOVERN THE DESIGN.
- SUBCONTRACTOR'S WORK SHALL COMPLY WITH THE LATEST EDITION OF THE FOLLOWING STANDARDS:
- AMERICAN CONCRETE INSTITUTE (ACI) 318, BUILDING CODE REQUIREMENTS FOR STRUCTURAL CONCRETE 3.1.
- AMERICAN INSTITUTE OF STEEL CONSTRUCTION (AISC), MANUAL OF STEEL CONSTRUCTION, LRFD, FOURTEENTH EDITION 3.2.
- 3.3. TELECOMMUNICATIONS INDUSTRY ASSOCIATION (TIA/EIA) 222-H, STRUCTURAL STANDARD FOR ANTENNA SUPPORTING STRUCTURES AND ANTENNAS
- INSTITUTE FOR ELECTRICAL AND ELECTRONICS ENGINEERS (IEEE) 81, GUIDE FOR MEASURING EARTH RESISTIVITY, GROUND IMPEDANCE, AND EARTH SURFACE POTENTIALS OF A GROUND SYSTEM 3.4. IEEE 1100 (1999) RECOMMENDED PRACTICE FOR POWERING AND GROUNDING OF ELECTRICAL EQUIPMENT
- IEEE C62.41, RECOMMENDED PRACTICES ON SURGE VOLTAGES IN LOW VOLTAGE AC POWER CIRCUITS (FOR LOCATION CATEGORY "C3" AND "HIGH SYSTEM EXPOSURE") 3.5.
- TIA 607 COMMERCIAL BUILDING GROUNDING AND BONDING REQUIREMENTS FOR TELECOMMUNICATIONS TELCORDIA GR-63 NETWORK 3.6.
- 3.7. EQUIPMENT-BUILDING SYSTEM (NEBS): PHYSICAL PROTECTION
- TELCORDIA GR-43-CORE GENERIC REQUIREMENTS FOR TELECOMMUNICATIONS HUTS 3.8.
- TELCORDIA GR-1293 GENERAL REQUIREMENTS FOR PERMANENT AC & DC BACKUP GENERATORS INCLUDING FUEL CELLS FOR REMOTE ELECTRONIC SITES 3.9.
- GIGAPOWER TECHNICAL PRACTICE 76416 GROUNDING AND BONDING REQUIREMENTS FOR NETWORK FACILITIES 3.10.
- 3.11. ANY AND ALL OTHER LOCAL & STATE LAWS AND REGULATIONS
- 3.12. FOR ANY CONFLICTS BETWEEN SECTIONS OF LISTED CODES AND STANDARDS REGARDING MATERIAL, METHODS OF CONSTRUCTION, OR OTHER REQUIREMENTS, THE MOST RESTRICTIVE SHALL GOVERN. WHERE THERE IS CONFLICT BETWEEN A GENERAL REQUIREMENT AND A SPECIFIC REQUIREMENT, THE SPECIFIC REQUIREMENT SHALL GOVERN.

| HING MATERIALS, EQUIPMENT, | A.B. ABV. |
|----------------------------------|-------------------------------|
| CLEARLY DEFINED OR IDENTIFIED BY | ACCA ADD'L A.F.F. |
| RS BEFORE PROCEEDING WITH ANY | A.F.G. ALUM. ALT. |
| DATIONS UNLESS SPECIFICALLY | ANT. APPRX. ARCH. |
| CE, FOR, BUT NOT LIMITED TO, | AWG. BLDG. |
| TH LOCAL EARTHQUAKE CODES | BLK. BLKG. BM. |
| o identify or establish bearing | B.N. BTCW. |
| R'S MARKINGS AT THE SITE FOR THE | B.O.F. |
| ANY DISCREPANCY IS FOUND | B/U |
| CIVIL SURVEY. THE CONTRACTOR | CAB. CANT. |
| | C.I.P. |
| NCEMENT OF WORK, OR AS | CLG. CLR. COL. CONC. |
| | CONN. |
| AVAILABLE RECORDS. THE | CONST. |
| RACY OF THE INFORMATION | CONT. d |
| DETERMINING EXACT LOCATION | DBL. |
| ACH UTILITY COMPANY DETAILED | DEPT. D.F. |
| ACH UTILITY COMPANY DETAILED | D.F. DIA. |
| | DIAG. |
| CTION. ANY DISCREPANCIES OR | DIM. DWG. |
| OLUTION AND INSTRUCTION, AND | DWG. DWL. |
| GINEER. FAILURE TO SECURE SUCH | EA. |
| | el. Elec. |
| d to finish elevations prior to | ELEV. |
| | EMT. |
| CONDITION PRIOR TO | E.N. ENG. |
| | ENG. EQ. |
| ATELY NOTED AND PLACED ON | EXP. |
| CT. | EXST.(E) EXT. |
| R BRACED IN ACCORDANCE WITH | FAB. |
| | F.F. |
| | F.G. FIN. |
| | |

FLR.

| ANCHOR BOLT ABOVE ANTENNA CABLE COVER ASSEMBLY ADDITIONAL ABOVE FINISHED FLOOR ABOVE FINISHED GRADE ALUMINUM ALTERNATE ANTENNA APPROXIMATE (LY) ARCHITECT (URAL) AMERICAN WIRE GAUGE BUILDING BLOCK BLOCKING BEAM BOUNDARY NAILING BARE TINNED COPPER WIRE BOTTOM OF FOOTING BACK-UP CABINET CABINET CABINET CANTILEVER (ED) CAST IN PLACE CEILING CLEAR COLUMN CONCRETE CONNECTION (OR) CONSTRUCTION CONSTRUCTION CONSTRUCTION CONSTRUCTION CONSTRUCTION CONSTRUCTION CONSTRUCTION CONTINUOUS PENNY (NAILS) DOUBLE DEPARTMENT DOUGLAS FIR DIAMETER |
|--|
| |
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| |
| |
| |
| |
| |
| |
| COLUMN |
| CONCRETE |
| CONNECTION(OR) |
| CONSTRUCTION |
| CONTINUOUS |
| PENNY (NAILS) |
| DOUBLE |
| |
| |
| |
| DIAGONAL |
| DIMENSION |
| DRAWING(S) |
| DOWEL(S) EACH |
| ELEVATION |
| ELECTRICAL |
| ELEVATOR |
| ELECTRICAL METALLIC TUBING |
| EDGE NAIL |
| ENGINEER |
| EQUAL |
| EXPANSION |
| EXISTING |
| EXTERIOR |
| FABRICATION(OR) |
| FINISH FLOOR |
| FINISH GRADE |
| FINISH(ED) |
| FLOOR |
| |
| |

FDN. F.O.C. F.O.M. F.O.S. F.O.W F.S. FT.(') FTG. G. GA. GI. G.F.I. INTERRUPTER GLB. (GLU-LAM) GPS GRND. HDR. HGR. HT. ICGB. IN. (") INT. LB.(#) L.B. L.F. MAS MAX. M.B. MECH MFR. MIN. MISC MTL. (N) NO.(#) N.T.S. O.C. OPNG. P/C PCS SERVICES PLY. PPC PRC P.S.F. P.S.I. P.T. PWR. QTY. RAD.(R) REF. REINF. REQ'D/ RGS.

NEW NUMBER NOT TO SCALE ON CENTER OPENING PRECAST CONCRETE PERSONAL COMMUNICATION PLYWOOD POWER PROTECTION CABINET PRIMARY RADIO CABINET POUNDS PER SQUARE FOOT POUNDS PER SQUARE INCH PRESSURE TREATED POWER (CABINET) QUANTITY RADIUS REFERENCE REINFORCEMENT(ING) REQUIRED **RIGID GALVANIZED STEEL**

SYMBOLS LEGEND:

| 1 A-300 A-300 | BLDG. SEC |
|---|--------------------|
| A5 A-310 | WALL SECT |
| D5 A-500 | DETAIL |
| A4 A-113 A1 A-113 A1 A-113 | ELEVATION |
| 001 | DOOR SYM |
| | WINDOW S |
| 3 | TILT-UP PAN |
| | PROPERTY |
| | CENTERLIN |
| | Setback |
| ∲ ^{±0"} | ELEVATION |
| A | GRID/COL |
| 3 | KEYNOTE, I |
| 2 | KEYNOTE, C |
| W- 3 | WALL TYPE |
| DFFICE | ROOM NA ROOM NU |
| | |

ABBREVIATIONS:

FOUNDATION

FACE OF STUD

FACE OF WALL

FINISH SURFACE

GALVANIZE(D)

FOOT (FEET)

FOOTING

GAUGE

GROUND

HEADER

HANGER

INCH(ES)

INTERIOR

POUND(S)

LAG BOLTS

MASONRY

MAXIMUM

MINIMUM

METAL

LINEAR FEET (FOOT)

LONG(ITUDINAL)

MACHINE BOLT

MANUFACTURER

MISCELLANEOUS

MECHANICAL

HEIGHT

FACE OF CONCRETE

FACE OF MASONRY

GROWTH (CABINET)

SCH. SHT. SIM. SPEC SQ. S.S. STD. STL. STRUC TEMP. THK. **GROUND FAULT CIRCUIT** T.N. T.O.A GLUE LAMINATED BEAM T.O.C. GLOBAL POSITIONING SYSTEM T.O.F. T.O.P. T.O.S. T.O.W. TYP. U.G. ISOLATED COPPER GROUND BUS U.L. U.N.O. V.I.F. W w/ WD. W.P. WT

SCHEDULE

SHEET

SIMILAR

SQUARE

STEEL

STANDARD

STRUCTURAL

TEMPORARY

THICK(NESS)

TOP OF CURB

TOP OF STEEL

TOP OF WALL

UNDER GROUND

VERIFY IN FIELD

WEATHERPROOF

PLATE, PROPERTY LINE

WIDE (WIDTH)

TYPICAL

WITH

WOOD

WEIGHT

CENTERLINE

TOP OF ANTENNA

TOP OF FOUNDATION

TOP OF PLATE (PARAPET)

UNDERWRITERS LABORATORY

UNLESS NOTED OTHERWISE

TOE NAIL

SPECIFICATIONS

STAINLESS STEEL

GROUT OR PLASTER TION (E) BRICK (E) MASONRY TION CONCRETE EARTH GRAVEL PLYWOOD SAND PLYWOOD SAND (E) STEEL ИBOL MATCH LINE SYMBOL _____ · · · _____ GROUND CONDUCTOR — ОН — — OVERHEAD SERVICE CONDUCTORS NEL MARK —— Tel —— **TELEPHONE CONDUIT** LINE — Pwr POWER CONDUIT COAXIAL CABLE —— Coax —— CHAIN LINK FENCE CHAIN LINK FENCE N DATUM _____ WOOD FENCE LUMN LINE (P) ANTENNA DIMENSION ITEM (P) RRH (P) DC SURGE SUPPRESSION CONSTRUCTION ITEM (F) ANTENNA MARK PE P (F) RRH AME JMBER (E) EQUIPMENT

PREPARED FOR Jigapuwe 311 S AKARD STREET, 21ST FLOOR DALLAS, TX 75202 Vendor: "15 INFRASTRUCTURE 23 MAUCHLY #110 IRVINE, CA 92618 J5 PROJECT ID: P-074358 Issued For: **AZ-001** MESA EAST 5540 EAST MAIN STREET MESA, AZ 85205 PARCEL ID: 141-77-057F DRAWN BY: JSP CHECKED BY: KM REV DATE DESCRIPTION A 1/25/23 90% ZD Licensor: Sheet Title: GENERAL NOTES Sheet Number: GN-1

SITE WORK GENERAL NOTES:

- 1. THE SUBCONTRACTOR SHALL CONTRACT UTILITY LOCATING SERVICES PRIOR TO THE START OF CONSTRUCTION.
- 2. ALL EXISTING ACTIVE SEWER, WATER, GAS, ELECTRIC, AND OTHER UTILITIES WHERE ENCOUNTERED IN THE WORK, SHALL BE PROTECTED AT ALL TIMES AND WHERE REQUIRED FOR THE PROPER EXECUTION OF THE WORK, SHALL BE RELOCATED AS DIRECTED BY CONTRACTOR. EXTREME CAUTION SHOULD BE USED BY THE SUBCONTRACTOR WHEN EXCAVATING OR DRILLING PIERS AROUND OR NEAR UTILITIES, SUBCONTRACTOR SHALL PROVIDE SAFETY TRAINING FOR THE WORKING CREW. THIS WILL INCLUDE BUT NOT BE LIMITED TO A.) FALL PROTECTION B.) CONFINED SPACE C.) ELECTRICAL SAFETY D.) TRENCHING AND EXCAVATION.
- 3. ALL SITE WORK SHALL BE AS INDICATED ON THE STAMPED CONSTRUCTION DRAWINGS AND PROJECT SPECIFICATIONS.
- 4. IF NECESSARY, RUBBISH, STUMPS, DEBRIS, STICKS, STONES, AND OTHER REFUSE SHALL BE REMOVED FROM THE SITE AND DISPOSED OF LEGALLY.
- 5. ALL EXISTING INACTIVE SEWER, WATER, GAS, ELECTRIC, AND OTHER UTILITIES, WHICH INTERFERE WITH THE EXECUTION OF THE WORK, SHALL BE REMOVED AND/OR CAPPED, PLUGGED, OR OTHERWISE DISCONNECTED AT POINTS WHICH WILL NOT INTERFERE WITH THE EXECUTION OF THE WORK, SUBJECT TO THE APPROVAL OF CONTRACTOR, OWNER, AND/OR LOCAL UTILITIES.
- 6. THE SUBCONTRACTOR SHALL PROVIDE SITE SIGNAGE IN ACCORDANCE WITH THE TECHNICAL SPECIFICATION FOR SITE SIGNAGE.
- 7. THE SITE SHALL BE GRADED TO CAUSE SURFACE WATER TO FLOW AWAY FROM THE EQUIPMENT AREA.
- 8. NO FILL OR EMBANKMENT MATERIAL SHALL BE PLACED ON FROZEN GROUND. FROZEN MATERIALS, SNOW, OR ICE SHALL BE PLACED IN ANY FILL OR EMBANKMENT.
- 9. THE SUB GRADE SHALL BE COMPACTED AND BROUGHT TO A SMOOTH UNIFORM GRADE PRIOR TO FINISHED SURFACE APPLICATION.
- 10. THE AREAS OF THE OWNERS PROPERTY DISTURBED BY THE WORK AND NOT COVERED BY THE EQUIPMENT, OR DRIVEWAY, SHALL BE GRADED TO A UNIFORM SLOPE AND STABILIZED TO PREVENT EROSION AS SPECIFIED ON THE PROJECT SPECIFICATIONS.
- 11. SUBCONTRACTOR SHALL MINIMIZE DISTURBANCE TO EXISTING SITE DURING CONSTRUCTION. EROSION CONTROL MEASURES, IF REQUIRED DURING CONSTRUCTION, SHALL BE IN CONFORMANCE WITH THE LOCAL GUIDELINES FOR EROSION AND SEDIMENT CONTROL.
- 12. NOTICE TO PROCEED NO WORK TO COMMENCE PRIOR TO COMPANY'S WRITTEN NOTICE TO PROCEED AND THE ISSUANCE OF A PURCHASE ORDER.
- 13. ALL CONSTRUCTION MEANS AND METHODS: INCLUDING BUT NOT LIMITED TO, ERECTION PLANS, RIGGING PLANS, CLIMBING PLANS, AND RESCUE PLANS SHALL BE THE RESPONSIBILITY OF THE GENERAL CONTRACTOR RESPONSIBLE FOR THE EXECUTION OF THE WORK CONTAINED HEREIN AND SHALL ADHERE TO ANSI/TIA-1019 (LATEST EDITION) INCLUDING THE REQUIRED INVOLVEMENT OF A QUALIFIED ENGINEER FOR CLASS IV CONSTRUCTION.

CONCRETE AND REINFORCING STEEL NOTES:

- 1. ALL CONCRETE WORK SHALL BE IN ACCORDANCE WITH THE ACI 301, ACI 318, ACI 336, ASTM A184, ASTM A185, AND THE DESIGN AND CONSTRUCTION SPECIFICATION FOR CAST-IN-PLACE CONCRETE.
- 2. ALL CONCRETE SHALL HAVE A MINIMUM COMPESSIVE STRENGTH OF 2,500 PSI AT 28 DAYS, UNLESS NOTED OTHERWISE. SLAB FOUNDATION DESIGN ASSUMING ALLOWABLE SOIL BEARING PRESSURE OF 2000 PSF.
- 3. REINFORCING STEEL SHALL CONFORM TO ASTM A615, GRADE 60, DEFORMED UNLESS NOTED OTHERWISE. WELDED WIRE FABRIC SHALL CONFORM TO ASTM A185 WELDED STEEL WIRE FABRIC UNLESS NOTED OTHERWISE. SPLICES SHALL BE CLASS "B" AND ALL HOOKS SHALL BE STANDARD. UNO.
- 4. THE FOLLOWING MINIMUM CONCRETE COVER SHALL BE PROVIDED FOR REINFORCING STEEL UNLESS SHOWN OTHERWISE ON DRAWINGS.

2" MIN.

- 4.1. CONCRETE CAST AGAINST EARTH: 3" MIN.
- 4.2. CONCRETE EXPOSED TO WEATHER:
- 4.2.1. #6 AND LARGER -
- 1 1/2" MIN. 4.2.2. #5 AND SMALLER & WWF. -4.3. CONCRETE NOT EXPOSED TO WEATHER OR NOT CAST AGAINST THE GROUND:
- 4.3.1. SLAB AND WALLS
- 3/4" MIN. 1 1/2" MIN. 4.3.2. BEAMS AND COLUMNS
- 5. A 3/4" CHAMFER SHALL BE PROVIDED AT ALL EXPOSED EDGES OF CONCRETE, UNLESS NOTED OTHERWISE, IN ACCORDANCE WITH ACI 301 SECTION 4.2.4

GENERAL NOTES:

1. FOR THE PURPOSE OF CONSTRUCTION DRAWING, THE FOLLOWING DEFINITIONS SHALL APPLY:

CONTRACTOR -SITE APPLICANT -OEM -

J5 INFRASTRUCTURE PARTNERS SUBCONTRACTOR - GENERAL CONTRACTOR (CONSTRUCTION) GIGAPOWER, LLC

ORIGINAL EQUIPMENT MANUFACTURER

- 2. PRIOR TO THE SUBMISSION OF BIDS, THE BIDDING SUBCONTRACTOR SHALL VISIT THE SITE TO FAMILIARIZE THEMSELVES, WITH THE EXISTING CONDITIONS AND TO CONFIRM THAT THE WORK CAN BE ACCOMPLISHED AS SHOWN ON THE CONSTRUCTION DRAWINGS. ANY DISCREPANCY FOUND SHALL BE BROUGHT TO THE ATTENTION OF THE CONTRACTOR AND GIGAPOWER
- 3. ALL MATERIALS FURNISHED AND INSTALLED SHALL BE IN STRICT ACCORDANCE WITH ALL APPLICABLE CODES, REGULATIONS, AND ORDINANCES. SUBCONTRACTOR SHALL ISSUE ALL APPROPRIATE NOTICES AND COMPLY WITH ALL LAWS, ORDINANCES, RULES, REGULATIONS AND LAWFUL ORDERS OF ANY PUBLIC AUTHORITY REGARDING THE PERFORMANCE OF THE WORK. ALL WORK CARRIED OUT SHALL COMPLY WITH ALL APPLICABLE MUNICIPAL AND UTILITY COMPANY SPECIFICATIONS, AND LOCAL JURISDICTIONAL CODES, ORDINANCES AND APPLICABLE REGULATIONS.
- 4. DRAWINGS PROVIDED HERE ARE NOT TO SCALE AND ARE INTENDED TO SHOW OUTLINE ONLY.
- UNLESS NOTED OTHERWISE, THE WORK SHALL INCLUDE FURNISHING MATERIALS, EQUIPMENT, APPURTENANCES AND LABOR NECESSARY TO COMPLETE ALL INSTALLATIONS AS INDICATED ON THE DRAWINGS.
- 6. 'KITTING LIST' SUPPLIED WITH THE BID PACKAGE IDENTIFIES ITEMS THAT WILL BE SUPPLIED BY CONTRACTOR. ITEMS NOT INCLUDED IN THE BILL OF MATERIALS AND KITTING LIST SHALL BE SUPPLIED BY THE SUBCONTRACTOR.
- 7. THE SUBCONTRACTOR SHALL INSTALL ALL EQUIPMENT AND MATERIALS IN ACCORDANCE WITH MANUFACTURER'S RECOMMENDATIONS UNLESS SPECIFICALLY STATED OTHERWISE.
- 8. IF THE SPECIFIED EQUIPMENT CAN NOT BE INSTALLED AS SHOWN ON THESE DRAWINGS. THE SUBCONTRACTOR SHALL PROPOSE AN ALTERNATIVE INSTALLATION FOR APPROVAL BY THE CONTRACTOR AND GIGAPOWER PRIOR TO PROCEEDING WITH ANY SUCH CHANGE OF INSTALLATION.
- 9. SUBCONTRACTOR SHALL DETERMINE ACTUAL ROUTING OF CONDUIT, POWER AND T1 CABLES, GROUNDING CABLES AS SHOWN ON THE POWER, GROUNDING AND TELCO PLAN DRAWINGS.
- 10. THE SUBCONTRACTOR SHALL PROTECT EXISTING IMPROVEMENTS, PAVEMENTS, CURBS, LANDSCAPING AND STRUCTURES. ANY DAMAGED PART SHALL BE REPAIRED AT THE SUBCONTRACTOR'S EXPENSE; TO THE SATISFACTION OF THE OWNER.
- 11. SUBCONTRACTOR SHALL LEGALLY AND PROPERLY DISPOSE OF ALL SCRAP MATERIALS SUCH AS COAXIAL CABLES AND OTHER ITEMS REMOVED FROM THE EXISTING FACILITY. ANTENNAS REMOVED SHALL BE RETURNED TO THE OWNER'S DESIGNATED LOCATION.
- 12. SUBCONTRACTOR SHALL LEAVE PREMISES IN CLEAN CONDITION, TRASH AND DEBRIS SHOULD BE REMOVED FROM SITE ON A DAILY BASIS.

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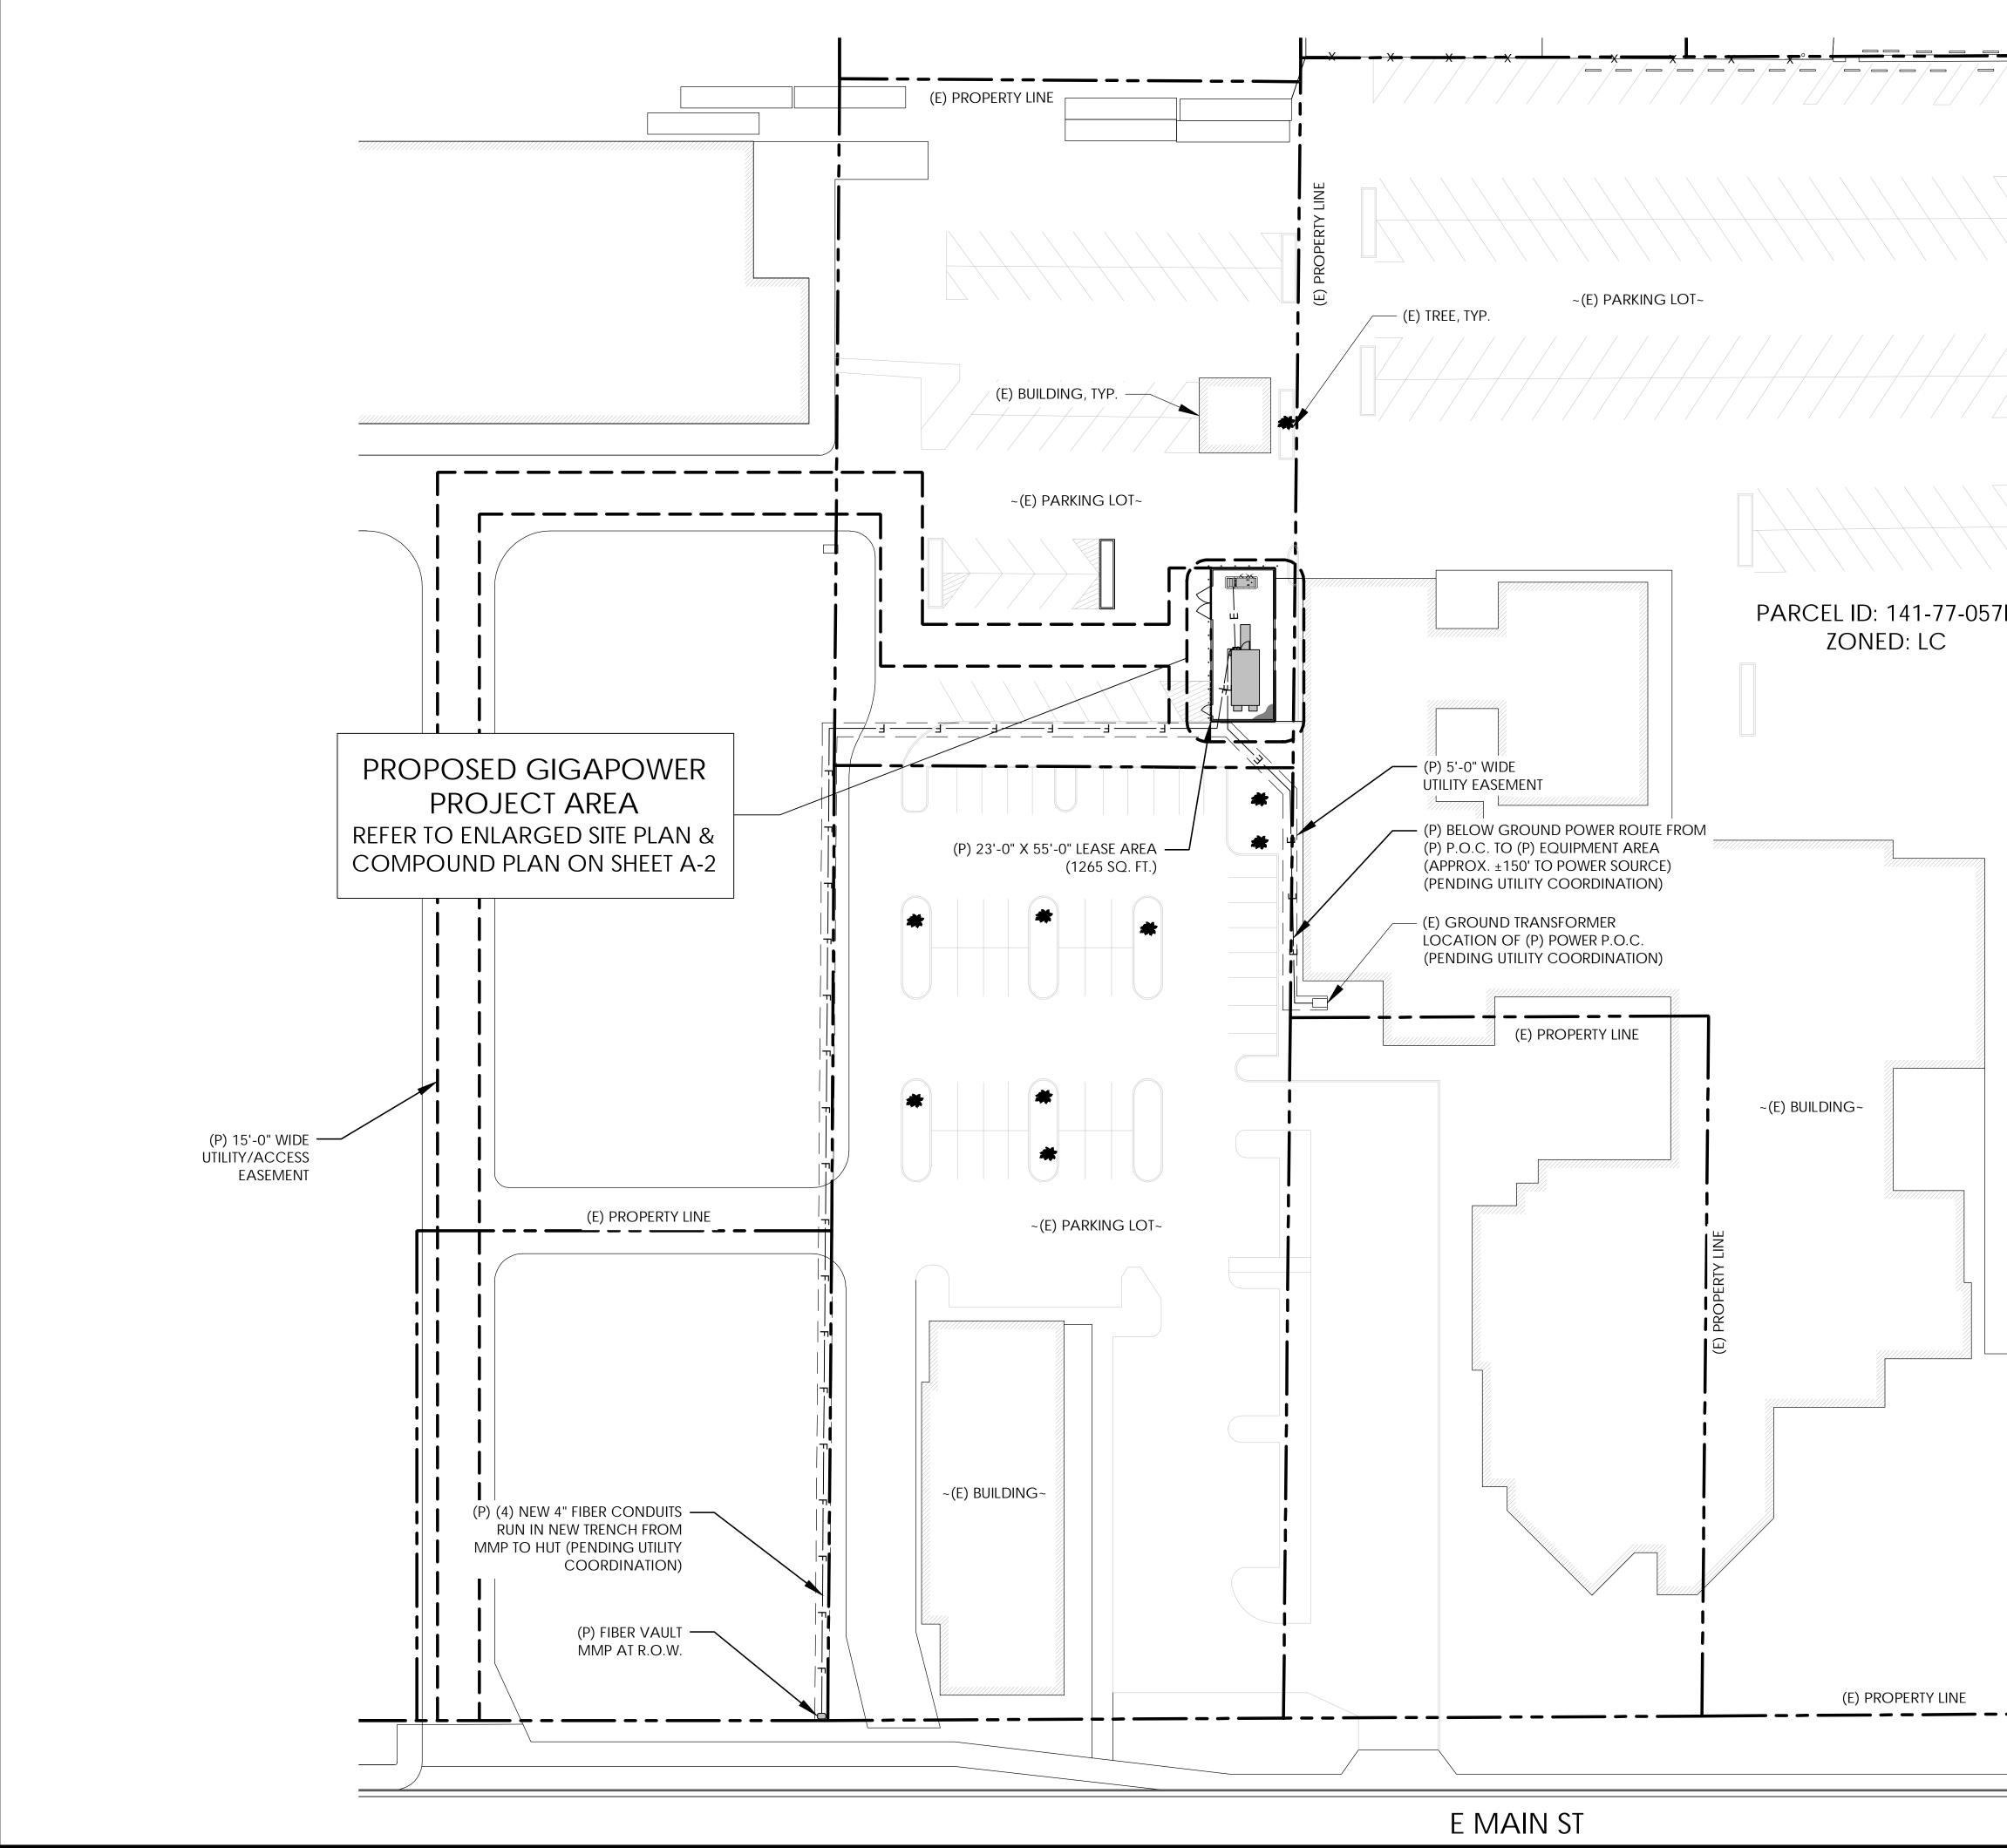


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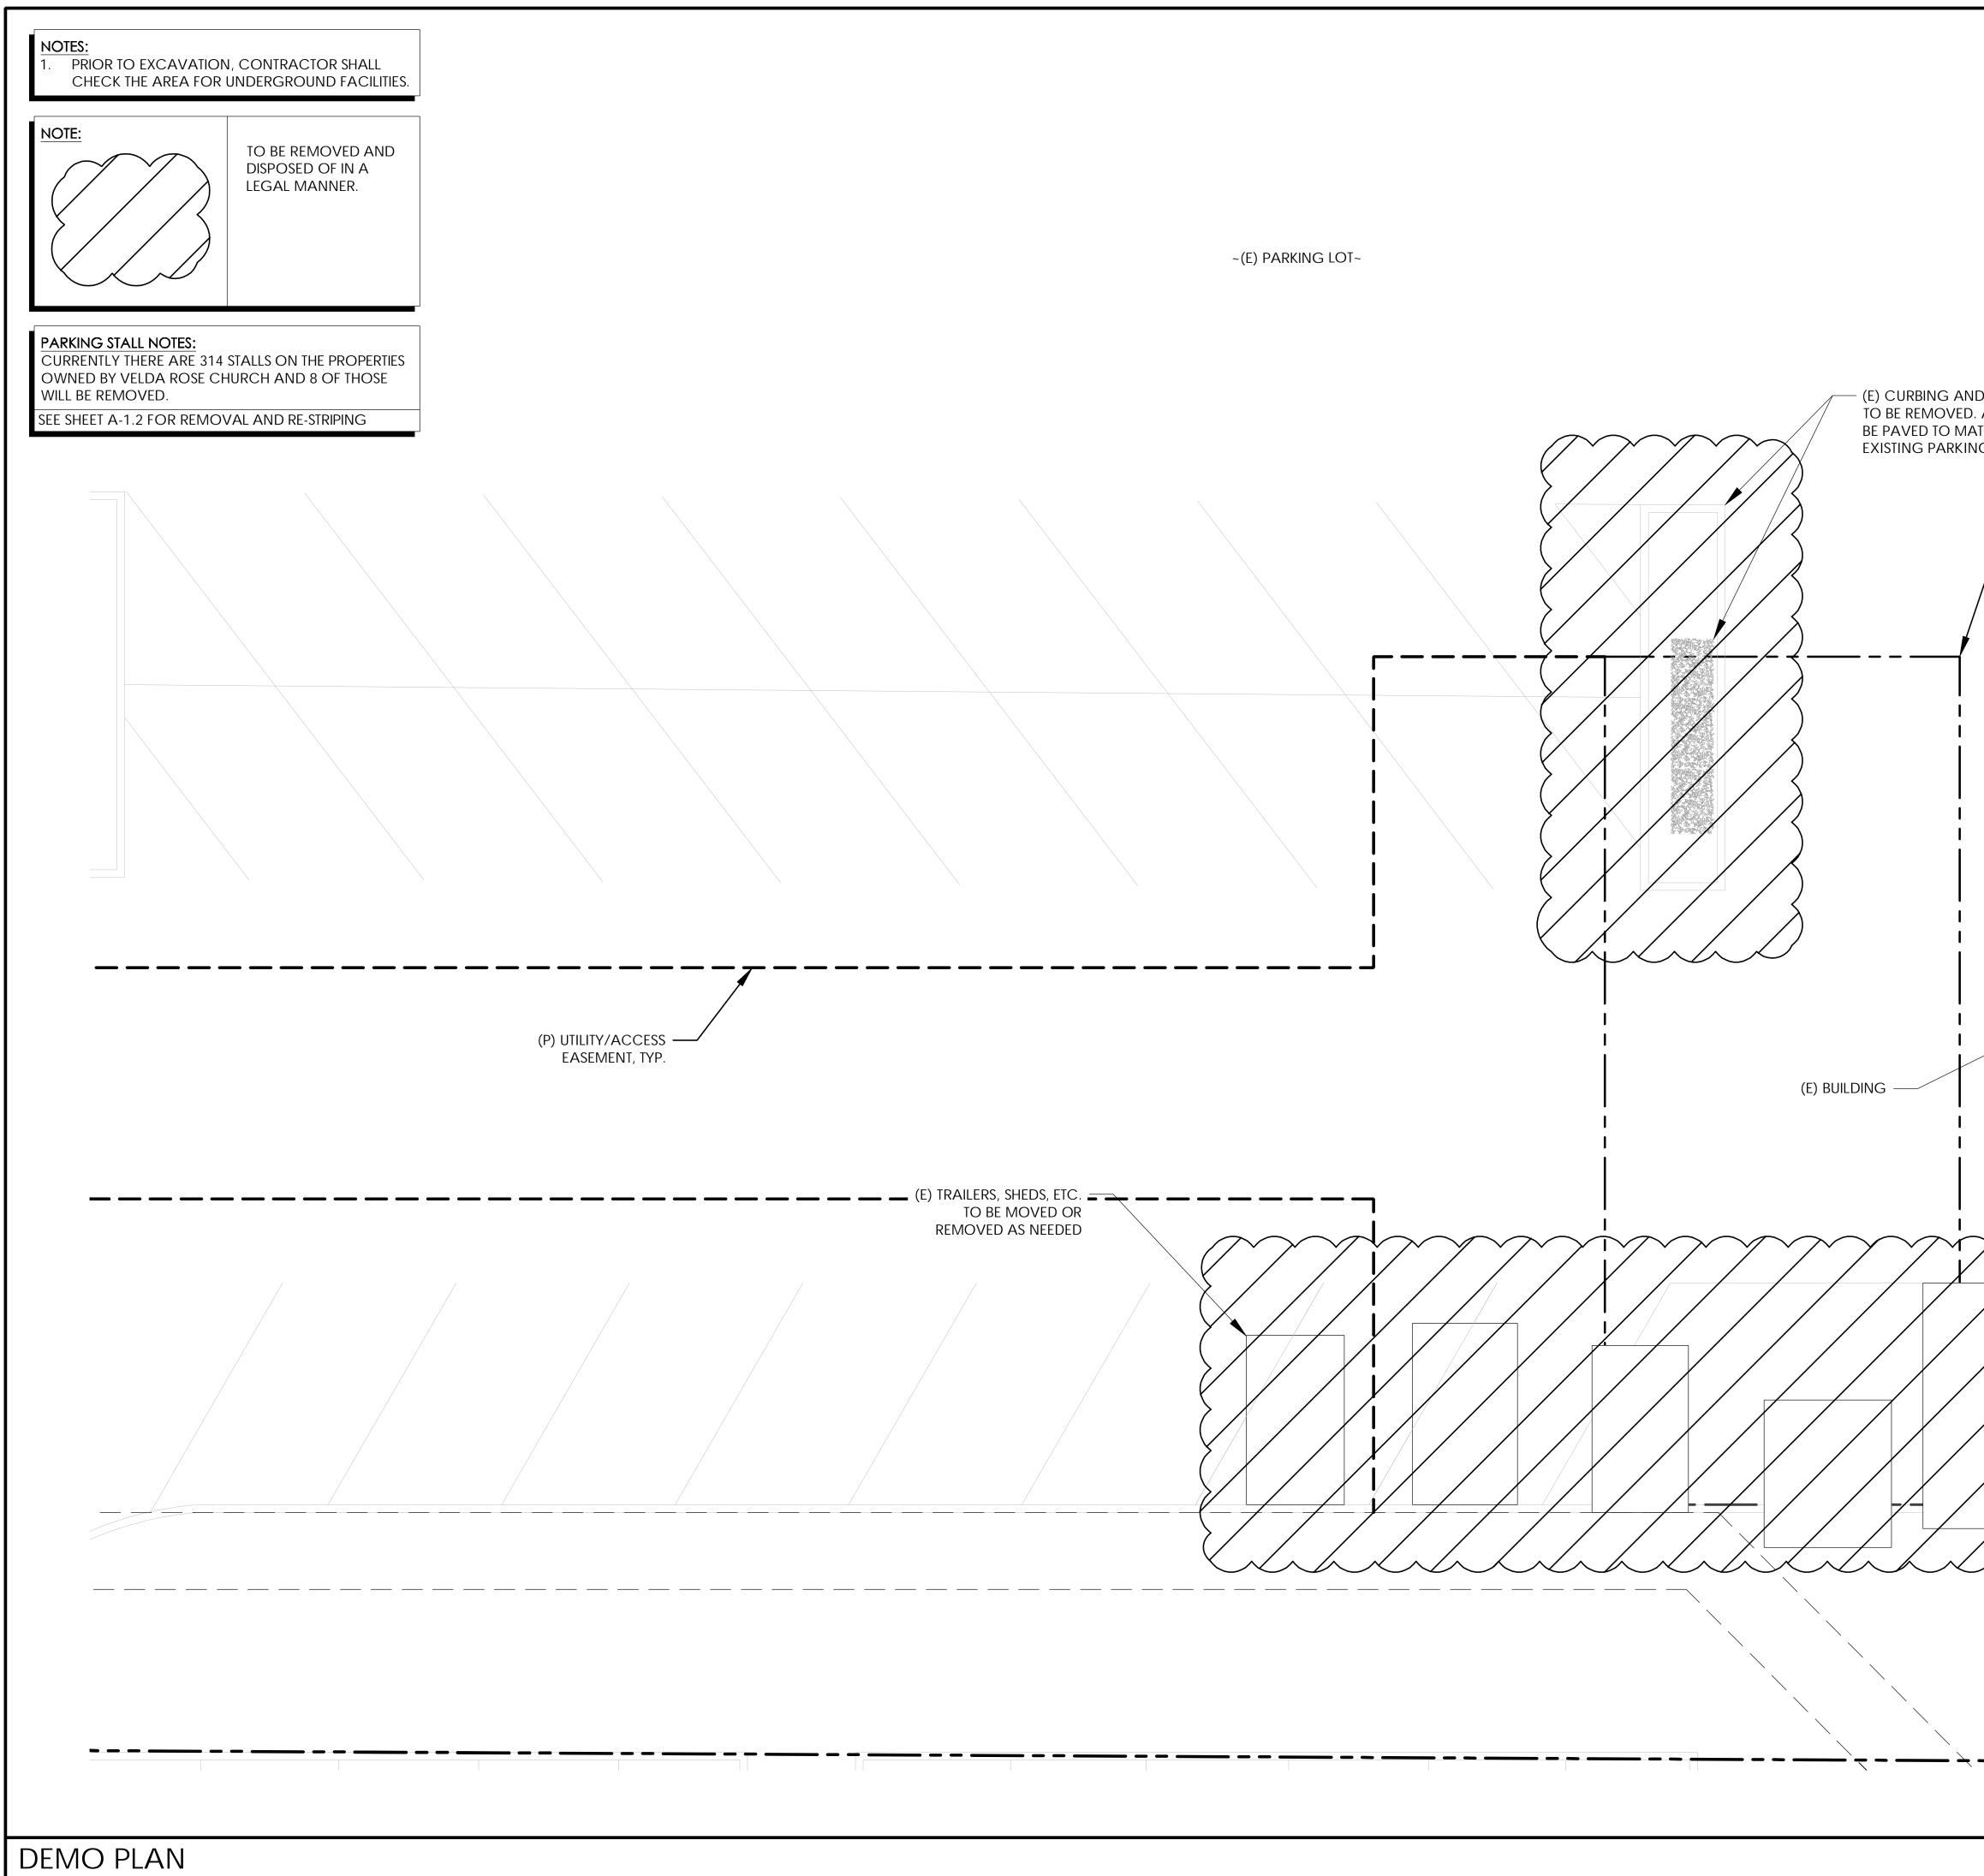
SIGNAGE AND STRIPING INFORMATION

1. PHOTOS OF ALL STRIPING, BARRICADES & SIGNAGE SHALL BE PART OF THE CONTRACTORS CLOSE OUT PACKAGE & SHALL BE TURNED INTO THE GIGAPOWER CONSTRUCTION PACKAGE & SHALL BE TURNED INTO THE GIGAPOWER CONSTRUCTION PROJECT MANAGER AT THE END OF CONSTRUCTION.


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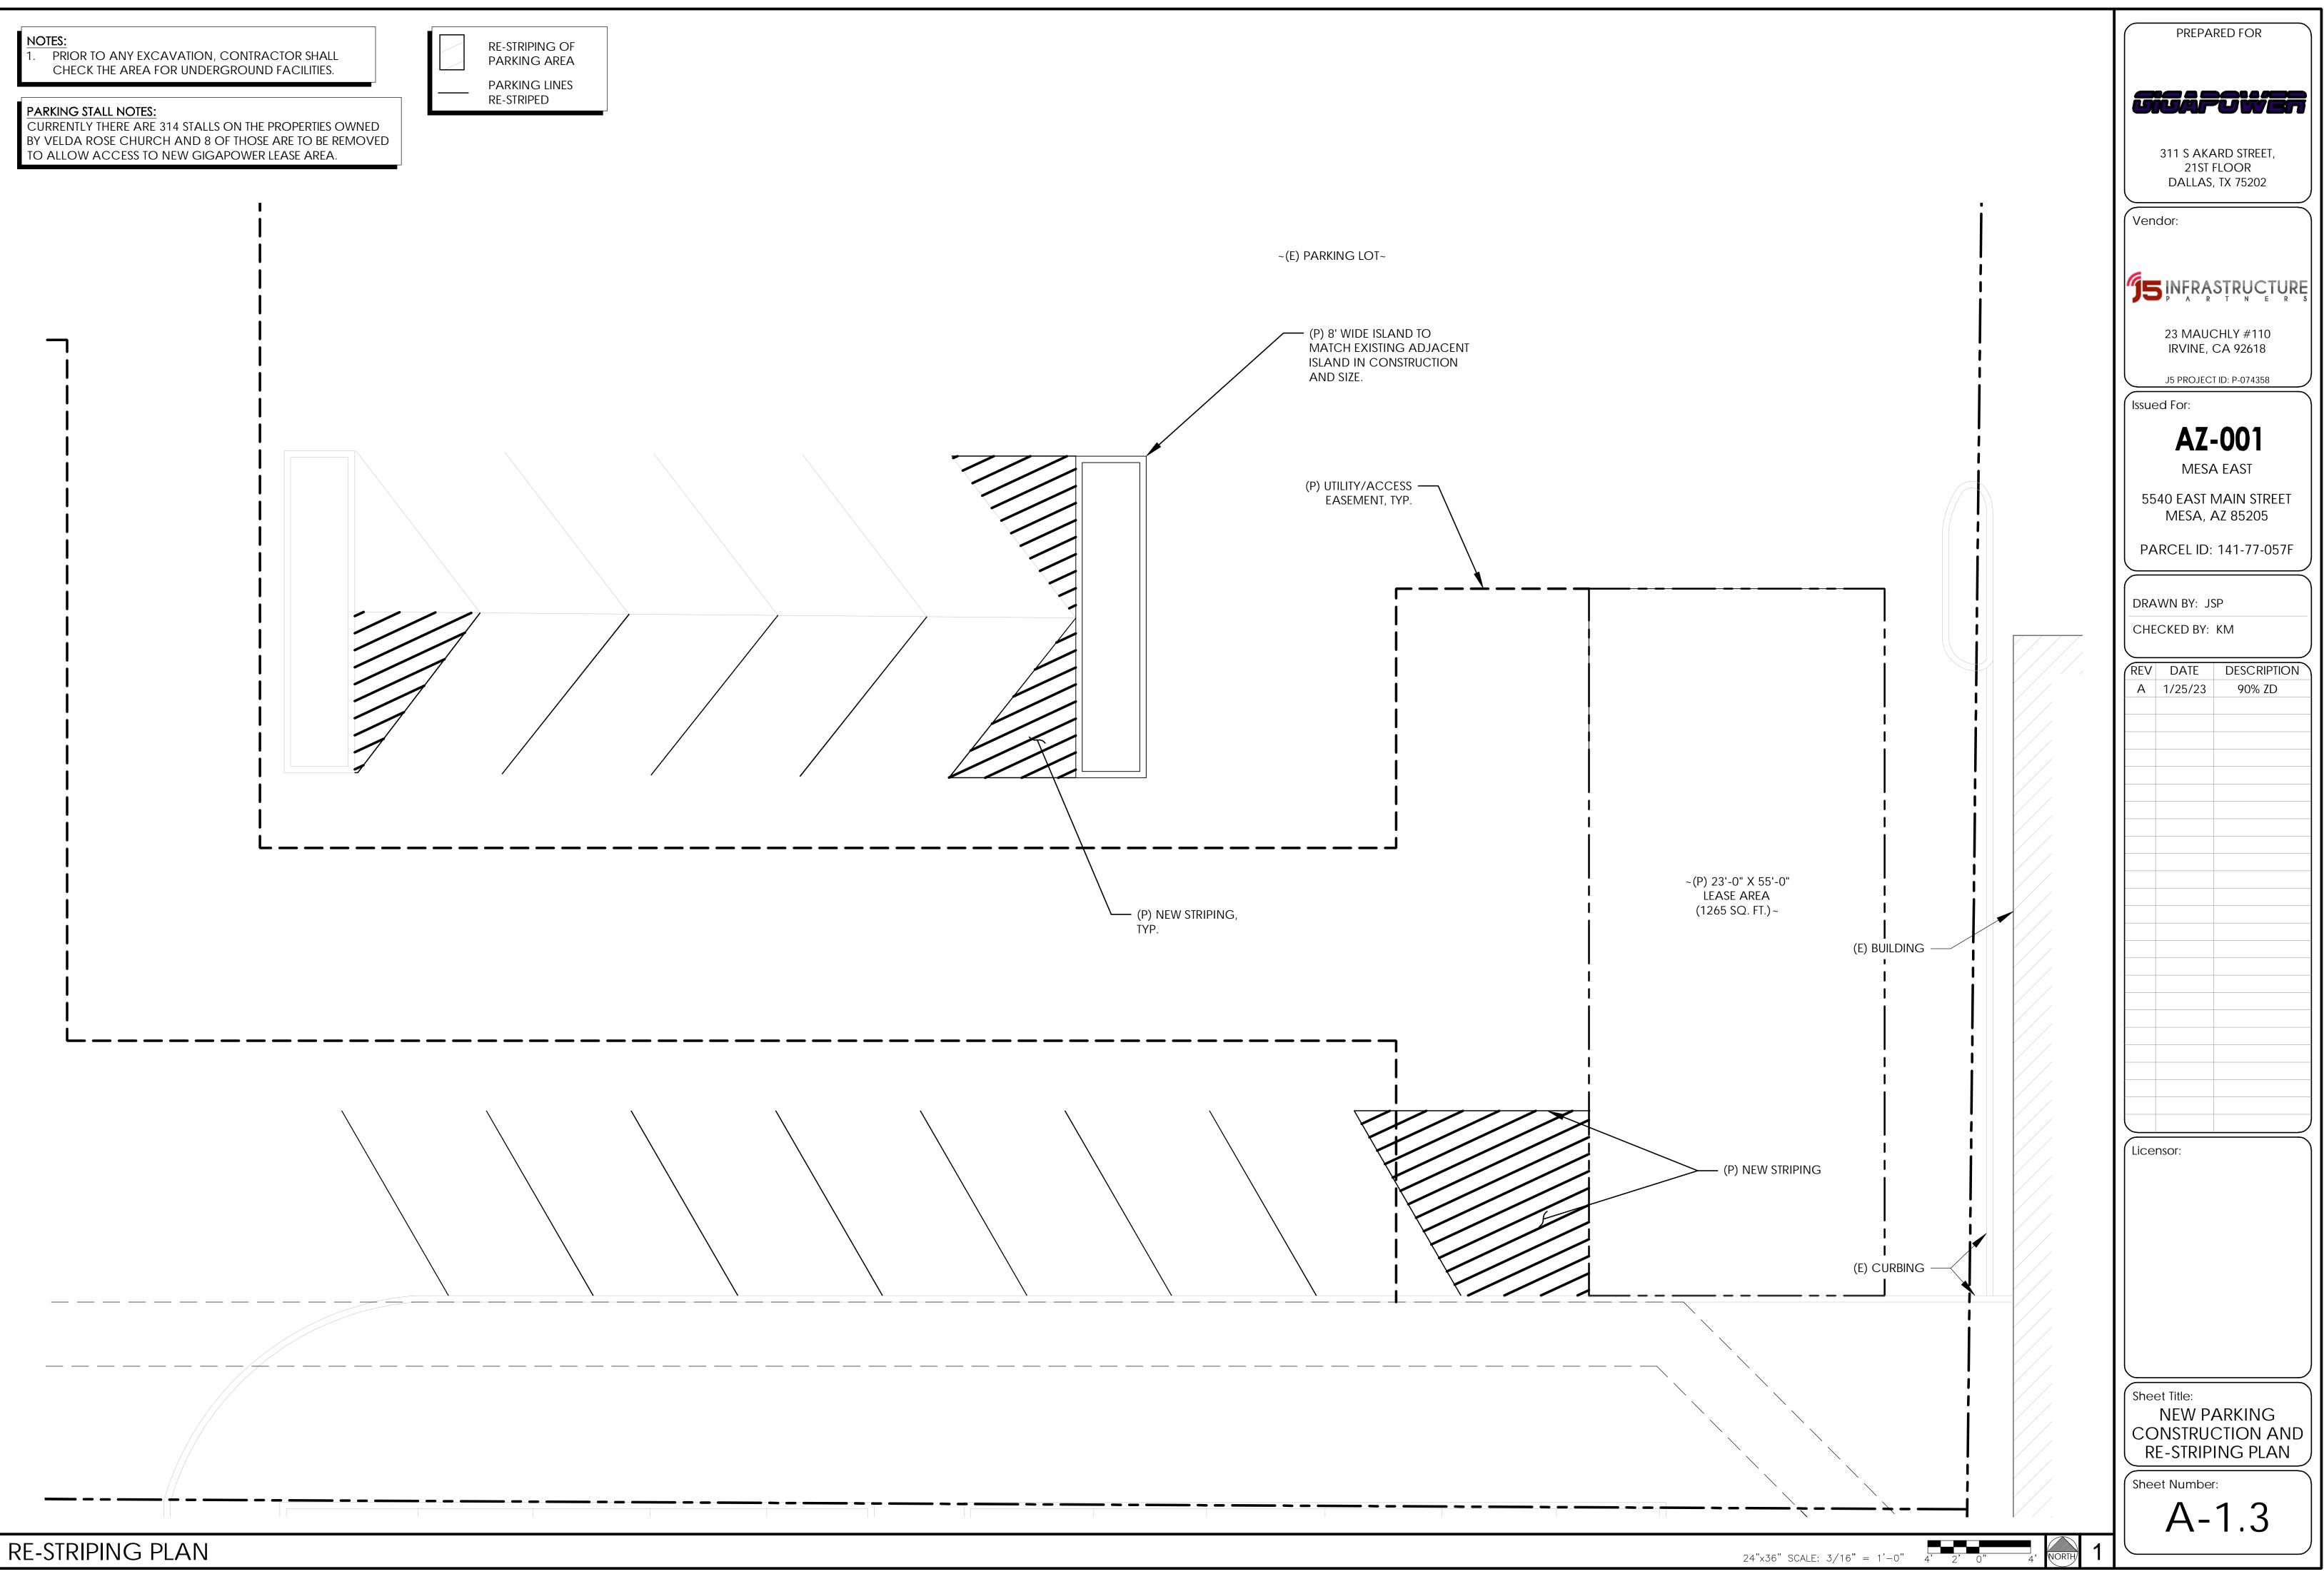


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| | 24"x36" SCALE: $3/16" = 1'-0"$ 4' 2' 0" 4' NORTH | |
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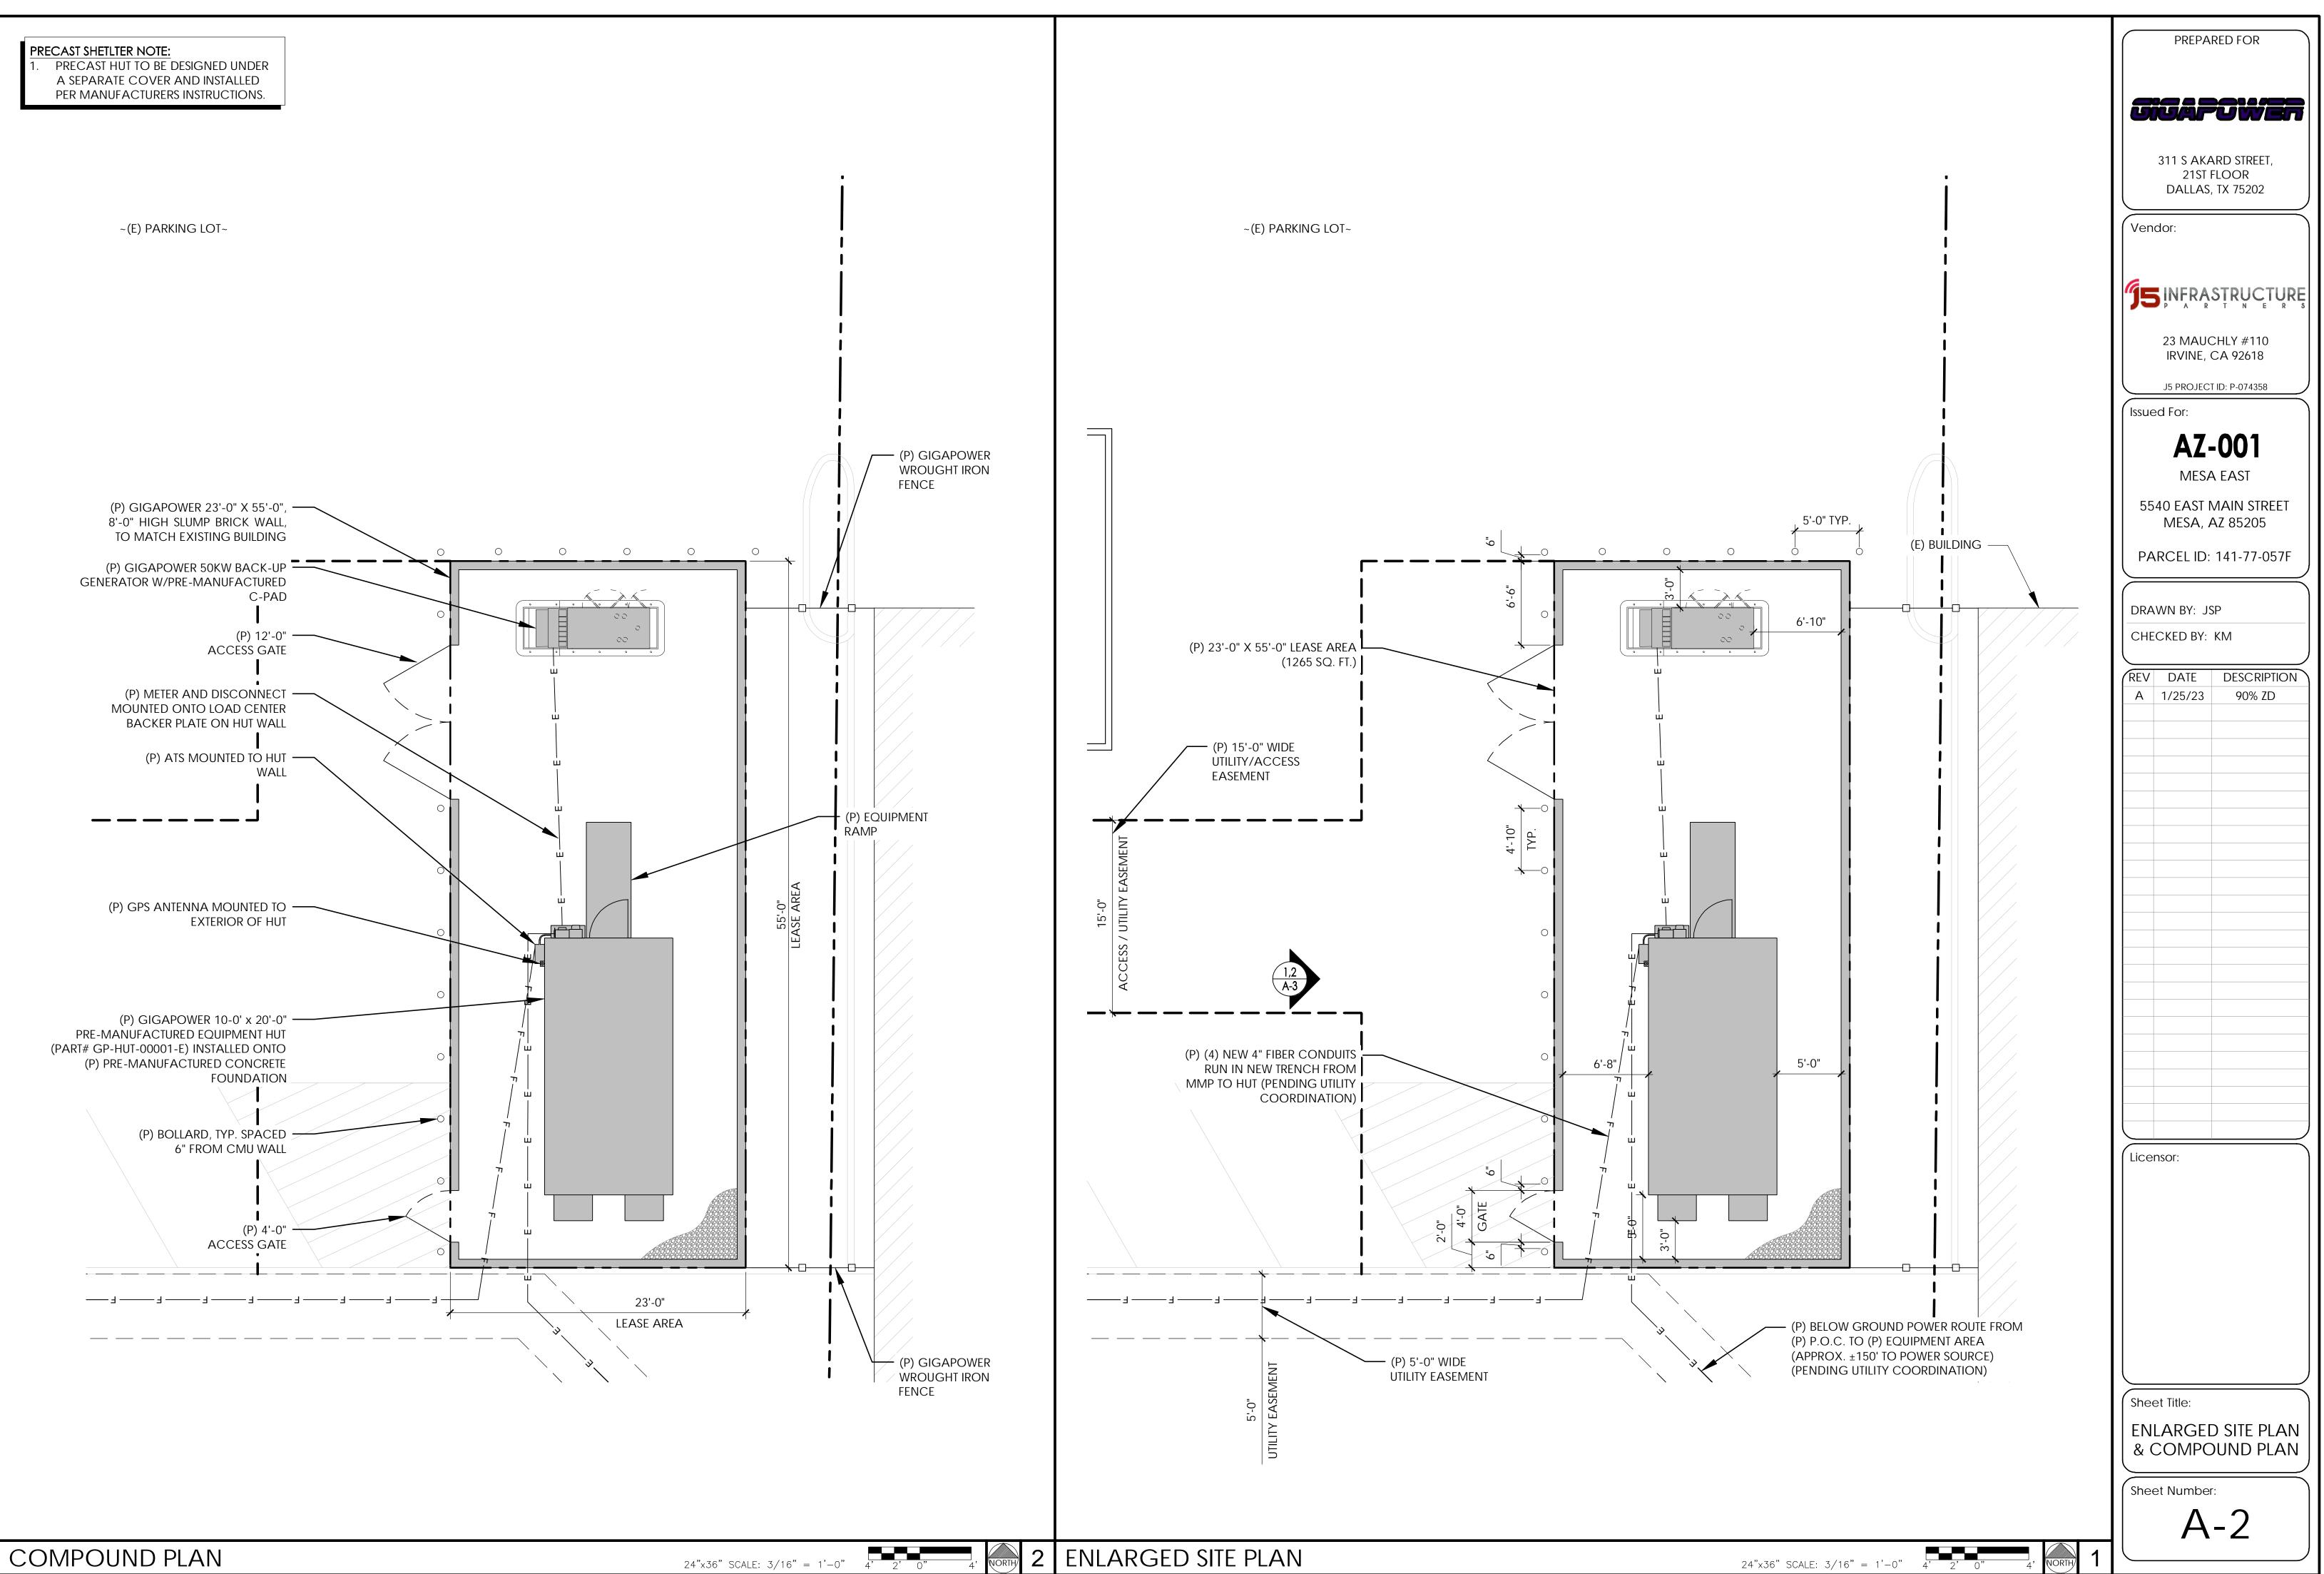










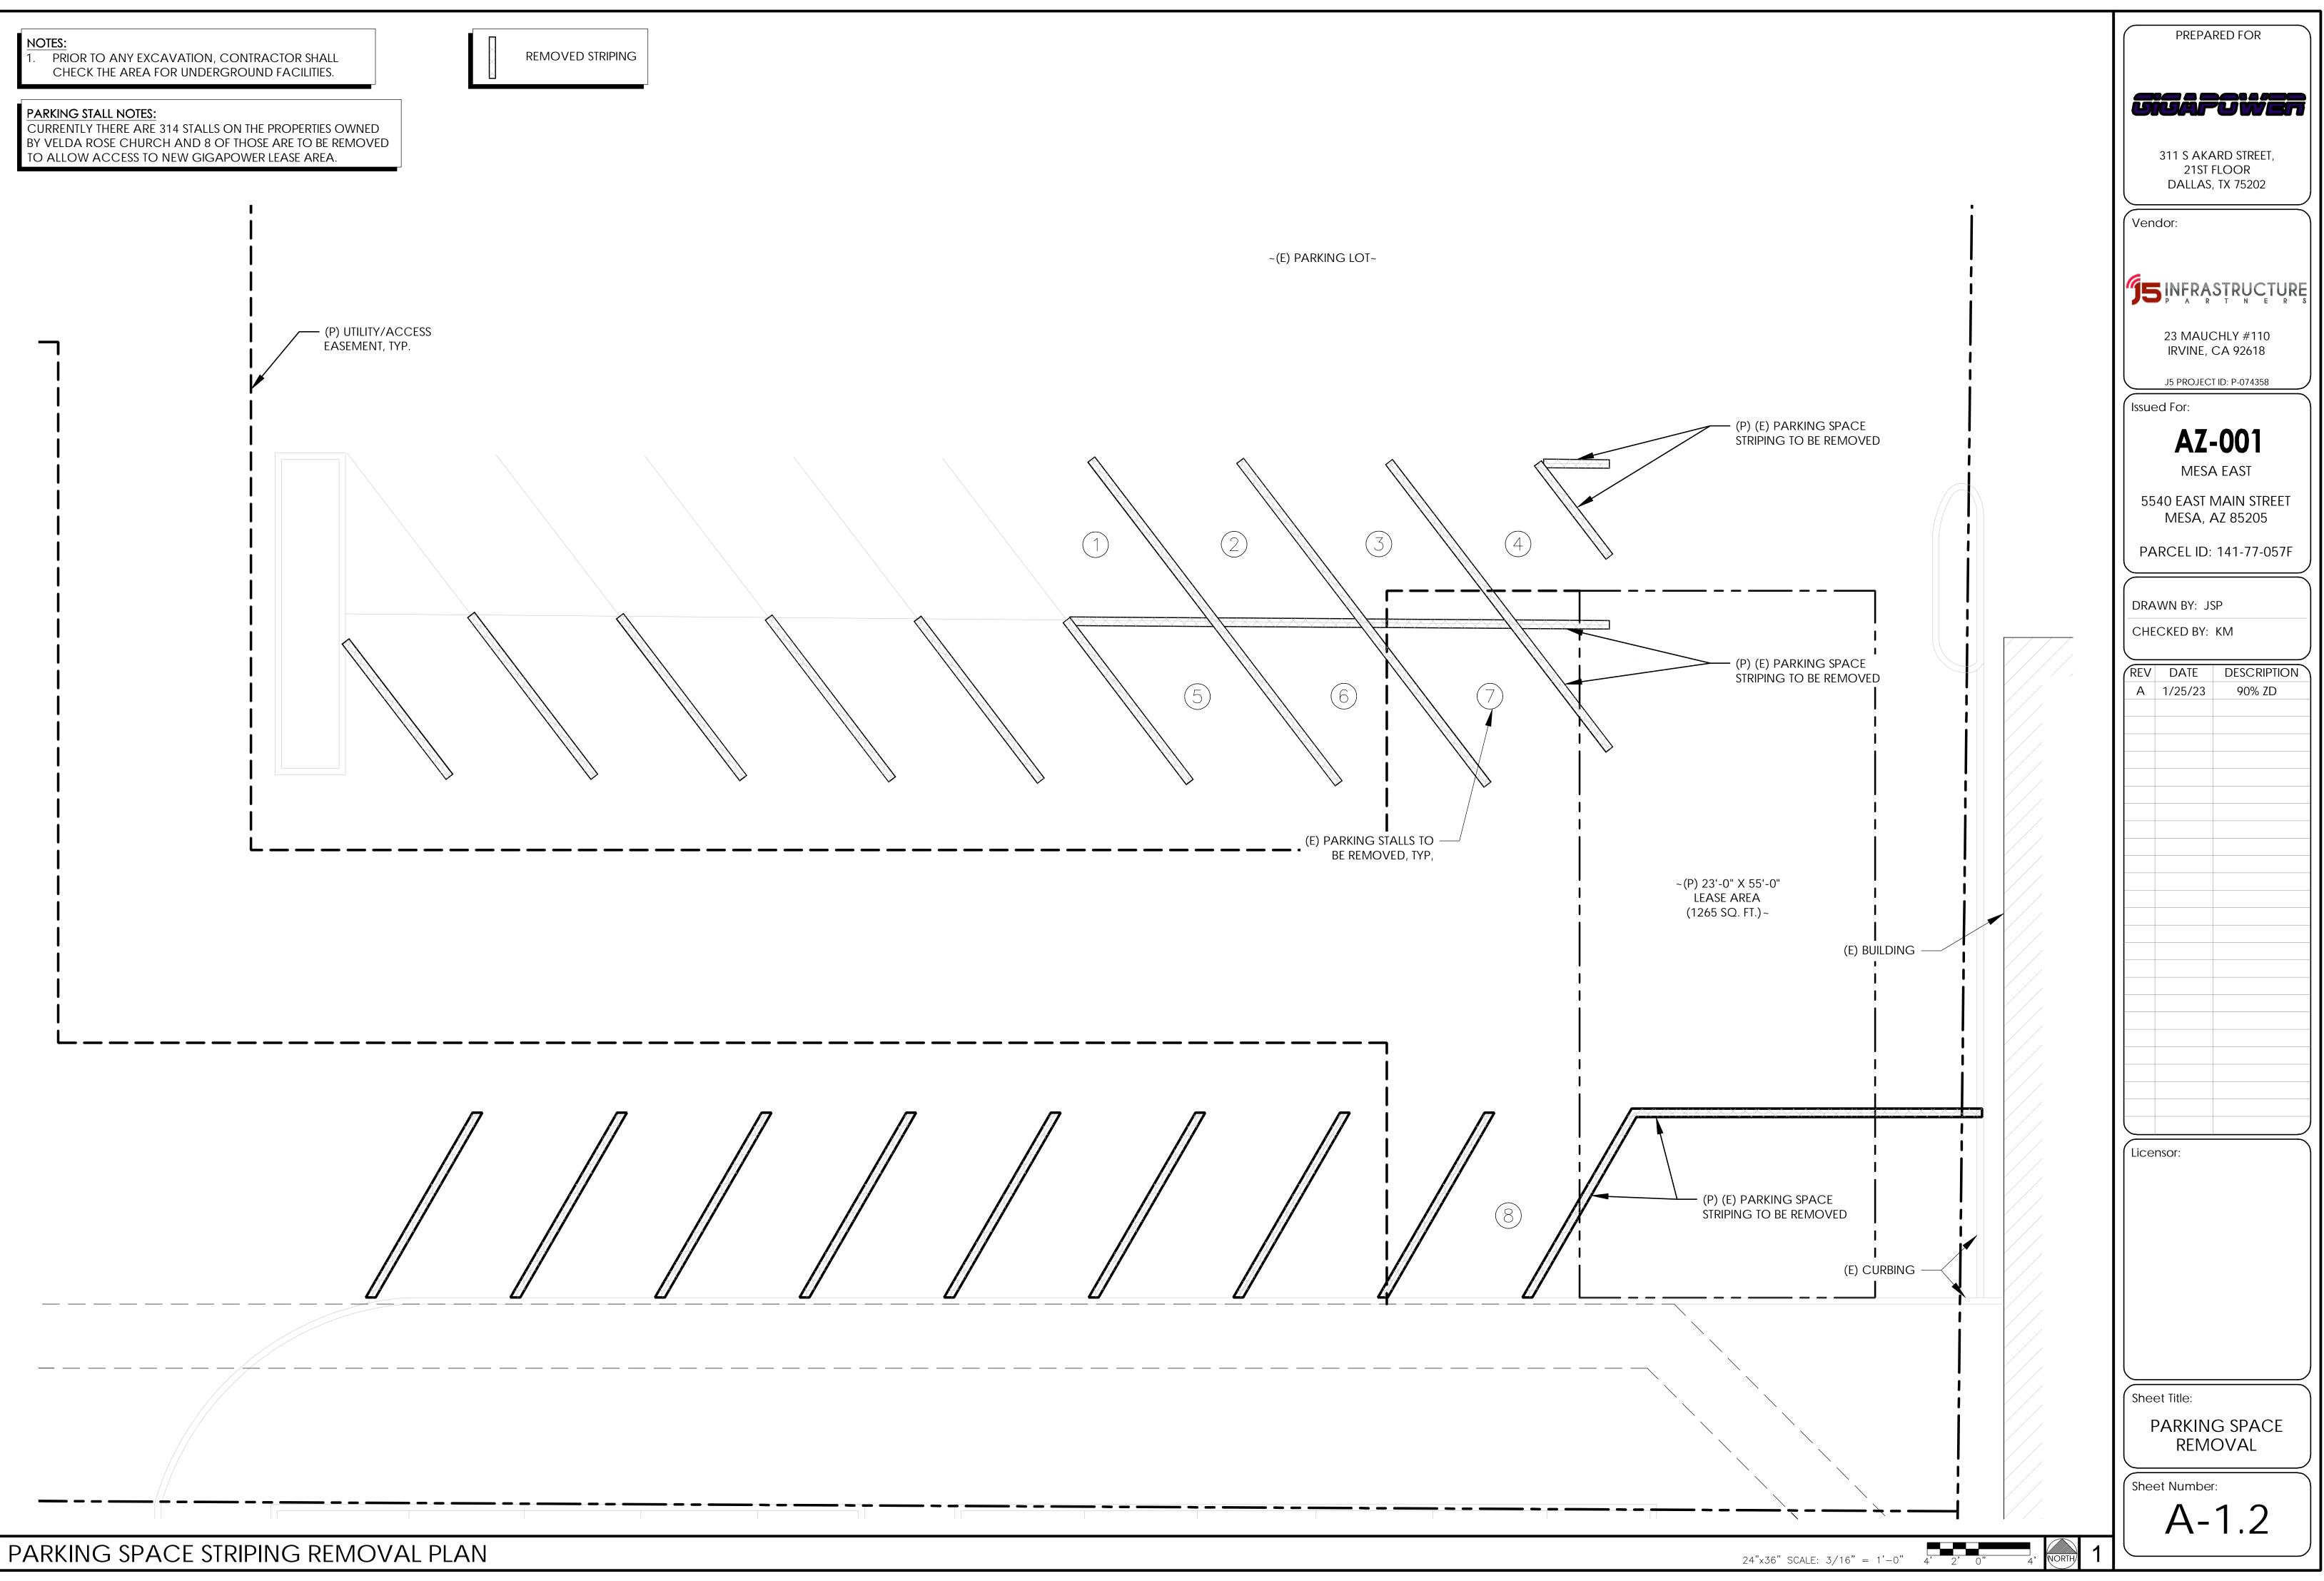






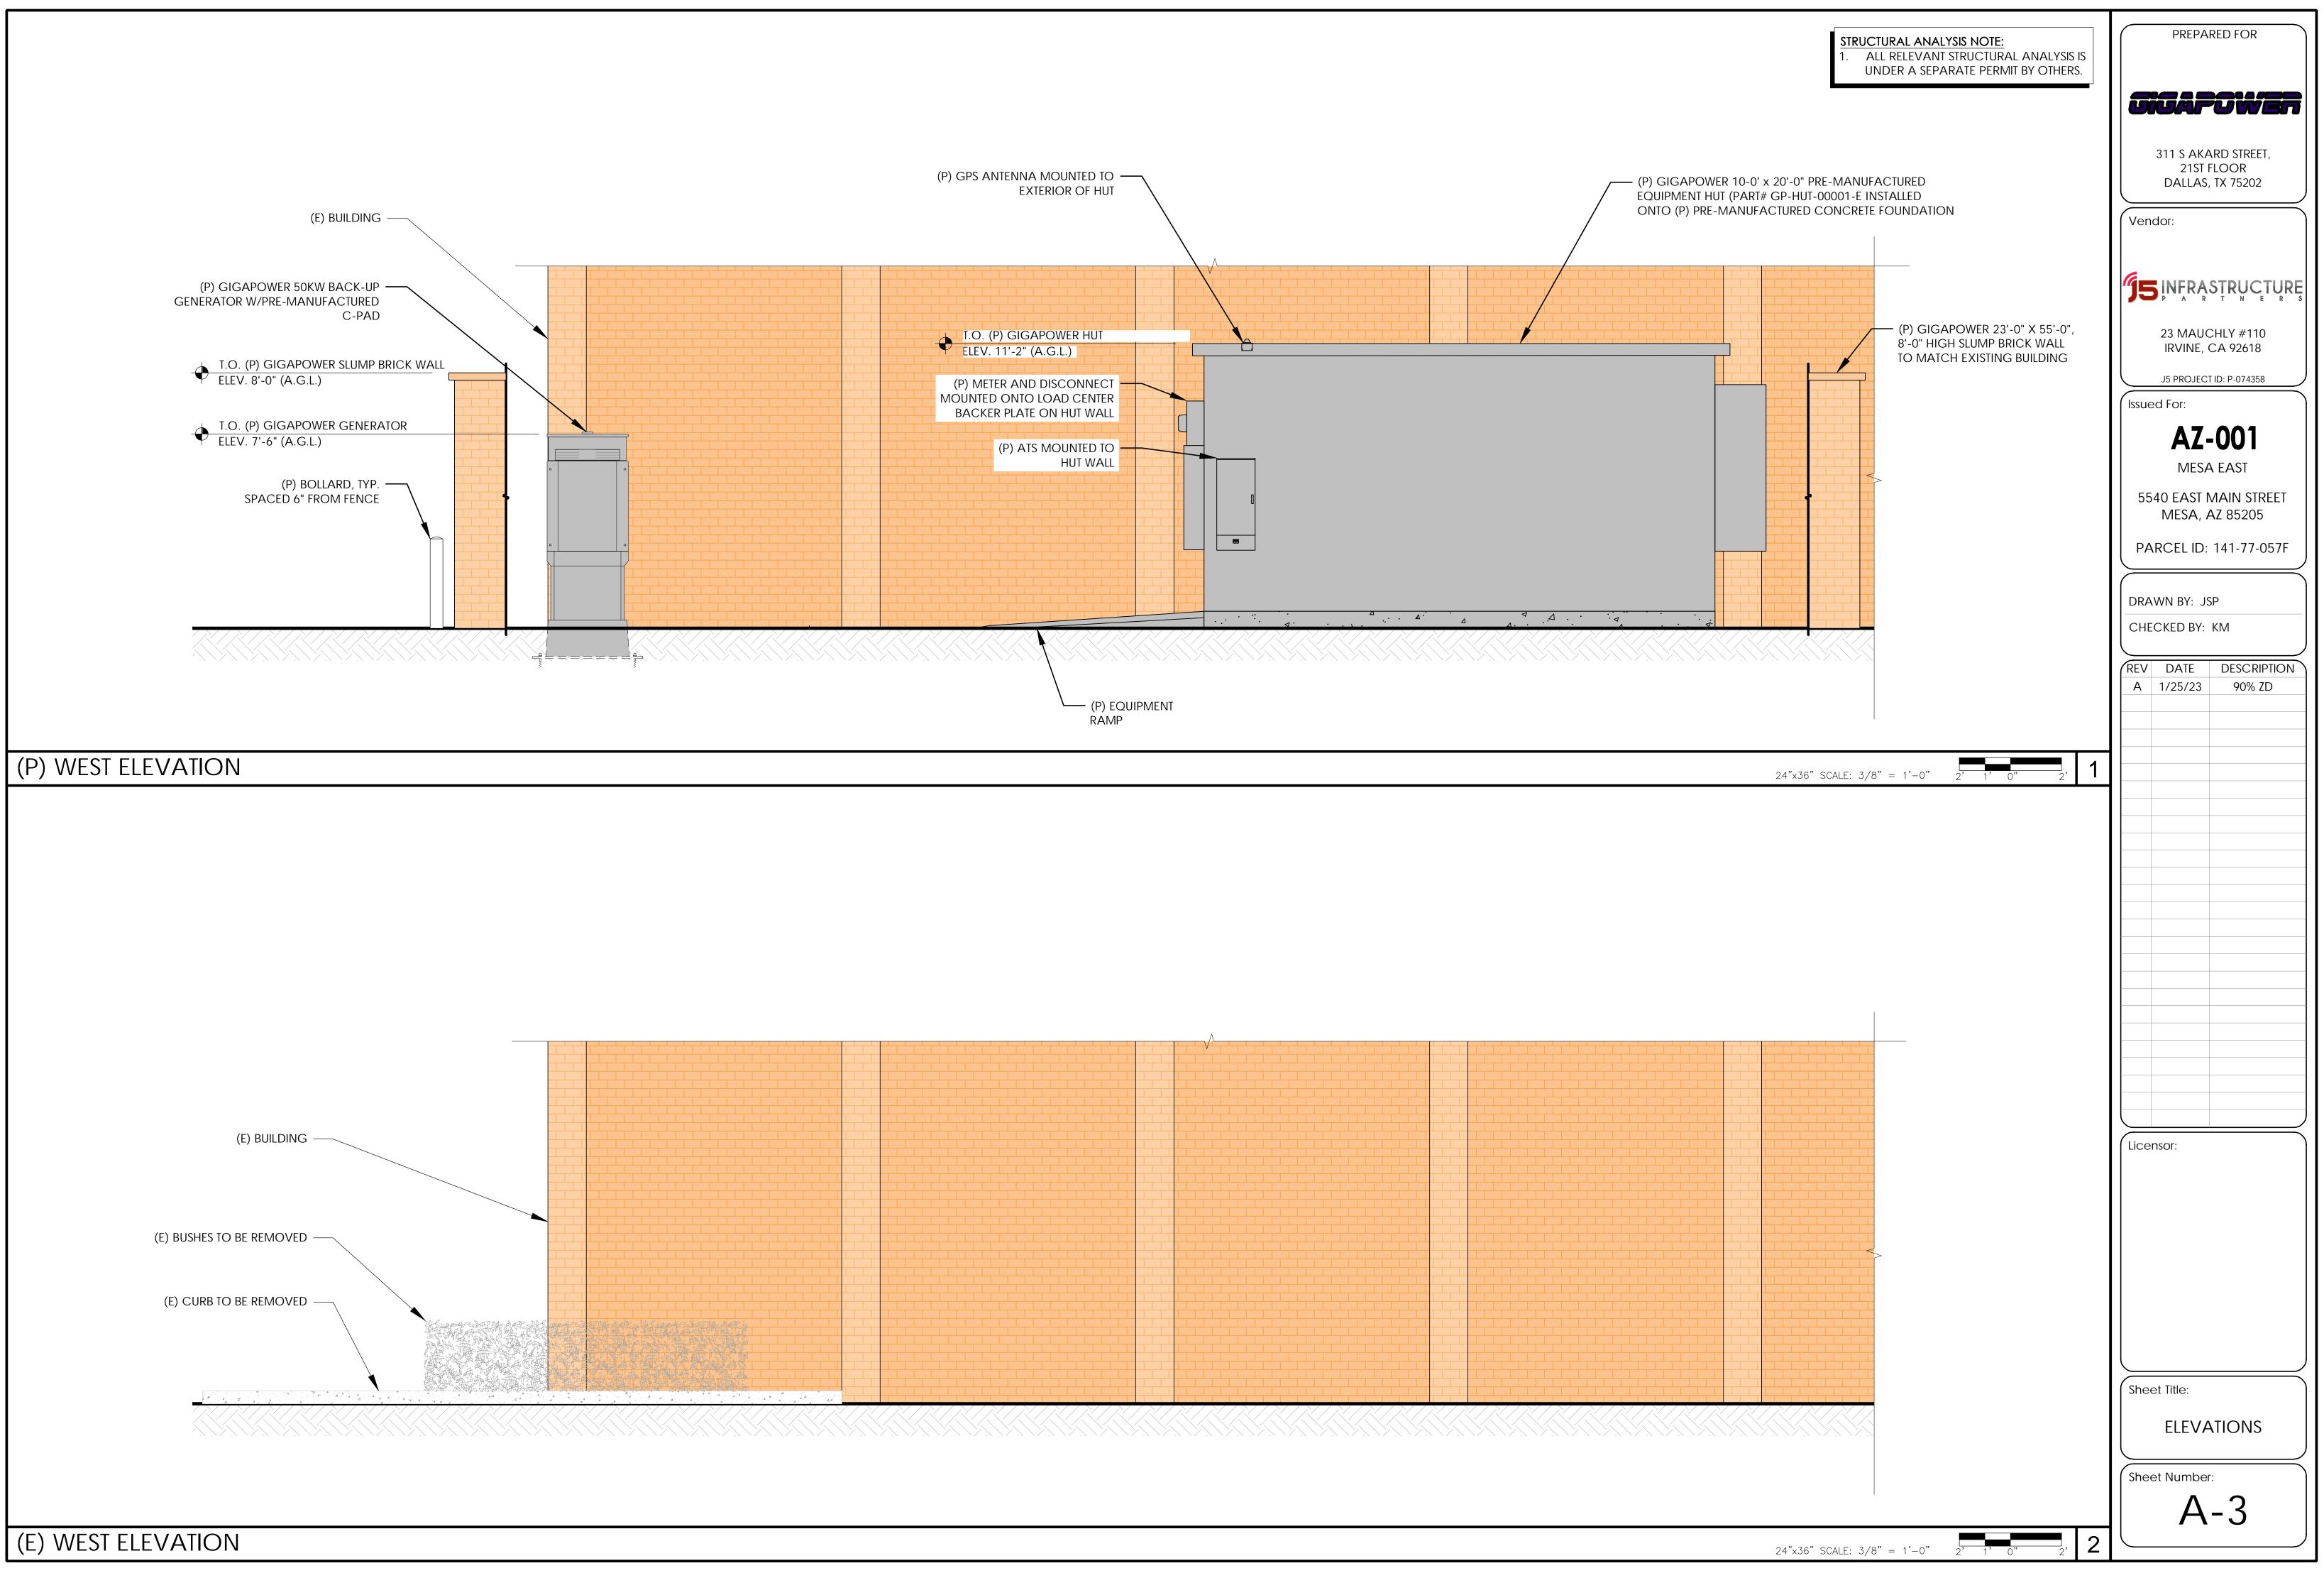

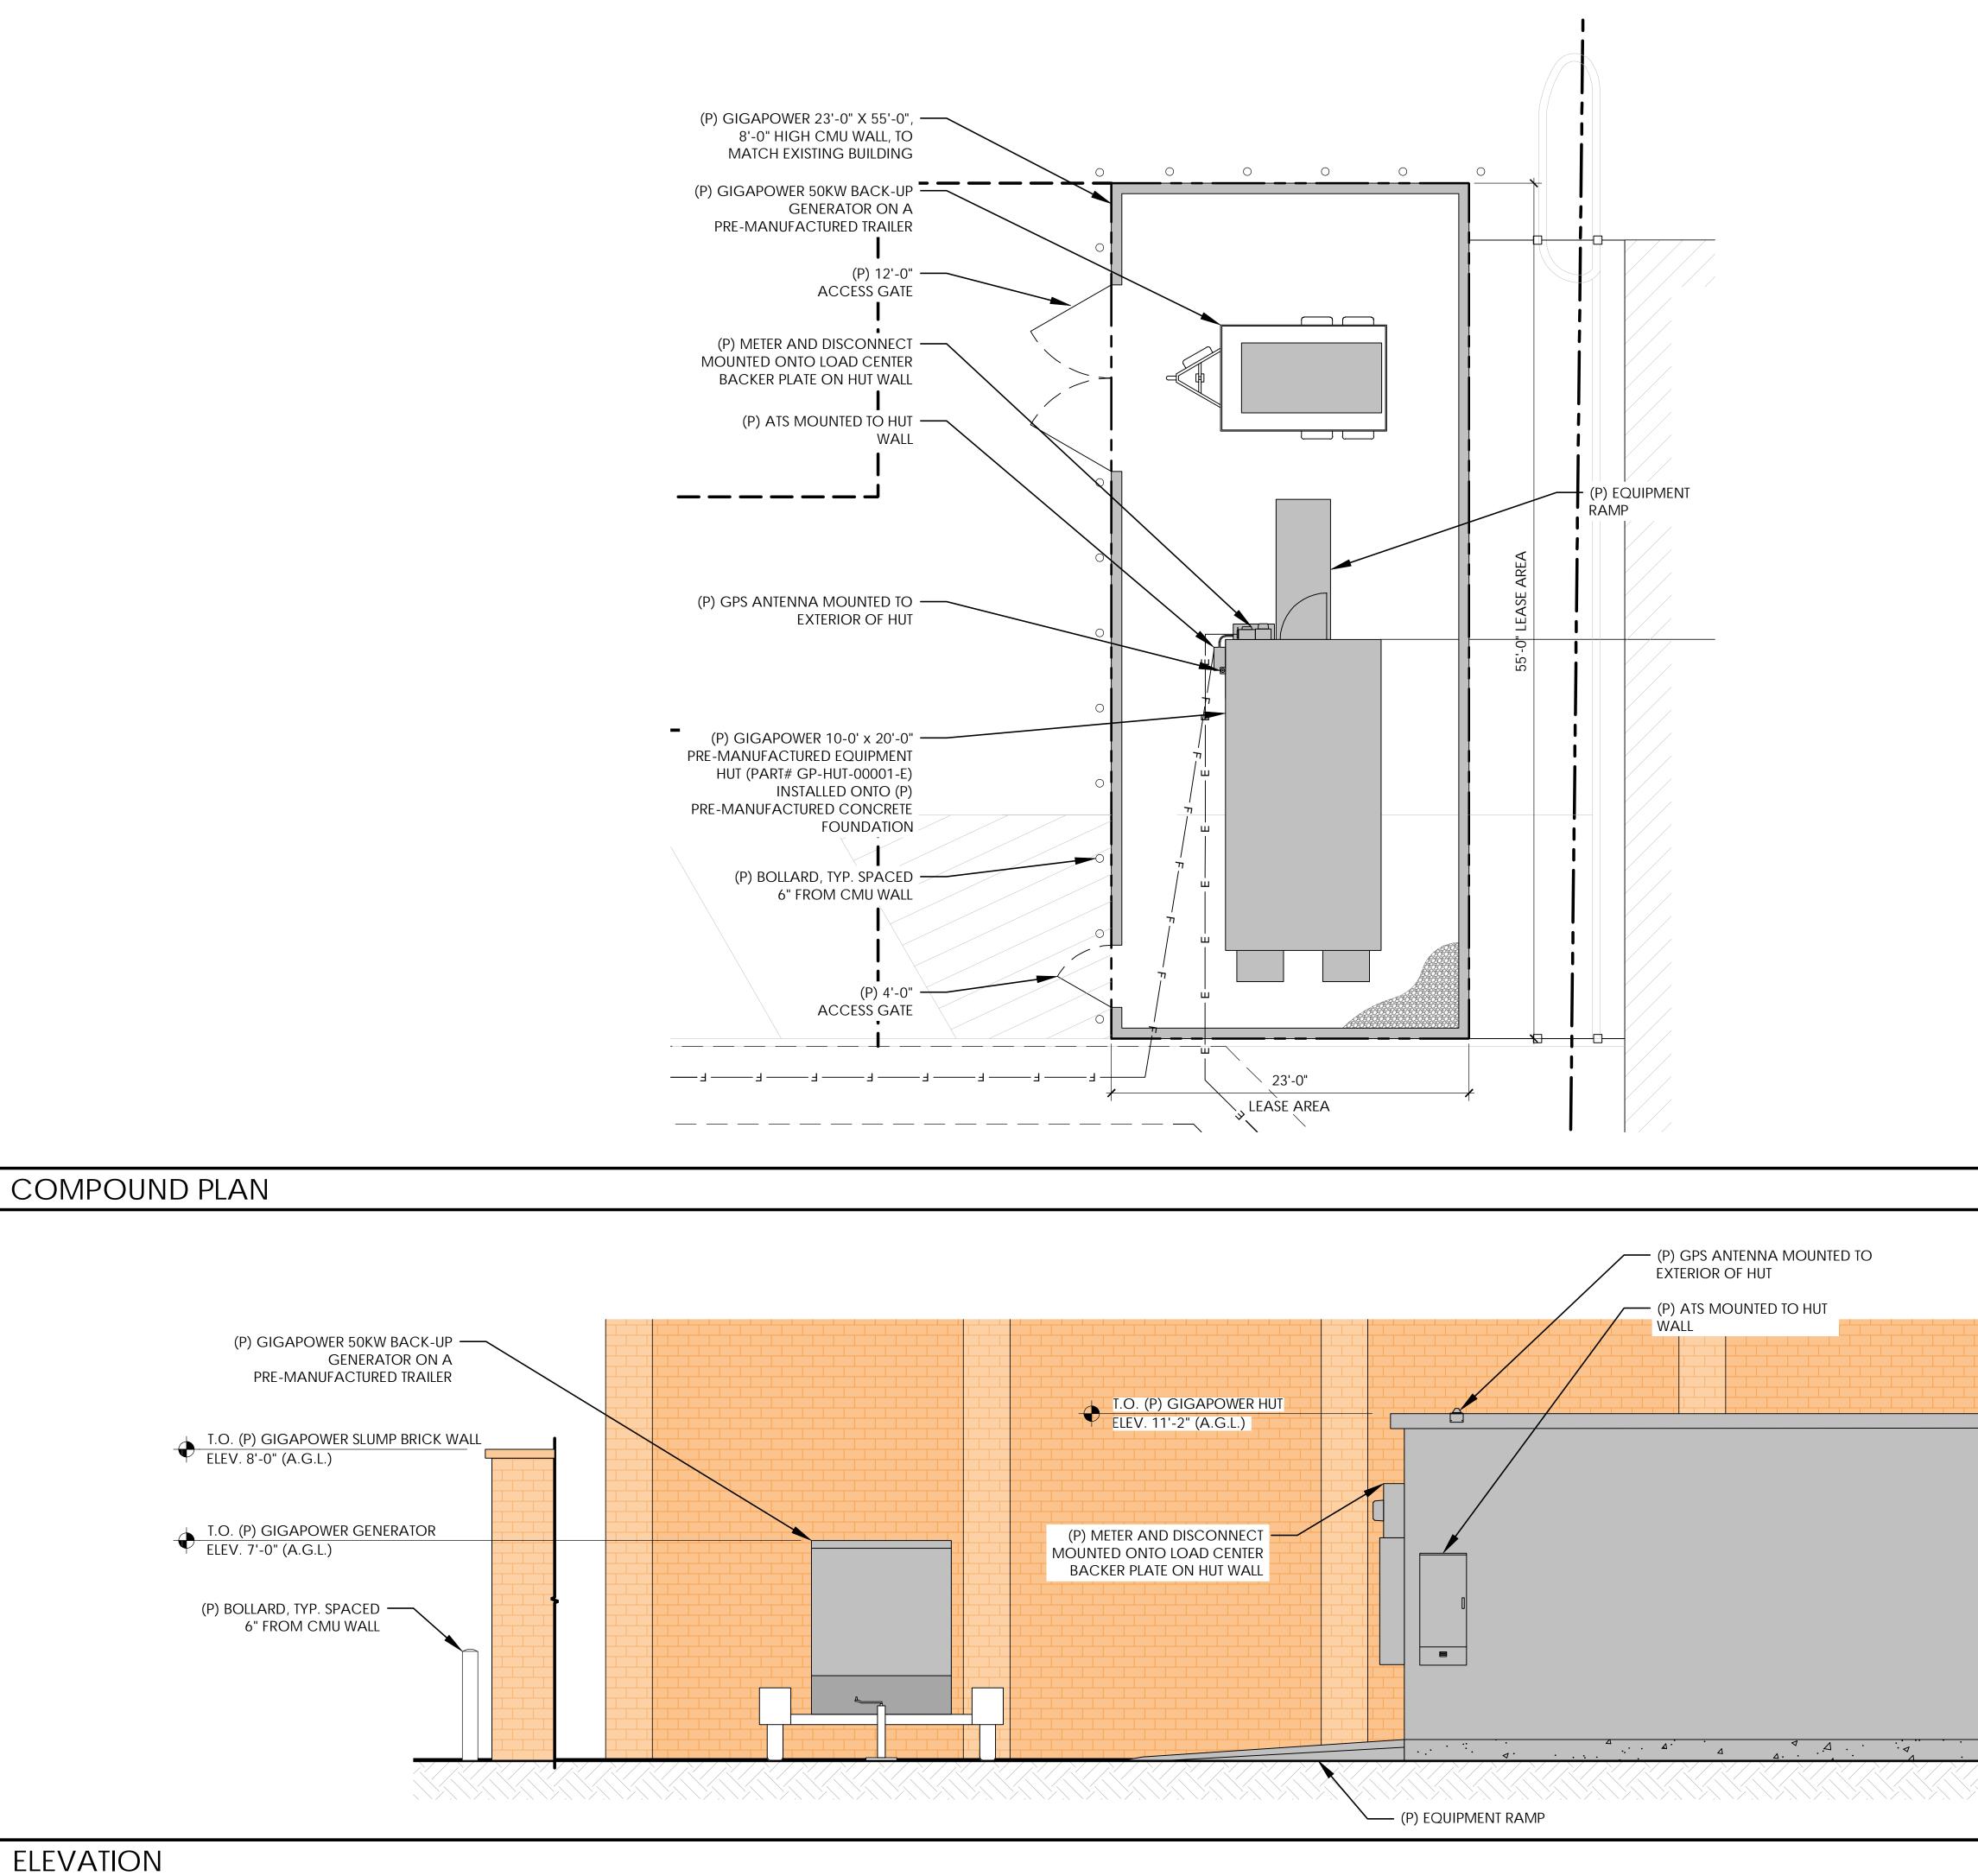

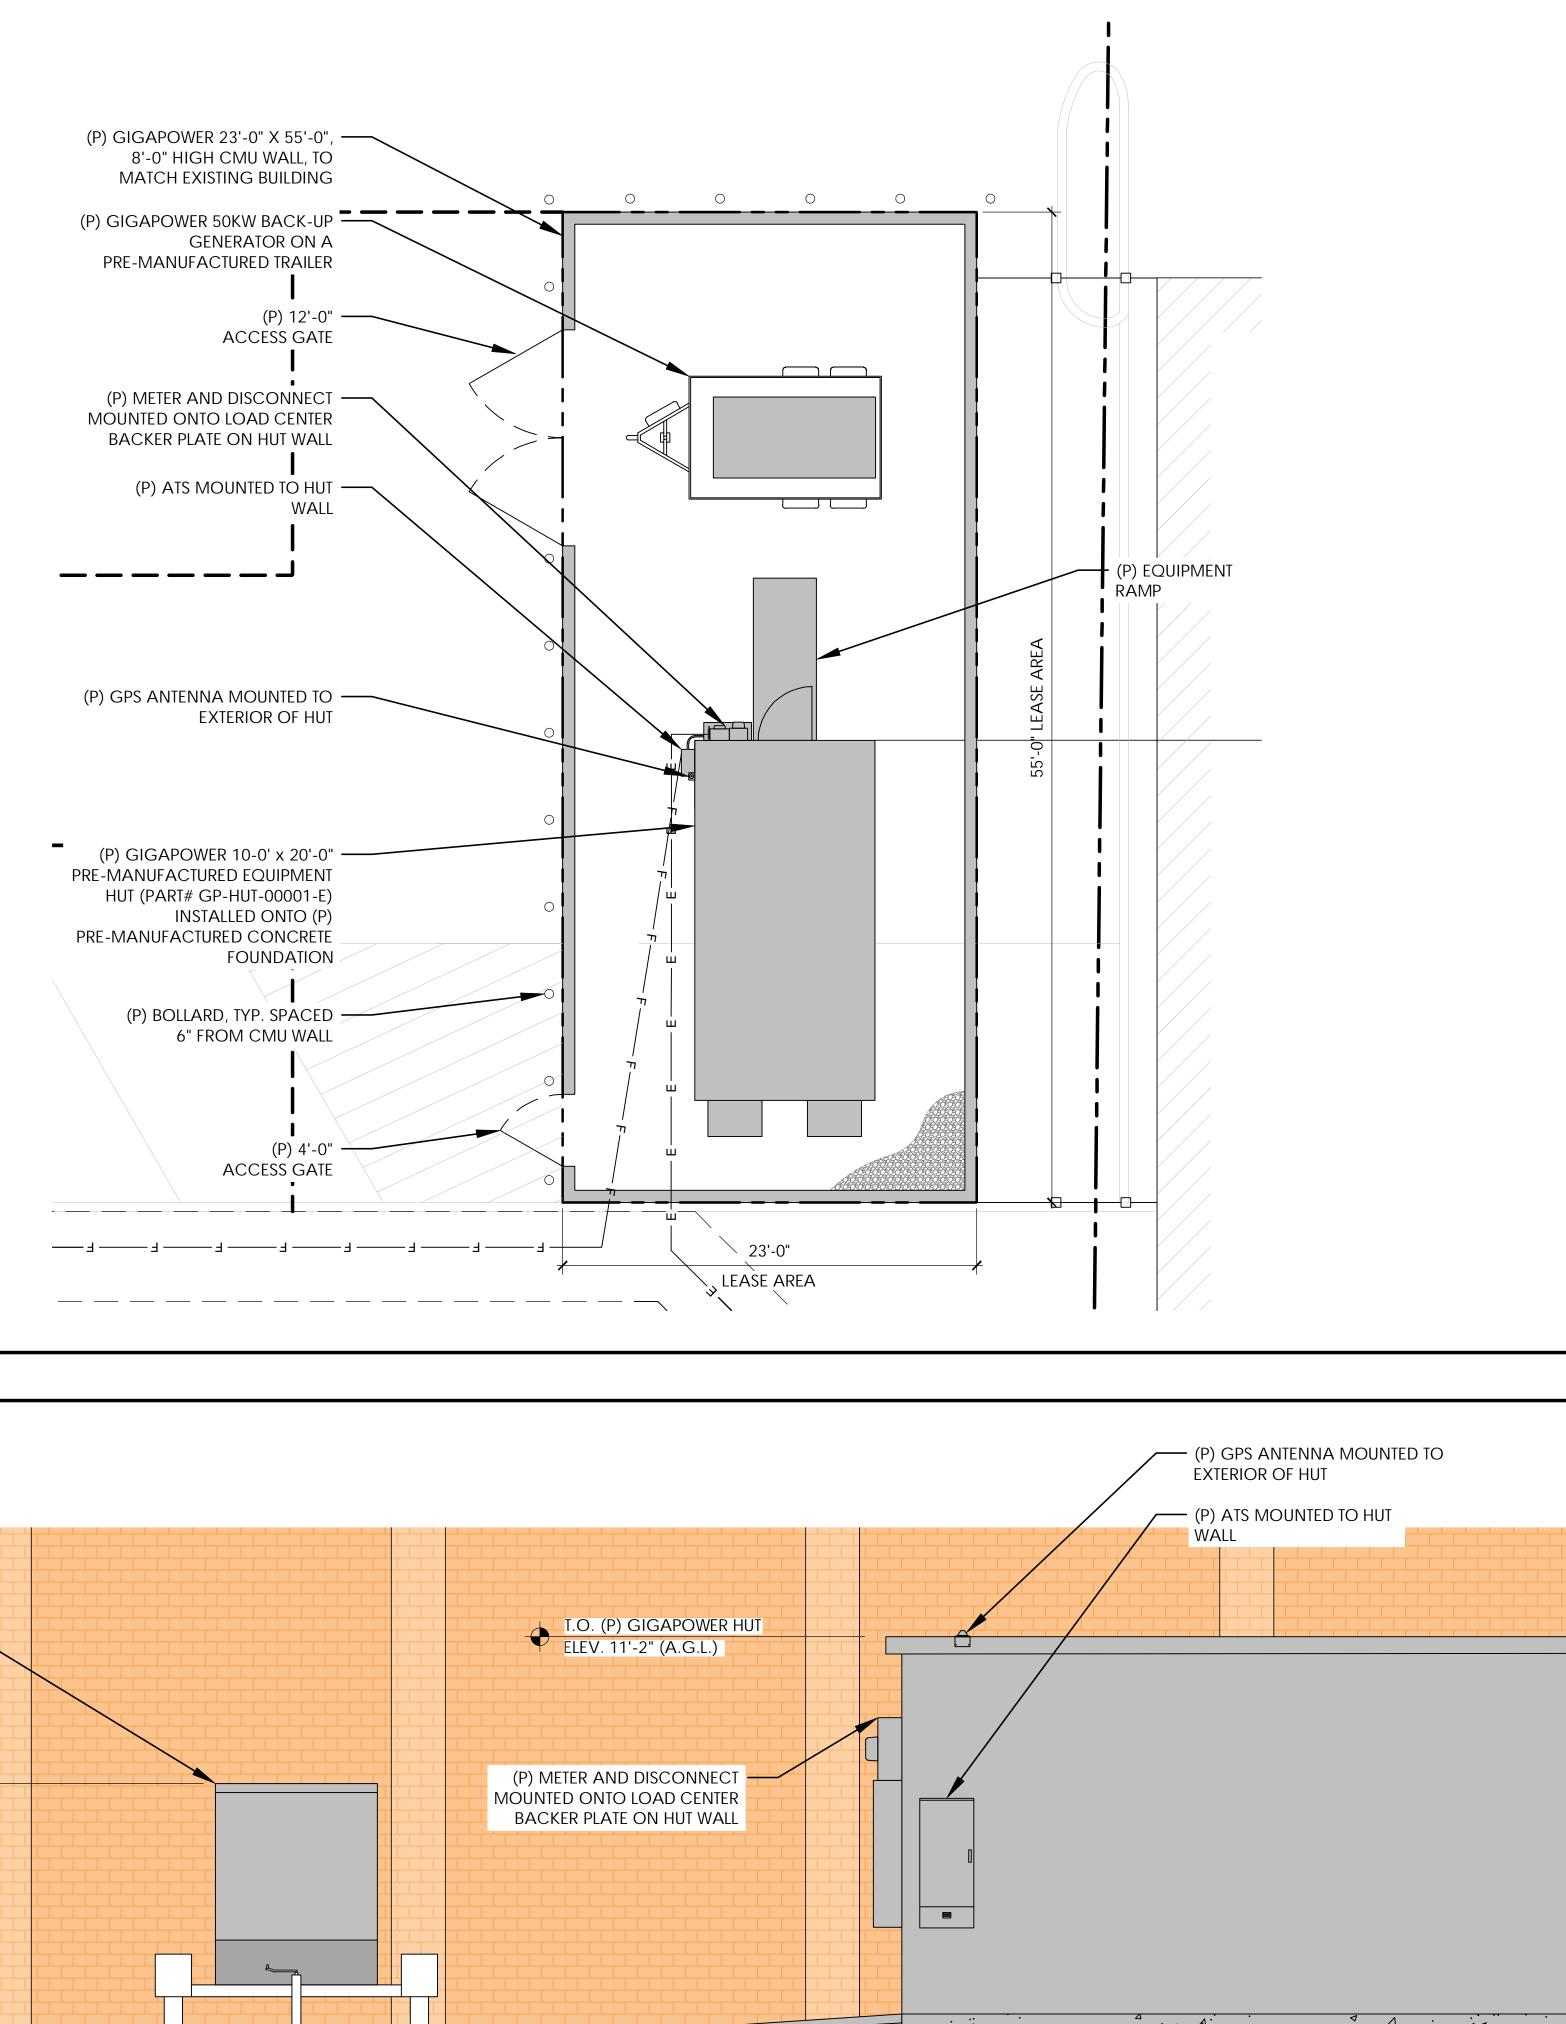

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| (P) GIGAPOWER 10-0' x 20'-0" | |
| PRE-MANUFACTURED EQUIPMENT HUT (PART# GP-HUT-00001-E) | |
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| (P) GIGAPOWER 23'-0" X 55'-0", 8'-0" HIGH CMU WALL, TO MATCH EXISTING BUILDING | |
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