

DLR Group inc. an Arizona corporation

6225 North 24th Street, Suite 250 Phoenix, AZ 85016

September 22, 2022

Project Narrative - Greenfield Industrial Design Review Board / Planning & Zoning

Pre-Application Meeting Date: December 16, 2021

Pre-Application Case #: PRS21-01194
Design Review Case #: DRB22-00730
Zoning Case #: ZON22-00731

## **Purpose of Request:**

The purpose of this request is to process a Design Review approval to allow for a new employment/industrial development. The subject site is approximately +/- 16.58 acres and is located South of McDowell Road and West of Greenfield Road.

#### **Project Summary:**

The project consists of three buildings that will be developed to meet the growing demand for employment and industrial facilities in the east valley. The buildings total approximately +/- 278,850 s.f. and each building is designed for 1-4 tenants. Surface parking is efficiently dispersed throughout the site with loading, refuse, and storage areas located at the rear of the buildings and screened from view with CMU walls. The property is currently zoned LI Light Industrial with Airfield Overflight Areas AOA 2 & AOA 3. The proposed use is allowed in this district and fits within the city General Plan for the area.

## Site Design:

#### Streets and Access

The primary access for this project will be from McDowell Road for Building 1, and Greenfield Road for Buildings 2 and 3. Secondary access for truck yard access has been provided on both McDowell Road and Greenfield Road separate from primary visitor/employee access.

The City of Mesa's 2040 Transportation Master Plan has identified McDowell Road and Greenfield Road as 4 lane arterial streets with existing 55' ROW, with the exception of a 146.5' portion of McDowell Road that has an existing 40' ROW. As part of this project the ROW along McDowell will increase to 75' along the entire length of the parcel. Greenfield Road will increase to 65' ROW along the entire length of the parcel with this project. Greenfield Road links directly with the Loop 202 approximately 1 mile to the north and McDowell Road links directly with the Loop 202 approximately 3 miles to both the east and west of the site. Regional circulation also includes State Route 87 located 6 miles west at the interchange with the Loop 202 and U.S. Route 60 located 5.5 miles south.

Project Narrative – Greenfield Industrial September 22, 2022 Page 2

## **Building Placement & Orientation**

The site is designed, and the building is placed to efficiently use the site while providing a strong relationship to the street and visual interest in areas visible from public view. Site infrastructure includes a complimentary landscape palette, hardscape paving, site screen walls and site lighting.

#### Drainage

Regional topography around the site generally falls from north to south, however the onsite topography generally falls from west to east. The site does not currently accept offsite flows from surrounding properties or bordering roads.

The proposed drainage plan will capture and retain both the onsite flows and runoff generated from the proposed half-street improvements. Once the runoff is captured it will be conveyed by storm drains where it will be retained by 4-120" CMP underground retention tanks. The underground retention tanks will be bled off using an orifice plate to control the discharge rate into the existing storm drain below Greenfield Road. All storm drainage will be designed to City of Mesa Standards and coordinated with city staff.

#### Parking, Loading, & Vehicular Access

Parking is dispersed throughout the site to provide convenience for employees and visitors. Parking has been provided for Office and Industrial to meet the City requirements. Please refer to architectural site plan data information for required and provided parking.

A decorative masonry screen wall is provided along McDowell Road and Greenfield Road to screen parking from public view and identify public entry and access. Landscaping is also provided throughout the parking areas (except in loading areas). The loading and service areas for the project are internal to the site, screened from public view by the buildings, screen walls and landscape.

### Landscaping & Shading

Landscape Theme: The selection of plant material prescribed for trees, shrubs, groundcovers and accents will be selected from the Arizona Department of Water Resources low water use plant list for the Phoenix Active Management Area (Phoenix AMA). The landscape theme will include enhancing the quantities of trees and shrub massing at strategic points along the Greenfield and McDowell Road frontages and the interior private streets.

Landscape Design: Per the Landscape section of the Mesa Zoning ordinance a vast number of areas need to be quantified and data tables need to be provided on the landscape plans to show compliance. The landscape drawing provided shows the required and provided categories for all areas onsite and the proposed design meets or exceed the Mesa requirement in all categories.

Landscape Pedestrian Areas: The proposed landscape and pedestrian area designs provide enhanced shade for pedestrians. Additionally, the pedestrian plaza spaces offer enhanced spaces for pedestrian use, which includes shade, seating, trash receptacles, synthetic turf, and paver hardscape materials.

## Screening

Along the McDowell and Greenfield Road frontages, there will be primarily 3'-4" of screening installed along the front of the parking stalls with periodic breaks to an offset shorter 3'-0" of screening in the form of a CMU wall or in combination with a landscaped berm. Longer stretches of CMU parking screen walls shall have accent block at intervals no greater than 10'-8". Truck courts, where visible from Greenfield Road, shall be screened with an 8'-0" height CMU wall with accent block at intervals no greater than 40'-0".

Project Narrative – Greenfield Industrial September 22, 2022 Page 3

#### Refuse

Refuse is anticipated to be provided within the service yards away from public view with bollard protection. Generally, the project is served by several double bin refuse enclosures, which are located in the loading area. The enclosures are screened from the street by the buildings and the 8-foot-tall masonry screen walls at each side of the loading area. Rolling gates to the loading areas are opaque to screen containers from view.

## **Exterior Lighting**

Lighting fixtures have been chosen to be harmonious with the overall building design and architectural theme of the project. Exterior lighting consists of energy efficient LED lighting for parking and service yard areas on sustainable timed control systems. Accent lighting is provided at main entry points of the industrial buildings. Lighting is used to accent focal features, such as building entries. Multiple light sources will be used including decorative facade lights, thematic site lighting at the public and employee gathering areas, decorative lighting at all building entries and general area lighting in service areas.

## **Architectural Design:**

#### General Design

The highest level of architectural details for the project are focused on the building public frontage, but consistent features are shared with all the entry sides of the Project.

The nature of the anticipated industrial uses requires large buildings with tall internal clear storage capacity. The facade design has buildings that are visually broken up into smaller components by wall details including material changes, panel reveals, shadows and changes to the roof line. Weather and sun protection, as well as shade and shadow interest, are provided by adjustments in the building elevations. At the pedestrian level, canopies have been provided for visual ties to the site features and are concentrated near public and employee entrances.

## **Entrances**

As previously noted, building entrances are oriented towards the predominant public view and street frontage. Building entrances are served by pedestrian walkways and are also clearly defined by building design elements including storefront designs and metal shade canopies.

## Massing & Scale

Although the nature of the proposed use requires large buildings, the building massing is reduced by vertical or horizontal wall offsets / articulated details around entrances or other method of visual relief. These methods are continued around the sides and rear of the buildings.

## Façade Articulation

Façade articulation is provided along all facades including roofline variation, changes in materials and plane changes around building entries. Varying patterns of decorative reveals surround the building to provide visual interest and define building entries.

Project Narrative – Greenfield Industrial September 22, 2022 Page 4

#### Materials & Colors

Building colors and materials reinforce the overall building design. An architectural mix of colors, reveal patterns, and concrete is provided along with metal canopies and metal window frames with insulated glazing.

## Service Areas & Utilities

The overall site layout has been designed and oriented to keep service, loading and utility areas screened from public view. These areas are located centrally within the site. Mechanical equipment, including roof-mounted systems and roof drainage systems are architecturally screened and design to be integral to the buildings.

## Outdoor Common Amenity Area Design

The proposed design incorporates 3 pedestrian amenity areas (1 for each building). These areas provide users a beneficial outdoor space as a compliment to the indoor environments. ADA compliant seating has been provided for tenants/employees to utilize for sitting, eating, or outdoor break areas. Along with the tables trash/ash bins have been provided to encourage use for outdoor lunch time by providing ease of waste disposal. The ground plane consists of enhanced paving (pavers) to differentiate the space from the standard paving throughout the site. Synthetic turf in each of the amenity areas provides users with the ability for passive recreation being able to picnic, but also allow flexibility for company events to use actively for bocce ball or cornhole. Lastly, tree planters have been built into the amenity areas to allow seating opportunities in both the shade and sun depending on the season. The Quercus virginiana or Southern Live Oak provides a consistent evergreen canopy that is very upright and works very well in patio/urban environments. Lastly, steel umbrellas have been added to the tables to maximize the shade and promote year-round use of the exterior seating.

## Request for Special Use Permit (SUP)

Due to the clear storage capacity required by industrial uses, we are requesting a Special Use Permit (SUP) that will allow us to increase the maximum building height to 45'. This is a 5' increase from the 40' height permitted in the Light Industrial (LI) Zone. The 45' building height is necessary to achieve a 32' clear height on the interior, meeting current market requirements for industrial users. This allows enough parapet to shield the HVAC units from view, while allowing enough space for the roof structure, roof slope, RTUs, and a 2' step down to 43'.

Approval of this will advance the goals and objectives of the General Plan for this area, which was rezoned to Light Industrial (LI) in 1980 to promote this exact use in the area. The location, size, design and operating characteristics of the warehouse buildings we are proposing align with the type of development outlined within the definition of the Light Industrial zone within the Mesa Zoning Ordinance:

LI Light Industrial. To provide areas for limited manufacturing and processing, wholesaling, research, warehousing, and distribution activities take place within enclosed buildings, with restricted accessory outdoor storage as needed to support the primary uses. Light Industrial areas can be used to buffer General Industrial uses from other less intense uses. This district also provides for a full range of commercial activities, generally on a limited scale, including high-impact commercial uses, outdoor display and outdoor sale. Individual developments include well-designed buildings on sites that may or may not have campus-like settings, and areas visible to the general public include well-designed landscape areas.

The proposed project will not be injurious or detrimental to the adjacent or surrounding properties in the area, which include other warehouses, properties zoned Light Industrial (LI) and Planned Employment Park (PEP), and Falcon Field Airport. We have confirmed that adequate public services, public facilities and public infrastructure are available to serve the proposed project.

# Request for Alternative Compliance - Maximum 50% Façade material and colors per Section 11-7-3(B)(6) of the MZO:

Section 11-7-3(B)(5)(b) – No more than fifty percent (50%) of the total façade may be covered with one (1) single material.

The approving body shall find that the request meets the following criteria from Section 11-7-3(B)(6)(b)(iv):


- Space limitations, unusually shaped lots and prevailing practices in the surrounding neighborhood, may justify alternative compliance for bypassed parcels and for improvements and redevelopment in older neighborhoods.
- The proposed alternative is aesthetically more complementary to the site, better fits into the context of the area, improves the overall architectural appeal of the area and/or meets or exceeds the design objectives as described in the City's General Plan.
  - RESPONSE: The building type that is typical for industrial, manufacturing, and warehousing uses of this size are typically constructed out of concrete tilt up panels which allows for the final product to be both durable for the tenant and cost efficient for the developers. The standard sizes, details and construction type help provide an efficient layout for users planning to use the space. The construction of this product type does heavily rely on these known factors for economic feasibility and does not fit with the Mesa Zoning Ordinance requirement to provide no more than 50% of one single material and therefore seeking Alternative Compliance Approval for this project. The design aligns with the intent of the design standards as well as other approved projects within the City of Mesa and provides variation in massing, vertical and horizontal articulation, enhanced building entries with framed accents, canopies to address human scale elements. The elevations also vary the façade with multiple shades on the field and as accents, recessed storefront with metal shade canopies at the entry areas to better define the arrival experience, and ribbed reveal patterned accent panels that will help set a standard for future developments within the surrounding Light Industrial (LI) zones. Per the City's request, we calculated the areas based on color and material changes. The longer north and south elevations are in compliance with the above section. The shorter east and west facing facades of Building 1 exceed 50% of Color 'A' (Building 1 = 58%). Refer to elevations for calculations.

## **Request for Modification of Zoning Stipulations**

The current zoning district of L-1 (Light Industrial) on the subject property was approved by the City of Mesa City Council on June 6, 1980 through zoning case #Z80-47 (Note: original zoning designation was identified as M-1 at the time). The approval of Z80-47 also included the following stipulations:


- 1. Additional right-of-way requirements:
- 2. All access to be from Greenfield Road:
- 3. That two rows of citrus trees and a wall be maintained along the western boundary of the property as a buffer.

The purpose of the stipulations were to address some comments that came before the City from some adjacent neighbors regarding the desire for some buffering of their properties from the industrial use and for the access to be away from the AG zoning uses. As shown in the map clip below (Zoning Map from Z80-47), the surrounding zoning to the north, west, and south at the time were all zoned as AG. With that historical zoning pattern, it made sense for the Council to add those stipulations to address the neighbor's concerns.

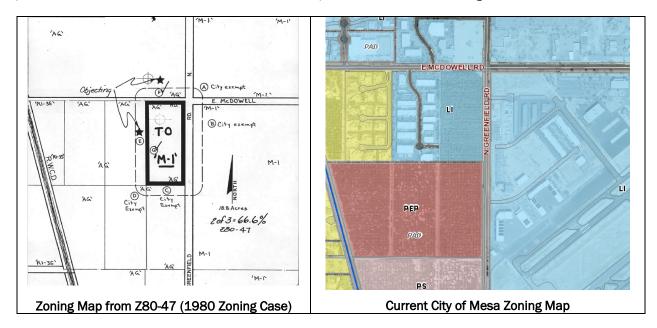

However, the surrounding development and land use patterns have changed over the past 40 years since the 1980 zoning case was approved. As shown in the map above (<u>Current City of Mesa Zoning Map</u>), the current zoning map exhibits that the property is now surrounded by a mixture of LI (Light Industrial) and PEP (Planned Employment Park) zoning designations and the development pattern has followed the City's vision for the development of employment and light industrial uses around the Falcon Field Airport.

As such, the original stipulations approved with the Z80-47 rezoning case are no longer applicable to the proposed development request. As part of this request, the Applicant respectfully requests that the stipulations be removed to allow for the proposed development of the Site Plan and SUP requests of this Application.

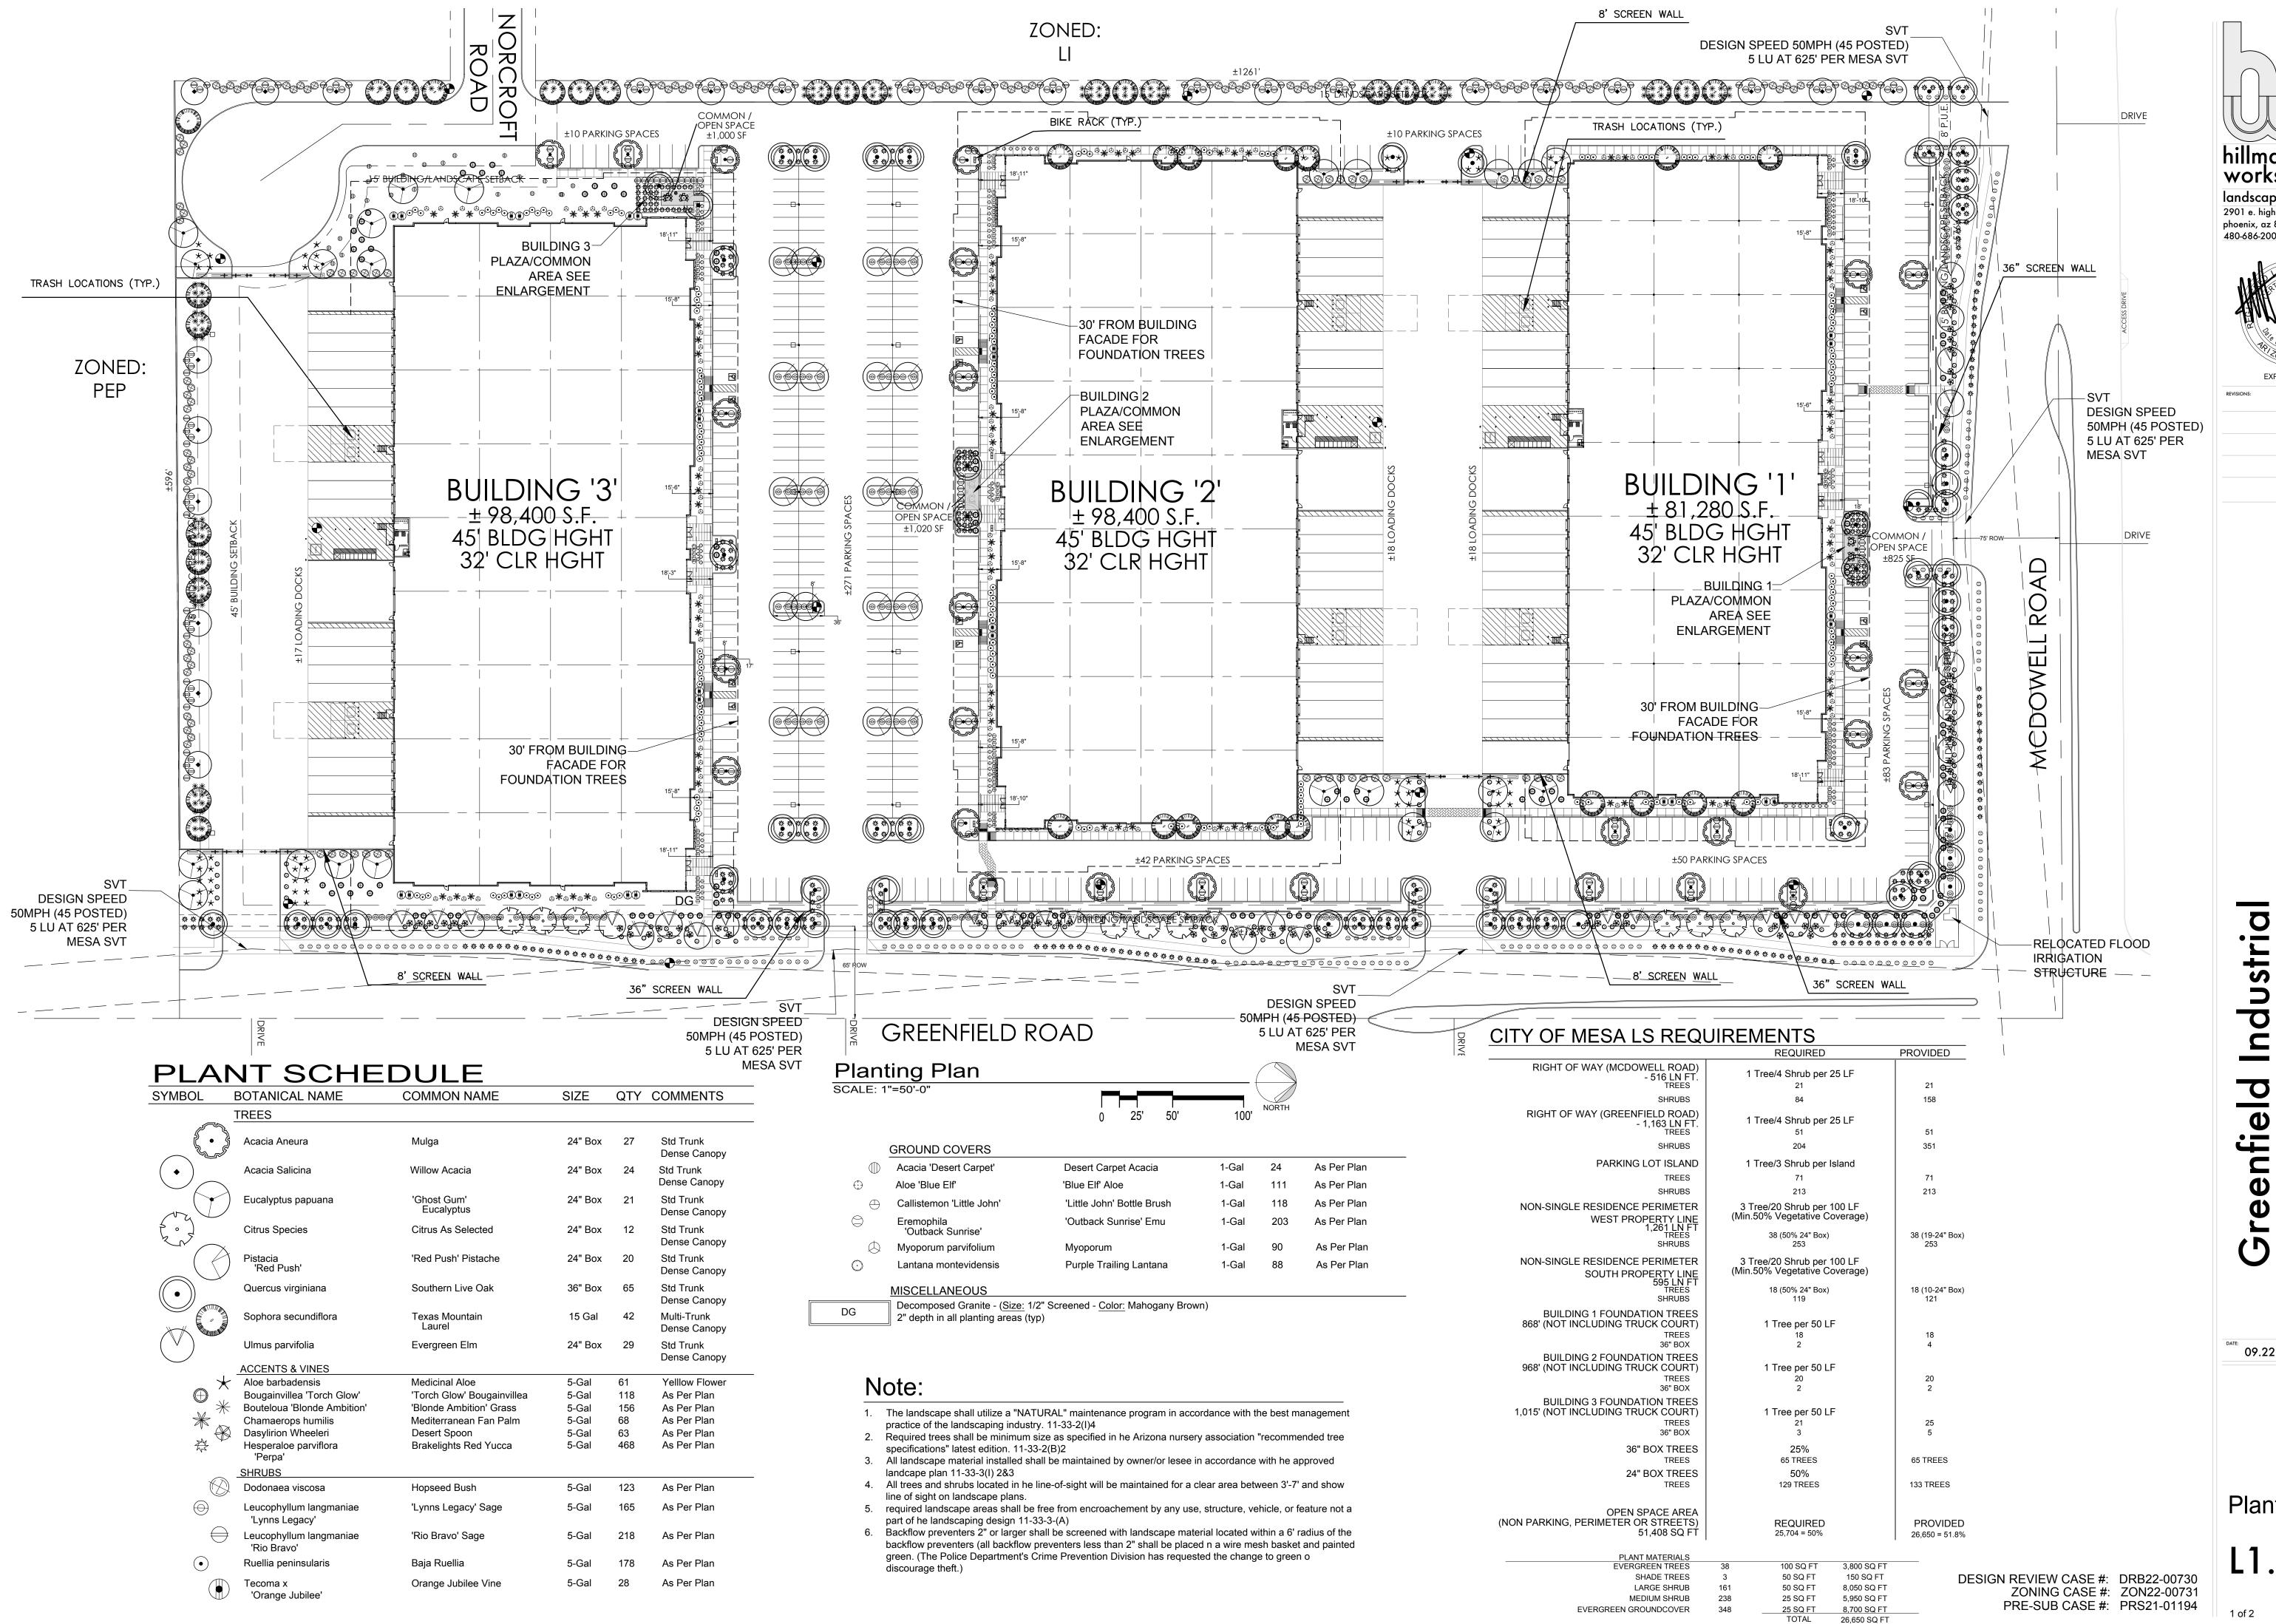


hillman workshop landscape architecture 2901 e. highland ave phoenix, az 85016 480-686-2001



EXPIRES 09/30/25

09.22.22

Planting Plan

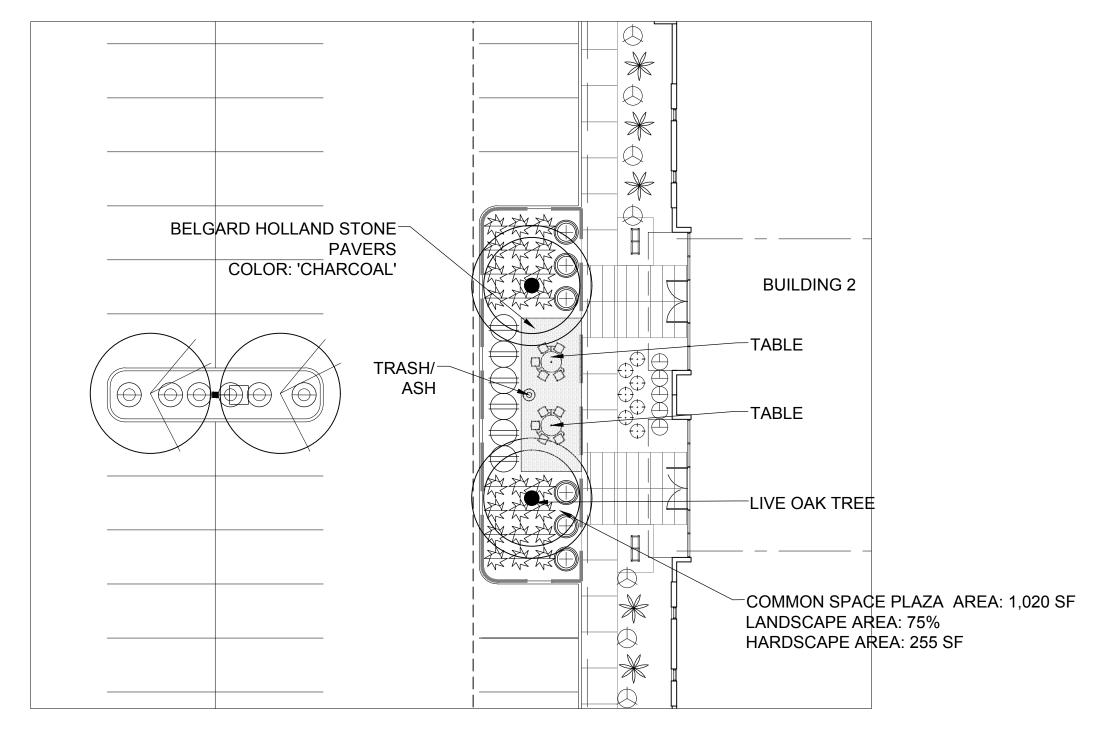




LANDSCAPEFORMS SOLSTICE CYGNUS UMBRELLA COLOR: 'WHITE'




SCALE: 1/16"=1'-0"



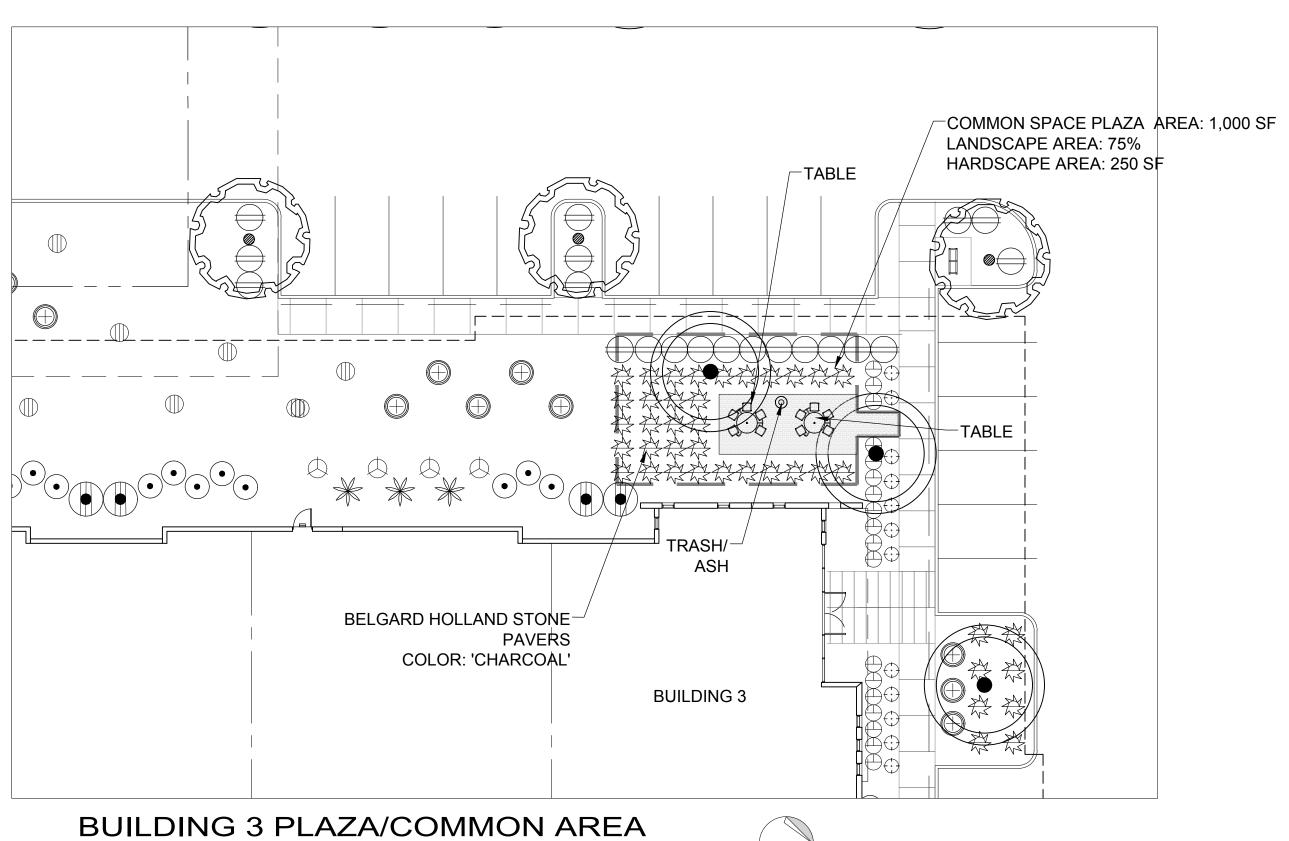



LANDSCAPEFORMS SIDE OPENING LITTER RECEPTACLE, WITH SAND PAN, WITH LOCK COLOR: 'WHITE'

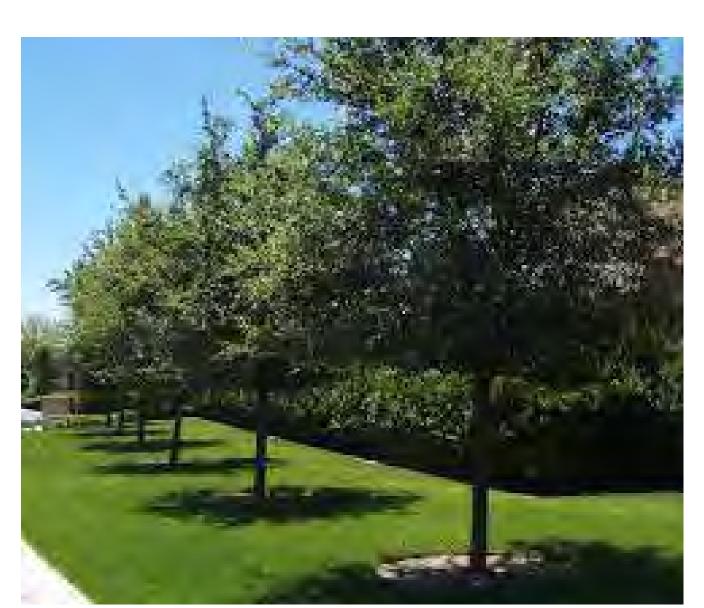

QUERCUS VIRGINIANA SOUTHERN LIVE OAK TREE



LANDSCAPEFORMS
MINGLE TABLE BACKLESS 5 SEAT
SURFACE MOUNT, PERFERATED,
WITH UMBRELLA HOLE
COLOR: 'WHITE'



BELGARD HOLLAND STONE 60MM PAVERS COLOR: CHARCOAL PATTERN: 90 DEGREE HERRINGBONE

DESIGN REVIEW CASE #: DRB22-00730 ZONING CASE #: ZON22-00731 PRE-SUB CASE #: PRS21-01194





EXFINES US

Greenfield Industrial 4329 E. McDowell Road, Mesa, AZ

09.22.22


Plaza Enlargements

L2.0

# GREENFIELD INDUSTRIAL

# **LEGEND**

EXISTING		PROPOSED
	PROPERTY LINE	
	EASEMENT LINE	
	SETBACK LINE	
G	GAS LINE	——— G ———
E	ELECTRIC LINE	———UE———
	WATER LINE	
ST	SANITARY LINE STORM LINE	55
F0	TELEPHONE LINE	UT
——————————————————————————————————————	MAJOR CONTOUR	4465
	MINOR CONTOR	4464
	PROPOSED CONSTRUCTION LIMITS	• • • • • • • • • • •
***	FIRE HYDRANT	~
₩V	WATER VALVE	w∨ ⊠
	SANITARY CLEANOUT	•
	SAWCUT LINE	
	LIGHT DUTY CONCRETE	
	HEAVY DUTY CONCRETE	
	LIGHT DUTY ASPHALT	
	HEAVY DUTY ASPHALT	
	LANDSCAPING	
	SPOT GRADE	1200.00 (TOP OF CURB) 1199.80 (FINISH PAVEMENT)
	SWALE/SLOPE INDICATOR	<u>#</u> .#%
	TRANSFORMER PAD	
	PARKING COUNT	#
\$	LIGHT STANDARD	■•
	CATCH BASIN	
	CURB INLET CATCH BASIN	
	SIGN	
	STORMWATER MANHOLE	

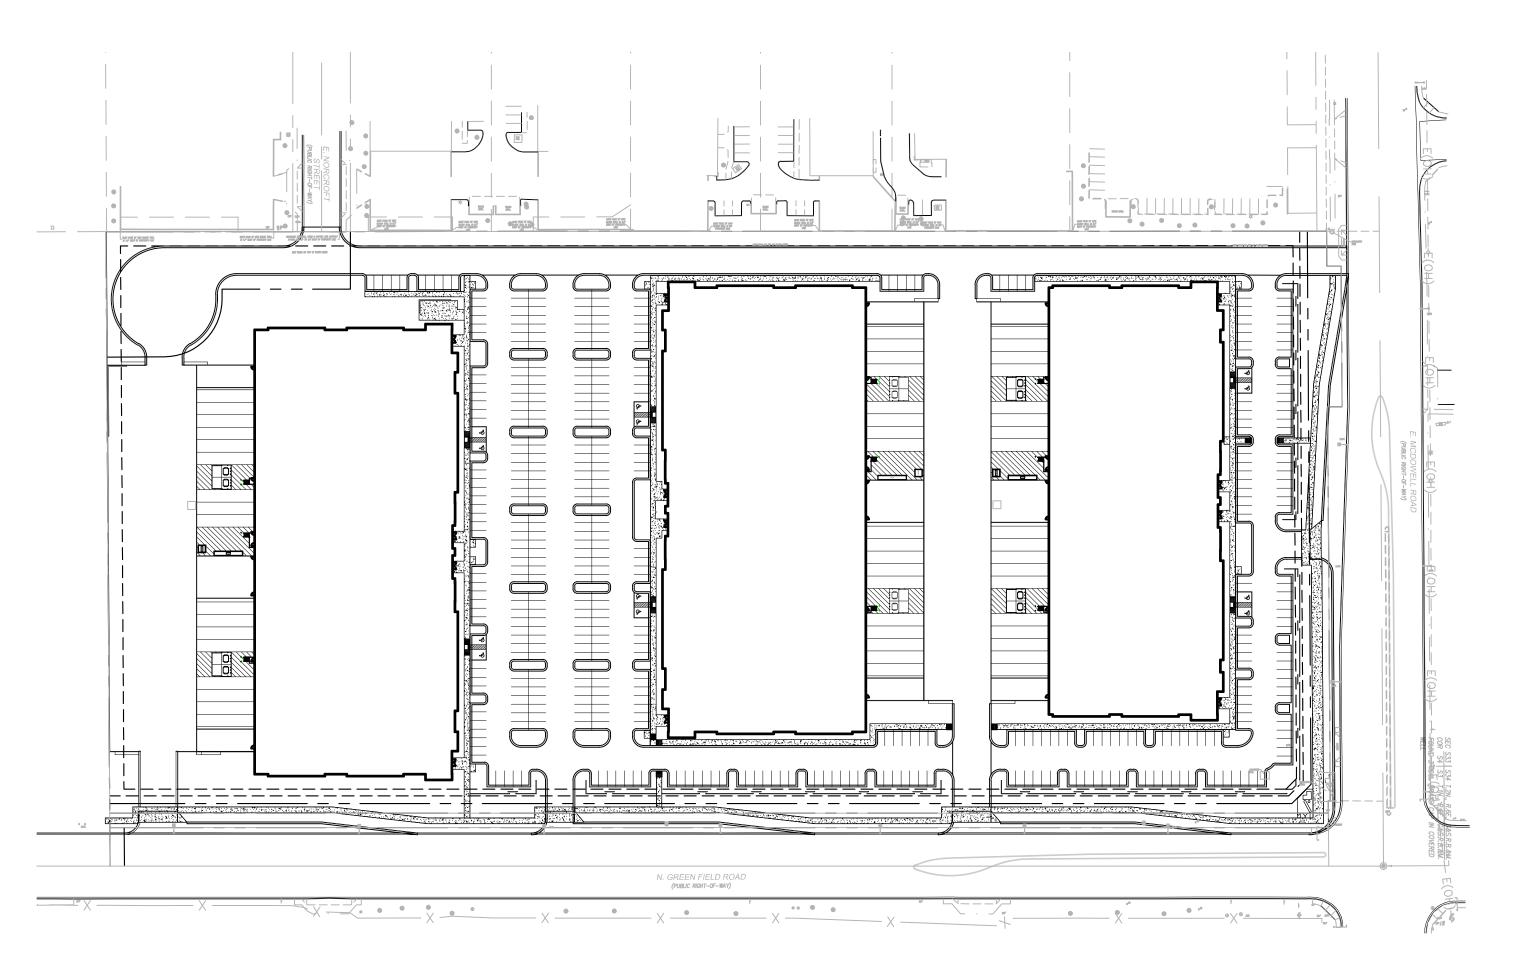

# SITE DATA

PROJECT:	GREENFIELD INDUSTRIAL
PROJECT ADDRESS:	SWC OF GREENFIELD RD & MCDOWELL RD
	MESA, AZ
DEVELOPER:	HOPEWELL DEVELOPMENT
SCOPE:	A NEW INDUSTRIAL BUILDING
ASSESSOR PARCEL NO.:	141-26-006E
EXISTING ZONING:	LI
PROPOSED ZONING:	LI
PROPOSED USE:	INDUSTRIAL
SITE AREA (GROSS):	±876,586 S.F. (20.12 AC)
SITE AREA (NET):	±722,489 S.F. (16.58 AC)
BUILDING AREA:	±279,200 S.F.
IMPERVIOUS AREA (BUILDING AREA + PAVEMENT)	±633,372 S.F.
STORIES:	1
LOT COVERAGE:	36.9% (90% ALLOWABLE)
OCCUPANCY:	B / S-1
CONSTRUCTION TYPE:	V-B
SCREENING HEIGHT:	42"
RUII DING HEIGHT:	+45'-0"

# SITE BENCHMARK INFORMATION

SANITARY SEWER MANHOLE

MARICOPA COUNTY DEPARTMENT OF TRANSPORTATION BENCH MARK, BEING A 3" DIAMETER MESA BRASS CAP IN HANDHOLE 0.5' DOWN, NO STAMPING AT THE CENTERLINE INTERSECTION OF MCDOWELL ROAD AND GREENFIELD ROAD.

## BASIS OF BEARING


GRID NORTH PER THE ARIZONA STATE PLANE COORDINATE SYSTEM, CENTRAL ZONE.

±45'-0" BUILDING HEIGHT:

## **GENERAL NOTES**

- 1. ALL SIDEWALKS SHALL BE CONSTRUCTED TO MAG STANDARDS AND THE CITY OF MESA.
- 2. ALL PROPOSED IMPROVEMENTS SHALL BE CONSTRUCTED TO MAG STANDARDS AND THE CITY OF MESA.
- 3. A LAND DISTURBANCE PERMIT WILL BE REQUIRED.
- 4. ALL DIMENSIONS TO EDGE OF PAVEMENT OR FACE OF CURB.

# VICINITY MAP N.T.S.

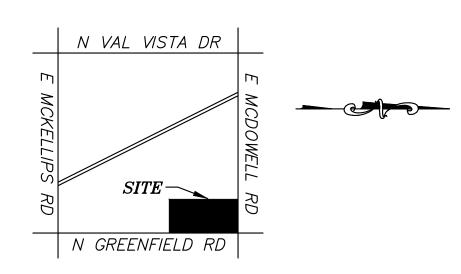

# **INDEX**

		<b>REVISIONS</b>								
		1	2	3	4	5	6	7	8	9
C1.0	COVER SHEET									
C2.0	SITE PLAN									
C2.1	FIRE ACCESS PLAN									
C3.0	GRADING PLAN									
C4.0	UTILTIY PLAN									

## PARKING CALCULATIONS

- / 11 11 1		<u></u>	
BUILDING 1 AR	REA CALCULATIONS		
OCCUPANCY	1ST FLOOR	TOTALS	
INDUSTRIAL	±81,500 S.F.	±81,500 S.F.	
TOTAL:	±81,500 S.F.	±81,500 S.F.	

BUILDING 2 AREA CALCULATIONS
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OCCUPANCY	1ST FLOOR	TOTALS
INDUSTRIAL	±98,500 S.F.	±98,500 S.F.
TOTAL:	±98,500 S.F.	±98,500 S.F.
	•	

BUILDING 3 AREA CALCULATIONS


BUILDING 3 AR	EA CALCULATIONS		
OCCUPANCY	1ST FLOOR	TOTALS	
INDUSTRIAL	±99,200 S.F.	±99,200 S.F.	
TOTAL:	±99,200 S.F.	±99,200 S.F.	

## REQUIRED PARKING CALCULATIONS

OCCUPANCY	S.F.	FACTOR	TOTAL
INDUSTRIAL	± 279,200	600	466
TOTAL			466
PARKING PROV	/IDED		
TOTAL REGULA	R SPACES		467
TOTAL ACCESSIBLE SPACES 12			
			1.7 SPACES PER 1,000 S.F.

BICYCLE	PARKING	CALCULATIONS	
			Т


RATIO	REQUIRED	PROVIDED
$\frac{1}{10}$ (1ST 50) $\frac{1}{20}$ (REMAINING)	75	76

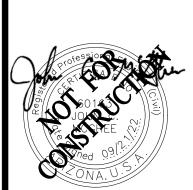


DRAWN BY CHECKED BY DRAWING SCALE AS SHOWN


> 09/21/2022 Job Number

22-0089 Sheet Number

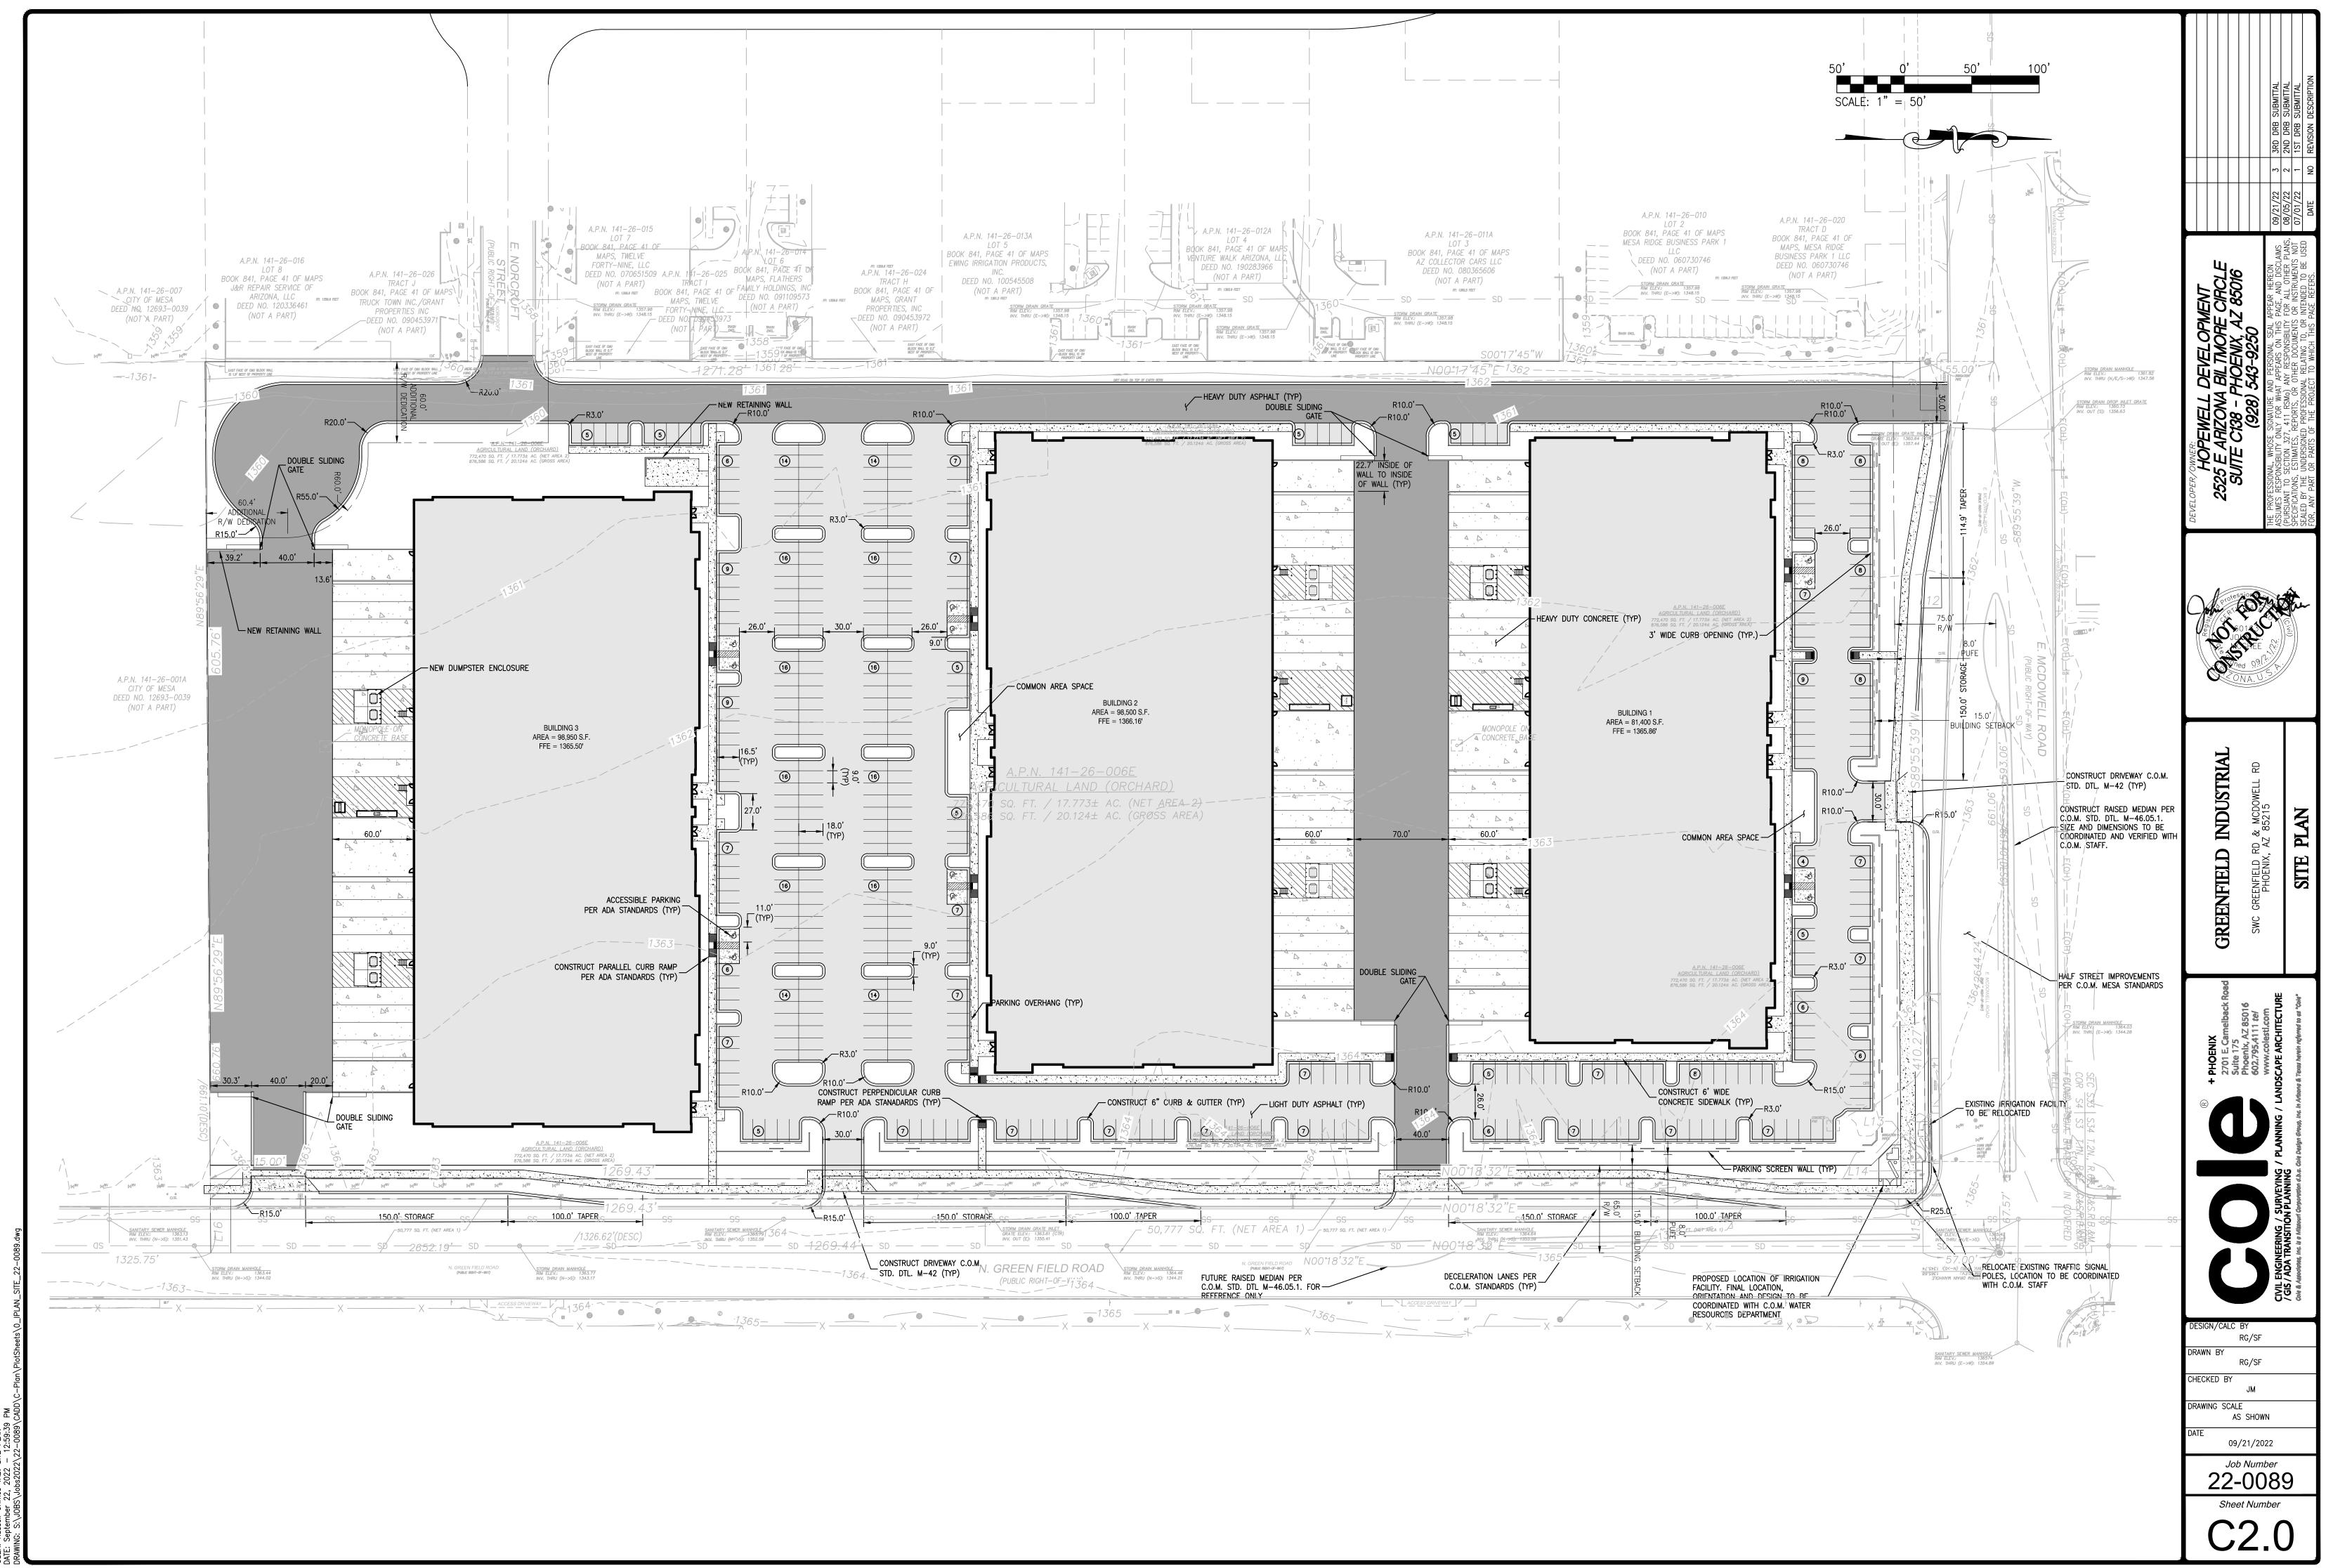


R: Russell Grimes TAB: SITE PLAN

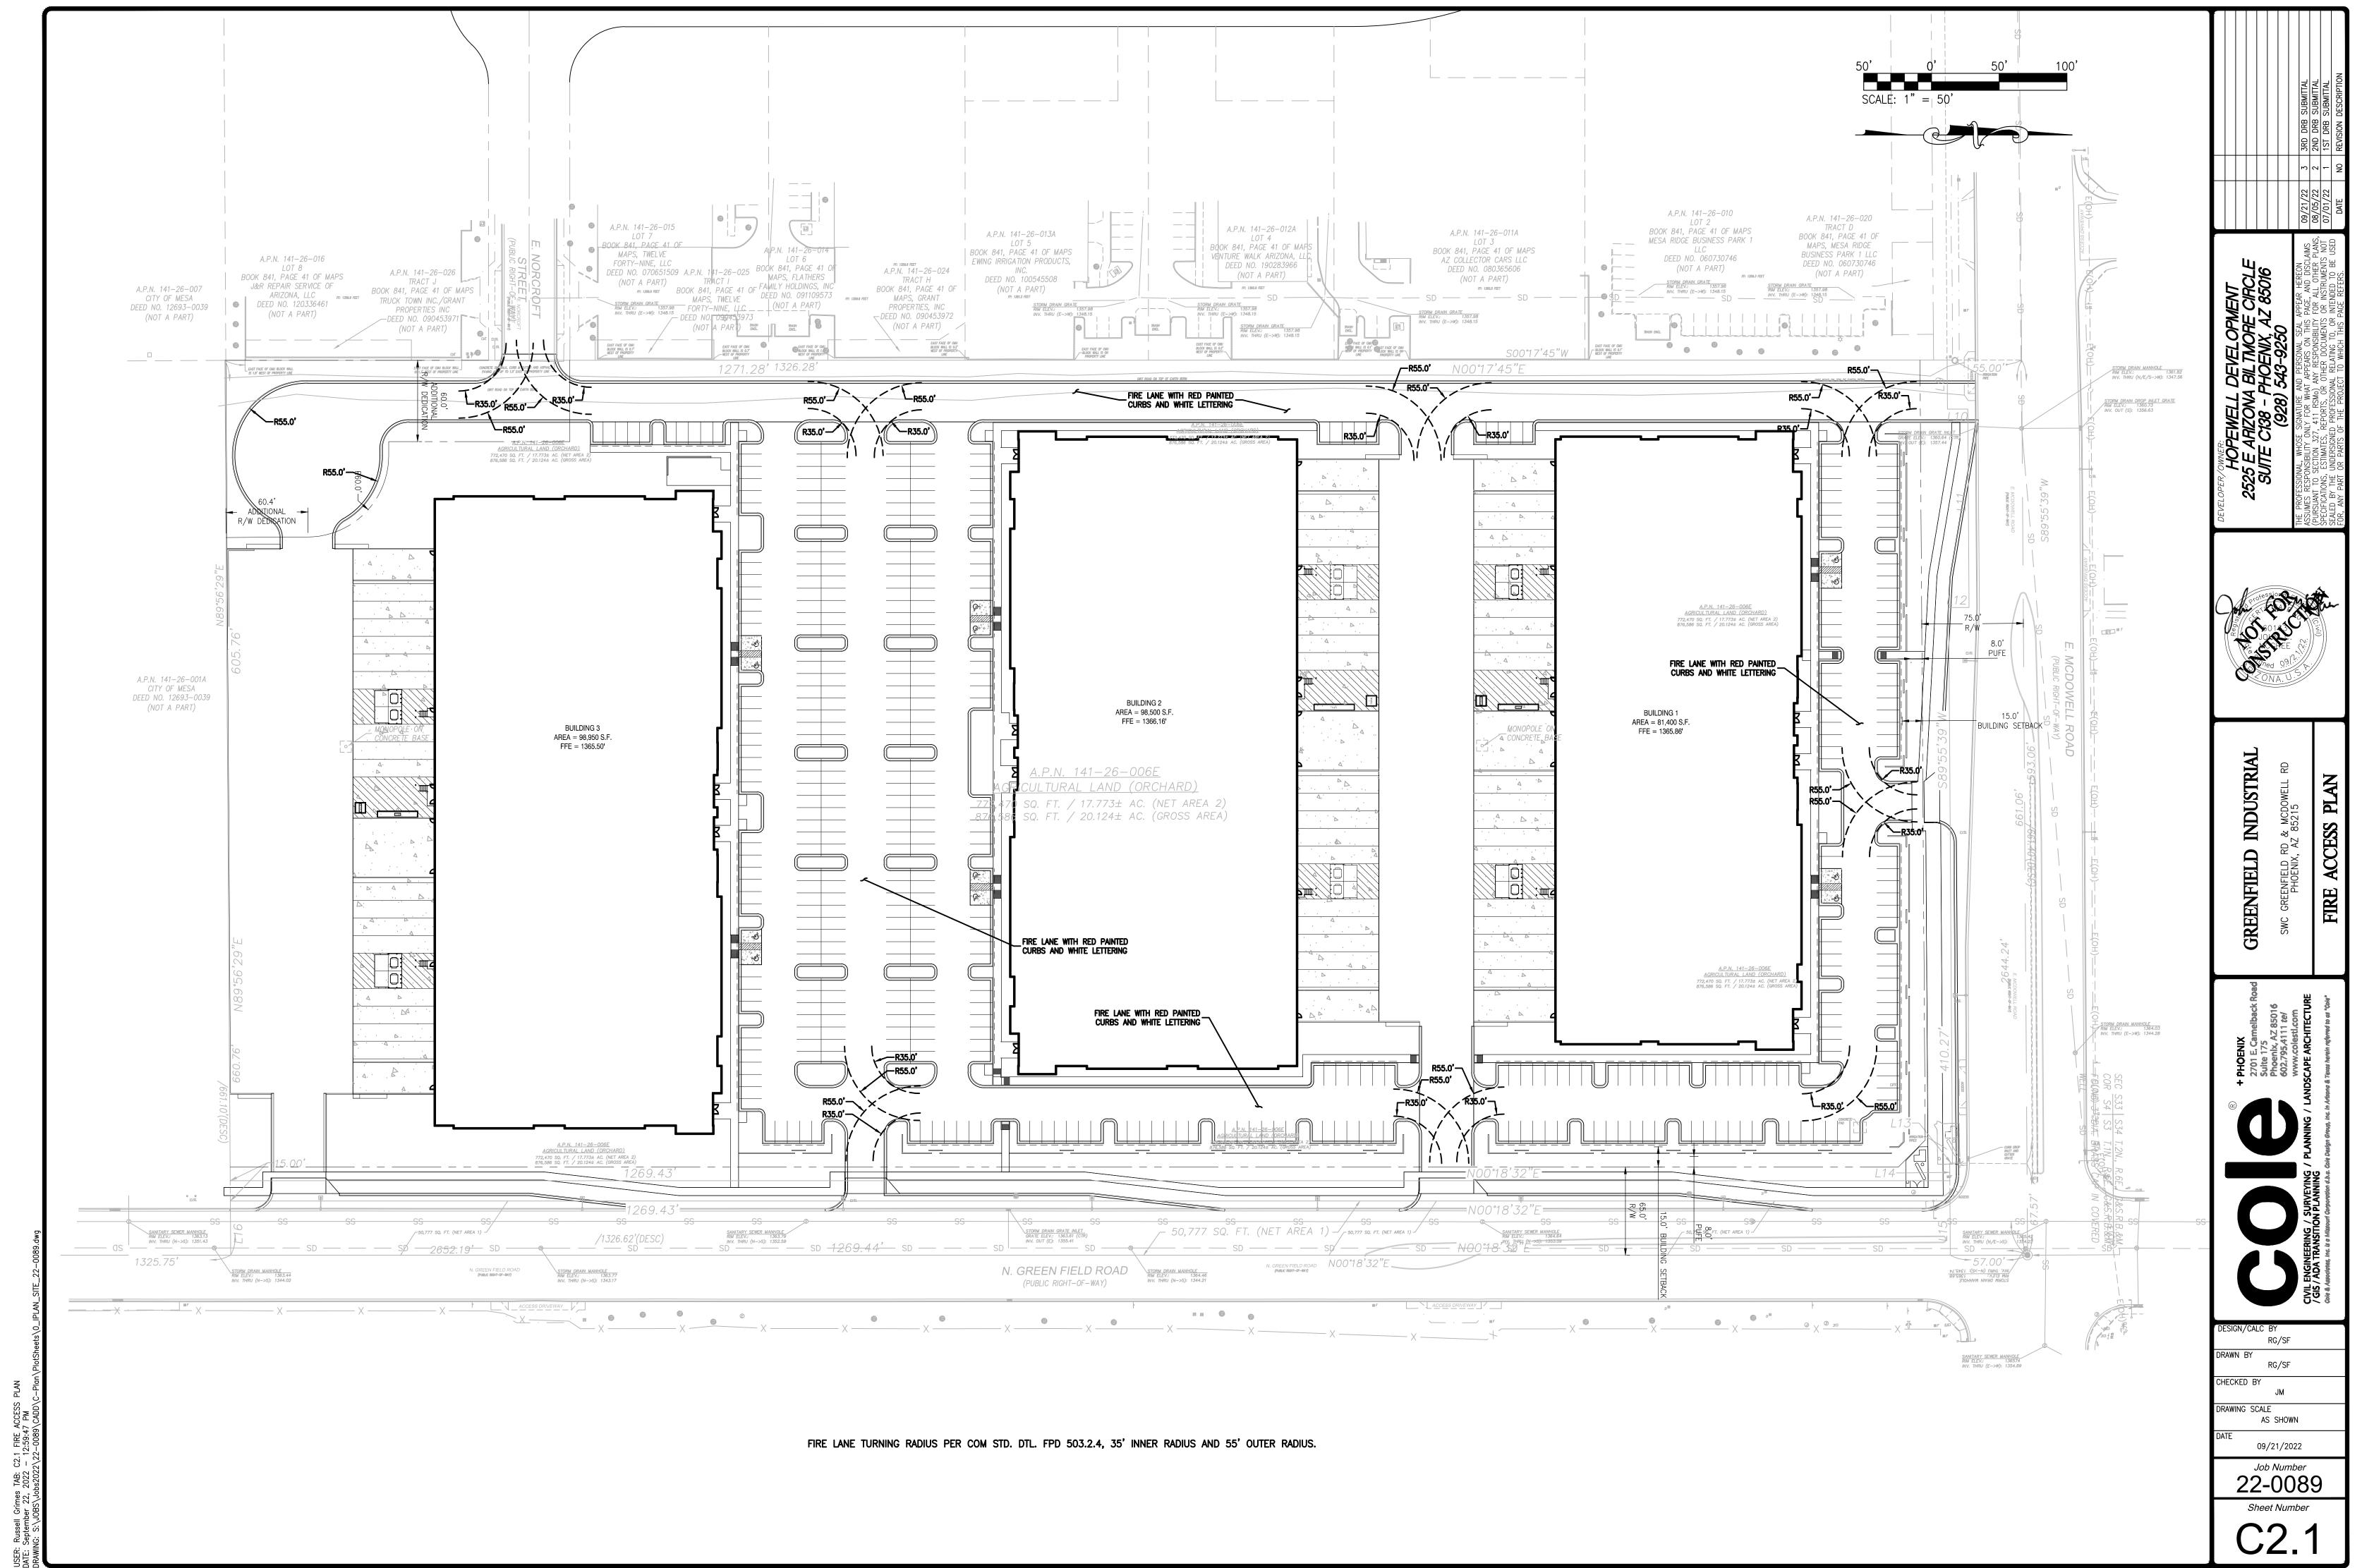

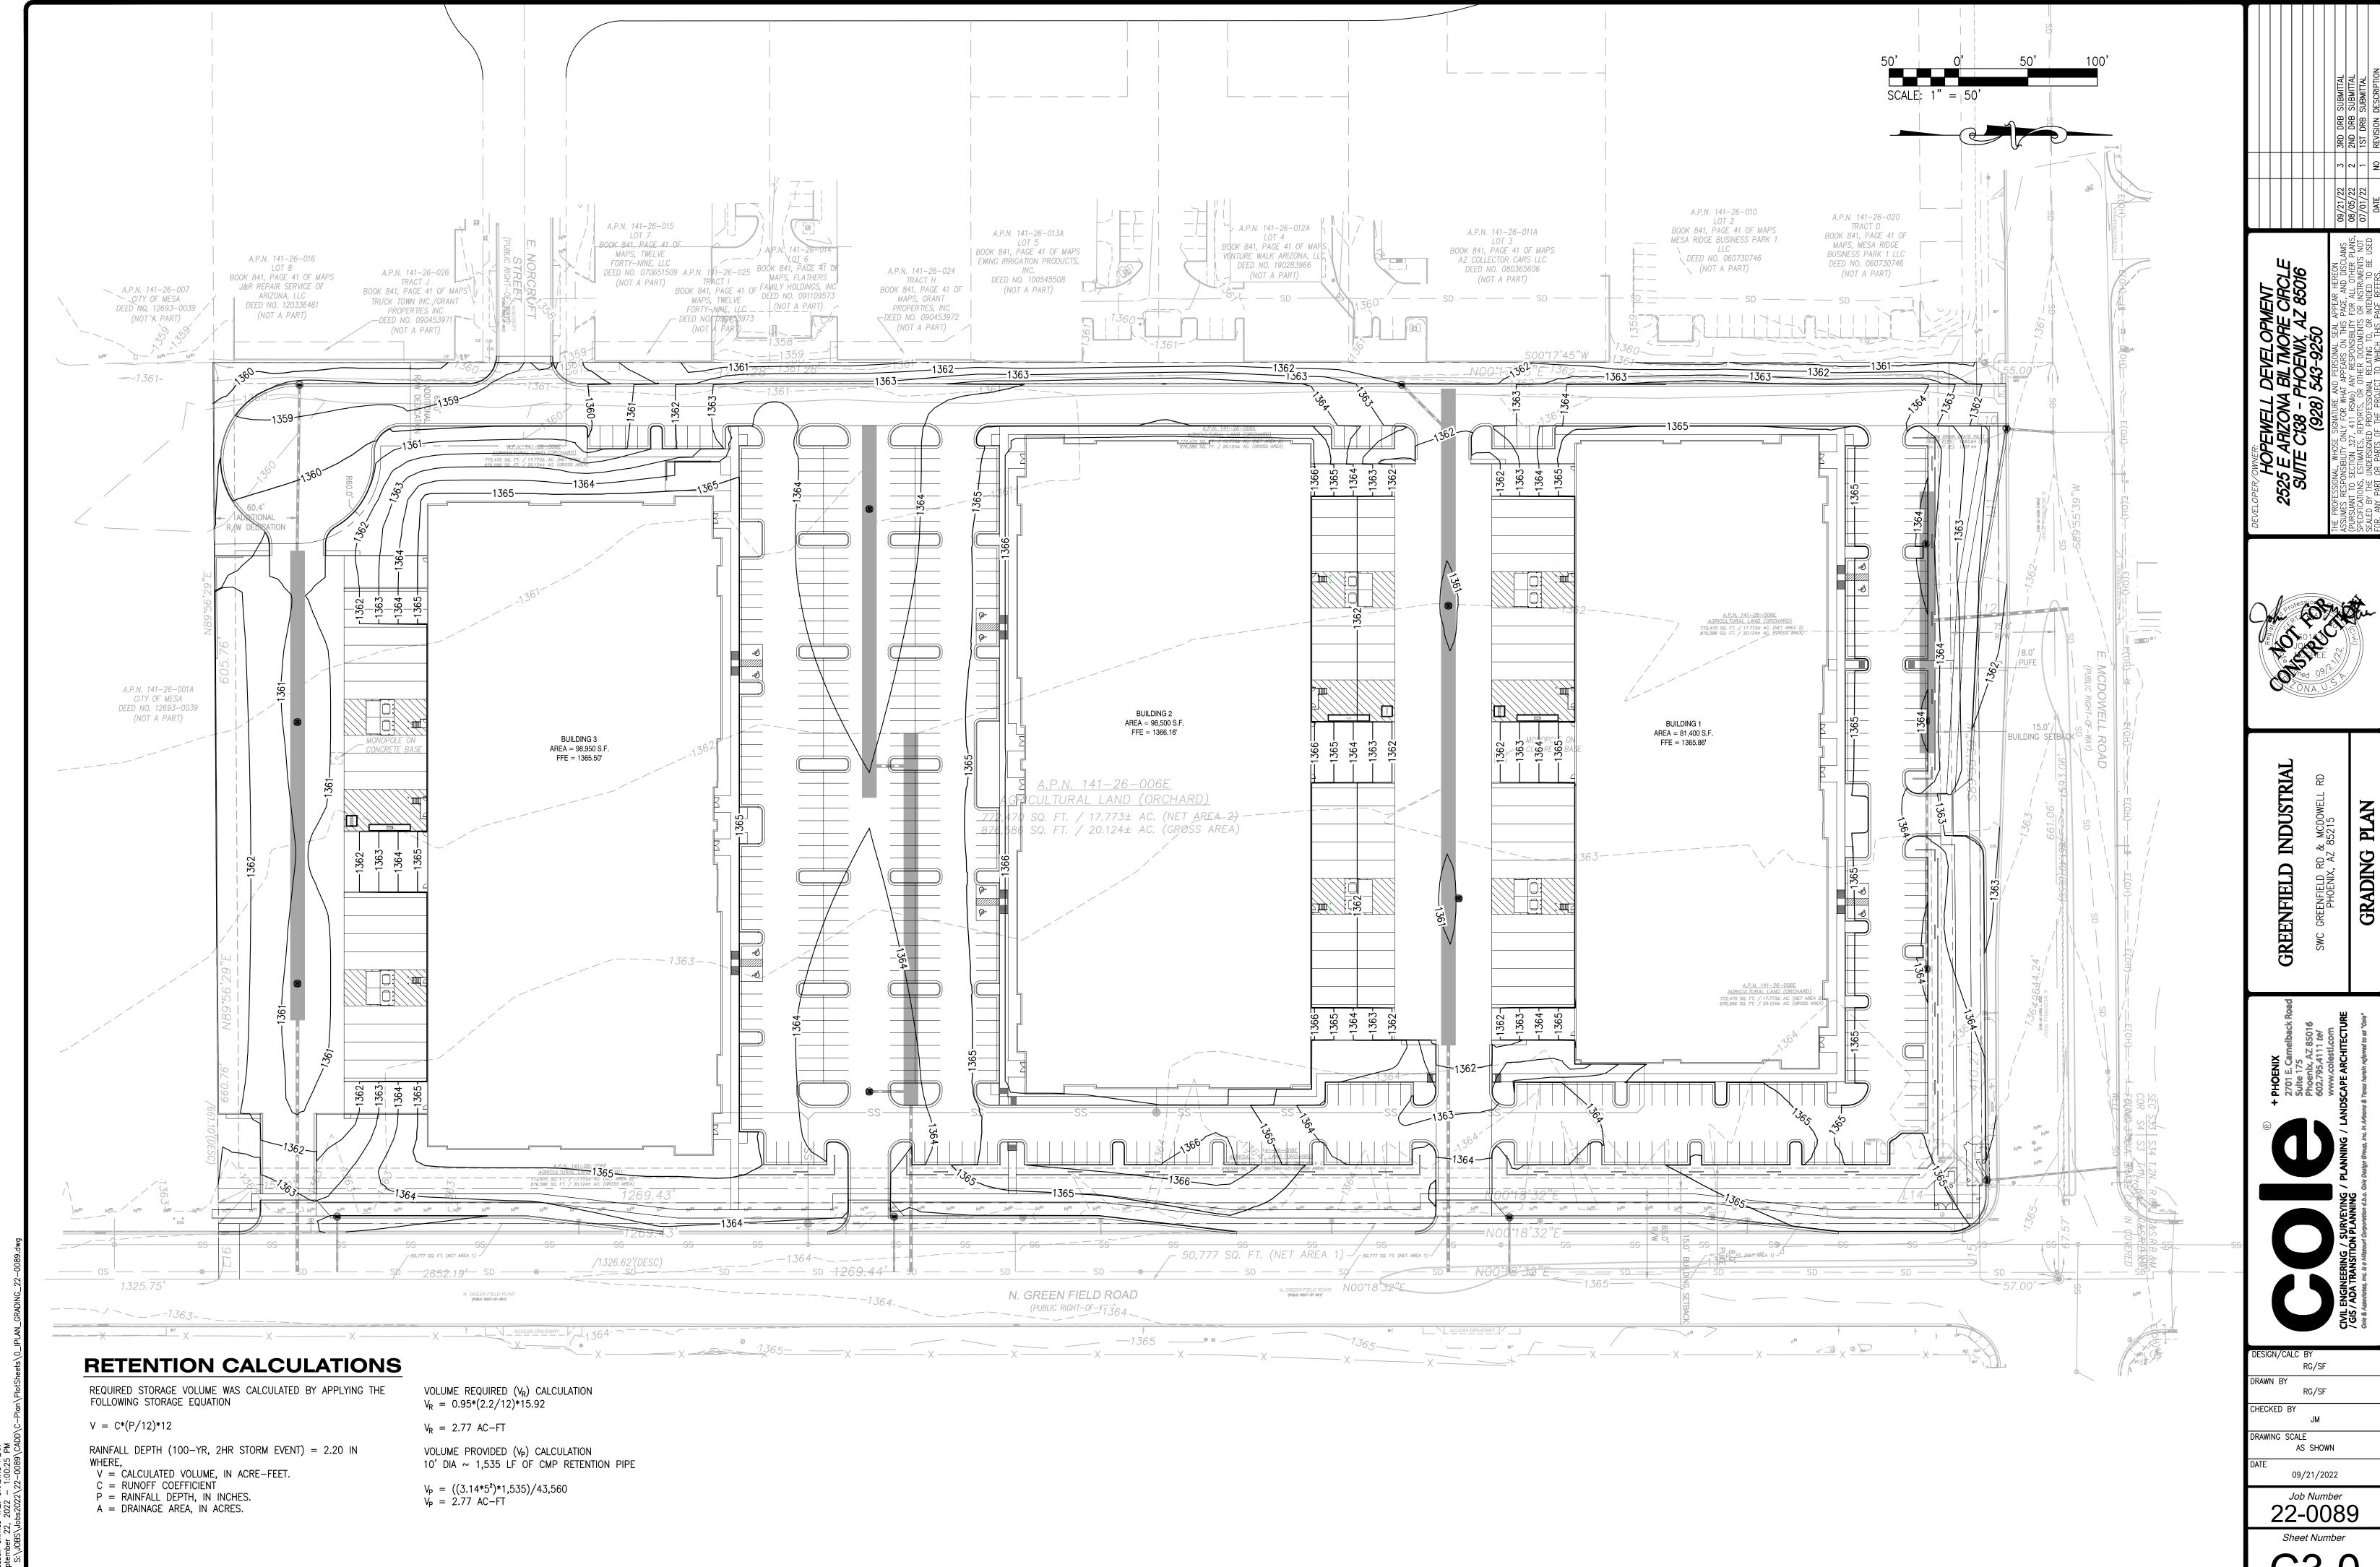

isell Grimes TAB: GRADING PLAN

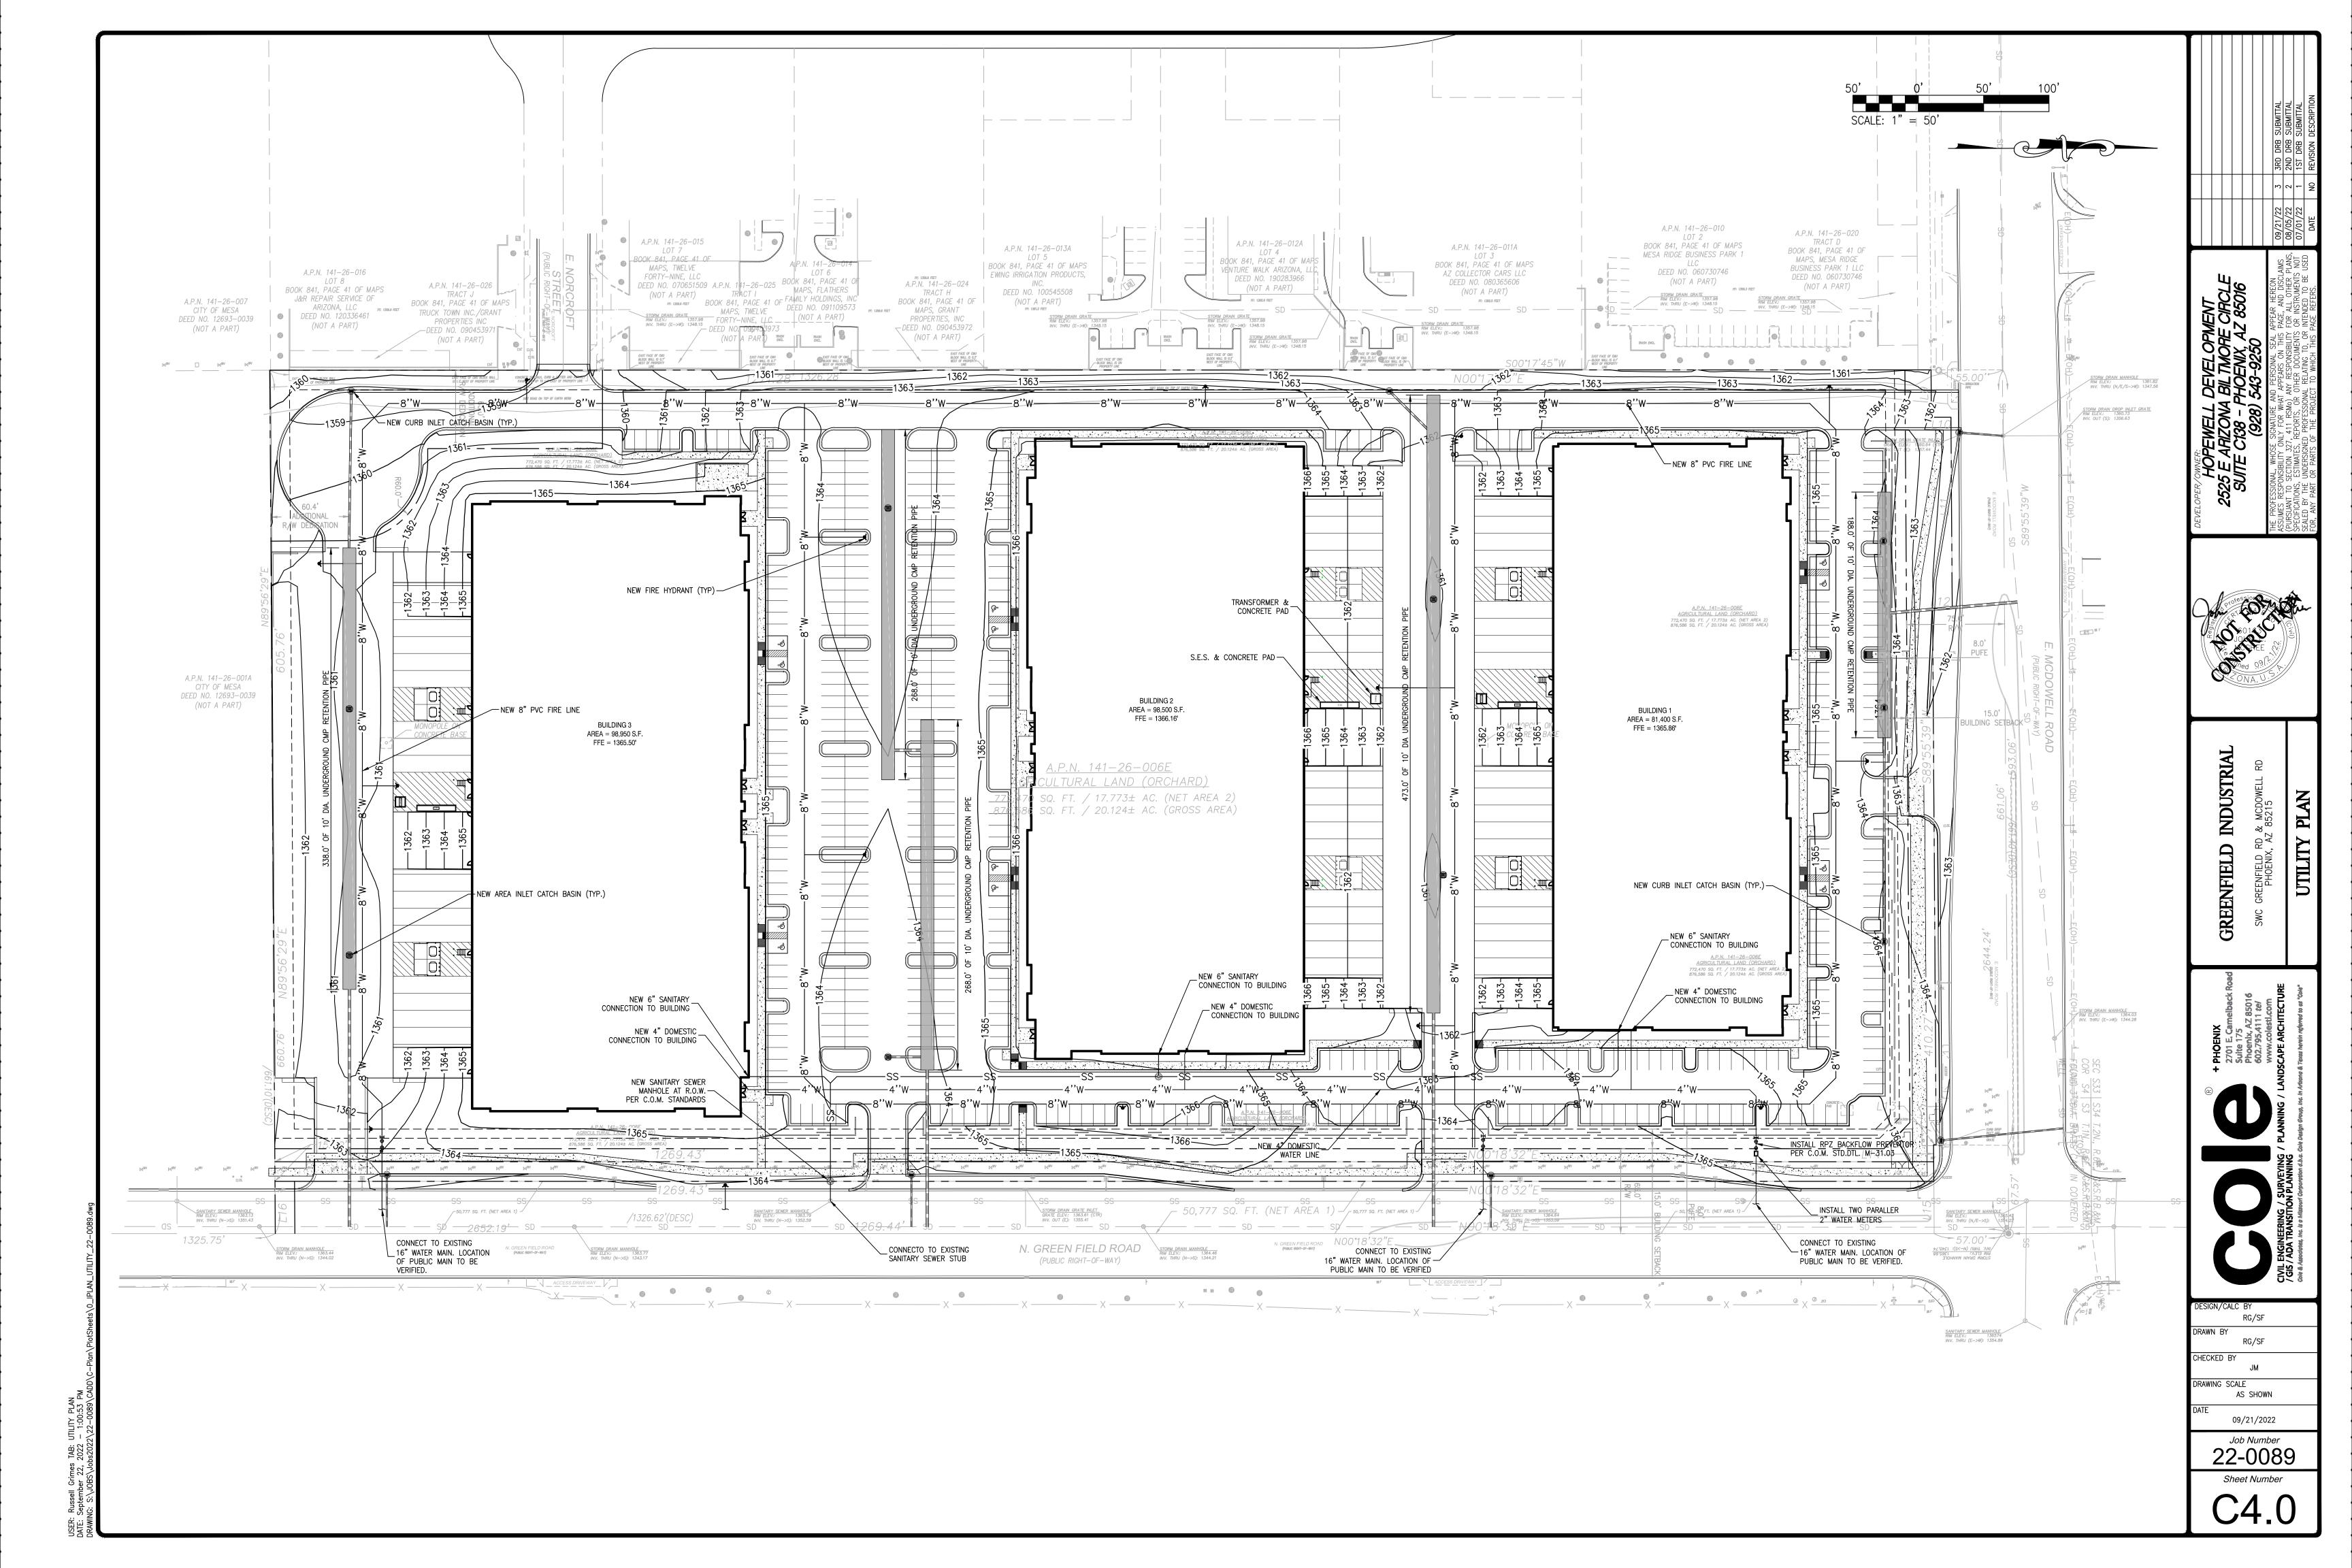

# BUILDING 1 - EXTERIOR ELEVATIONS (NORTH)

25 H712 1

<u>43'−0"</u> T.O. PARAPET


→ 32'-0" B.O. ACCENT

27'-0"
WDW HEAD

15'-0"
WDW SILL

14'-0"
T.O. CANOPY

12'-0"
WDW HEAD

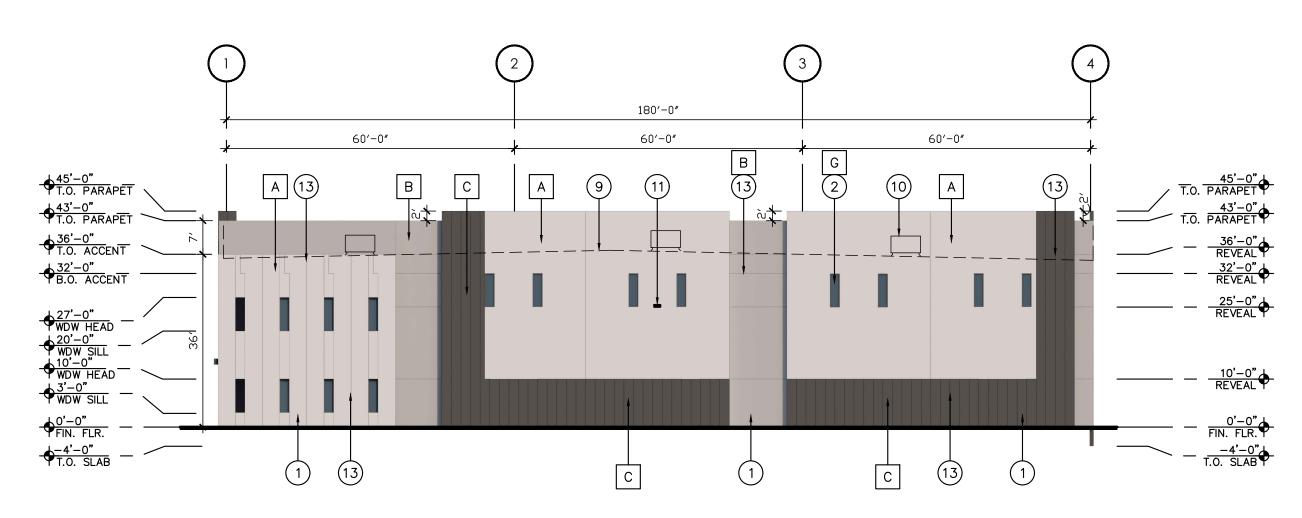


52′-0**″** 

52′-0**″** 

2 10

52′-0**″** 

# BUILDING 1 - EXTERIOR ELEVATIONS (WEST)

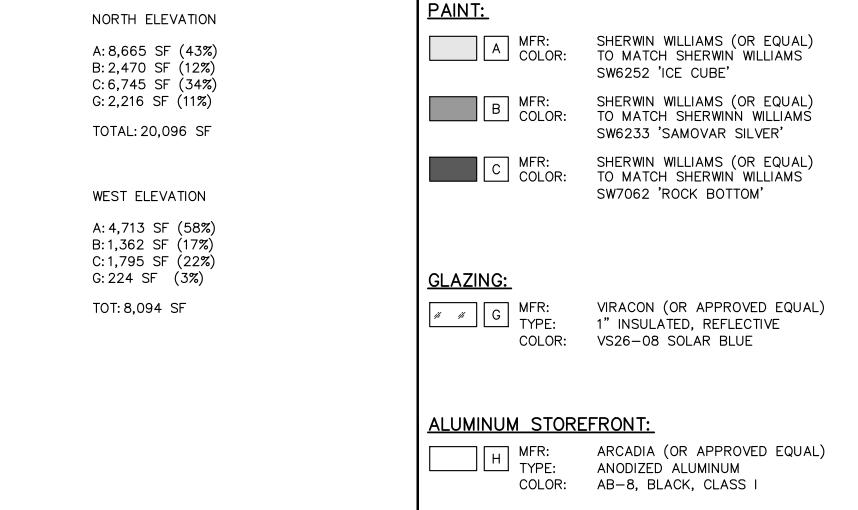

MATERIAL SCHEDULE

MASONRY:

J MFR: SIZE:

K MFR: SIZE:

☐ MFR:

SIZE:

SUPERLITE (OR EQUAL) 8"x8"x16"

SUPERLITE (OR EQUAL)

SUPERLITE (OR EQUAL)

TEXTURE: SMOOTH FACE

COLOR: 'PEARL WHITE'

TEXTURE: SMOOTH FACE

TEXTURE: SPLIT FACE

COLOR: 'OPAL'

8"x8"x16"

COLOR: 'RUTHERFORD GREY'

8"x8"x16"

MATERIAL CALCULATIONS

448'-0"

52′-0**″** 

5 2 G

52′-0**″** 

## **GENERAL NOTES**

17

- A. BUILDING ARCHITECTURE IS EXPECTED TO CONFORM TO THE BUILDING DESIGN COMPONENTS IN THE DESIGN MANUAL FOR COMMERCIAL, INSUTRIAL AND MULTI-FAMILY RESIDENTIAL DEVELOPMENT.
- BUILDINGS SHALL BE SITED AND DESIGNED TO ACHIEVE AN OPTIMUM LEVEL OF ENERGY EFFICIENCY WITH REGARD TO SOLAR ORIENTATION.
- MECHANICAL EQUIPMENT, WHETHER GROUND LEVEL OR ROOF-MOUNTED, SHALL BE SCREENED FROM PUBLIC VIEW AND BE SO LOCATED TO BE PERCEIVED AS AN INTERGRAL PART OF THE BUILDING.
- . EXTERIOR ELECTRICAL WALL EQUIPMENT, INCLUDING BUT NOT LIMITED TO, SERVICE ENTRANCE SECTIONS, ELECTRICAL ACCESS PANELS, AND ELECTRICAL CABINETS, SHALL ME LOCATED IN THE REAR OR SIDE OF THE BUILDING AND BE FULLY ENCLOSED ON IN A RECESSED AREA OF THE BUILDING SO NOT TO PROJECT PAST THE EXTERIOR
- FACADE.
- ALL SIDES OF A BUILDING SHALL RECEIVE CONSISTENT ARCHITECTURAL TREATMENT, ALL BUILDINGS LOCATED WITHIN A UNIFIED, PLANNED DEVELOPMENT, SUCH AS A SHOPPING CENTER OR BUSINESS PARK, SHALL BE ARCHITECTURALLY STYLED TO ACHIEVE HARMONY AND CONTINUITY OF DESIGN. BUILDING ELEVATIONS SHALL BE COORDINATED WITH REGARD TO
- COLOR, TEXTURE, MATERIALS, FINISHES, AND FORM. PEDESTRIAN-OREINTED SITE DESIGN IS REQUIRED. BUILDINGS WITH METAL OR STEEL EXTERIORS SHALL BE ARCHITECTURALLY ALTERED THROUGH THE CONSTRUCTION OF VENEERS, FACADES, OR OTHER ARCHITECTURAL TREATMENTS TO MINIMIZE THE EXTENT OF METAL
- SURFACES VISIBLE. ALL DOWNSPOUTS SHALL BE INTERNALIZED OR ARCHITECTURALLY INTEGRATED INTO THE DESIGN OF A BUILDING.

# **KEYNOTES (ELEVATIONS)**

NOTE: THE BUILDING ELEVATION KEYNOTES LISTED BELOW ARE TYPICAL TO THE BUILDING AND MAY NOT BE APPLICABLE AND/OR REFERENCED ON ALL SHEETS.

- . PAINTED CONCRETE TILT PANEL.
- 2. 1" INSULATED GLAZING. 3. C.M.U. SCREEN WALL.
- 4. HOLLOW METAL DOOR AND FRAME PAINTED.
- 5. AL/GL DOOR TO MATCH WINDOW SYSTEM. 6. OVERHEAD DOOR - PAINTED.
- STEEL CANOPY SEE CANOPY DETAILS SHEET A10.02.
- 8. NOT USED.
- 9. LINE OF ROOF BEYOND.
- 10. LINE OF FUTURE MECHANICAL UNIT BEYOND. 11. LIGHT FIXTURE SEE ELECTRICAL DRAWINGS.
- 12. NOT USED.
- 13. 1/2" RECESS IN PAINTED CONCRETE TILT PANEL. TYP. 14. NOT USED.
- 15. ADDRESS NUMBERS SHALL BE A MINIMUM OF 24" TALL WITH A 4" BRUSH STROKE OF A CONTRASTING COLOR TO THE BACKGROUND COLOR.

DESIGN REVIEW CASE #: DRB22-00730 ZONING CASE #: ZON22-00731 PRE-SUB CASE #: PRS21-01194

(Sheet Title) **BUILDING 1** COLORED **EXTERIOR** 

(Project Number)

30-22167-00

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CD F

9.22.2022

(Revisions)


SITE PLAN

DESIGN REVIEW

**ELEVATIONS** 

# BUILDING 1 - EXTERIOR ELEVATIONS (SOUTH)

<u>+43'−0"</u> T.O. PARAPET >

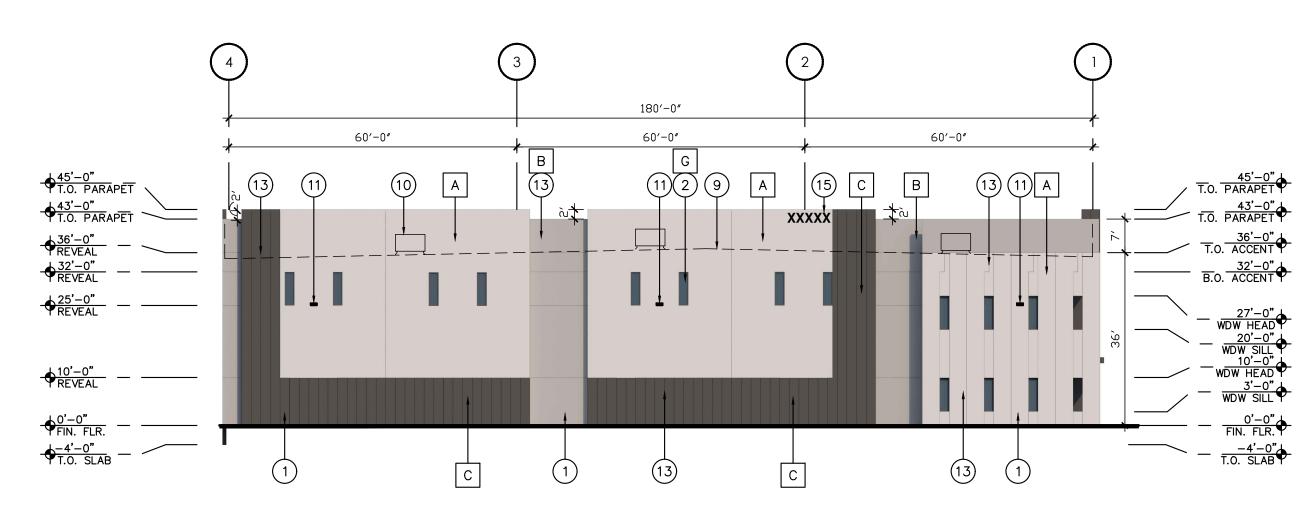

52′-0**″** 

52′-0**″** 

# BUILDING 1 - EXTERIOR ELEVATIONS (EAST)

## A MFR: COLOR: SHERWIN WILLIAMS (OR EQUAL) A: 9,424 SF (44%) TO MATCH SHERWIN WILLIAMS B: 3,720 SF (17%) SW6252 'ICE CUBE' C: 8,198 SF (38%) G: 0 SF B MFR: COLOR: SHERWIN WILLIAMS (OR EQUAL) TO MATCH SHERWINN WILLIAMS TOT: 21,342 SF SW6233 'SAMOVAR SILVER' C MFR: COLOR: SHERWIN WILLIAMS (OR EQUAL) TO MATCH SHERWIN WILLIAMS SW7062 'ROCK BOTTOM' EAST ELEVATION A: 4,713 SF (58%) B:1,362 SF (17%) C:1,795 SF (22%) G: 224 SF (3%) **GLAZING:** TOT: 8,094 SF VIRACON (OR APPROVED EQUAL) G MFK: TYPE: 1" INSULATED, REFLECTIVE COLOR: VS26-08 SOLAR BLUE **ALUMINUM STOREFRONT:** ARCADIA (OR APPROVED EQUAL) TYPE: ANODIZED ALUMINUM COLOR: AB-8, BLACK, CLASS I

PAINT:

MATERIAL SCHEDULE

MATERIAL CALCULATIONS

SOUTH ELEVATION

448'-0"

52′-0**″** 

52′-0**″** 

# **GENERAL NOTES**

SUPERLITE (OR EQUAL) 8"x8"x16"

SUPERLITE (OR EQUAL)

SUPERLITE (OR EQUAL)

TEXTURE: SMOOTH FACE

TEXTURE: SMOOTH FACE

TEXTURE: SPLIT FACE

COLOR: 'OPAL'

COLOR:

☐ MFR:

SIZE:

'PEARL WHITE'

8"x8"x16"

COLOR: 'RUTHERFORD GREY'

8"x8"x16"

MASONRY:

J MFR: SIZE:

K MFR: SIZE:

52′-0**″** 

A. BUILDING ARCHITECTURE IS EXPECTED TO CONFORM TO THE BUILDING DESIGN COMPONENTS IN THE DESIGN MANUAL FOR COMMERCIAL, INSUTRIAL AND MULTI-FAMILY RESIDENTIAL DEVELOPMENT.

BUILDINGS SHALL BE SITED AND DESIGNED TO ACHIEVE AN OPTIMUM LEVEL OF ENERGY EFFICIENCY WITH REGARD TO SOLAR ORIENTATION.

MECHANICAL EQUIPMENT, WHETHER GROUND LEVEL OR ROOF-MOUNTED, SHALL BE SCREENED FROM PUBLIC VIEW AND BE SO LOCATED TO BE PERCEIVED AS AN INTERGRAL PART OF THE BUILDING.

. EXTERIOR ELECTRICAL WALL EQUIPMENT, INCLUDING BUT NOT LIMITED TO, SERVICE ENTRANCE SECTIONS, ELECTRICAL ACCESS PANELS, AND ELECTRICAL CABINETS, SHALL ME LOCATED IN THE REAR OR SIDE OF THE BUILDING AND BE FULLY ENCLOSED ON IN A RECESSED AREA OF THE BUILDING SO NOT TO PROJECT PAST THE EXTERIOR

FACADE. ALL SIDES OF A BUILDING SHALL RECEIVE CONSISTENT

ARCHITECTURAL TREATMENT, ALL BUILDINGS LOCATED WITHIN A UNIFIED, PLANNED DEVELOPMENT, SUCH AS A SHOPPING CENTER OR BUSINESS PARK, SHALL BE ARCHITECTURALLY STYLED TO ACHIEVE HARMONY AND CONTINUITY OF DESIGN. BUILDING ELEVATIONS SHALL BE COORDINATED WITH REGARD TO

COLOR, TEXTURE, MATERIALS, FINISHES, AND FORM. PEDESTRIAN-OREINTED SITE DESIGN IS REQUIRED. BUILDINGS WITH METAL OR STEEL EXTERIORS SHALL BE ARCHITECTURALLY ALTERED THROUGH THE CONSTRUCTION OF VENEERS, FACADES, OR OTHER ARCHITECTURAL TREATMENTS TO MINIMIZE THE EXTENT OF METAL

SURFACES VISIBLE. ALL DOWNSPOUTS SHALL BE INTERNALIZED OR ARCHITECTURALLY INTEGRATED INTO THE DESIGN OF A BUILDING.

**KEYNOTES (ELEVATIONS)** 

NOTE: THE BUILDING ELEVATION KEYNOTES LISTED BELOW ARE TYPICAL TO THE BUILDING AND MAY NOT BE APPLICABLE AND/OR REFERENCED ON ALL SHEETS.

. PAINTED CONCRETE TILT PANEL. 2. 1" INSULATED GLAZING.

3. C.M.U. SCREEN WALL. 4. HOLLOW METAL DOOR AND FRAME - PAINTED.

5. AL/GL DOOR TO MATCH WINDOW SYSTEM.

6. OVERHEAD DOOR — PAINTED. STEEL CANOPY - SEE CANOPY DETAILS SHEET A10.02.

8. NOT USED. 9. LINE OF ROOF BEYOND.

10. LINE OF FUTURE MECHANICAL UNIT BEYOND. 11. LIGHT FIXTURE — SEE ELECTRICAL DRAWINGS. 12. NOT USED. 13. 1/2" RECESS IN PAINTED CONCRETE TILT PANEL. - TYP.

14. NOT USED. 15. ADDRESS NUMBERS SHALL BE A MINIMUM OF 24" TALL

WITH A 4" BRUSH STROKE OF A CONTRASTING COLOR TO THE BACKGROUND COLOR.

**BUILDING 1** COLORED **EXTERIOR ELEVATIONS** 

(Project Number)

30-22167-00

(Sheet Title)

DESIGN REVIEW CASE #: DRB22-00730 ZONING CASE #: ZON22-00731 PRE-SUB CASE #: PRS21-01194

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SITE PLAN


9.22.2022

(Revisions)

**DESIGN REVIEW** 

## 466'-0" 52′-0**″** 52′-0**″** 52′-0**″** 52′-0″ 52′-0**″** <del>↓45'-0"</del> T.O. PARAPET B C A 10 XXXXX → 32'-0" B.O. ACCENT 15'-0" WDW SILL 14'-0" T.O. CANOPY 12'-0" WDW HEAD 2 5 H 2 G 75 25 H712

# BUILDING 2 - EXTERIOR ELEVATIONS (SOUTH)

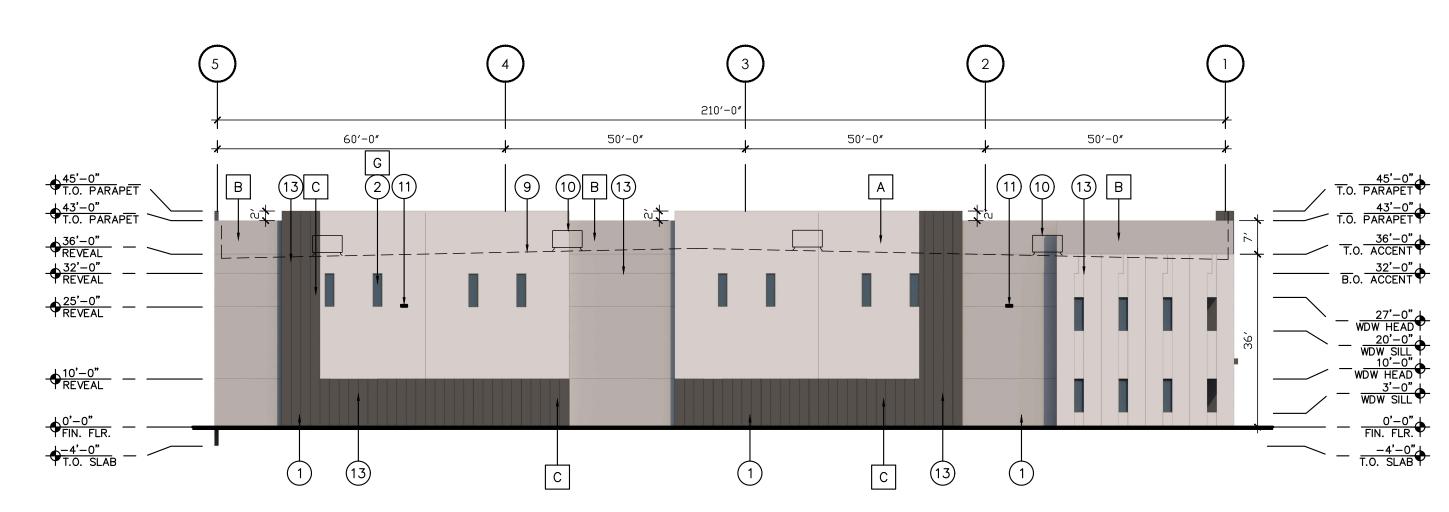

# BUILDING 2 - EXTERIOR ELEVATIONS (WEST)

## MATERIAL CALCULATIONS MATERIAL SCHEDULE PAINT: SOUTH ELEVATION A MFR: COLOR: SHERWIN WILLIAMS (OR EQUAL) A: 8,665 SF (42%) TO MATCH SHERWIN WILLIAMS B: 3,244 SF (16%) SW6252 'ICE CUBE' C: 6,745 SF (32%) B MFR: COLOR: G: 2,216 SF (11%) SHERWIN WILLIAMS (OR EQUAL) TO MATCH SHERWINN WILLIAMS TOT: 20,870 SF SW6233 'SAMOVAR SILVER' C MFR: COLOR: SHERWIN WILLIAMS (OR EQUAL) TO MATCH SHERWIN WILLIAMS SW7062 'ROCK BOTTOM' WEST ELEVATION A: 4,713 SF (50%) B: 2,652 SF (28%) C:1,795 SF (19%) G: 224 SF (2%) **GLAZING:** TOT: 9,384 SF VIRACON (OR APPROVED EQUAL) G MFK: TYPE: 1" INSULATED, REFLECTIVE COLOR: VS26-08 SOLAR BLUE

**ALUMINUM STOREFRONT:** 

TYPE:

ARCADIA (OR APPROVED EQUAL)

ANODIZED ALUMINUM

COLOR: AB-8, BLACK, CLASS I

# **GENERAL NOTES**

SUPERLITE (OR EQUAL) 8"x8"x16"

SUPERLITE (OR EQUAL)

SUPERLITE (OR EQUAL)

TEXTURE: SMOOTH FACE

TEXTURE: SMOOTH FACE

TEXTURE: SPLIT FACE

COLOR: 'OPAL'

COLOR:

☐ MFR:

SIZE:

'PEARL WHITE'

8"x8"x16"

COLOR: 'RUTHERFORD GREY'

8"x8"x16"

MASONRY:

J MFR: SIZE:

K MFR: SIZE:

- A. BUILDING ARCHITECTURE IS EXPECTED TO CONFORM TO THE BUILDING DESIGN COMPONENTS IN THE DESIGN MANUAL FOR COMMERCIAL, INSUTRIAL AND MULTI-FAMILY
- RESIDENTIAL DEVELOPMENT. BUILDINGS SHALL BE SITED AND DESIGNED TO ACHIEVE AN OPTIMUM LEVEL OF ENERGY EFFICIENCY WITH REGARD TO SOLAR ORIENTATION.
- MECHANICAL EQUIPMENT, WHETHER GROUND LEVEL OR ROOF-MOUNTED, SHALL BE SCREENED FROM PUBLIC VIEW AND BE SO LOCATED TO BE PERCEIVED AS AN INTERGRAL PART OF THE BUILDING.
- . EXTERIOR ELECTRICAL WALL EQUIPMENT, INCLUDING BUT NOT LIMITED TO, SERVICE ENTRANCE SECTIONS, ELECTRICAL ACCESS PANELS, AND ELECTRICAL CABINETS, SHALL ME LOCATED IN THE REAR OR SIDE OF THE BUILDING AND BE FULLY ENCLOSED ON IN A RECESSED AREA OF THE BUILDING SO NOT TO PROJECT PAST THE EXTERIOR
- FACADE. ALL SIDES OF A BUILDING SHALL RECEIVE CONSISTENT
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- PEDESTRIAN-OREINTED SITE DESIGN IS REQUIRED. BUILDINGS WITH METAL OR STEEL EXTERIORS SHALL BE ARCHITECTURALLY ALTERED THROUGH THE CONSTRUCTION OF VENEERS, FACADES, OR OTHER ARCHITECTURAL TREATMENTS TO MINIMIZE THE EXTENT OF METAL SURFACES VISIBLE.
- ALL DOWNSPOUTS SHALL BE INTERNALIZED OR ARCHITECTURALLY INTEGRATED INTO THE DESIGN OF A BUILDING.

# **KEYNOTES (ELEVATIONS)**

NOTE: THE BUILDING ELEVATION KEYNOTES LISTED BELOW ARE TYPICAL TO THE BUILDING AND MAY NOT BE APPLICABLE AND/OR REFERENCED ON ALL SHEETS.

- . PAINTED CONCRETE TILT PANEL.
- 2. 1" INSULATED GLAZING. 3. C.M.U. SCREEN WALL.
- 4. HOLLOW METAL DOOR AND FRAME PAINTED.
- 5. AL/GL DOOR TO MATCH WINDOW SYSTEM. 6. OVERHEAD DOOR - PAINTED.
- STEEL CANOPY SEE CANOPY DETAILS SHEET A10.02.
- 8. NOT USED.
- 9. LINE OF ROOF BEYOND. 10. LINE OF FUTURE MECHANICAL UNIT BEYOND. 11. LIGHT FIXTURE — SEE ELECTRICAL DRAWINGS.
- 12. NOT USED.
- 13. 1/2" RECESS IN PAINTED CONCRETE TILT PANEL. TYP. 14. NOT USED. 15. ADDRESS NUMBERS SHALL BE A MINIMUM OF 24" TALL
- WITH A 4" BRUSH STROKE OF A CONTRASTING COLOR TO THE BACKGROUND COLOR.

DESIGN REVIEW CASE #: DRB22-00730 ZONING CASE #: ZON22-00731

PRE-SUB CASE #: PRS21-01194

(Project Number) 30-22167-00 (Sheet Title) **BUILDING 2** COLORED

**EXTERIOR** 

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9.22.2022

(Revisions)

SITE PLAN

DESIGN REVIEW

**ELEVATIONS** 

## 52′-0″ 52′-0″ 52′-0**″** 52′-0″ 52′-0**″** 52′-0**″** +45'-0" T.O. PARAPET A (9) <u> 43'−0"</u> T.O. PARAPET 36'-0" REVEAL 32'-0" REVEAL →25'-0" — — 10'-0" — — ◆0'-0" FIN. FLR. 13 C C 13 6

466'-0"

# BUILDING 2 - EXTERIOR ELEVATIONS (NORTH)

50′-0″ 60'-0"  $\sqrt{\frac{45'-0"}{\text{T.O.}}}$ (10) (2) $-\frac{43'-0"}{\text{T.O. PARAPET}}$ XXXXX → 36'-0" T.O. ACCENT 36'−0" REVEAL → 32'-0" B.O. ACCENT 32'−0" REVEAL 25'−0" REVEAL **→ 20'-0"** WDW SILL 10'−0" REVEAL  $\frac{3'-0"}{\text{WDW SILL}}$ <del>-4'-0"</del> − T.O. SLAB

# **BUILDING 2 - EXTERIOR ELEVATIONS (EAST)**

## MATERIAL CALCULATIONS MATERIAL SCHEDULE PAINT: NORTH ELEVATION A MFR: COLOR: SHERWIN WILLIAMS (OR EQUAL) A: 9,424 SF (43%) TO MATCH SHERWIN WILLIAMS B: 4,494 SF (20%) SW6252 'ICE CUBE' C: 8,212 SF (37%) G: 0 SF B MFR: COLOR: SHERWIN WILLIAMS (OR EQUAL) TO MATCH SHERWINN WILLIAMS TOT: 22,130 SF SW6233 'SAMOVAR SILVER' C MFR: COLOR: SHERWIN WILLIAMS (OR EQUAL) TO MATCH SHERWIN WILLIAMS SW7062 'ROCK BOTTOM' EAST ELEVATION A: 4,713 SF (50%) B: 2,652 SF (28%) C:1,795 SF (19%) G: 224 SF (2%) **GLAZING:** TOT: 9,384 SF VIRACON (OR APPROVED EQUAL) G MFK: TYPE: 1" INSULATED, REFLECTIVE COLOR: VS26-08 SOLAR BLUE

**ALUMINUM STOREFRONT:** 

H MFR:

ARCADIA (OR APPROVED EQUAL)

ANODIZED ALUMINUM

COLOR: AB-8, BLACK, CLASS I

## MASONRY:

SUPERLITE (OR EQUAL) 8"x8"x16" J MFR: SIZE: TEXTURE: SMOOTH FACE 'PEARL WHITE' COLOR:

K MFR: SIZE: SUPERLITE (OR EQUAL) 8"x8"x16" TEXTURE: SMOOTH FACE COLOR: 'RUTHERFORD GREY'

☐ MFR: SIZE:

SUPERLITE (OR EQUAL) 8"x8"x16" TEXTURE: SPLIT FACE COLOR: 'OPAL'

# **GENERAL NOTES**

- A. BUILDING ARCHITECTURE IS EXPECTED TO CONFORM TO THE BUILDING DESIGN COMPONENTS IN THE DESIGN MANUAL FOR COMMERCIAL, INSUTRIAL AND MULTI-FAMILY
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# **KEYNOTES (ELEVATIONS)**

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- 4. HOLLOW METAL DOOR AND FRAME PAINTED.
- 5. AL/GL DOOR TO MATCH WINDOW SYSTEM. 6. OVERHEAD DOOR — PAINTED.
- STEEL CANOPY SEE CANOPY DETAILS SHEET A10.02.
- 8. NOT USED. 9. LINE OF ROOF BEYOND.
- 10. LINE OF FUTURE MECHANICAL UNIT BEYOND. 11. LIGHT FIXTURE SEE ELECTRICAL DRAWINGS.
- 12. NOT USED. 13. 1/2" RECESS IN PAINTED CONCRETE TILT PANEL. - TYP.
- 14. NOT USED. 15. ADDRESS NUMBERS SHALL BE A MINIMUM OF 24" TALL WITH A 4" BRUSH STROKE OF A CONTRASTING COLOR TO

THE BACKGROUND COLOR.

30-22167-00 (Sheet Title) **BUILDING 2** 

(Project Number)

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9.22.2022

(Revisions)

SITE PLAN


**DESIGN REVIEW** 

COLORED **EXTERIOR ELEVATIONS** 

DESIGN REVIEW CASE #: DRB22-00730 ZONING CASE #: ZON22-00731 PRE-SUB CASE #: PRS21-01194

# 466′-0″ 52′-0″ 52'-0" 52′-0″ 51′-0″ 52′-0″ 52′-0″ <del>-</del><del>\$45'−0"</del> T.O. PARAPĒT xxxxx 7 5 25 H 712

# BUILDING 3 - EXTERIOR ELEVATIONS (NORTH)

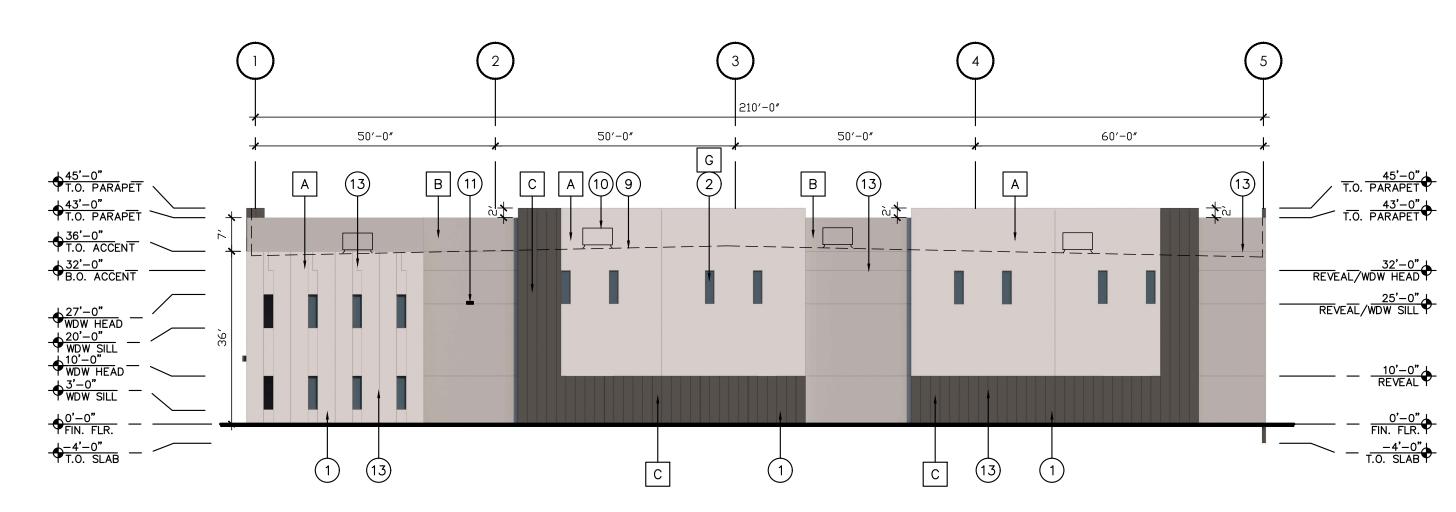

# **BUILDING 3 - EXTERIOR ELEVATIONS (WEST)**

## PAINT: NORTH ELEVATION A MFR: COLOR: SHERWIN WILLIAMS (OR EQUAL) A: 8,665 SF (41%) TO MATCH SHERWIN WILLIAMS B: 3,330 SF (16%) SW6252 'ICE CUBE' C: 6,745 SF (32%) B MFR: COLOR: G: 2,216 SF (11%) SHERWIN WILLIAMS (OR EQUAL) TO MATCH SHERWINN WILLIAMS TOT: 20,956 SF SW6233 'SAMOVAR SILVER' C MFR: COLOR: SHERWIN WILLIAMS (OR EQUAL) TO MATCH SHERWIN WILLIAMS SW7062 'ROCK BOTTOM' WEST ELEVATION A: 4,713 SF (50%) B: 2,652 SF (28%) C:1,795 SF (19%) G: 224 SF (2%) **GLAZING:** TOT: 9,384 SF VIRACON (OR APPROVED EQUAL) G MFK: TYPE: 1" INSULATED, REFLECTIVE COLOR: VS26-08 SOLAR BLUE

MATERIAL SCHEDULE

**ALUMINUM STOREFRONT:** 

H MFR:

ARCADIA (OR APPROVED EQUAL)

ANODIZED ALUMINUM

COLOR: AB-8, BLACK, CLASS I

MATERIAL CALCULATIONS

# **GENERAL NOTES**

SUPERLITE (OR EQUAL) 8"x8"x16"

SUPERLITE (OR EQUAL)

SUPERLITE (OR EQUAL)

TEXTURE: SMOOTH FACE

TEXTURE: SMOOTH FACE

TEXTURE: SPLIT FACE

COLOR: 'OPAL'

COLOR:

☐ MFR:

SIZE:

'PEARL WHITE'

8"x8"x16"

COLOR: 'RUTHERFORD GREY'

8"x8"x16"

MASONRY:

J MFR: SIZE:

K MFR: SIZE:

- A. BUILDING ARCHITECTURE IS EXPECTED TO CONFORM TO THE BUILDING DESIGN COMPONENTS IN THE DESIGN MANUAL FOR COMMERCIAL, INSUTRIAL AND MULTI-FAMILY
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- FACADE. ALL SIDES OF A BUILDING SHALL RECEIVE CONSISTENT
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- SURFACES VISIBLE. ALL DOWNSPOUTS SHALL BE INTERNALIZED OR ARCHITECTURALLY INTEGRATED INTO THE DESIGN OF A BUILDING.

## **KEYNOTES (ELEVATIONS)**

NOTE: THE BUILDING ELEVATION KEYNOTES LISTED BELOW ARE TYPICAL TO THE BUILDING AND MAY NOT BE APPLICABLE AND/OR REFERENCED ON ALL SHEETS.

- . PAINTED CONCRETE TILT PANEL. 2. 1" INSULATED GLAZING.
- 3. C.M.U. SCREEN WALL. 4. HOLLOW METAL DOOR AND FRAME - PAINTED.
- 5. AL/GL DOOR TO MATCH WINDOW SYSTEM. 6. OVERHEAD DOOR - PAINTED.
- STEEL CANOPY SEE CANOPY DETAILS SHEET A10.02. 8. NOT USED.
- 9. LINE OF ROOF BEYOND. 10. LINE OF FUTURE MECHANICAL UNIT BEYOND. 11. LIGHT FIXTURE — SEE ELECTRICAL DRAWINGS.
- 12. NOT USED. 13. 1/2" RECESS IN PAINTED CONCRETE TILT PANEL. - TYP. 14. NOT USED.
- 15. ADDRESS NUMBERS SHALL BE A MINIMUM OF 24" TALL WITH A 4" BRUSH STROKE OF A CONTRASTING COLOR TO THE BACKGROUND COLOR.

**BUILDING 3** COLORED **EXTERIOR** 

**ELEVATIONS** 

(Project Number)

30-22167-00

(Sheet Title)

DESIGN REVIEW CASE #: DRB22-00730 ZONING CASE #: ZON22-00731 PRE-SUB CASE #: PRS21-01194 ШЁ CD F SITE PLAN

9.22.2022

(Revisions)

**DESIGN REVIEW** 

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## 52′-0″ 52′-0″ 52′-0**″** 52′-0″ 52′-0″ 52′-0**″** 52′-0**″** 51′-0″ 51′-0″ 11 10 <u> 43'−0"</u> T.O. PARAPET 32'-0" REVEAL/WDW HEAD REVEAL/WDW HEAD →25'-0" REVEAL/WDW SILL REVEAL/WDW SILL +10'-0" — — 1 6 1 6 6 11

# BUILDING 3 - EXTERIOR ELEVATIONS (SOUTH)

**BUILDING 3 - EXTERIOR ELEVATIONS (EAST)** 

50′-0**″** 50'-0" 50′-0**″** PREVEAL/WDW HEAD →25'-0"
REVEAL/WDW SILL

## MATERIAL CALCULATIONS SOUTH A: 10,579 SF (48%) B: 3,917 SF (18%)

C: 7,693 SF (35%) G: 0 SF TOT: 22,189 SF

EAST ELEVATION A: 4,713 SF (50%) B: 2,652 SF (28%) C:1,795 SF (19%) G: 224 SF (2%)

TOT: 9,384 SF

MATERIAL SCHEDULE PAINT: SHERWIN WILLIAMS (OR EQUAL)

A MFR: COLOR: TO MATCH SHERWIN WILLIAMS SW6252 'ICE CUBE' B MFR: COLOR: SHERWIN WILLIAMS (OR EQUAL) TO MATCH SHERWINN WILLIAMS

SW6233 'SAMOVAR SILVER' C MFR: COLOR: SHERWIN WILLIAMS (OR EQUAL) TO MATCH SHERWIN WILLIAMS SW7062 'ROCK BOTTOM'

**GLAZING:** G MFK: TYPE:

VIRACON (OR APPROVED EQUAL) 1" INSULATED, REFLECTIVE COLOR: VS26-08 SOLAR BLUE

**ALUMINUM STOREFRONT:** 

ARCADIA (OR APPROVED EQUAL) TYPE: ANODIZED ALUMINUM COLOR: AB-8, BLACK, CLASS I

## MASONRY:

SUPERLITE (OR EQUAL) 8"x8"x16" J MFR: SIZE: TEXTURE: SMOOTH FACE 'PEARL WHITE' COLOR:

K MFR: SIZE: SUPERLITE (OR EQUAL) 8"x8"x16" TEXTURE: SMOOTH FACE COLOR: 'RUTHERFORD GREY'

SIZE:

SUPERLITE (OR EQUAL) 8"x8"x16" TEXTURE: SPLIT FACE COLOR: 'OPAL'

# **GENERAL NOTES**

A. BUILDING ARCHITECTURE IS EXPECTED TO CONFORM TO THE BUILDING DESIGN COMPONENTS IN THE DESIGN MANUAL FOR COMMERCIAL, INSUTRIAL AND MULTI-FAMILY RESIDENTIAL DEVELOPMENT.

BUILDINGS SHALL BE SITED AND DESIGNED TO ACHIEVE AN OPTIMUM LEVEL OF ENERGY EFFICIENCY WITH REGARD TO SOLAR ORIENTATION.

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FACADE.

ALL SIDES OF A BUILDING SHALL RECEIVE CONSISTENT ARCHITECTURAL TREATMENT, ALL BUILDINGS LOCATED WITHIN A UNIFIED, PLANNED DEVELOPMENT, SUCH AS A SHOPPING CENTER OR BUSINESS PARK, SHALL BE ARCHITECTURALLY STYLED TO ACHIEVE HARMONY AND CONTINUITY OF DESIGN. BUILDING ELEVATIONS SHALL BE COORDINATED WITH REGARD TO

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# **KEYNOTES (ELEVATIONS)**

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. PAINTED CONCRETE TILT PANEL. 2. 1" INSULATED GLAZING.

3. C.M.U. SCREEN WALL. 4. HOLLOW METAL DOOR AND FRAME - PAINTED.

5. AL/GL DOOR TO MATCH WINDOW SYSTEM. 6. OVERHEAD DOOR — PAINTED.

STEEL CANOPY - SEE CANOPY DETAILS SHEET A10.02. 8. NOT USED.

9. LINE OF ROOF BEYOND. 10. LINE OF FUTURE MECHANICAL UNIT BEYOND. 11. LIGHT FIXTURE — SEE ELECTRICAL DRAWINGS.

12. NOT USED. 13. 1/2" RECESS IN PAINTED CONCRETE TILT PANEL. - TYP.

14. NOT USED. 15. ADDRESS NUMBERS SHALL BE A MINIMUM OF 24" TALL

WITH A 4" BRUSH STROKE OF A CONTRASTING COLOR TO THE BACKGROUND COLOR.

(Project Number) 30-22167-00 (Sheet Title)

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9.22.2022


(Revisions)

SITE PLAN

**DESIGN REVIEW** 

**BUILDING 3** COLORED **EXTERIOR ELEVATIONS** 

DESIGN REVIEW CASE #: DRB22-00730 ZONING CASE #: ZON22-00731 PRE-SUB CASE #: PRS21-01194

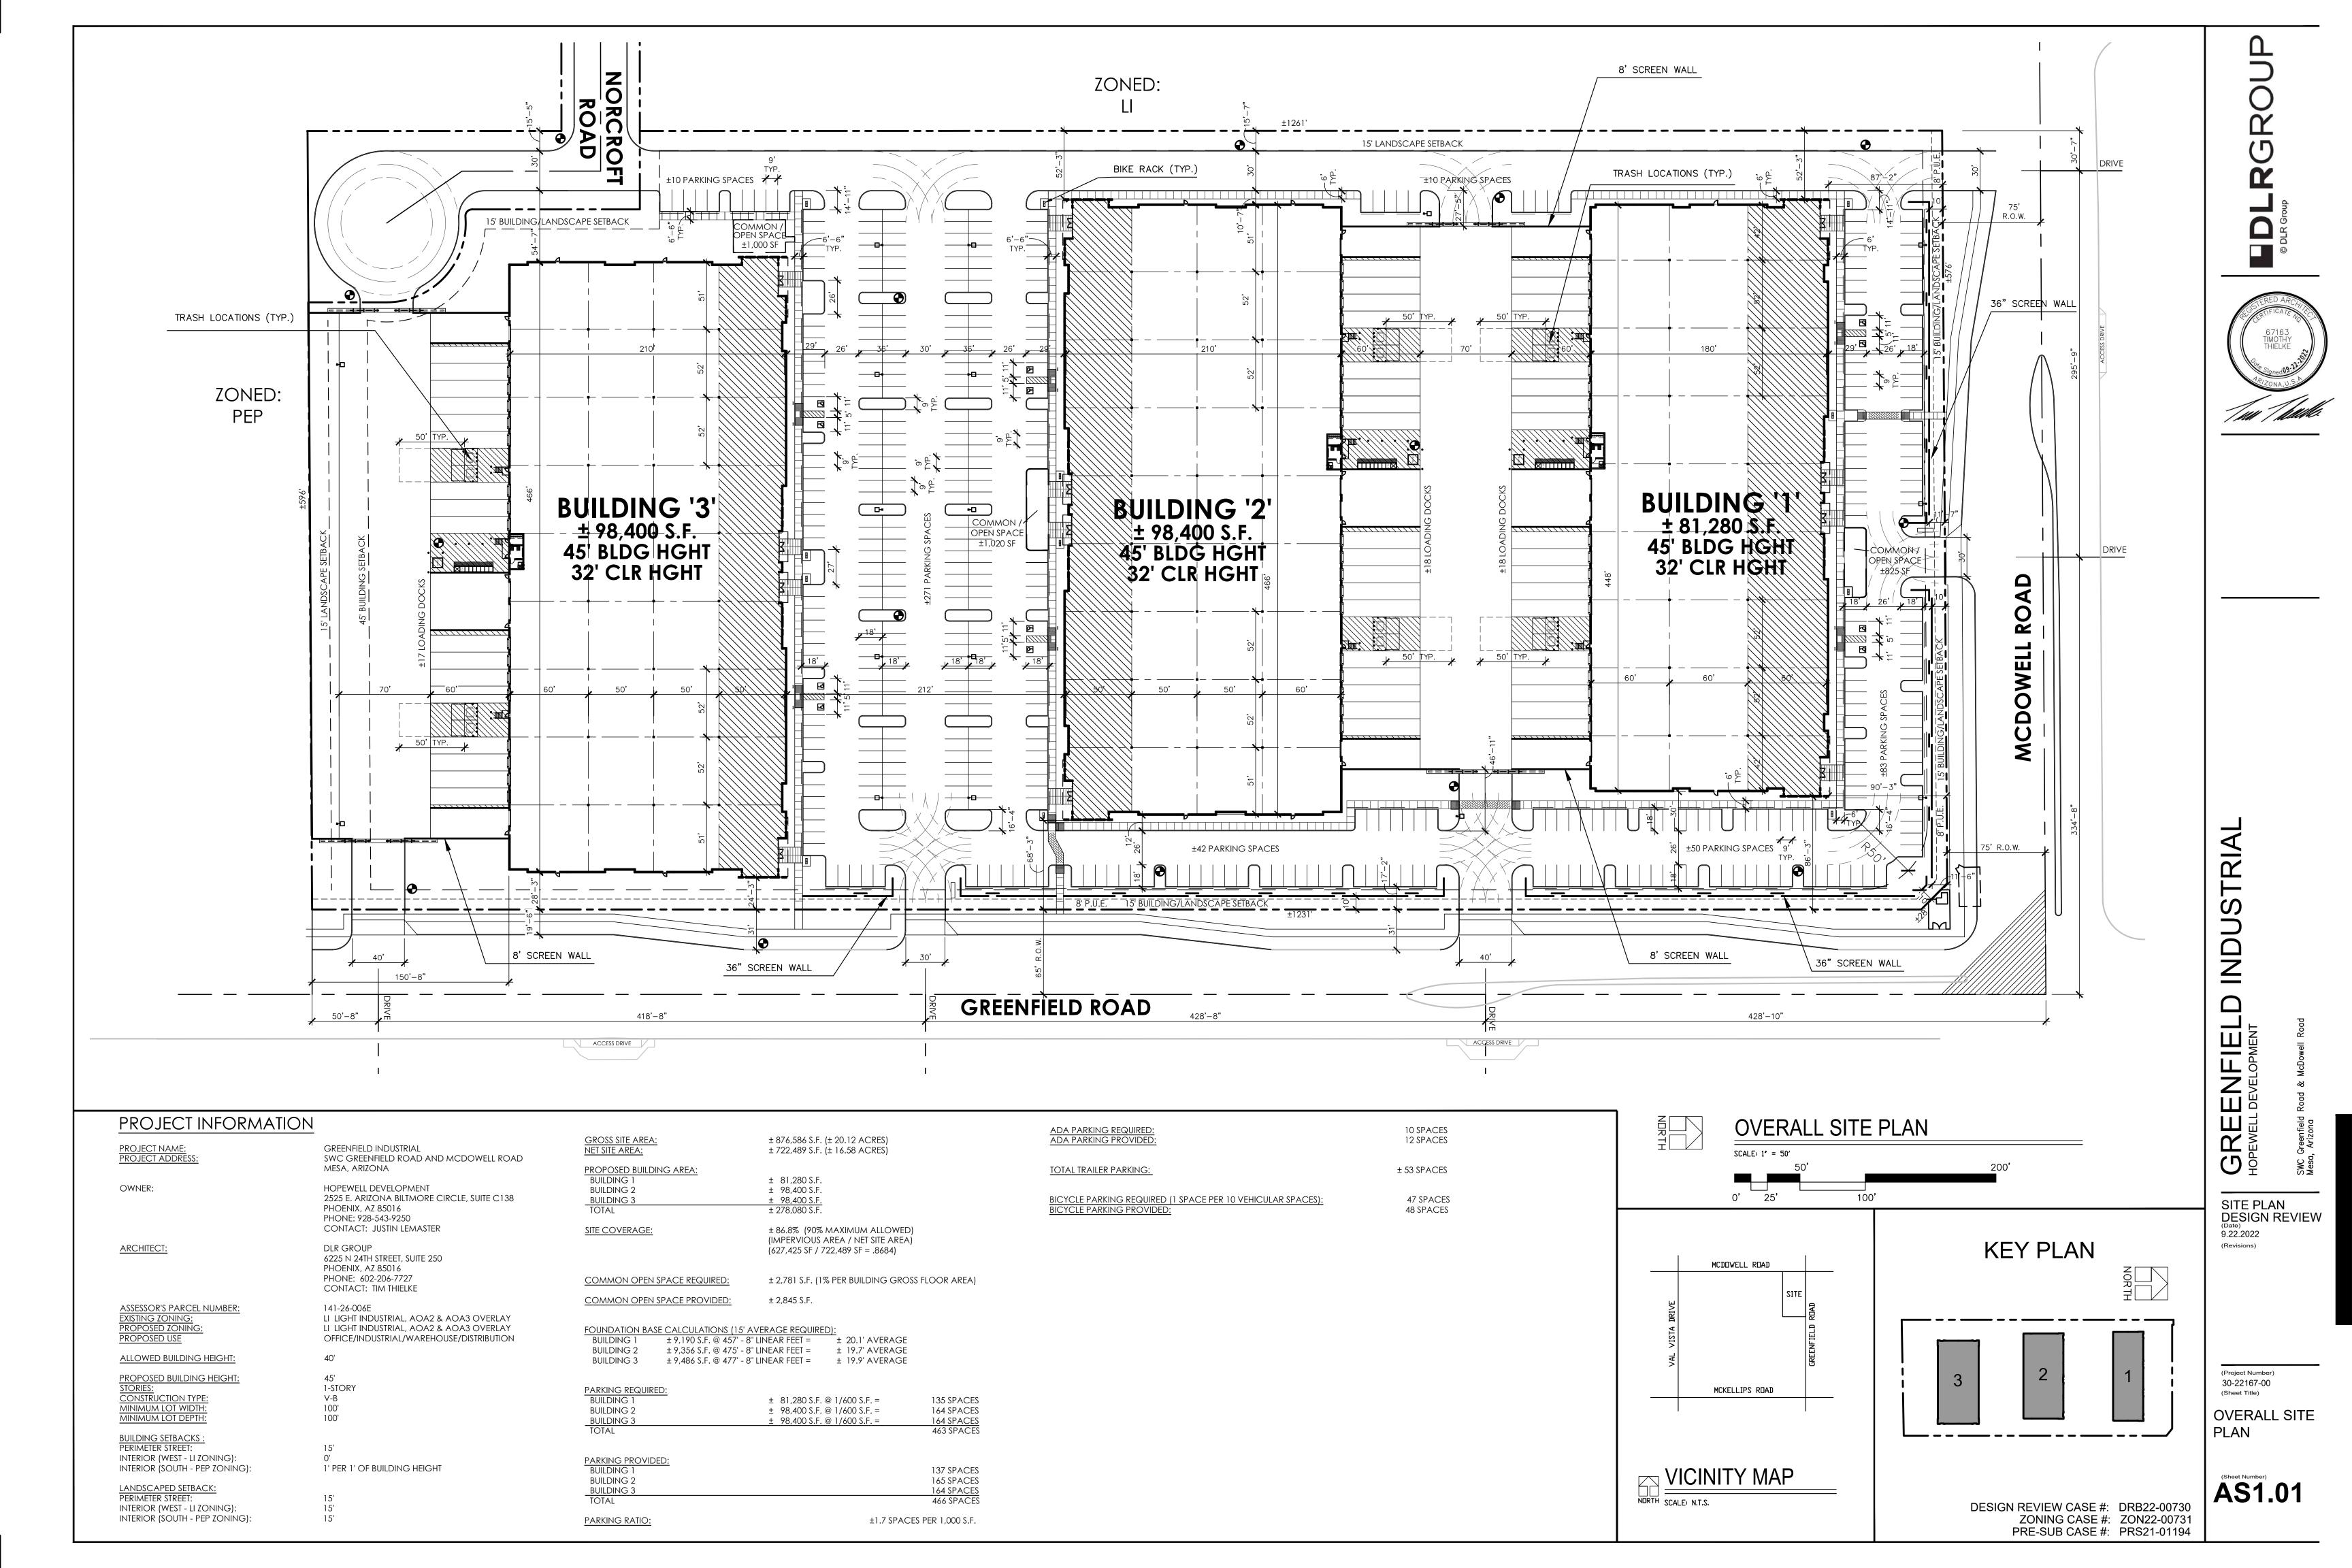

EXISTING ZONING: PROPOSED ZONING PROPOSED USE

ALLOWED BUILDING HEIGHT:

INTERIOR (WEST - LI ZONING):

INTERIOR (WEST - LI ZONING):

INTERIOR (SOUTH - PEP ZONING):

LANDSCAPED SETBACK:

PERIMETER STREET:

INTERIOR (SOUTH - PEP ZONING):

CONSTRUCTION TYPE:

MINIMUM LOT WIDTH

MINIMUM LOT DEPTH:

LI LIGHT INDUSTRIAL, AOA2 & AOA3 OVERLAY LI LIGHT INDUSTRIAL, AOA2 & AOA3 OVERLAY

OFFICE/INDUSTRIAL/WAREHOUSE/DISTRIBUTION

1-STORY

1' PER 1' OF BUILDING HEIGHT

V-B

100'

100'

FOUNDATION BASE CALCULATIONS (15' AVERAGE REQUIRED):

BUILDING 3

BUILDING 1

**BUILDING 2** 

BUILDING 3

BUILDING 2

BUILDING 3

PARKING RATIO:

PARKING REQUIRED:

PARKING PROVIDED: BUILDING 1

± 9,190 S.F. @ 457' - 8" LINEAR FEET = ± 20.1' AVERAGE ± 9,356 S.F. @ 475' - 8" LINEAR FEET = ± 19.7' AVERAGE

± 9,486 S.F. @ 477' - 8" LINEAR FEET = ± 19.9' AVERAGE

± 81,280 S.F. @ 1/600 S.F. =

± 98,400 S.F. @ 1/600 S.F. = ± 98,400 S.F. @ 1/600 S.F. =

135 SPACES

164 SPACES


164 SPACES 463 SPACES

137 SPACES 165 SPACES

164 SPACES

466 SPACES

±1.7 SPACES PER 1,000 S.F.

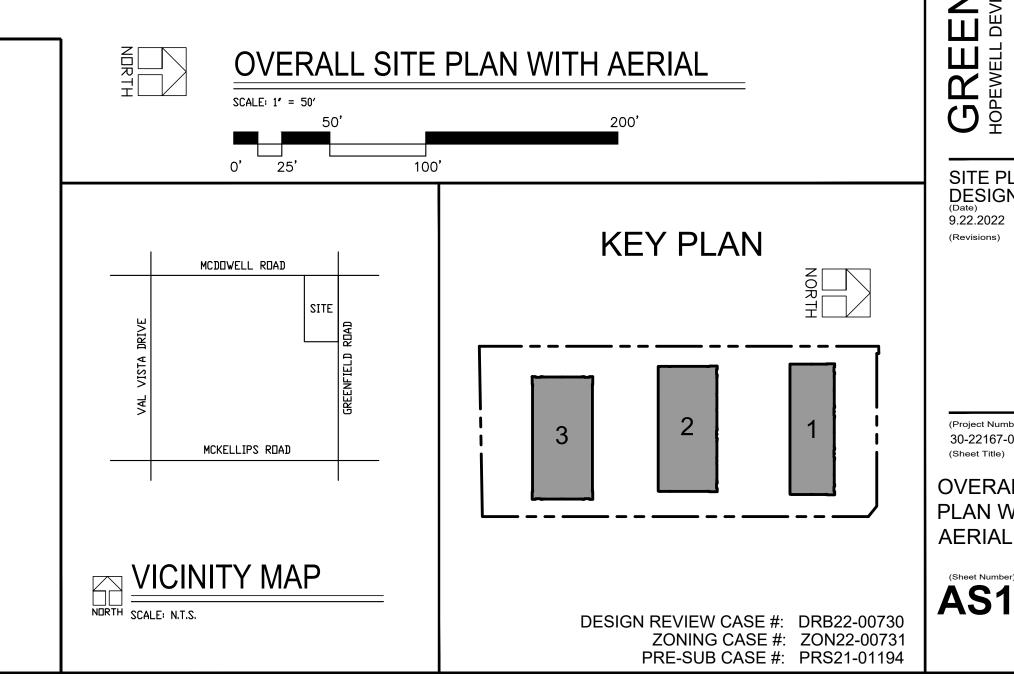

TRIAL S NDO: ENFIE! CD B

> SITE PLAN DESIGN REVIEW (Date) 9.22.2022 (Revisions)

(Project Number) 30-22167-00

**OVERALL SITE PLAN WITH AERIAL** 

**AS1.01R** 



INDUSTRIAL GREENFIEL HOPEWELL DEVELOPMENT

SITE PLAN DESIGN REVIEW 9.22.2022 (Revisions)

(Project Number) 30-22167-00 (Sheet Title)

OVERALL CONTEXT

AS1.01P DESIGN REVIEW CASE #: DRB22-00730 ZONING CASE #: ZON22-00731 PRE-SUB CASE #: PRS21-01194

(Revisions)

30-22167-00
(Sheet Title)

PROPERTIES
WITHIN 500 F


WITHIN 500 FT PLAN

(Sheet Number)

AS1.01N

DESIGN REVIEW CASE #: DRB22-00730
ZONING CASE #: ZON22-00731
PRE-SUB CASE #: PRS21-01194

**KEY PLAN** 

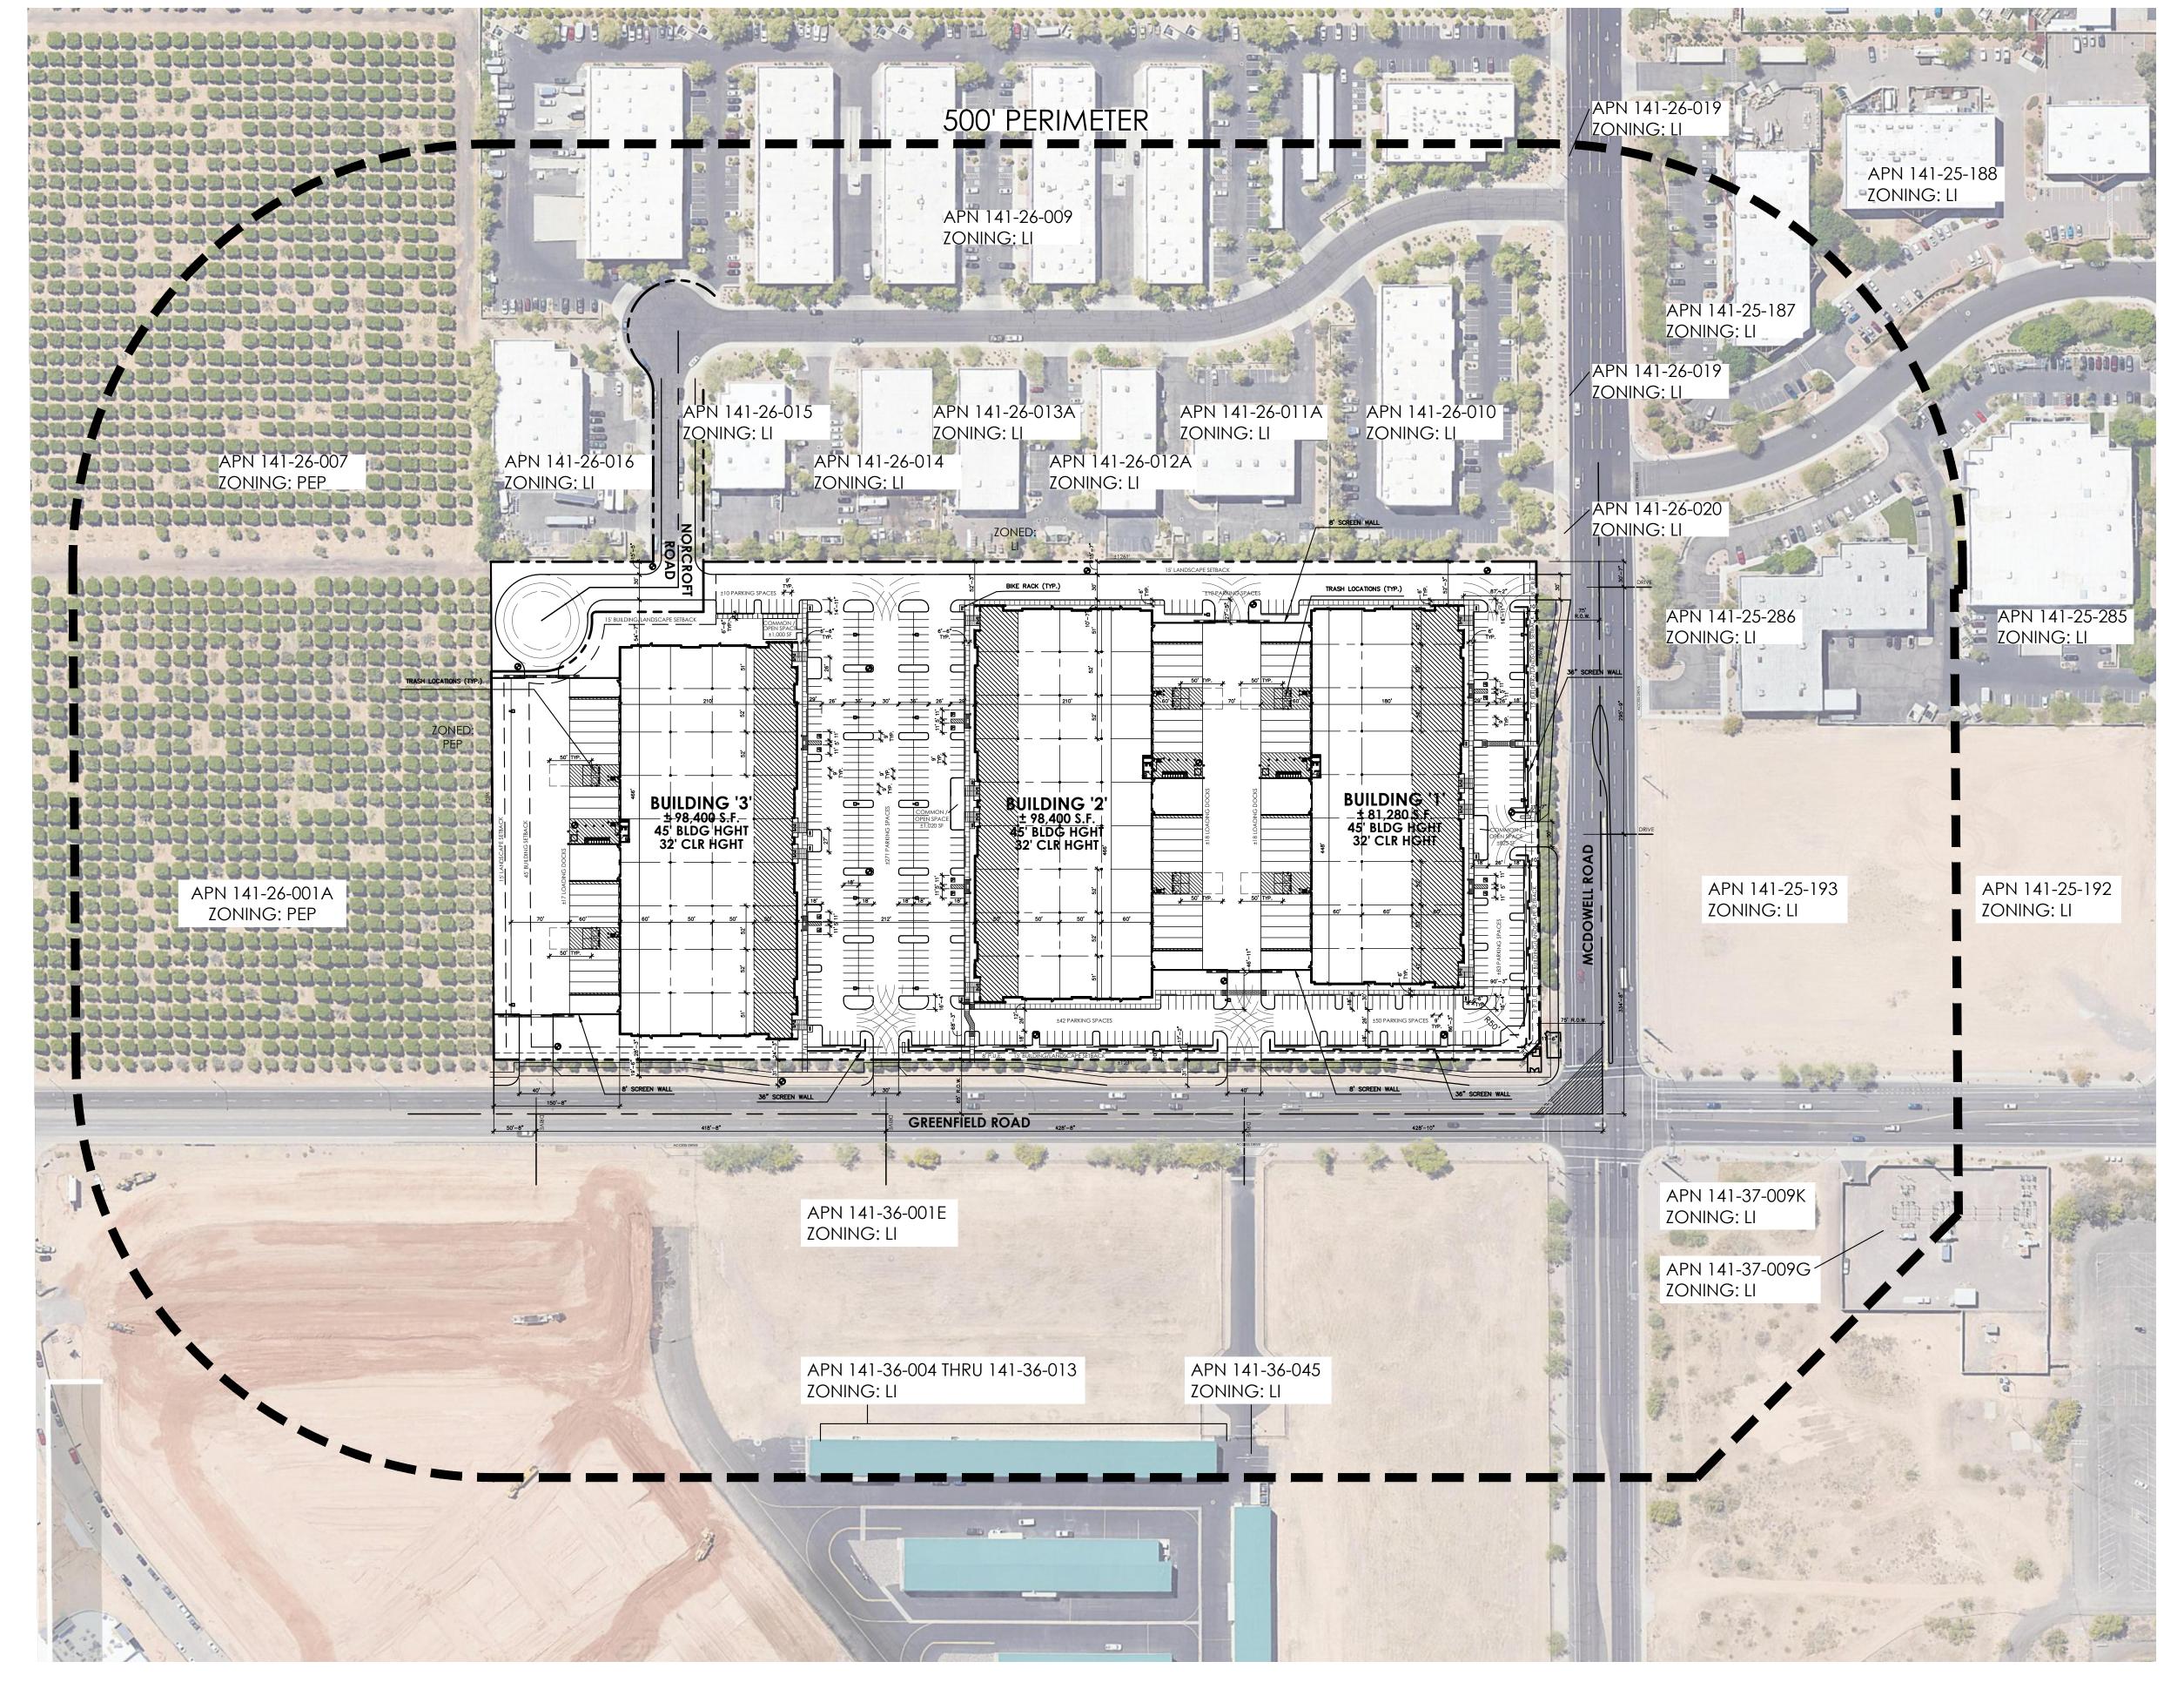





- FIRE HYDRANT (VERIFY LOCATION WITH CIVIL DRAWINGS)

- DOCK HIGH TRUCK DOOR - GRADE LEVEL TRUCK DOOR

- EGRESS MAN DOOR

## **GENERAL NOTES**

A. ALL EXTERNAL LIGHTING SHALL BE LOCATED AND DESIGNED TO PREVENT RAYS FROM BEING DIRECTED OFF OF THE

LEGEND NOTES

AND/OR REFERENCED ON ALL SHEETS.

1. BOLLARD TYP. - SEE DETAIL 14/A1.08

DETAILS 21, 31, 41/AS1.02...

18'-0")

31/AS1.03.

ELECTRICAL.

SUBMITTAL.

41/AS1.03.

REFER TO CIVIL.

DETAILS.

SUBMITTAL.

DETAIL 43/AS1.03.

CIVIL FOR GRADES.

2. STANDARD CONCRETE SIDEWALK - SEE CIVIL.

ACCESS AISLE TYP. - SEE DETAIL 25/AS1.02.

ACCESS AISLE TYP. - SEE DETAIL 25/AS1.02..

DRAWINGS UNDER SEPARATE REVIEW AND PERMIT.

ENTRANCES AND COMMON OUTDOOR SPACE.

- 35' INSIDE RADIUS, 55' OUTSIDE RADIUS.

AND TEXTURE FROM ASPHALTIC PAVING.

24/AS1.03 AND ELECTRICAL DRAWINGS.

LANDSCAPE SHEET L2.0 FOR ENLARGED PLANS AND

COORDINATED WITH AND APPROVED BY WATER RESOURCES.

PROPERTY UPON WHICH THE LIGHTING IS LOCATED. B. ALL SITE IMPROVEMENTS: PAVING, CONCRETE CURBS, GUTTERS, ETC. SHALL BE DESIGNED AND INSTALLED PER

THE GEOTECHNICAL SOILS REPORT. C. ALL PEDESTRIAN SIDEWALKS, CROSSWALKS, AND AISLES

THROUGHOUT THE SITE AND INCLUDING CONNECTIONS TO THE PUBLIC WAY ARE PART OF THE ACCESSIBLE ROUTE AND SHALL/HAVE BEEN DESIGNED TO MEET ACCESSIBLE ROUTE GUIDELINES AND REQUIREMENTS.

D. CURBING ALONG ALL FIRE ACCESS LANES, OTHER THAN THAT WITHIN PARKING STALLS, SHALL BE PAINTED AND MARKED "NO PARKING - FIRE LANE". INSTALL SIGNAGE -SEE DETAIL 11/AS1.03.

SPRINKLER SYSTEM CAPABILITIES AND LIMITATIONS PLACARD OR PLACARDS SHALL BE INSTALLED AS REQUIRED IN CITY OF PHOENIX FIRE CODE.

**KEY PLAN** 

DESIGN REVIEW CASE #: DRB22-00730

ZONING CASE #: ZON22-00731 PRE-SUB CASE #: PRS21-01194


GRENELL HOPEWELL


SITE PLAN DESIGN REVIEW 9.22.2022 (Revisions)

(Project Number) 30-22167-00 (Sheet Title)

**ENLARGED** SITE PLAN -AREA A

**AS1.01A** 

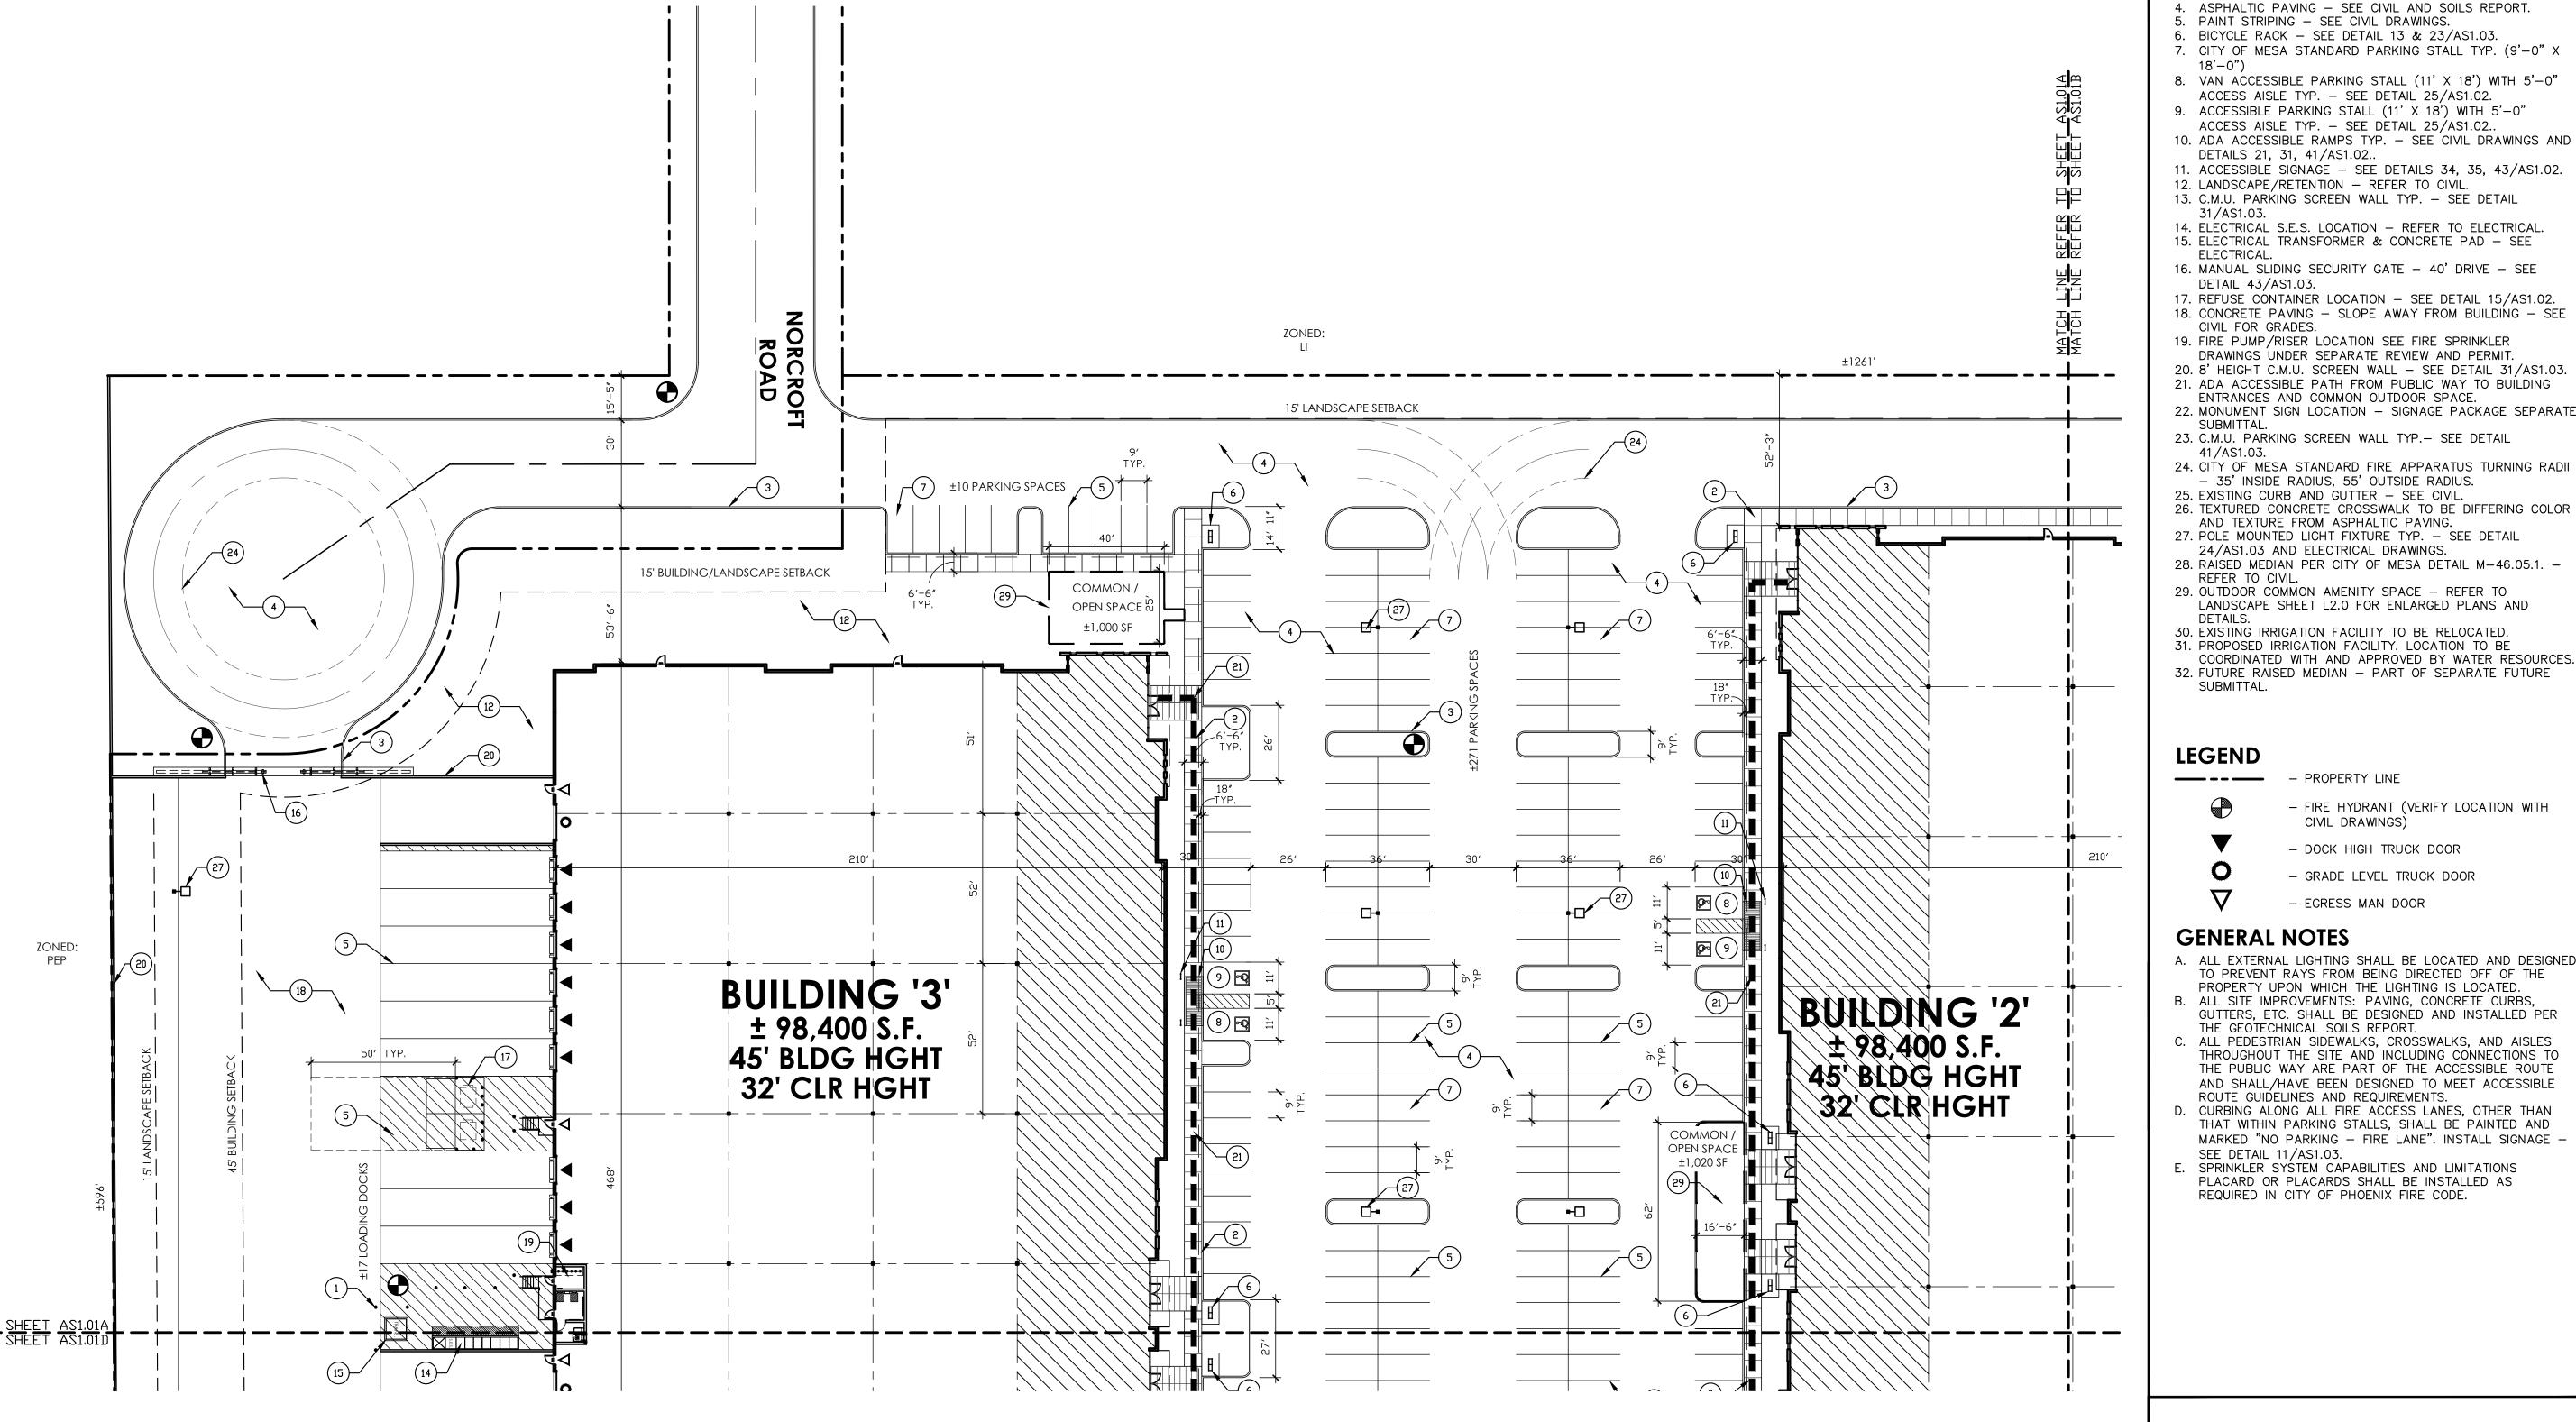

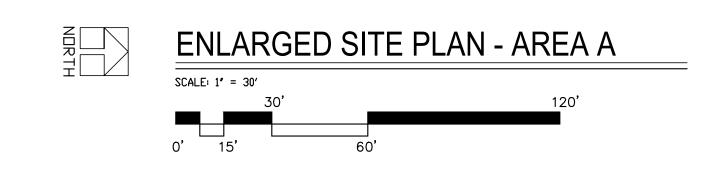

## LEGEND NOTES

- THE SITE KEYNOTES LISTED BELOW ARE TYPICAL TO THE PROJECT AND MAY NOT BE APPLICABLE AND/OR REFERENCED ON ALL SHEETS.
- 1. BOLLARD TYP. SEE DETAIL 14/A1.08
- 2. STANDARD CONCRETE SIDEWALK SEE CIVIL. 3. 6" CONCRETE CURB (AND GUTTER) TYP. - SEE CIVIL
- 4. ASPHALTIC PAVING SEE CIVIL AND SOILS REPORT. 5. PAINT STRIPING - SEE CIVIL DRAWINGS.
- 6. BICYCLE RACK SEE DETAIL 13 & 23/AS1.03. 7. CITY OF MESA STANDARD PARKING STALL TYP. (9'-0" X
- 8. VAN ACCESSIBLE PARKING STALL (11' X 18') WITH 5'-0"
- ACCESS AISLE TYP. SEE DETAIL 25/AS1.02. 9. ACCESSIBLE PARKING STALL (11' X 18') WITH 5'-0" ACCESS AISLE TYP. - SEE DETAIL 25/AS1.02..
- DETAILS 21, 31, 41/AS1.02... 11. ACCESSIBLE SIGNAGE - SEE DETAILS 34, 35, 43/AS1.02.
- 12. LANDSCAPE/RETENTION REFER TO CIVIL.
- 13. C.M.U. PARKING SCREEN WALL TYP. SEE DETAIL 31/AS1.03. 14. ELECTRICAL S.E.S. LOCATION - REFER TO ELECTRICAL.
- 15. ELECTRICAL TRANSFORMER & CONCRETE PAD SEE ELECTRICAL.
- 16. MANUAL SLIDING SECURITY GATE 40' DRIVE SEE DETAIL 43/AS1.03.
- 17. REFUSE CONTAINER LOCATION SEE DETAIL 15/AS1.02. 18. CONCRETE PAVING - SLOPE AWAY FROM BUILDING - SEE CIVIL FOR GRADES.
- 19. FIRE PUMP/RISER LOCATION SEE FIRE SPRINKLER DRAWINGS UNDER SEPARATE REVIEW AND PERMIT.
- 20. 8' HEIGHT C.M.U. SCREEN WALL SEE DETAIL 31/AS1.03. 21. ADA ACCESSIBLE PATH FROM PUBLIC WAY TO BUILDING
- ENTRANCES AND COMMON OUTDOOR SPACE. 22. MONUMENT SIGN LOCATION - SIGNAGE PACKAGE SEPARATE
- 23. C.M.U. PARKING SCREEN WALL TYP.- SEE DETAIL
- 24. CITY OF MESA STANDARD FIRE APPARATUS TURNING RADII - 35' INSIDE RADIUS, 55' OUTSIDE RADIUS.
- 25. EXISTING CURB AND GUTTER SEE CIVIL. 26. TEXTURED CONCRETE CROSSWALK TO BE DIFFERING COLOR AND TEXTURE FROM ASPHALTIC PAVING.
- 27. POLE MOUNTED LIGHT FIXTURE TYP. SEE DETAIL 24/AS1.03 AND ELECTRICAL DRAWINGS.
- 28. RAISED MEDIAN PER CITY OF MESA DETAIL M-46.05.1. -REFER TO CIVIL. 29. OUTDOOR COMMON AMENITY SPACE - REFER TO
- LANDSCAPE SHEET L2.0 FOR ENLARGED PLANS AND
- 30. EXISTING IRRIGATION FACILITY TO BE RELOCATED. 31. PROPOSED IRRIGATION FACILITY. LOCATION TO BE
- COORDINATED WITH AND APPROVED BY WATER RESOURCES. 32. FUTURE RAISED MEDIAN - PART OF SEPARATE FUTURE SUBMITTAL.

- PROPERTY LINE

- FIRE HYDRANT (VERIFY LOCATION WITH CIVIL DRAWINGS)

- DOCK HIGH TRUCK DOOR

- GRADE LEVEL TRUCK DOOR - EGRESS MAN DOOR

# **GENERAL NOTES**

- A. ALL EXTERNAL LIGHTING SHALL BE LOCATED AND DESIGNED TO PREVENT RAYS FROM BEING DIRECTED OFF OF THE
- PROPERTY UPON WHICH THE LIGHTING IS LOCATED. B. ALL SITE IMPROVEMENTS: PAVING, CONCRETE CURBS, GUTTERS, ETC. SHALL BE DESIGNED AND INSTALLED PER
- THE GEOTECHNICAL SOILS REPORT. C. ALL PEDESTRIAN SIDEWALKS, CROSSWALKS, AND AISLES THROUGHOUT THE SITE AND INCLUDING CONNECTIONS TO THE PUBLIC WAY ARE PART OF THE ACCESSIBLE ROUTE
- AND SHALL/HAVE BEEN DESIGNED TO MEET ACCESSIBLE ROUTE GUIDELINES AND REQUIREMENTS. D. CURBING ALONG ALL FIRE ACCESS LANES, OTHER THAN
- THAT WITHIN PARKING STALLS, SHALL BE PAINTED AND MARKED "NO PARKING - FIRE LANE". INSTALL SIGNAGE -SEE DETAIL 11/AS1.03.

SPRINKLER SYSTEM CAPABILITIES AND LIMITATIONS PLACARD OR PLACARDS SHALL BE INSTALLED AS REQUIRED IN CITY OF PHOENIX FIRE CODE.

> SITE PLAN DESIGN REVIEW 9.22.2022 (Revisions)

(Project Number) 30-22167-00

AREA B

CD B **KEY PLAN** 

DESIGN REVIEW CASE #: DRB22-00730

ZONING CASE #: ZON22-00731 PRE-SUB CASE #: PRS21-01194

(Sheet Title) **ENLARGED** SITE PLAN -

**AS1.01B** 

# LEGEND NOTES

- THE SITE KEYNOTES LISTED BELOW ARE TYPICAL TO THE PROJECT AND MAY NOT BE APPLICABLE AND/OR REFERENCED ON ALL SHEETS.
- 1. BOLLARD TYP. SEE DETAIL 14/A1.08
- 2. STANDARD CONCRETE SIDEWALK SEE CIVIL.
  3. 6" CONCRETE CURB (AND GUTTER) TYP. SEE CIVIL
- 4. ASPHALTIC PAVING SEE CIVIL AND SOILS REPORT. 5. PAINT STRIPING - SEE CIVIL DRAWINGS. 6. BICYCLE RACK - SEE DETAIL 13 & 23/AS1.03.
- 7. CITY OF MESA STANDARD PARKING STALL TYP. (9'-0" X
- 8. VAN ACCESSIBLE PARKING STALL (11' X 18') WITH 5'-0"
- 9. ACCESSIBLE PARKING STALL (11' X 18') WITH 5'-0" ACCESS AISLE TYP. - SEE DETAIL 25/AS1.02..
- DETAILS 21, 31, 41/AS1.02.. 11. ACCESSIBLE SIGNAGE - SEE DETAILS 34, 35, 43/AS1.02.
- 12. LANDSCAPE/RETENTION REFER TO CIVIL. 13. C.M.U. PARKING SCREEN WALL TYP. - SEE DETAIL
- 14. ELÉCTRICAL S.E.S. LOCATION REFER TO ELECTRICAL.
- 15. ELECTRICAL TRANSFORMER & CONCRETE PAD SEE 16. MANUAL SLIDING SECURITY GATE - 40' DRIVE - SEE
- DETAIL 43/AS1.03. 17. REFUSE CONTAINER LOCATION — SEE DETAIL 15/AS1.02.
- 18. CONCRETE PAVING SLOPE AWAY FROM BUILDING SEE CIVIL FOR GRADES.
- 19. FIRE PUMP/RISER LOCATION SEE FIRE SPRINKLER DRAWINGS UNDER SEPARATE REVIEW AND PERMIT.
- 20. 8' HEIGHT C.M.U. SCREEN WALL SEE DETAIL 31/AS1.03. 21. ADA ACCESSIBLE PATH FROM PUBLIC WAY TO BUILDING
- ENTRANCES AND COMMON OUTDOOR SPACE.

  22. MONUMENT SIGN LOCATION SIGNAGE PACKAGE SEPARATE
- 23. C.M.U. PARKING SCREEN WALL TYP. SEE DETAIL
- 24. CITY OF MESA STANDARD FIRE APPARATUS TURNING RADII - 35' INSIDE RADIUS, 55' OUTSIDE RADIUS.
- 26. TEXTURED CONCRETE CROSSWALK TO BE DIFFERING COLOR AND TEXTURE FROM ASPHALTIC PAVING.
- 27. POLE MOUNTED LIGHT FIXTURE TYP. SEE DETAIL 24/AS1.03 AND ELECTRICAL DRAWINGS. 28. RAISED MEDIAN PER CITY OF MESA DETAIL M-46.05.1. -
- REFER TO CIVIL. 29. OUTDOOR COMMON AMENITY SPACE — REFER TO LANDSCAPE SHEET L2.0 FOR ENLARGED PLANS AND
- 30. EXISTING IRRIGATION FACILITY TO BE RELOCATED.
- 31. PROPOSED IRRIGATION FACILITY. LOCATION TO BE COORDINATED WITH AND APPROVED BY WATER RESOURCES. 32. FUTURE RAISED MEDIAN - PART OF SEPARATE FUTURE

PROPERTY LINE - FIRE HYDRANT (VERIFY LOCATION WITH

CIVIL DRAWINGS) - DOCK HIGH TRUCK DOOR

- GRADE LEVEL TRUCK DOOR

- A. ALL EXTERNAL LIGHTING SHALL BE LOCATED AND DESIGNED
- PROPERTY UPON WHICH THE LIGHTING IS LOCATED. B. ALL SITE IMPROVEMENTS: PAVING, CONCRETE CURBS, GUTTERS, ETC. SHALL BE DESIGNED AND INSTALLED PER
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DESIGN REVIEW CASE #: DRB22-00730


ZONING CASE #: ZON22-00731 PRE-SUB CASE #: PRS21-01194

> SITE PLAN DESIGN REVIEW 9.22.2022 (Revisions)

(Project Number) 30-22167-00 (Sheet Title)

**ENLARGED** SITE PLAN -AREA C

AS1.01C

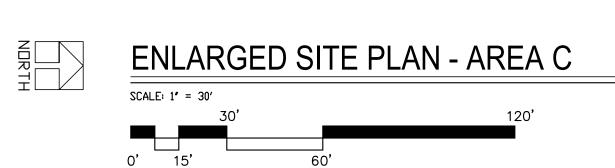

# LEGEND NOTES

THE SITE KEYNOTES LISTED BELOW ARE TYPICAL TO THE PROJECT AND MAY NOT BE APPLICABLE AND/OR REFERENCED ON ALL SHEETS.

1. BOLLARD TYP. - SEE DETAIL 14/A1.08

2. STANDARD CONCRETE SIDEWALK - SEE CIVIL. 3. 6" CONCRETE CURB (AND GUTTER) TYP. - SEE CIVIL

4. ASPHALTIC PAVING - SEE CIVIL AND SOILS REPORT. 5. PAINT STRIPING - SEE CIVIL DRAWINGS. 6. BICYCLE RACK - SEE DETAIL 13 & 23/AS1.03.

7. CITY OF MESA STANDARD PARKING STALL TYP. (9'-0" X

8. VAN ACCESSIBLE PARKING STALL (11' X 18') WITH 5'-0" ACCESS AISLE TYP. - SEE DETAIL 25/AS1.02. 9. ACCESSIBLE PARKING STALL (11' X 18') WITH 5'-0"

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12. LANDSCAPE/RETENTION - REFER TO CIVIL. 13. C.M.U. PARKING SCREEN WALL TYP. - SEE DETAIL

14. ELÉCTRICAL S.E.S. LOCATION — REFER TO ELECTRICAL. 15. ELECTRICAL TRANSFORMER & CONCRETE PAD — SEE

16. MANUAL SLIDING SECURITY GATE - 40' DRIVE - SEE DETAIL 43/AS1.03.

17. REFUSE CONTAINER LOCATION — SEE DETAIL 15/AS1.02. 18. CONCRETE PAVING - SLOPE AWAY FROM BUILDING - SEE

19. FIRE PUMP/RISER LOCATION SEE FIRE SPRINKLER DRAWINGS UNDER SEPARATE REVIEW AND PERMIT.

20. 8' HEIGHT C.M.U. SCREEN WALL - SEE DETAIL 31/AS1.03. 21. ADA ACCESSIBLE PATH FROM PUBLIC WAY TO BUILDING ENTRANCES AND COMMON OUTDOOR SPACE.

SUBMITTAL. 23. C.M.U. PARKING SCREEN WALL TYP. - SEE DETAIL

- 35' INSIDE RADIUS, 55' OUTSIDE RADIUS. 25. EXISTING CURB AND GUTTER - SEE CIVIL. 26. TEXTURED CONCRETE CROSSWALK TO BE DIFFERING COLOR

AND TEXTURE FROM ASPHALTIC PAVING. 27. POLE MOUNTED LIGHT FIXTURE TYP. - SEE DETAIL

24/AS1.03 AND ELECTRICAL DRAWINGS. 28. RAISED MEDIAN PER CITY OF MESA DETAIL M-46.05.1. -REFER TO CIVIL.

29. OUTDOOR COMMON AMENITY SPACE - REFER TO LANDSCAPE SHEET L2.0 FOR ENLARGED PLANS AND

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COORDINATED WITH AND APPROVED BY WATER RESOURCES. 32. FUTURE RAISED MEDIAN - PART OF SEPARATE FUTURE

- PROPERTY LINE

- FIRE HYDRANT (VERIFY LOCATION WITH CIVIL DRAWINGS)

- DOCK HIGH TRUCK DOOR

- GRADE LEVEL TRUCK DOOR - EGRESS MAN DOOR

## **GENERAL NOTES**

PROPERTY UPON WHICH THE LIGHTING IS LOCATED. B. ALL SITE IMPROVEMENTS: PAVING, CONCRETE CURBS,

. ALL PEDESTRIAN SIDEWALKS, CROSSWALKS, AND AISLES THROUGHOUT THE SITE AND INCLUDING CONNECTIONS TO THE PUBLIC WAY ARE PART OF THE ACCESSIBLE ROUTE AND SHALL/HAVE BEEN DESIGNED TO MEET ACCESSIBLE

ROUTE GUIDELINES AND REQUIREMENTS. . CURBING ALONG ALL FIRE ACCESS LANES, OTHER THAN THAT WITHIN PARKING STALLS, SHALL BE PAINTED AND

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GUTTERS, ETC. SHALL BE DESIGNED AND INSTALLED PER THE GEOTECHNICAL SOILS REPORT.

MARKED "NO PARKING - FIRE LANE". INSTALL SIGNAGE -SEE DETAIL 11/AS1.03.

REQUIRED IN CITY OF PHOENIX FIRE CODE.

**KEY PLAN** 

DESIGN REVIEW CASE #: DRB22-00730 ZONING CASE #: ZON22-00731 PRE-SUB CASE #: PRS21-01194

CD B

(Project Number) 30-22167-00 (Sheet Title)

SITE PLAN


9.22.2022


(Revisions)

**DESIGN REVIEW** 

**ENLARGED** SITE PLAN -AREA D

**AS1.01D** 

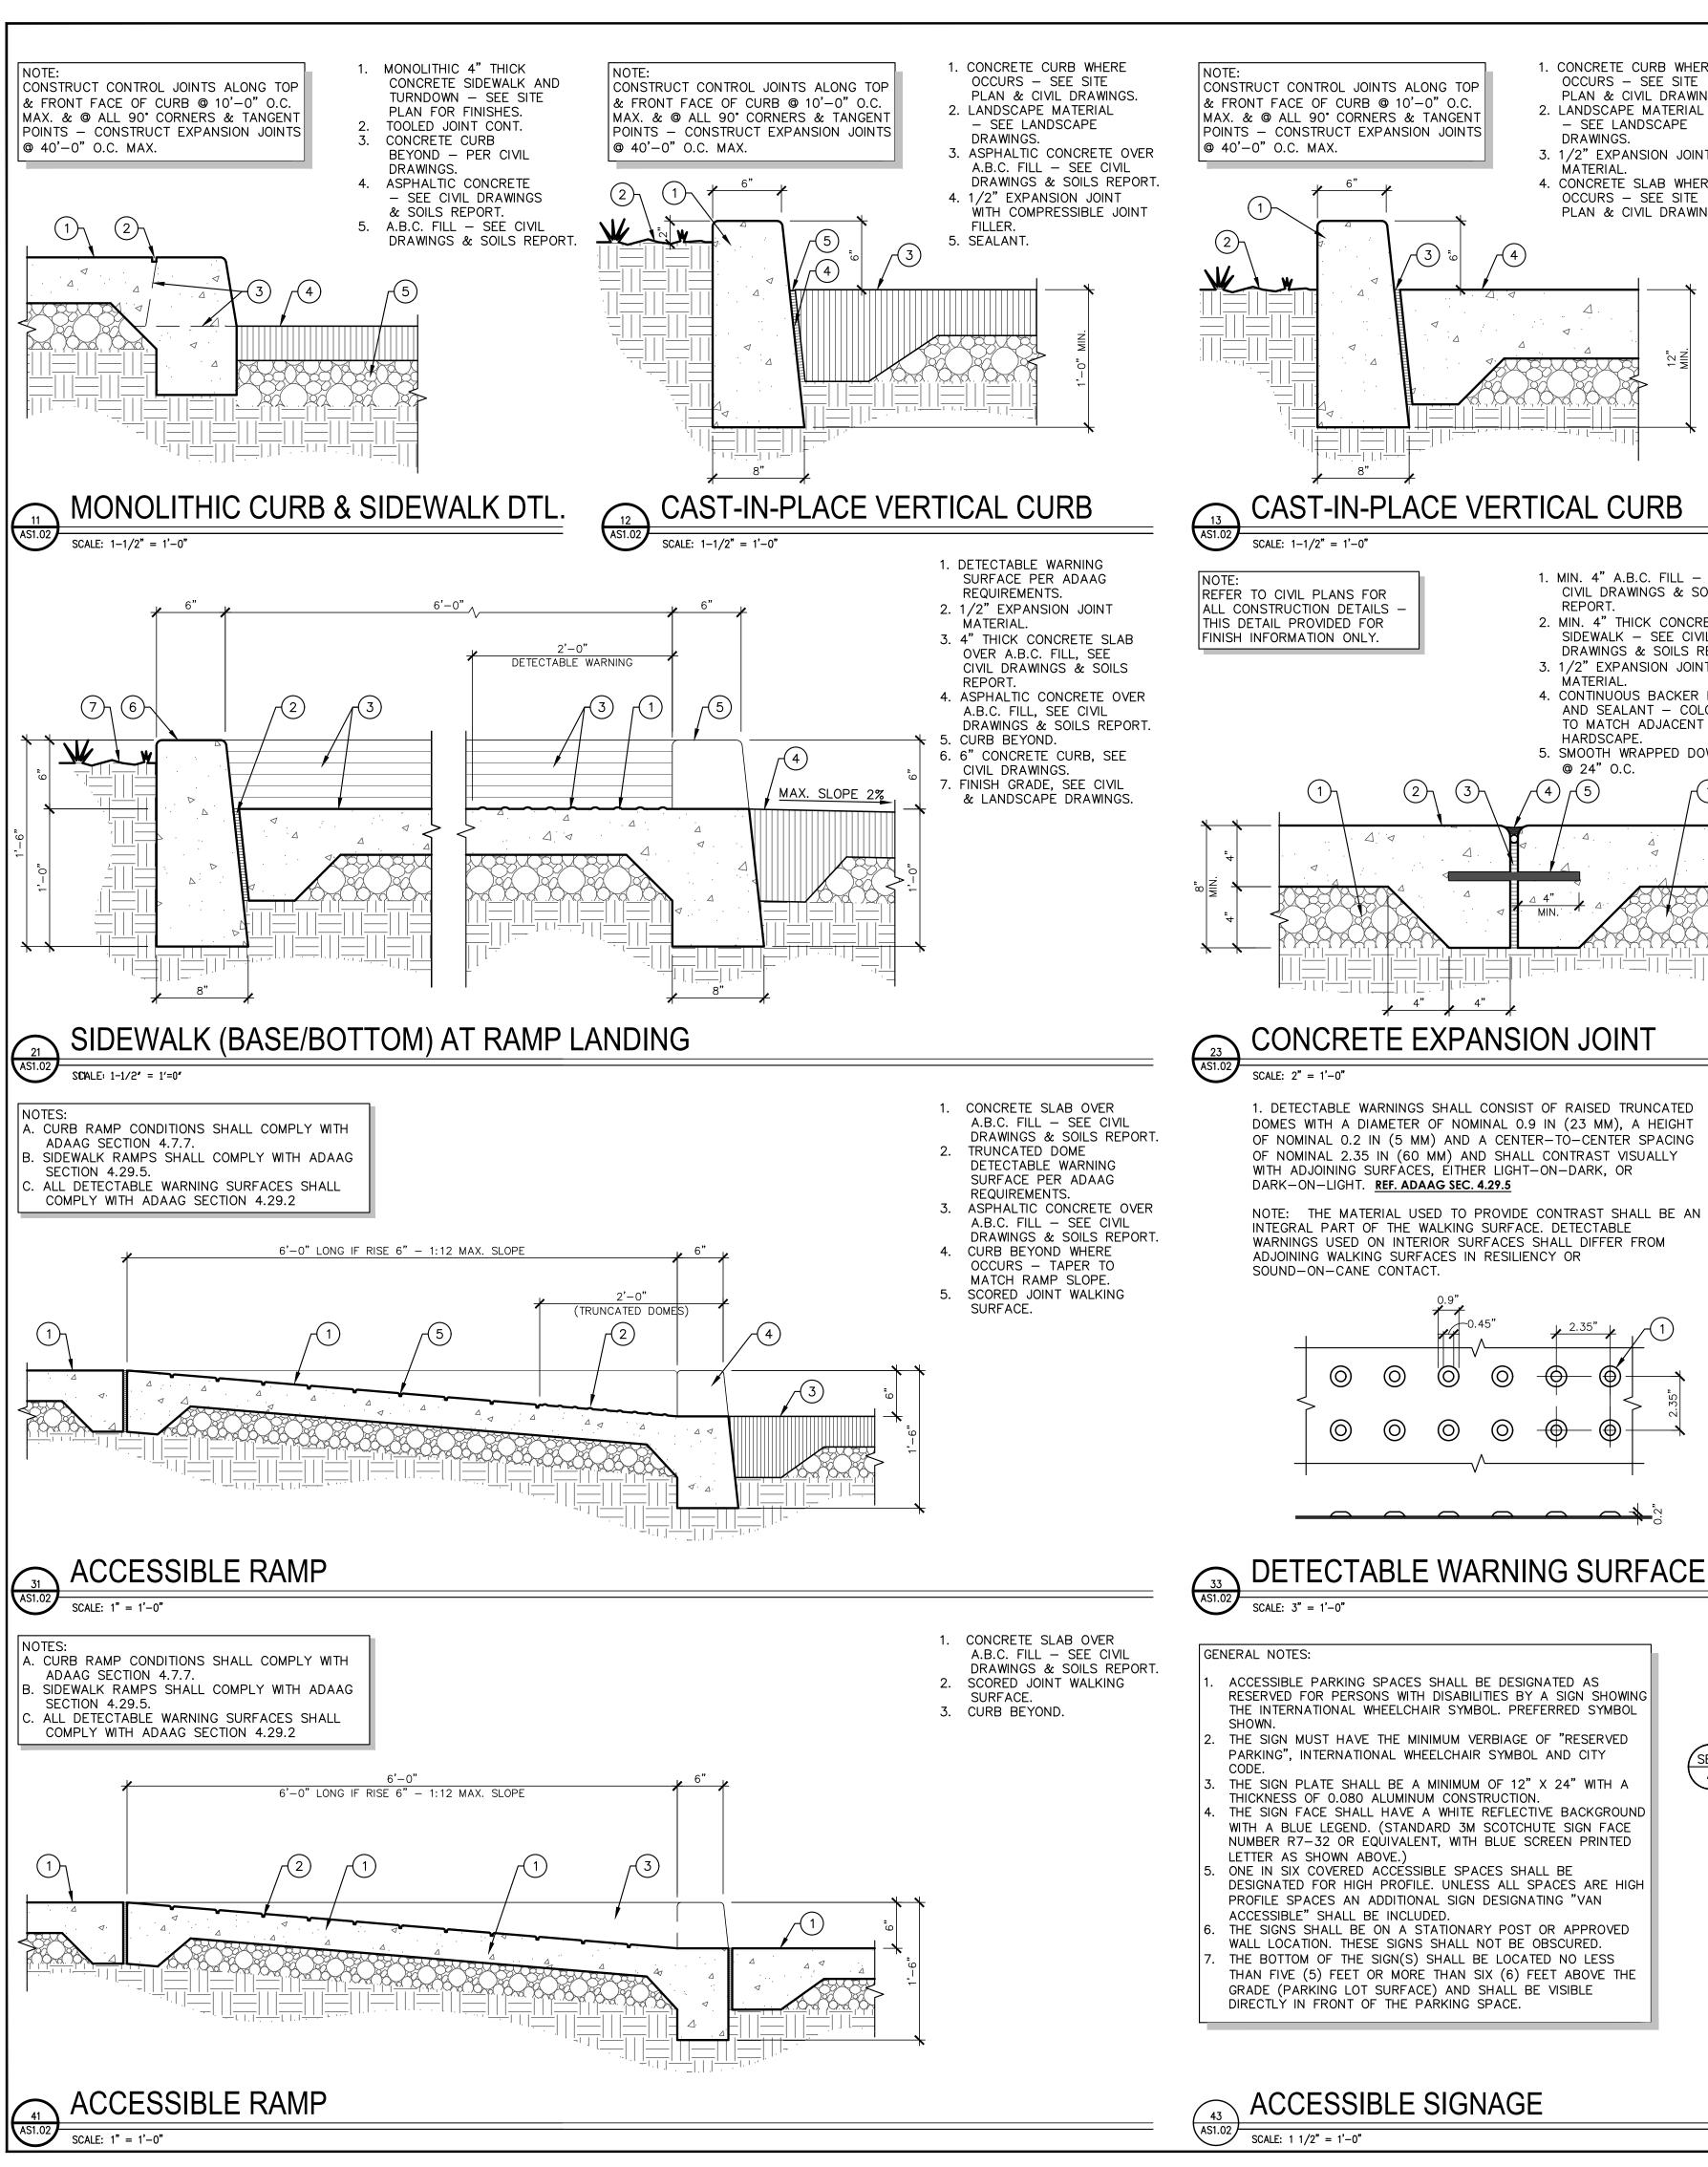

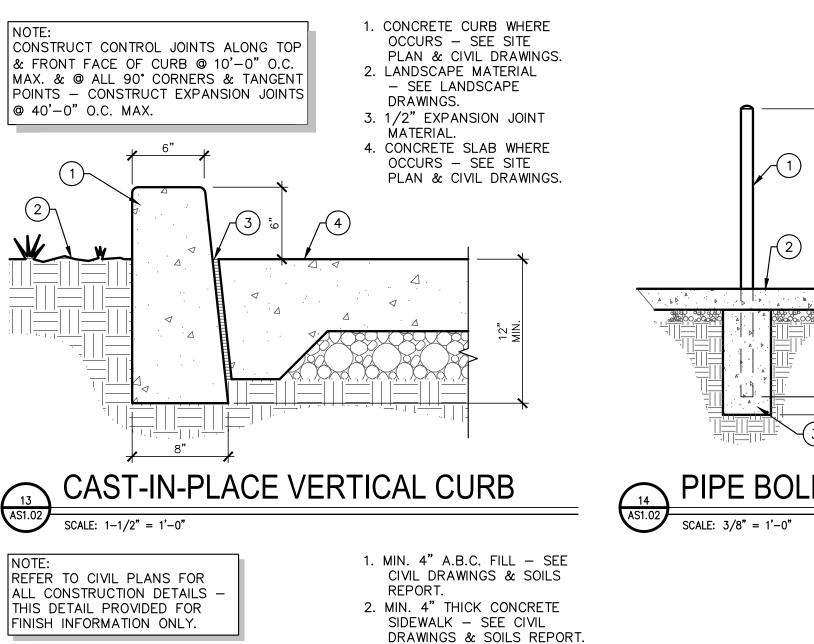

3. 1/2" EXPANSION JOINT

4. CONTINUOUS BACKER ROD

TO MATCH ADJACENT


5. SMOOTH WRAPPED DOWEL


AND SEALANT - COLOR


MATERIAL

HARDSCAPE.

@ 24" O.C.

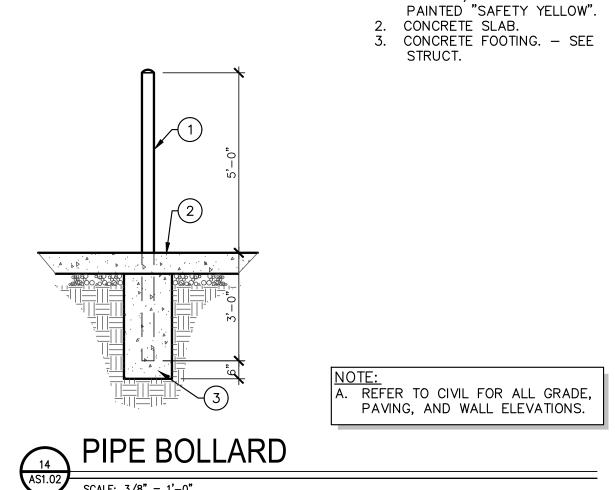

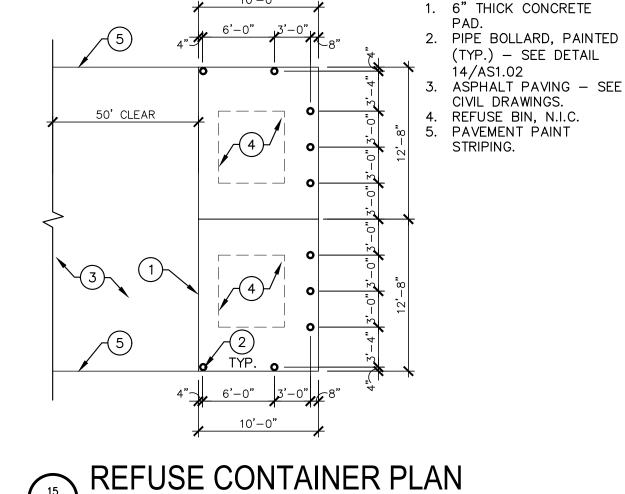

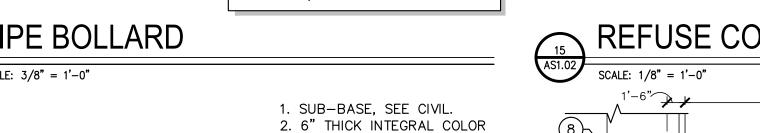

CONCRETE, W/ SCORED


3. ASPHALT PAVING, SEE CIVIL.

THE SITE PLAN.


PATTERN AS INDICATED ON

1. 6" DIA. STEEL PIPE. GROUT


SOLID W/ CROWNED TOP -

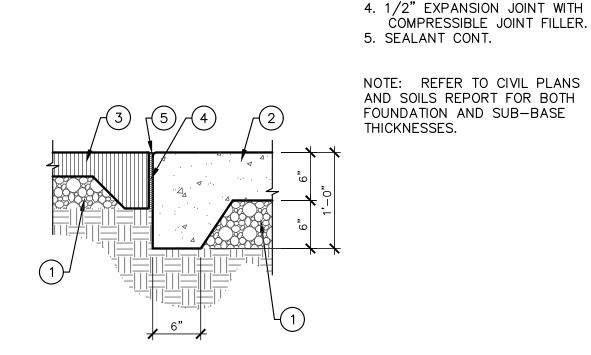


CONCRETE TURNDOWN

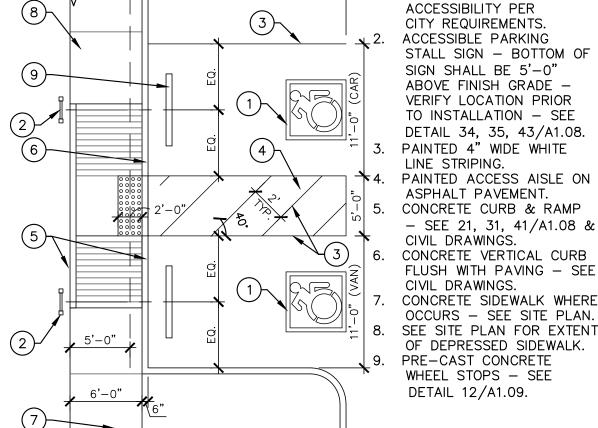



5'-0"x5'-0" SYMBOL OF

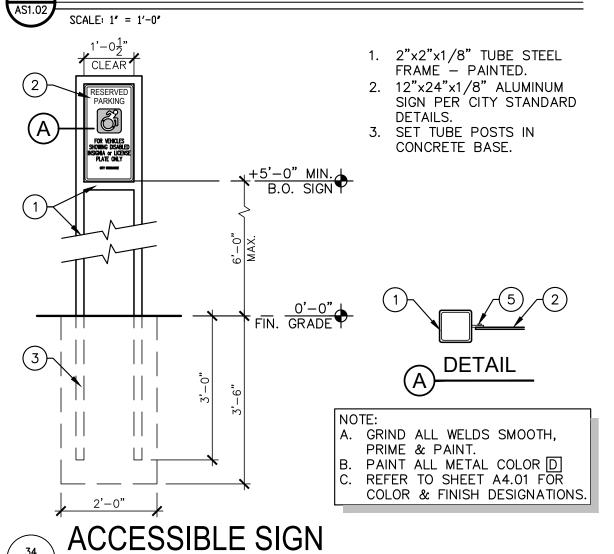

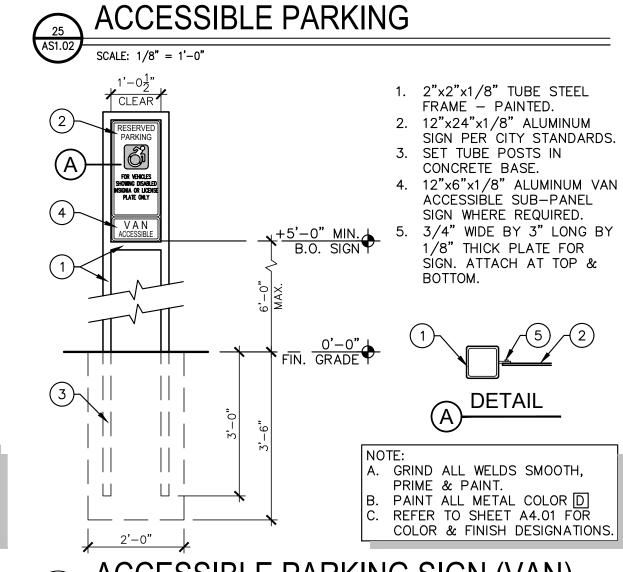



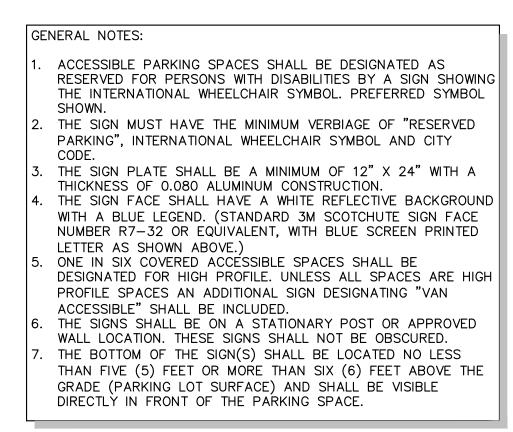

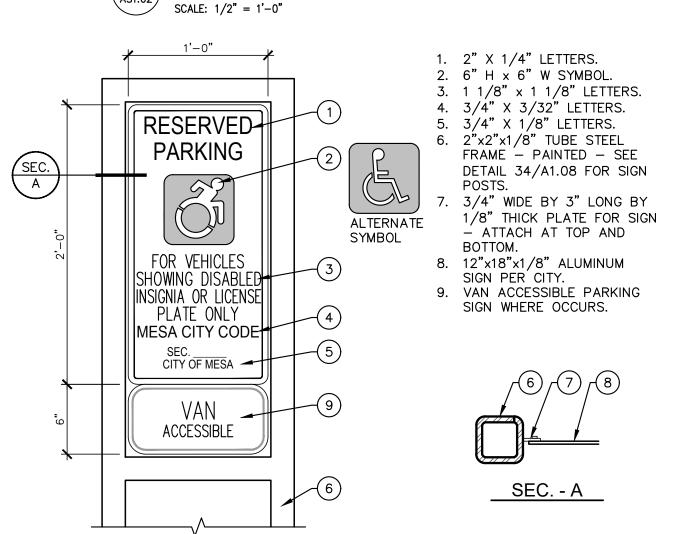

ACCESSIBLE PARKING SIGN (VAN) SCALE: 1/2" = 1'-0"

> (Project Number) 30-22167-00 (Sheet Title) SITE DETAILS

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9.22.2022

(Revisions)

SITE PLAN

**DESIGN REVIEW** 

**AS1.02** 

DESIGN REVIEW CASE #: DRB22-00730 ZONING CASE #: ZON22-00731 PRE-SUB CASE #: PRS21-01194






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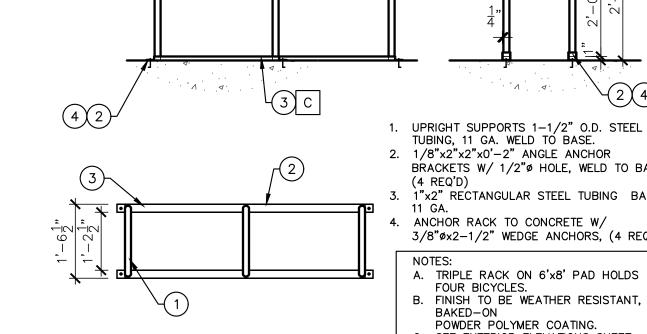
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<u>ل</u> ہُ SITE PLAN **DESIGN REVIEW** 9.22.2022 (Revisions)

(Project Number) 30-22167-00 (Sheet Title) SITE DETAILS

**AS1.03** 



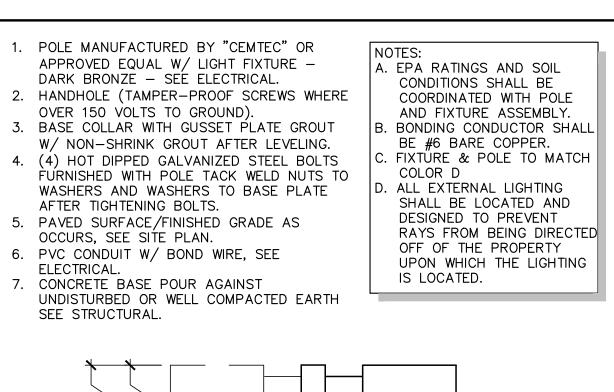


2'-4"

2'-4"

**BICYCLE RACK** 

2. 1/8"x2"x2"x0'-2" ANGLE ANCHOR BRACKETS W/ 1/2"ø HOLE, WELD TO BASE. (4 REQ'D) 3. 1"x2" RECTANGULAR STEEL TUBING BASE, ANCHOR RACK TO CONCRETE W/ 3/8" $\phi \times 2-1/2$ " WEDGE ANCHORS, (4 REQ'D). A. TRIPLE RACK ON 6'x8' PAD HOLDS FOUR BICYCLES. B. FINISH TO BE WEATHER RESISTANT, POWDER POLYMER COATING.

C. SEE EXTERIOR ELEVATIONS SHEET A4.01C FOR FINISH DESIGNATIONS.

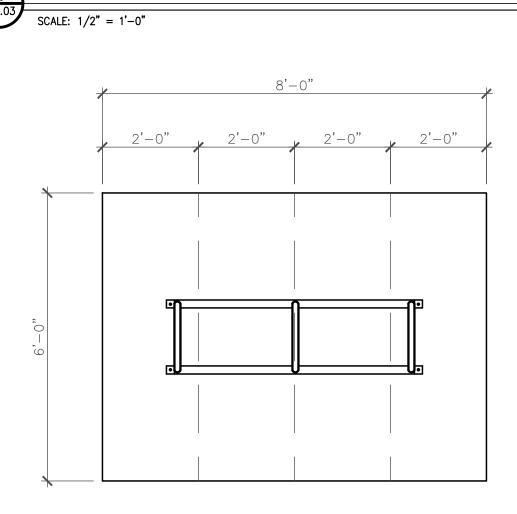

SITE POLE LIGHTING FIXTURE

SCALE: 1/2" = 1'-0"

1. 8" SMOOTH FACE CMU -

- 'L' OPAL PRECISION

INTEGRAL COLOR.

A. SEE STRUCTURAL FOR

TYPICAL WALL ELEVATION

FOR 8'-0" SCREEN WALL.

REINFORCING.

A. GRIND ALL WELDS SMOOTH,

B. PAINT ALL METAL, COLOR E.

PRIME & PAINT.

2. 8" SPLIT FACE CMU

'K' HUNTINGTON GRAY

PRECISION INTEGRAL COLOR.

A (7)

# L 9-

1. 3" HIGH  $\times$  6'-0" LONG

3. PAVEMENT. - SEE CIVIL

2. ASPHALTIC BOND.

DRAWINGS.

**CONCRETE WHEEL STOP** 

SCALE: 2" = 1'-0"

10'-8" MAX.

4. SEALANT (TYP.)


PAVING - SEE

SPECIFICATIONS.

PRECAST WHEEL STOP.

5. HOLD DOWN PIN AT ASPHALT

BICYCLE RACK CONCRETE PAD SCALE: 1/2" = 1'-0"

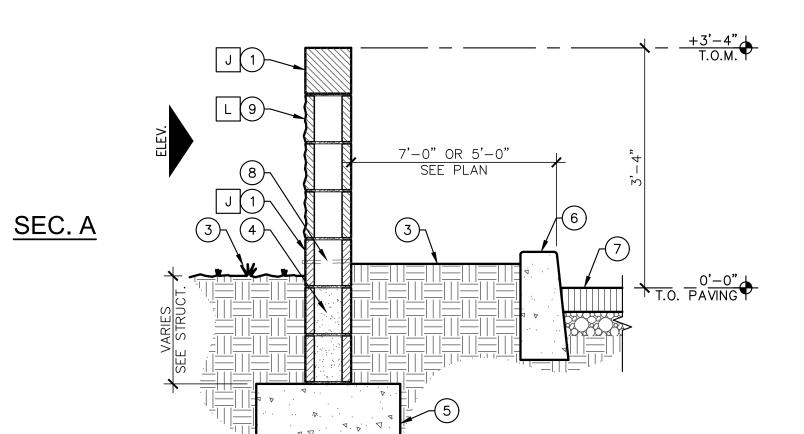

1. 2" LETTERS ARE 5/8" WIDE.

4. ALL LETTERS ARE RED WITH

MOUNTED ON A POST AS

PER MAG STD. DTL. 131.

6. THE BOTTOM OF THE SIGN IS

7. CURBING SHALL BE PAINTED

PARKING-FIRE LANE".

8. THESE SIGNS ARE NOT

MESA.

TO BE 7' ABOVE GRADE AND

SPACED NO MORE THAN 75'

BRILLIANT RED WITH WHITE

2" LETTERING NOTES: "NO

SUPPLIED BY THE CITY OF

J 1)-

2. 1-1/2" LETTERS ARE 1/2"

3. 3/4" LETTERS ARE 1/8"

A WHITE REFLECTIVE

5. THE SIGNS ARE TO BE

BACKGROUND.

WIDE.

-BY ORDER OF THE

MESA FIRE CODE

3/4" <del>← |-</del> FIRE MARSHALL

FIRE SIGNAGE

1'-4"

ELEV.

AS1.03 SCALE: 3/4" = 1'-0"

TYP. @ END j

AS1.03 SCALE:  $1 \frac{1}{2}$ " = 1'-0"

1. 8" SMOOTH FACE CMU - SEE ELEVATIONS FOR COURSING AND PATTERN

2. 8" SPLIT FACE CMU - SEE ELEVATIONS FOR COURSING AND PATTERN. CONTINUE SPLIT FACE BLOCK ONE COURSE BELOW FINISH GRADE —

3. GRADE VARIES - SEE CIVIL DRAWINGS. 4. GROUT SOLID UP TO FINISH GRADE, TYPICAL. 5. CONCRETE FOOTING - SEE STRUCTURAL DRAWINGS. 6. CONCRETE CURB - SEE SITE PLAN AND CIVIL DRAWINGS.

7. ASPHALTIC CONCRETE OVER A.B.C. FILL - SEE CIVIL DRAWINGS. 8. 1/2" DIA. WEEP HOLES @ 2'-0" O.C. AS REQ'D FOR DRAINAGE - SEE CIVIL DRAWINGS. 9. 8" SPLIT FACE CMU ACCENT - SEE

ELEVATIONS FOR COURSING AND

PATTERN.

A. SEE STRUCTURAL FOR REINFORCING. SEE ELEVATION SHEETS FOR COLOR & FINISH DESIGNATIONS. THE HIGHER SECTION OF PARKING SCREEN WALL SHALL BE THE WALL

OFFSET CLOSEST TO THE STREETS.

1. 4" SPLIT FACE CMU CAP

FINISH GRADE - MIN.

TYPICAL.

SCREEN WALL AT TRUCK COURT

1. CMU PIER/SCREENWALL - SEE SITE PLAN. 2. 4"x4" TUBE STEEL POST - REFER TO STRUCTURAL FOR FOUNDATION. 24'-0" GATE WIDTH 3. 2"x4" TUBE STEEL FRAME - REFER TO STRUCTURAL VERIFY W/ MANUF'R 4. STEEL DECKING WELDED TO FRAME. 5. 3"x3" TUBE STEEL WEBS - REFER TO STRUCT. EQ EQ EQ 6. GRADE VARIES - REFER TO CIVIL DRAWINGS. GATE VERTICAL GATE VERTICAL GATE VERTICAL CONCRETE CURB - SEE SITE PLAN AND CIVIL SUPPORT SUPPORT DRAWINGS. 8. ASPHALTIC CONCRETE OVER A.B.C. FILL -REFER TO CIVIL DRAWINGS.

K 1

4. GROUT SOLID UP TO FINISH GRADE, 5. CONCRETE FOOTING - SEE

STRUCTURAL DRAWINGS. 6. CONCRETE CURB - SEE SITE PLAN AND CIVIL DRAWINGS. 7. ASPHALTIC CONCRETE OVER A.B.C. FILL SEE CIVIL DRAWINGS. 8. 1/2" DIA. WEEP HOLES @ 2'-0" O.C. AS REQ'D FOR DRAINAGE - SEE CIVIL

2. 8" SPLIT FACE CMU - CONTINUE SPLIT

FACE BLOCK ONE COURSE BELOW

3. GRADE VARIES - SEE CIVIL DRAWINGS.

A. SEE STRUCTURAL FOR REINFORCING. B. SEE ELEVATION SHEETS FOR COLOR & FINISH DESIGNATIONS.
THE HIGHER SECTION OF PARKING SCREEN WALL SHALL BE THE WALL OFFSET CLOSEST TO THE STREETS.


SPLIT FACE TO WRAP TO SIDES OF BLOCK AT BOTH ENDS OF WALL.

PARKING SCREEN WALL - SHORT SCALE: 3/4" = 1'-0"

PARKING SCREEN WALL - LONG

SECURITY SLIDING GATE - OPAQUE 3/16" = 1'-0"

SCALE: 3/16"=1'-0"

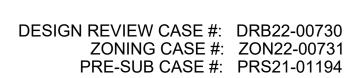



6225 North 24th Street, Suite 250 Phoenix, AZ 85016

## August 8, 2022

Re: Citizen Participation Plan
For: Greenfield Industrial

Case #: PRS21-01194 / ZON22-00734 / DRB22-00730

Prepared By: DLR Group

## Purpose:

The purpose of this Citizen Participation Plan is to inform the citizens, property owners, neighborhood associations, agencies, schools, and businesses in the vicinity of the site of an application for the Greenfield Industrial project. This site is located South of McDowell Road and West of Greenfield Road and is an application for Design Review Board Approval and Planning & Zoning Board / City Council Site Plan Approval. This plan will ensure that those affected by this application will have an adequate opportunity to learn about and comment on the proposal.

## Contact:

DLR Group Attn: Tim Thielke 6225 N 24<sup>th</sup> Street, Suite 250 Phoenix, AZ 85016 Phone (602) 794-2180 Email – tthielke@dlrgroup.com

**Pre-submittal Meeting:** The preapplication meeting with City of Mesa planning staff was held on December 16, 2021. Staff reviewed the application and recommended that adjacent property owners within 500 feet and registered Homeowners Associations be contacted.

**Action Plan:** In order to provide effective citizen participation in conjunction with their application, the following actions will be taken to provide opportunities to understand and address any real or perceived impacts from their development that members of the community may have.

- 1. A contact list will be developed for citizens and agencies in this area including
  - Property owners within 500 feet from site
  - Registered Homeowners Association within one half mile of the project
- 2. All persons listed on the contact list will receive a letter describing the project, project schedule, and siteplan.
- 3. Neighborhood Associations, Homeowners Associations and Neighbors within 500 feet of the site will be called by telephone to inform them personally of the project and receive comments (optional).
- Presentations will be made to groups of citizens or neighborhood associations upon request. [All materials such as sign-in lists, comments, and petitions received are copied to the City of Mesa]

**Greenfield Industrial** August 8th, 2022 Page 2

## Schedule:

Pre-application meeting – December 16, 2021
Formal Design Review Board Application Submittal – July 1, 2022
Design Review Board Hearing – September 28, 2022
Submittal of Citizen Participation Report and Notification materials – TBD Planning and Zoning Board Hearing - TBD

sta@tblaw.com



# Citizen Participation Report Hopewell Development – Greenfield Industrial ZON22-00731 October 31, 2022

## **Purpose**

The purpose of the Citizen Participation Report is to provide the City of Mesa staff with information regarding the Applicant's efforts to engage citizens and property owners in the vicinity concerning the Applicant's request to the City of Mesa for the submittal of a Rezoning, Site Plan Review, and Special Use Permit Application (Application #ZON22-00731) for an approximately 17.8-acre property generally located at the southwest corner of E. McDowell Road and N. Greenfield Road and known as Assessor Parcel Number 141-26-006E (the "Property"). The Application is requesting to develop the Property as an industrial development. More specifically the project request approval of the following from the City of Mesa:

- 1. Rezoning to remove conditions of approval for Zoning Case #Z80-047;
- 2. Site Plan review;
- 3. Design Review; and
- 4. Special Use Permit

By providing opportunities for citizen participation, the Applicant has ensured that those affected by this Application had an adequate opportunity to learn about and comment on the proposed industrial development project.

## **Contact Information**

The person coordinating the Citizen Participation activities was:

Shaine T. Alleman Tiffany & Bosco, P.A. 2525 East Camelback Road, 7<sup>th</sup> Floor Pheonix, Arizona 85016 602-452-2712 office 602-255-0103 fax sta@tblaw.com

## Actions

In order to provide effective citizen participation in conjunction with this Application, the following actions were taken to provide opportunities for feedback from surrounding property owners:



- 1. A contact list was developed for citizens and agencies in the area, including:
  - a. Property owners within 500 feet from the Property (for Design Review Board Notification)
  - b. Property owners within 1,000 feet from the Property
  - c. All registered Neighborhood Associations with 1 mile of the project
  - d. Homeowners Associations within ½ mile of the Property.
- 2. A neighborhood outreach letter was mailed on July 25, 2022 to all property owners within 1000' of the Property, City-registered Neighborhood Associations within 1 mile of the Property, and Homeowners Associations within ½ mile of the Property notifying neighbors of the Application. As a result of that notification letter, we received no responses from surrounding property owners and stakeholders.
- 3. After discussion with City staff, a neighborhood meeting was not required in connection with this Application.
- 4. Notice for the Design Review Board was mailed out to September 22, 2022. The notice was sent to all property owners within 500 feet of the subject property, registered neighborhood associations within 1 mile and Homeowner Associations within ½ mile of the Property were included. A copy of the notification letters for the public meetings is included with this Citizen Participation Report.
- 5. Notice for the Planning & Zoning Board hearing will be mailed on November 1, 2022 and sent to all property owners within 1,000 feet of the subject property, registered neighborhood associations within 1 mile and Homeowner Associations within ½ mile of the Property were included. A copy of the notification letters for the public meetings is included with this Citizen Participation Report.
- 6. For the public hearing notice, the Applicant posted a 4' x 4' sign on the Property at two (2) locations, as required. The signs were placed on the Property on October 31, 2022, two (2) weeks prior to the Planning & Zoning Board meeting. A notarized document with attached photograph of the sign is attached.

## Summary of Concerns, Issues and Problems and Resolutions

There were no major citizen concerns voiced throughout the process.



## Schedule

**Pre-Submittal Conference** December 16, 2021 Neighborhood Notification Letter Mailed July 25, 2022 September 22, 2022 Design Review Board Notification Letter Mailed Design Review Board Hearing October 11, 2022 P&Z/Council Hearing Notification Letter Mailed November 1, 2022 Public Hearing Notice Sign Posted October 31, 2022 Planning and Zoning Board Hearing November 16, 2022 City Council Introduction Hearing November 21, 2022 City Council Final Action Hearing December 1, 2022

## **Attached Exhibits**

- A. Combined notification list consisting of property owners within 1,000 feet from the Property, all registered neighborhood associations with 1 mile of the Property, and homeowners associations within ½ mile of the Property (for public outreach requirements).
- B. Map of property owners parcels within 1,000 feet of the Property.
- C. Neighborhood Notification Letter and Exhibits regarding proposed Application mailed on July 25, 2022.
- D. Neighborhood Notification Letter and Exhibits for notification of Design Review Board Public Hearing mailed on September 22, 2022.
- E. Neighborhood Notification Letter and Exhibits for notification of Public Hearing (P&Z and City Council) mailed on November 1, 2022.
- F. Public Notice Sign Posting Affidavit for sign posted on October 31, 2022.

If you have any questions, please feel free to contact me at (602) 452-2712 or at sta@tblaw.com.

Sincerely,

Shaine T. Alleman

## 1000' Neighborhood Notification List

# **Exhibit A**

Parcel Number	Owner	MAIL_ADDR1	MAIL_CITY	MAI	MAIL_ZIP
141-25-008A	JHJ OMAHA LLC	PO BOX 7043	CAVE CREEK	AZ 8	85237
141-25-009A	CARUFEL PROPERTIES V LLC	6532 E RUSTIC DR	MESA	AZ 8	85215
141-25-079A	WAX PROPERTIES LTD	PO BOX 23506	SAN DIEGO	CA S	92193
141-25-079B	COMMONS INDUSTRIAL PARK AT FALCON VIEW ASSOC	C 2812 N NORWALK 105	MESA	AZ 8	85215
141-25-103A	WAX PROPERTIES LTD	PO BOX 23506	SAN DIEGO	CA S	92193
141-25-139	ALLIED FIRE PROPERTIES LLC	2845 N NORFOLK	MESA	AZ 8	85215
141-25-140	REEB CAPITAL I LLC	2812 N NORWALK STE 105	MESA	AZ 8	85215
141-25-141	OX ENTERPRISES LLC	1455 E MAGNUM RD	QUEEN CREEK	AZ 8	85140
141-25-151	PKM REAL ESTATE COMPANY II LLC	300 E 48TH ST	HOLLAND	MI 4	49423
141-25-187	D L HUBER HOLDING LLC	204 ENNISMORE LN	BRENTWOOD	TN 3	37027
141-25-188	REAL ESTATE HOLDINGS GROUP LLC	32531 N SCOTTSDALE RD	SCOTTSDALE	AZ 8	85266
141-25-189	BALLANTYNE OMAHA 2848 LLC	2848 N OMAHA	MESA	AZ 8	85215
141-25-192	STEPHEN M JAVINETT LIVING TRUST	2962 N NORFOLK	MESA	AZ 8	85215
141-25-193	STEPHEN M JAVINETT LIVING TRUST	2962 N NORFOLK	MESA	AZ 8	85215
141-25-209	MESA AIRPARK INVESTMENTS LLC	PO BOX 6128	MESA	AZ 8	85216
141-25-210	CHIN ALEX W/JACK C/REBECCA J	1847 E MERLOT ST	GILBERT	AZ 8	85298
141-25-211	CESARS FLOORING COVERING INC	2942 N GREENFIELD RD SUITE 141	MESA	AZ 8	85215
141-25-212	LUNA FAMILY LLLP	2764 E LAUREL ST	MESA	AZ 8	85213
141-25-213	RSDMK HOLDINGS LLC	3810 E. KNOLL ST.	MESA	AZ 8	85215
141-25-214	RSDMK HOLDINGS LLC	3810 E. KNOLL ST.	MESA	AZ 8	85215
141-25-215	PAOLA AND JEFF SCARBERRY LIVING TRUST	5345 E MCLELLAN RD UNIT 21	MESA	AZ 8	85205
141-25-216	EPIC INVESTMENTS LIMITED PARTNERSHIP	10040 E HAPPY VALLEY RD UNIT 347	SCOTTSDALE	AZ 8	85255
141-25-227	GREENFIELD AIRPARK LLC	7689 E PARADISE LN STE 7	SCOTTSDALE	AZ 8	85260
141-25-285	ALLEGRETTI & COMPANY	20555 DEVONSHIRE ST UNIT 375	CHATSWORTH	CA S	91311
141-25-286	GB HOLDING COMPANY LLC	7009 E IVYGLEN ST	MESA	AZ 8	85207
141-26-001A	MESA CITY OF	20 E MAIN ST STE 650	MESA	AZ 8	85211
141-26-004	MESA CITY OF	20 E MAIN ST STE 650	MESA	AZ 8	85211
141-26-006D	MESA CITY OF	20 E MAIN ST STE 650	MESA	AZ 8	85211
141-26-006E	OTTOSEN DONALD R TR	105 S 28TH ST	PHOENIX	AZ 8	85034
141-26-007	MESA CITY OF	20 E MAIN ST STE 650	MESA	AZ 8	85211
141-26-009	BKM MESA RIDGE 913 LLC	1701 QUAIL ST STE 100	NEWPORT BEACH	ICA S	92660
141-26-010	BKM MESA RIDGE 913 LLC	1701 QUAIL ST STE 100	NEWPORT BEACH	ICA 9	92660
141-26-011A	AZ COLLECTOR CARS LLC	2401 W BELL RD	PHOENIX	AZ 8	85023
141-26-012A	VENTURE WALK ARIZONA LLC	3216 GREY HAWK CT	CARLSBAD	CA S	92010

## 1000' Neighborhood Notification List

141-26-013A	EWING IRRIGATION PRODUCTS INC	3441 E HARBOUR DR	PHOENIX	ΑZ	85034
141-26-014	FLATHERS FAMILY HOLDINGS INC	20292 E ACRE PL	ORANGE	CA	92869
141-26-015	TWELVE FORTY-NINE LLC	16009 E CHOLLA DR	FOUNTAIN HILLS	ΑZ	85268
141-26-016	J&R REPAIR SERVICE OF ARIZONA LLC	29236 N RED FINCH DR	SAN TAN VALLEY	ΑZ	85143
141-26-017	BKM MESA RIDGE 913 LLC	1701 QUAIL ST STE 100	NEWPORT BEAC	НСА	92660
141-26-018	BKM MESA RIDGE 913 LLC	1701 QUAIL ST STE 100	NEWPORT BEAC	НСА	92660
141-26-019	BKM MESA RIDGE 913 LLC	1701 QUAIL ST STE 100	NEWPORT BEAC	НСА	92660
141-26-020	BKM MESA RIDGE 913 LLC	1701 QUAIL ST STE 100	NEWPORT BEAC	НСА	92660
141-26-024	GRANT PROPERTIES INC	1004 W TAFT AVE STE 150	ORANGE	CA	92865
141-26-025	TWELVE FORTY NINE LLC	16009 E CHOLLA DR	FOUNTAIN HILLS	ΑZ	85268
141-26-026	TRUCK TOWN INC/GRANT PROPERTIES INC	1004 W TAFT AVE STE 150	ORANGE	CA	92865
141-26-087	KRUPNIK RICHARD L	4148 E NORA CIR	MESA	ΑZ	85215
141-26-088	STRATTON FAMILY LIVING TRUST	4130 E NORA CIR	MESA	ΑZ	85215
141-26-091	JONES JAMES H/BETTE R	4135 E NORA CIR	MESA	ΑZ	85215
141-26-092	MARKELL AND ANNELISSA STAFFIERI 2013 FAMILY TRU	J: 4153 E NORA CIR	MESA	ΑZ	85215
141-26-093	CORMIER ERLENE HELEN	4152 E NORTHRIDGE CIR	MESA	ΑZ	85215
141-26-094	LEYBOVICH BENJAMIN/PATRISHA AFTON	4134 E NORTHRIDGE CIR	MESA	ΑZ	85215
141-26-097	WEISER STEVEN JOE/KRISTA CHARLENE	4133 E NORTHRIDGE CIR	MESA	ΑZ	85215
141-26-098	DEHAVEN TERRESSA G/BRAD	4151 E NORTHRIDGE CIR	MESA	ΑZ	85215
141-26-099	FIERRO TROY/DARCY	4150 E NORCROFT CIR	MESA	ΑZ	85215
141-26-100	HARRISON JOHN/BRENNAN HEIDI A	4132 E NORCROFT CIR	MESA	ΑZ	85215
141-26-103	ROFF MARGARET/KEVIN	4135 E NORCROFT CIR	MESA	ΑZ	85215
141-26-104	PRICE KEITH R	4157 E NORCROFT CIR	MESA	ΑZ	85215
141-26-106	ESTATES ON MCDOWELL COMMUNITY ASSOCIATION	4645 E COTTON GIN LOOP	PHOENIX	ΑZ	85040
141-26-107	ESTATES ON MCDOWELL COMMUNITY ASSOCIATION	4645 E COTTON GIN LOOP	PHOENIX	ΑZ	85040
141-26-108	ESTATES ON MCDOWELL COMMUNITY ASSOCIATION	4645 E COTTON GIN LOOP	PHOENIX	ΑZ	85040
141-36-001E	MESA CITY OF	20 E MAIN ST STE 650	MESA	ΑZ	85211
141-36-004	REILLY AVIATION LLC (LEASE)	4165 W WINTERWASH DR	TUCSON	ΑZ	85745
141-36-005	REILLY AVIATION LLC (LEASE)	4165 W WINTERWASH DR	TUCSON	ΑZ	85745
141-36-006	REILLY AVIATION LLC (LEASE)	4165 W WINTERWASH DR	TUCSON	ΑZ	85745
141-36-007	REILLY AVIATION LLC (LEASE)	4165 W WINTERWASH DR	TUCSON	ΑZ	85745
141-36-008	REILLY AVIATION LLC (LEASE)	4165 W WINTERWASH DR	TUCSON	ΑZ	85745
141-36-009	REILLY AVIATION LLC (LEASE)	4165 W WINTERWASH DR	TUCSON	ΑZ	85745
141-36-010	TRENDSTAR LLC	2541 E UNIVERSITY DR	PHOENIX	ΑZ	85034
141-36-011	REILLY AVIATION LLC (LEASE)	4165 W WINTERWASH DR	TUCSON	ΑZ	85745

### 1000' Neighborhood Notification List

444 26 242	LACKAAACIIC	44.CE \44.\4/\A/INITED\4/4.CH DD	THECON	47 05745
141-36-012	JACKMAC LLC	4165 W WINTERWASH DR	TUCSON	AZ 85745
141-36-013	REILLY AVIATION LLC (LEASE)	4165 W WINTERWASH DR	TUCSON	AZ 85745
141-36-014	REILLY AVIATION LLC (LEASE)	4165 W WINTERWASH DR	TUCSON	AZ 85745
141-36-015	REILLY AVIATION LLC (LEASE)	4165 W WINTERWASH DR	TUCSON	AZ 85745
141-36-016	REILLY AVIATION LLC (LEASE)	4165 W WINTERWASH DR	TUCSON	AZ 85745
141-36-017	REILLY AVIATION LLC (LEASE)	4165 W WINTERWASH DR	TUCSON	AZ 85745
141-36-018	REILLY AVIATION LLC (LEASE)	4165 W WINTERWASH DR	TUCSON	AZ 85745
141-36-019	REILLY AVIATION LLC (LEASE)	4165 W WINTERWASH DR	TUCSON	AZ 85745
141-36-020	REILLY AVIATION LLC (LEASE)	4165 W WINTERWASH DR	TUCSON	AZ 85745
141-36-021	REILLY AVIATION LLC (LEASE)	4165 W WINTERWASH DR	TUCSON	AZ 85745
141-36-022	REILLY AVIATION LLC (LEASE)	4165 W WINTERWASH DR	TUCSON	AZ 85745
141-36-023	REILLY AVIATION LLC (LEASE)	4165 W WINTERWASH DR	TUCSON	AZ 85745
141-36-024	HATFIELD DERIK/RACHEL LEASE	7842 E WILLETTA ST	MESA	AZ 85207
141-36-025	REILLY AVIATION LLC (LEASE)	4165 W WINTERWASH DR	TUCSON	AZ 85745
141-36-026	DISIVESTRO RAYMOND F JR	3540 E AMELIA	PHOENIX	AZ 85018
141-36-027	REILLY AVIATION LLC (LEASE)	4165 W WINTERWASH DR	TUCSON	AZ 85745
141-36-028	REILLY AVIATION LLC (LEASE)	4165 W WINTERWASH DR	TUCSON	AZ 85745
141-36-029	REILLY AVIATION LLC (LEASE)	4165 W WINTERWASH DR	TUCSON	AZ 85745
141-36-030	REILLY AVIATION LLC (LEASE)	4165 W WINTERWASH DR	TUCSON	AZ 85745
141-36-031	REILLY AVIATION LLC (LEASE)	4165 W WINTERWASH DR	TUCSON	AZ 85745
141-36-032	REILLY AVIATION LLC (LEASE)	4165 W WINTERWASH DR	TUCSON	AZ 85745
141-36-033	REILLY AVIATION LLC (LEASE)	4165 W WINTERWASH DR	TUCSON	AZ 85745
141-36-034	REILLY AVIATION LLC (LEASE)	4165 W WINTERWASH DR	TUCSON	AZ 85745
141-36-035	KIM & BARRY'S BUILDING LLC (LEASE)	2711 N 24TH ST	PHOENIX	AZ 85008
141-36-036	REILLY AVIATION LLC (LEASE)	4165 W WINTERWASH DR	TUCSON	AZ 85745
141-36-037	WAGNON JOSEPH/LADEGARD JILLIAN	201 E KEIM DR	PHOENIX	AZ 85012
141-36-038	REILLY AVIATION LLC (LEASE)	4165 W WINTERWASH DR	TUCSON	AZ 85745
141-36-039	REILLY AVIATION LLC (LEASE)	4165 W WINTERWASH DR	TUCSON	AZ 85745
141-36-040	REILLY AVIATION LLC (LEASE)	4165 W WINTERWASH DR	TUCSON	AZ 85745
141-36-041	REILLY AVIATION LLC (LEASE)	4165 W WINTERWASH DR	TUCSON	AZ 85745
141-36-042	REILLY AVIATION LLC (LEASE)	4165 W WINTERWASH DR	TUCSON	AZ 85745
141-36-043	REILLY AVIATION LLC (LEASE)	4165 W WINTERWASH DR	TUCSON	AZ 85745
141-36-044	REILLY AVIATION LLC (LEASE)	4165 W WINTERWASH DR	TUCSON	AZ 85745
141-36-045	REILLY AVIATION LLC (LEASE)	4165 W WINTERWASH DR	TUCSON	AZ 85745
141-37-009G	SRPAI&PD	PO BOX 52025	PHOENIX	AZ 85072

141-37-009K BOEING COMPANY 5000 E MCDOWELL RD MC M 541-F118 MESA AZ 85215

Registered Neighborhoods and City of Mesa								
HOA Name	First Name	Mail Address	City	State	Zip			
SOMERSET ESTATES	Larry Tyler	3821 E PALM CIR	MESA	AZ	85207			
HERMOSA GROVES NORTH COMMUNITY ASSOCIATION	Dustin Snow	4135 S Power Rd SUITE 122	MESA	ΑZ	85212			
ROSEWOOD ESTATES COMMUNITY ASSOCIATION	Bob Brown	7255 E HAMPTON AVE SUITE 101	MESA	ΑZ	85209			
SOMERSET ESTATES HOMEOWNERS ASSOCIATION	HEYWOOD REALTY AND INVESTMENT	42 S. HAMILTON PL. SUITE 101	GILBERT	ΑZ	85233			
SPYGLASS ESTATES HOMEOWNERS ASSOCIATION, NO. 1	Amanda Brown	3802 N. 53rd Avenue Suite 140	PHOENIX	ΑZ	85031			
VILLA TUSCANO HOMEOWNERS ASSOCIATION	DAVID M DAY	2011 N Lemon St	MESA	ΑZ	85215			
VISTA ESTANCIA HOMEOWNERS ASSOCIATION, INC.	HEYWOOD REALTY AND INVESTMENT	42 S. HAMILTON PL. SUITE 101	GILBERT	ΑZ	85233			
MONTANA DORADA HOMEOWNERS ASSOCIATION, INC.	Cornerstone Property Services	4360 E Brown Road Suite 108	MESA	ΑZ	85205			


### ACC LINK

https://ecorp.azcc.gov/PublicBusinessSearch/PublicBusinessInfo?entityNumber=08963333
https://ecorp.azcc.gov/PublicBusinessSearch/PublicBusinessInfo?entityNumber=10835609
https://ecorp.azcc.gov/PublicBusinessSearch/PublicBusinessInfo?entityNumber=07433811
https://ecorp.azcc.gov/PublicBusinessSearch/PublicBusinessInfo?entityNumber=01848439
https://ecorp.azcc.gov/PublicBusinessSearch/PublicBusinessInfo?entityNumber=10895939
https://ecorp.azcc.gov/PublicBusinessSearch/PublicBusinessInfo?entityNumber=09460713
https://ecorp.azcc.gov/PublicBusinessSearch/PublicBusinessInfo?entityNumber=09787940



**EXHIBIT B** 



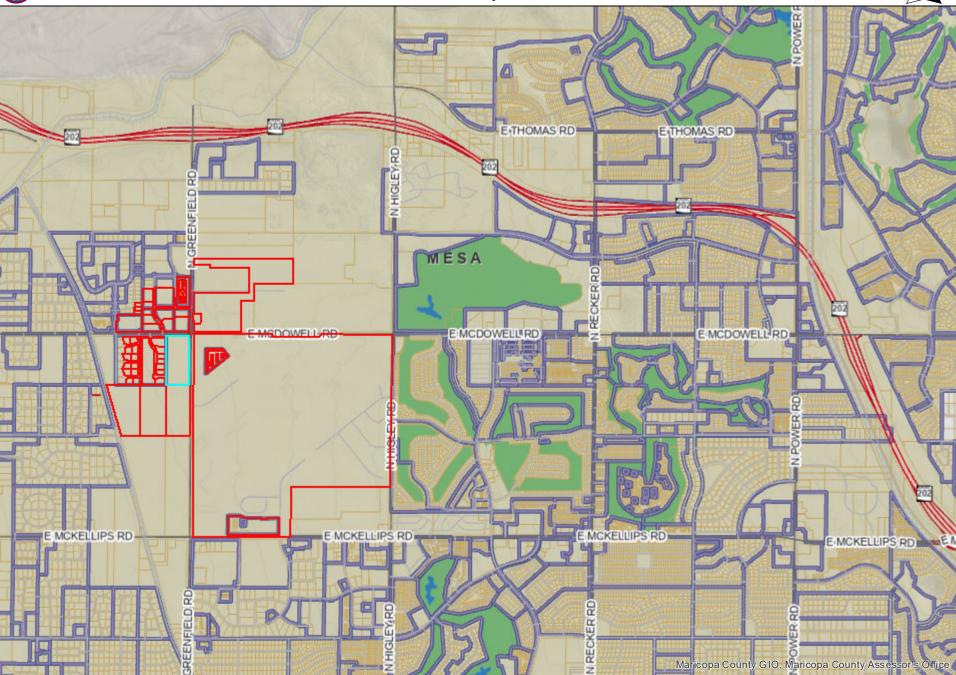





DLR Group inc. an Arizona corporation

6225 North 24th Street, Suite 250 Phoenix, AZ 85016

July 25, 2022

Re: Citizen Participation Notification

For: Greenfield Industrial

Case #: Z0N22-00734 / DRB22-00730

Prepared By: DLR Group

Dear Neighbor,

We have applied for **Design Review** and **Site Plan Review** for the property located at the SWC of McDowell Road and Greenfield Road. This request is for development of a new industrial project with three buildings totaling 278,850 sf of building area on 16.58 acres of vacant land. The case numbers assigned to this project are **DRB22-00730** and **ZON22-00734**.

This letter is being sent to all property owners within 1,000 feet of the property and registered HOA's at the request of the City of Mesa Planning Division. Enclosed for your review is a copy of the site plan and elevations of the proposed development. If you have any questions regarding this proposal, please call me at 602-381-8580 or e-mail me at tthielke@dlrgroup.com.

The **Design Review Board application** (Case #DRB22-00730) will be scheduled for consideration by the Mesa Design Review Board at their meeting held on September 13, 2022 in the Lower Level of the City Council Chambers. The meeting will begin at 4:30 p.m.

The public can attend the meeting either in-person or electronically and telephonically. The live meeting may be listened to by calling 888-788-0099 or 877-853-5247 (toll free) using meeting ID 530 123 2921 and following the prompts.

Public participation will be available electronically and telephonically. If you want to provide a written comment or speak telephonically at the meeting, please submit an **online comment card** at <a href="https://www.mesaaz.gov/government/advisory-boards-committees/board-of-adjustment/online-meeting-comment-card">https://www.mesaaz.gov/government/advisory-boards-committees/board-of-adjustment/online-meeting-comment-card</a> at **least 1 hour prior to the start of the meeting.** If you want to speak at the meeting, you will need to indicate on the comment card that you would like to speak during the meeting, and you will need to call **888-788-0099** or **877-853-5247** (toll free) using meeting ID **530 123 2921** and following the prompts, prior to the start of the meeting. You will be able to listen to the meeting; and when the item you have indicated that you want to speak on is before the Board, your line will be taken off mute and you will be given an opportunity to speak.

For help with the online comment card, or for any other technical difficulties, please call 480-644-2099.

The **Planning and Zoning application** for Site Plan Review (Case #ZON22-00734) will be scheduled for consideration by the Planning and ZOning Board at their meeting held on September 28, 2022 in the Upper Level of the City Council Chambers. The meeting will begin at 4:00 p.m.

The public can attend the meeting either in-person or electronically and telephonically. The live meeting may be listened to by calling 888-788-0099 or 877-853-5247 (toll free) using meeting ID 530 123 2921 and following the prompts. The meetings may also be watched on local cable Mesa channel 11, online at Mesa11.com/live or <a href="https://mesa11.zoom.us/j/5301232921">https://mesa11.zoom.us/j/5301232921</a>

Public participation will be available electronically and telephonically. If you want to provide a written comment or speak telephonically at the meeting, please submit an **online comment card** at <a href="https://www.mesaaz.gov/government/advisory-boards-committees/board-of-adjustment/online-meeting-comment-card">https://www.mesaaz.gov/government/advisory-boards-committees/board-of-adjustment/online-meeting-comment-card</a> at **least 1 hour prior to the start of the meeting.** If you want to speak at the meeting, you will need to indicate on the comment card that you would like to speak during the meeting, and you will need to call **888-788-0099** or **877-853-5247** (toll free) using meeting ID **530 123 2921** and following the prompts, prior to the start of the meeting. You will be able to listen to the meeting; and when the item you have indicated that you want to speak on is before the Board, your line will be taken off mute and you will be given an opportunity to speak.

For help with the online comment card, or for any other technical difficulties, please call 480-644-2099.


The City of Mesa has assigned this case to Robert Mansolillo of their Planning Division staff. He can be reached at 480-644-3952 or Robert.mansolillo@mesaaz.gov should you have any questions regarding the public hearing process. If you have sold this property in the interim, please forward this correspondence to the new owner.

Sincerely, Tim Thielke, AIA DLR Group


(Project Number) 30-22167-00


PROPERTIES
WITHIN 500 FT
PLAN


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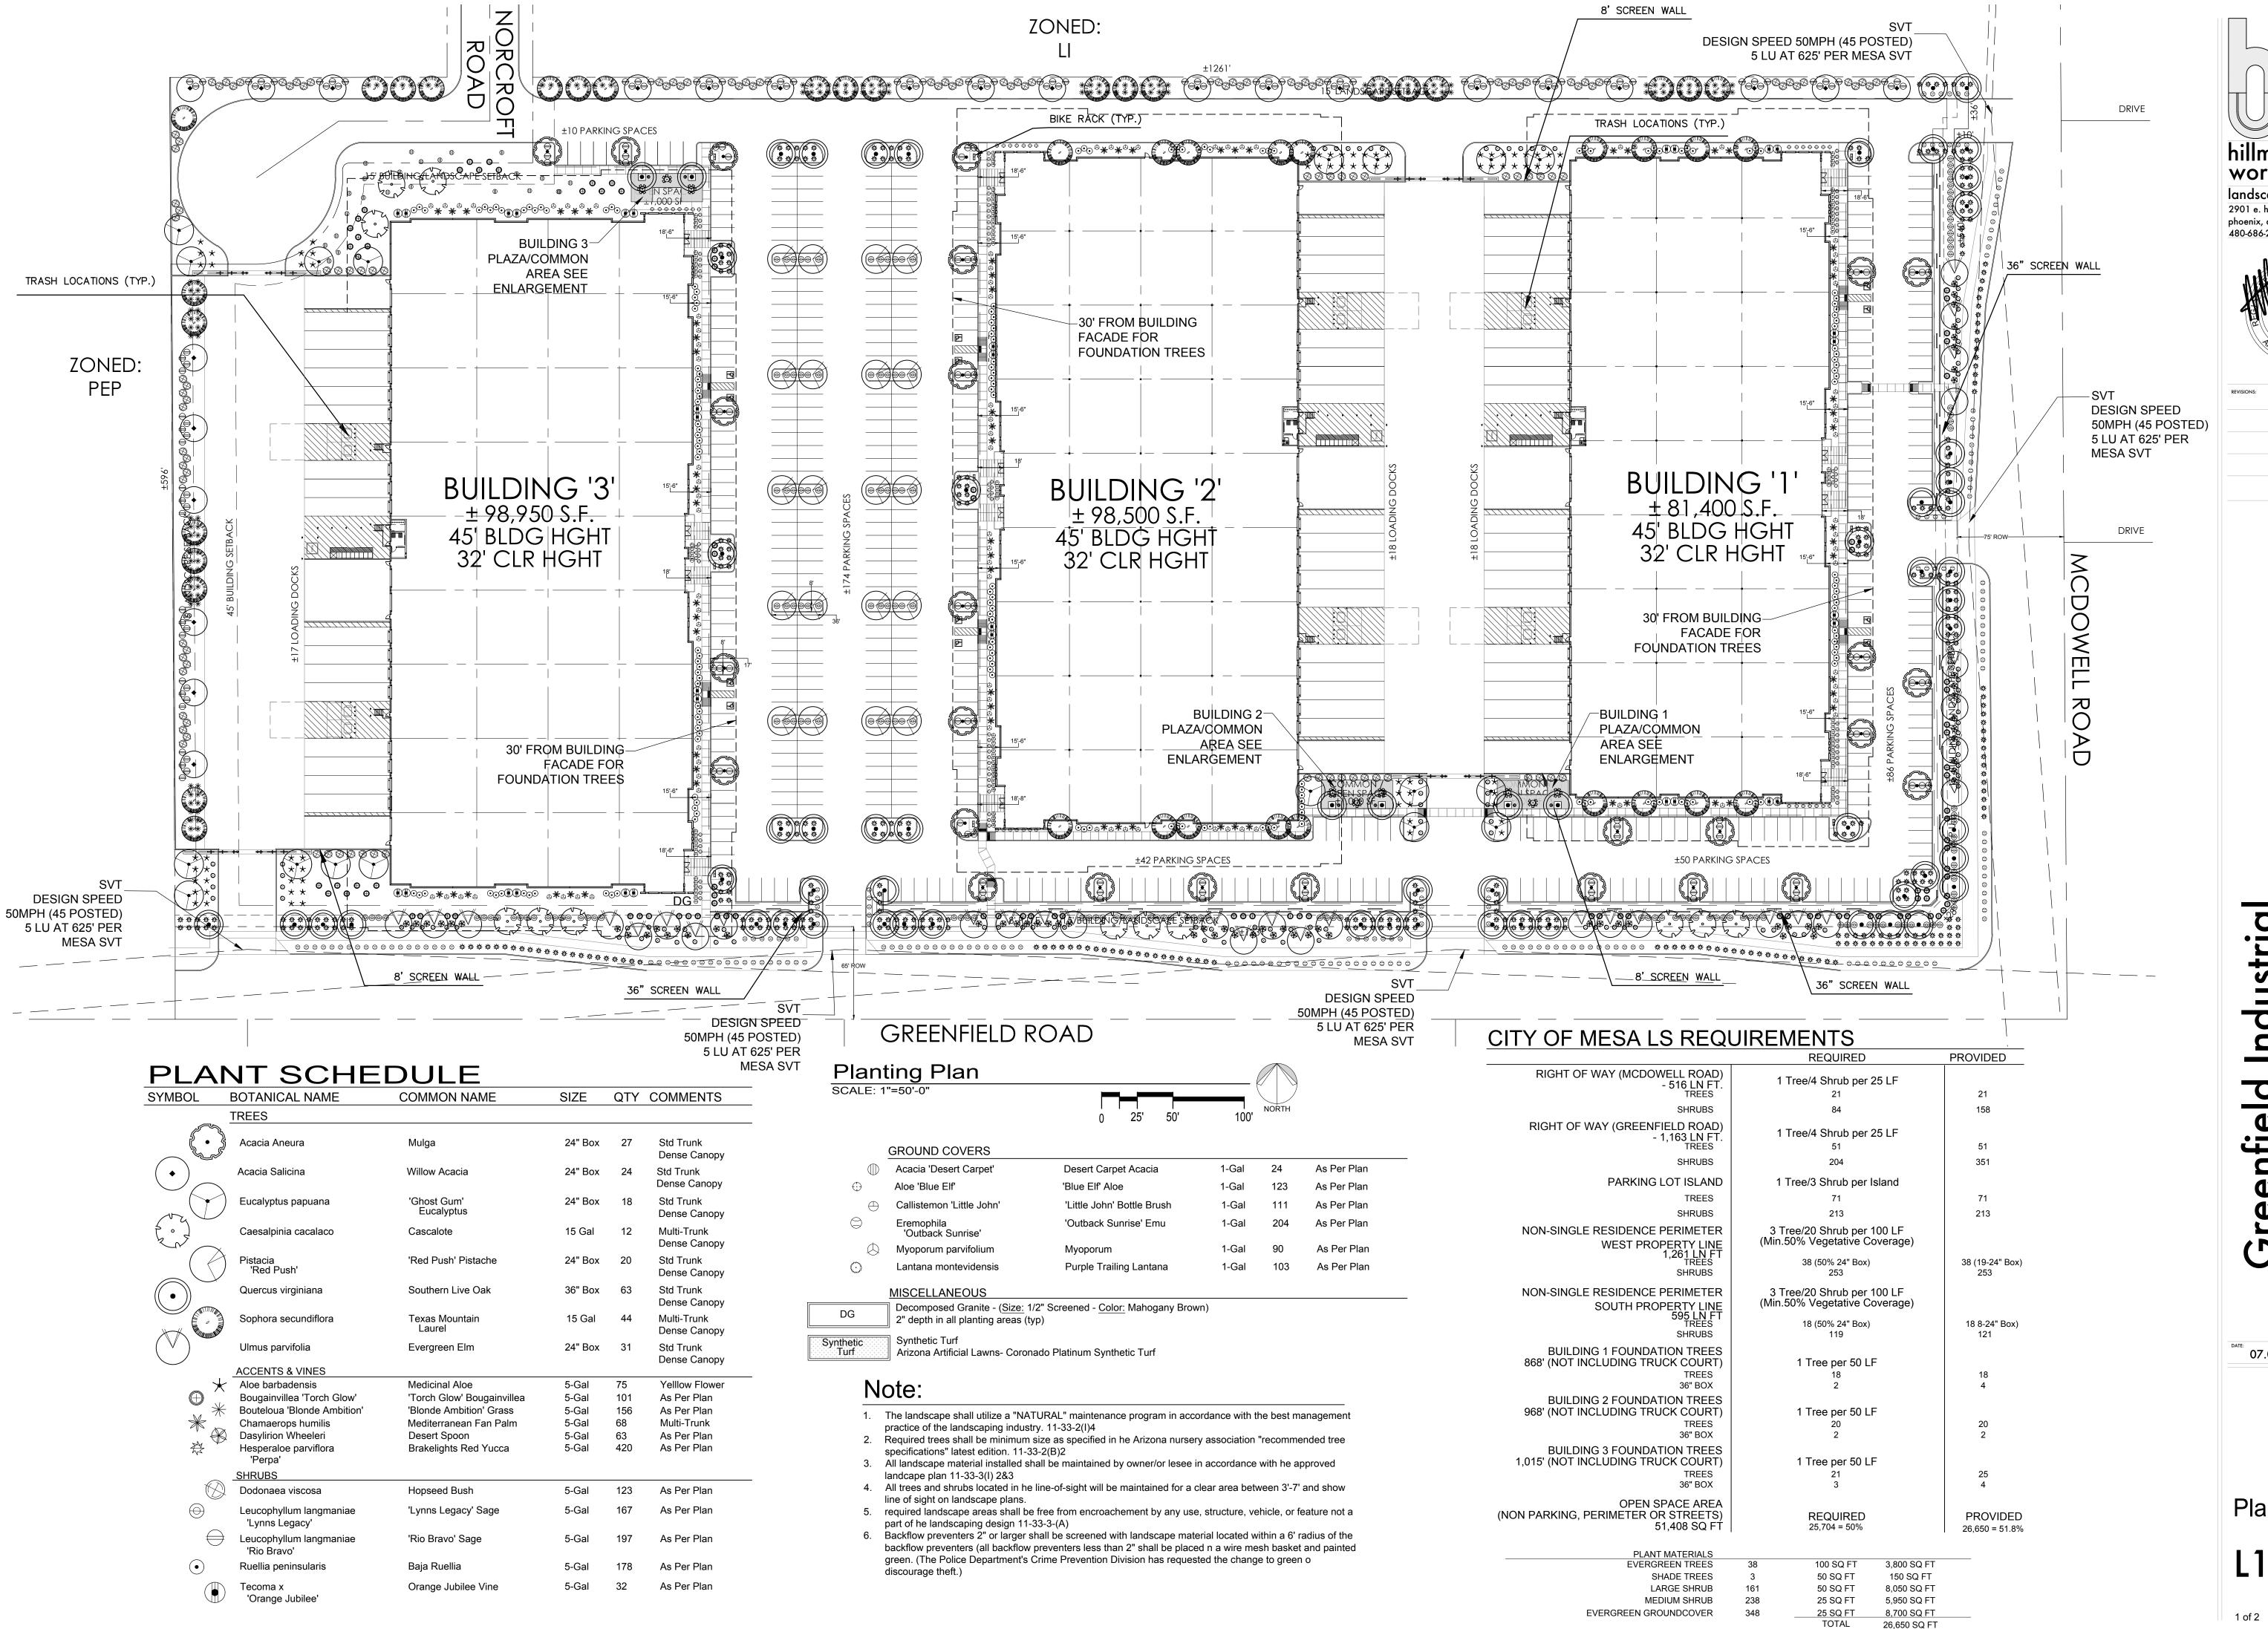


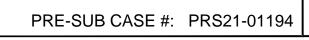**KEY PLAN** 



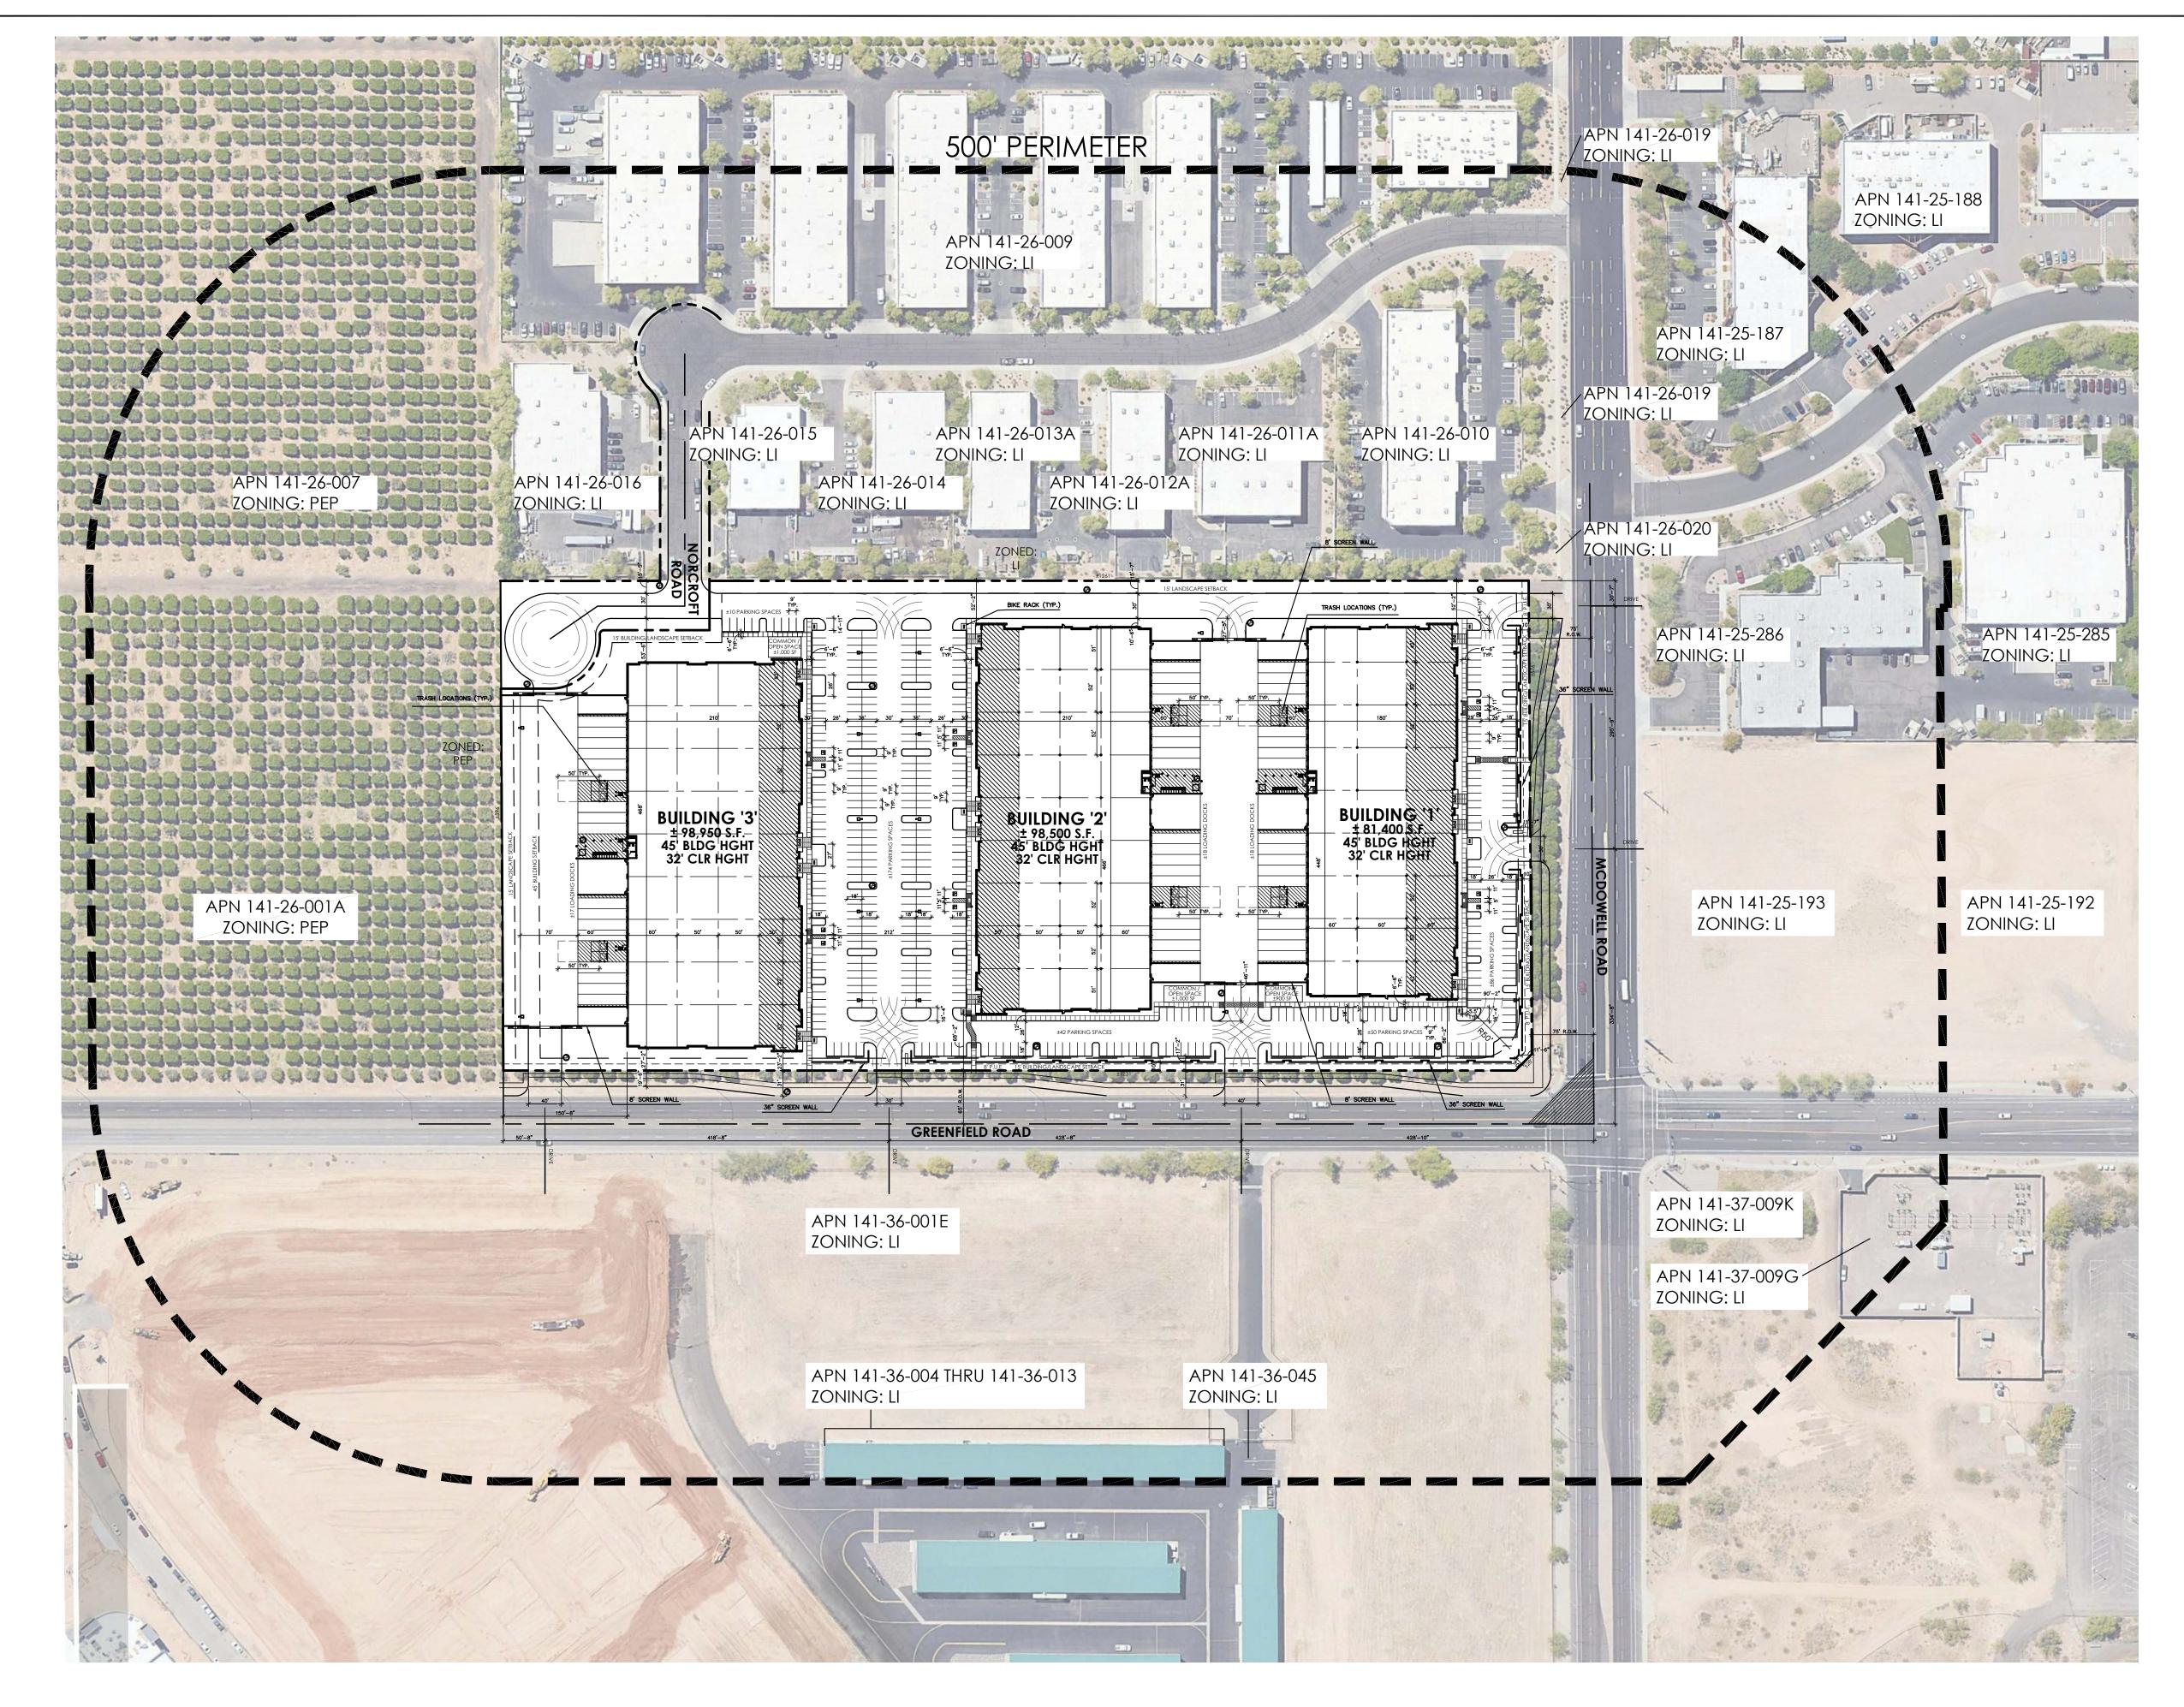

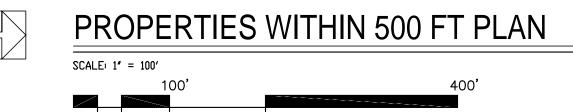

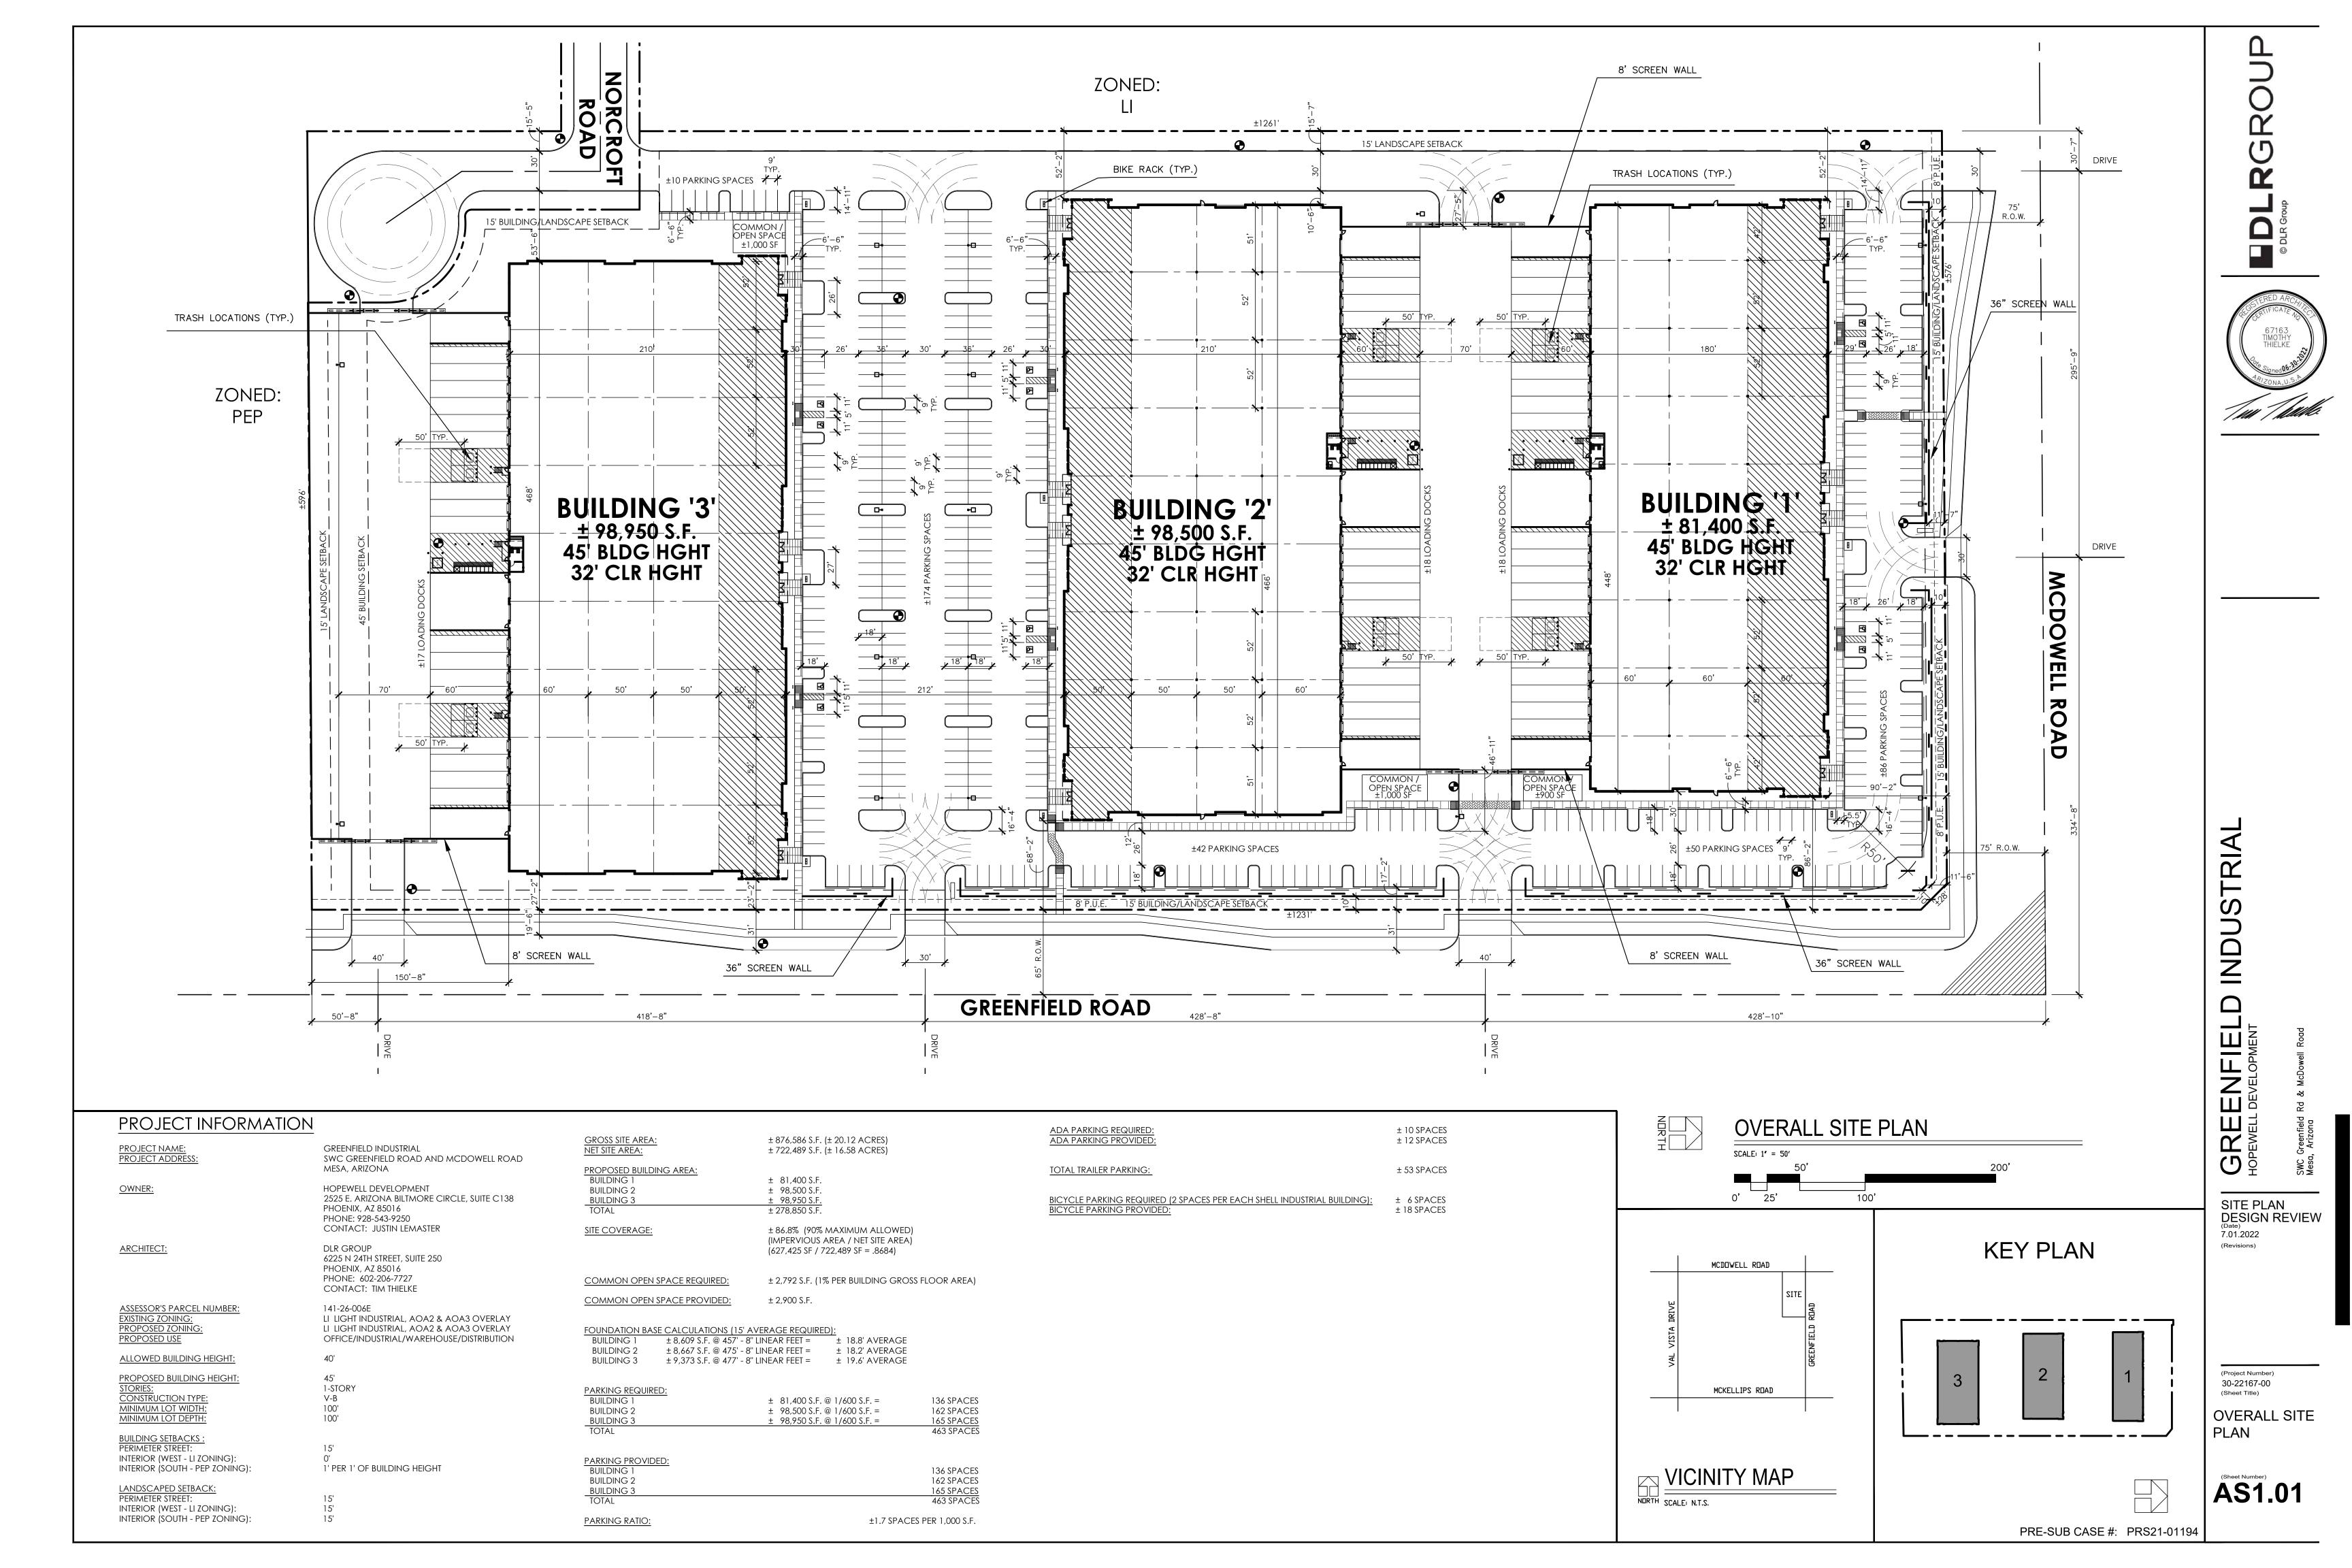

hillman workshop landscape architecture 2901 e. highland ave phoenix, az 85016 480-686-2001



EXPIRES 09/30/22

stri 0 enfi

07.01.22

Planting Plan





SITE PLAN DESIGN REVIEW 7.01.2022 (Revisions)

(Project Number) 30-22167-00 (Sheet Title)

BUILDING 1 COLOR RENDERING

A4.03C



BUILDING 1 - COLOR RENDERING

SCALE: N.T.S.





Shaine T. Alleman Attorney at Law 602.452.2712 sta@tblaw.com

September 22, 2022

RE: Hopewell Development; 4329 E. McDowell Road, Mesa, Arizona 85215 Design Review Board Hearing (DRB22-00730)

Dear Neighbor,

We have applied for a Design Review Application for the property located at 4329 E. McDowell Road, Mesa 85215. As part of this request, we are required to be heard and reviewed by the City of Mesa Design Review Board. This request is for development of a light industrial use. The case number assigned to this project is DRB22-00730.

This letter is being sent to all property owners within 500 feet of the property at the request of the City of Mesa Planning Division. Enclosed for your review is a copy of the site plan and elevations of the proposed development. If you have any questions regarding this proposal, please call me at 602-452-2712 or e-mail me at sta@tblaw.com.


This application will be scheduled for consideration by the Mesa Design Review Board at its meeting held on October 11th, 2022 in the City Council Chambers at 57 East First Street. The meeting will begin at 4:30 p.m. You are invited to attend this meeting and provide any input you may have regarding this proposal.

The public can attend the meeting either in-person or electronically and telephonically. The live meeting may be watched on local cable Mesa channel 11, online at Mesa11.com/live www.youtube.com/user/cityofmesa11/live, or listened to by calling 888-788-0099 or 877-853-5247 (toll free) using meeting ID 530 123 2921 and following the prompts. If you want to provide a written comment or speak telephonically at the meeting, please submit an online comment card by scanning the QR code below or visiting https://www.mesaaz.gov/government/advisory-boardscommittees/board-of-adjustment/online-meeting-comment-card at least 1 hour prior to the start of the meeting. If you want to speak at the meeting, you will need to indicate on the comment card that you would like to speak during the meeting, and you will need to call 888-788-0099 or 877-853-5247 (toll free) using meeting ID 530 123 2921 and following the prompts, prior to the start of the meeting. You will be able to listen to the meeting; and when the item you have indicated that you want to speak on is before the Board, your line will be taken off mute and you will be given an opportunity to speak.

For help with the online comment card, or for any other technical difficulties, please call 480-644-2099.

correspondence to the new owner. \_\_Sincerely,

Shaine T. Alleman

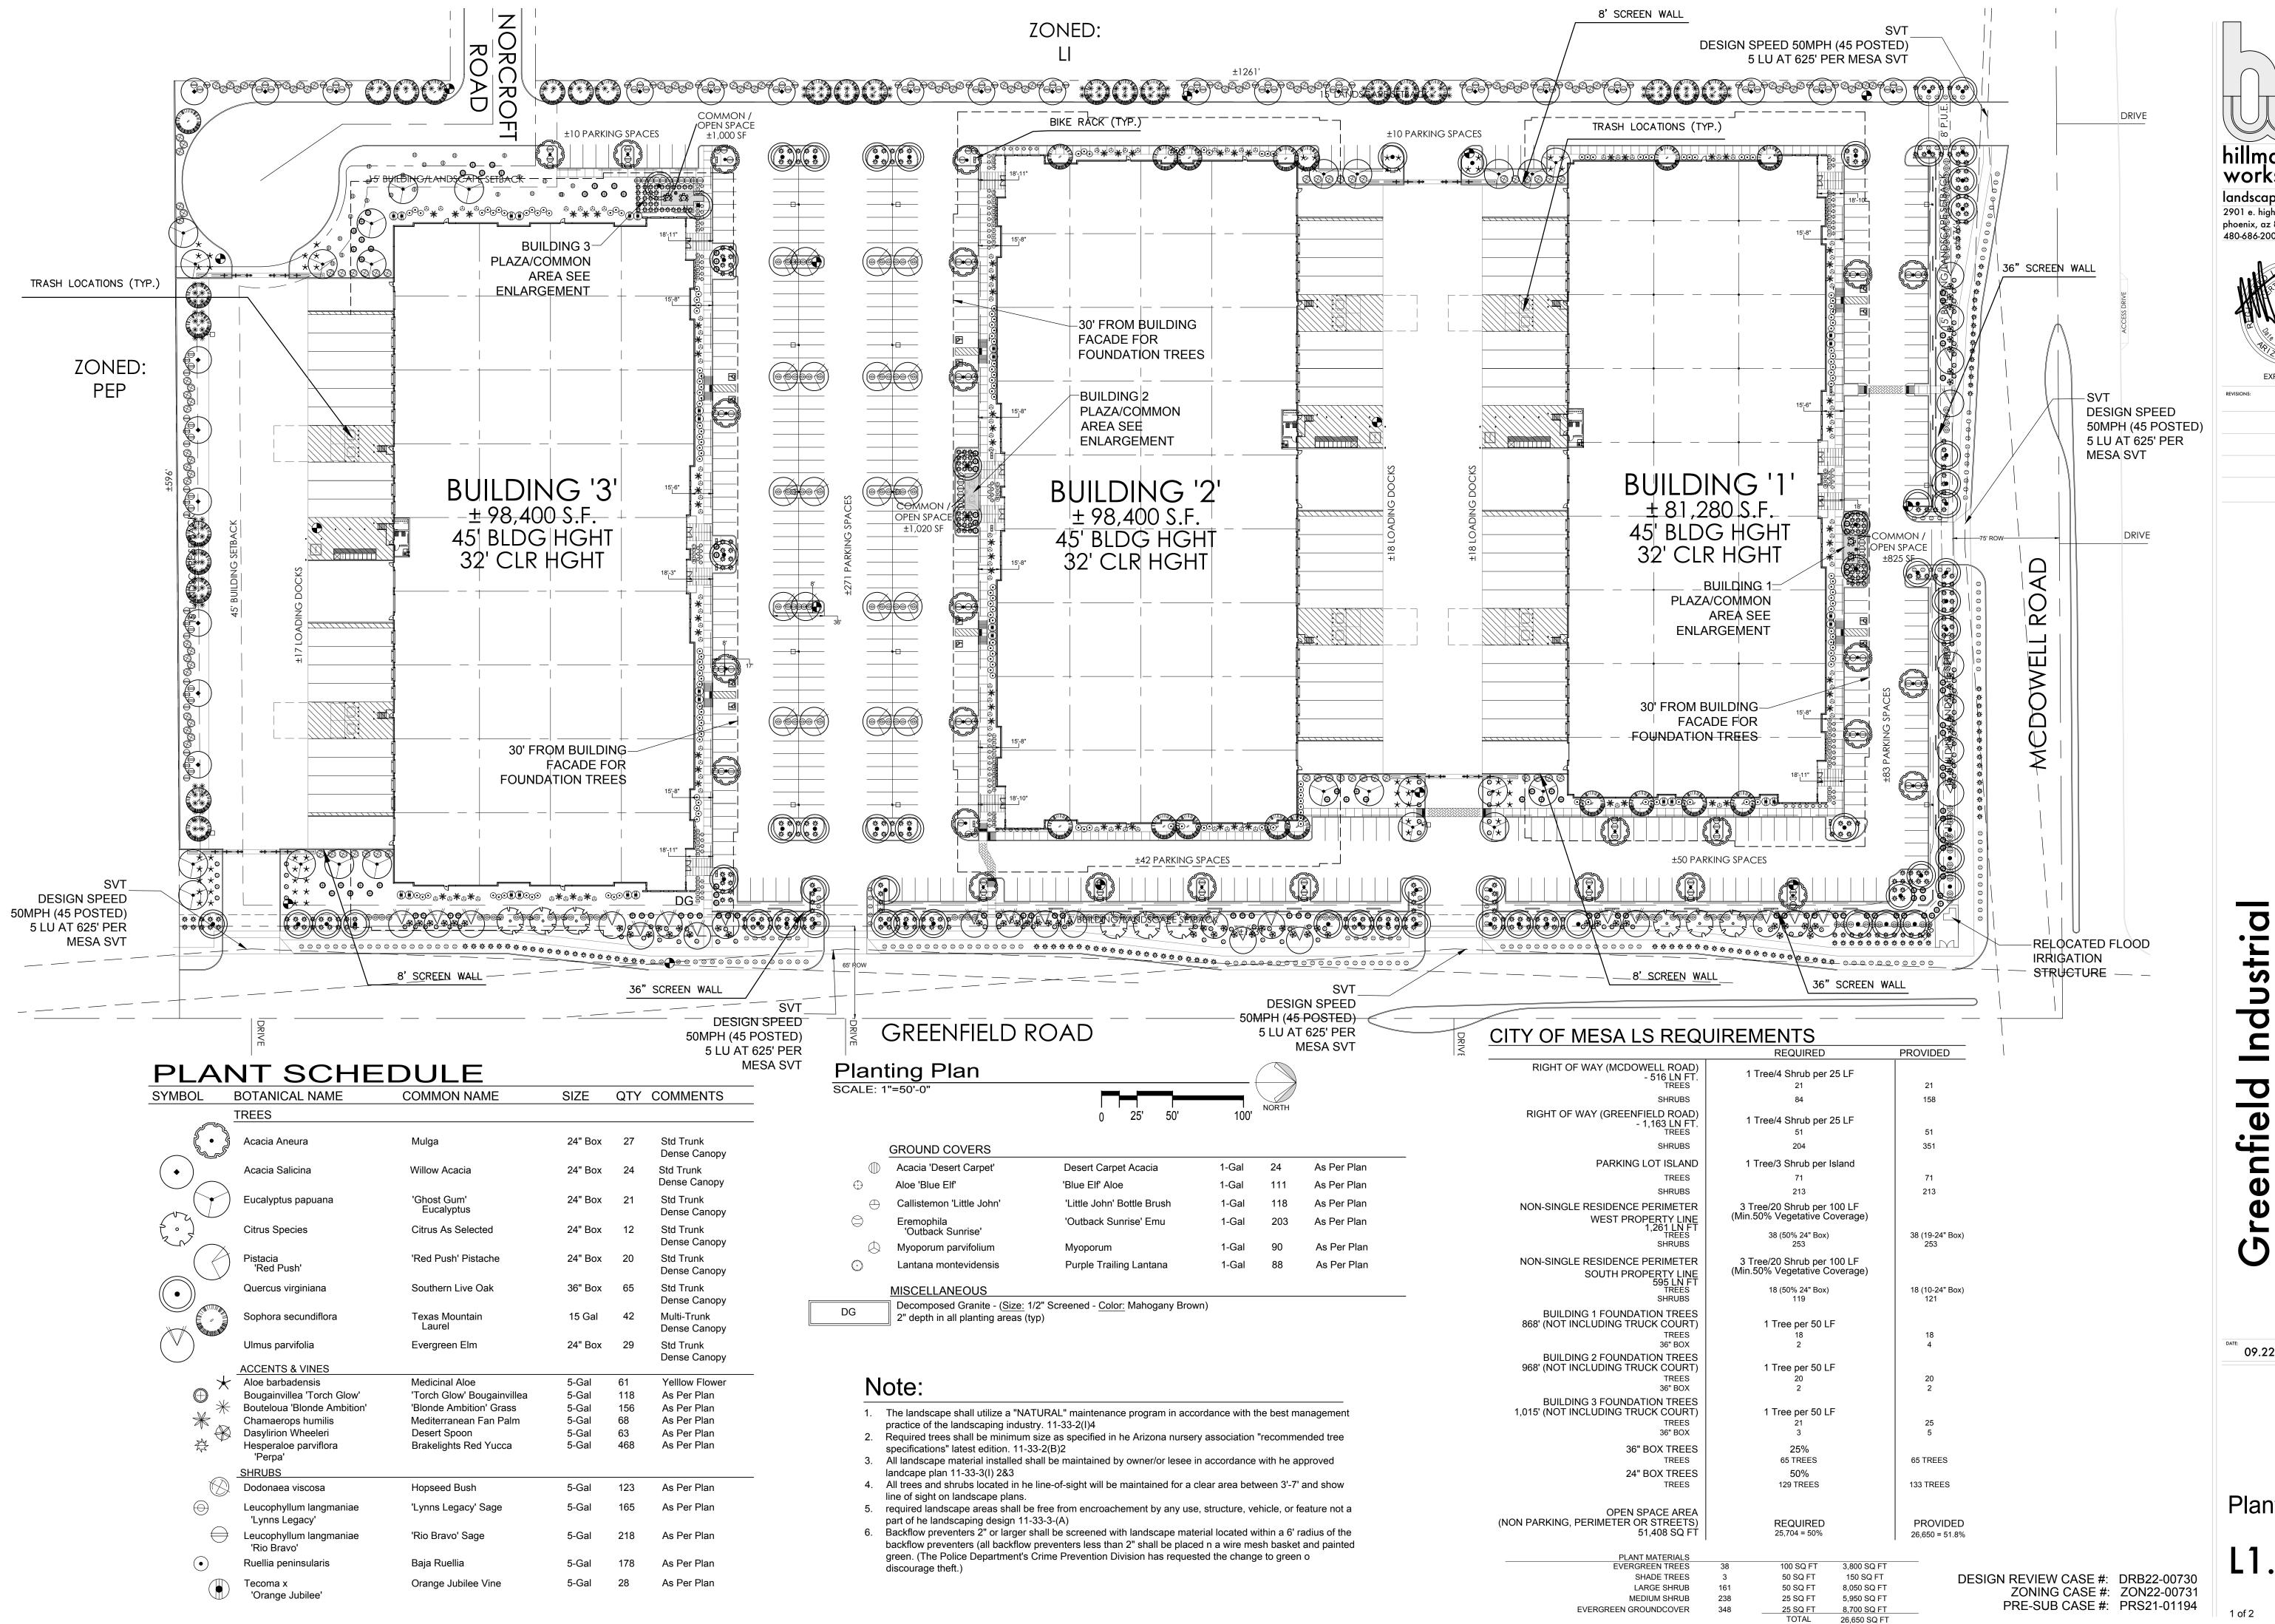


hillman workshop landscape architecture 2901 e. highland ave phoenix, az 85016 480-686-2001



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09.22.22

Planting Plan



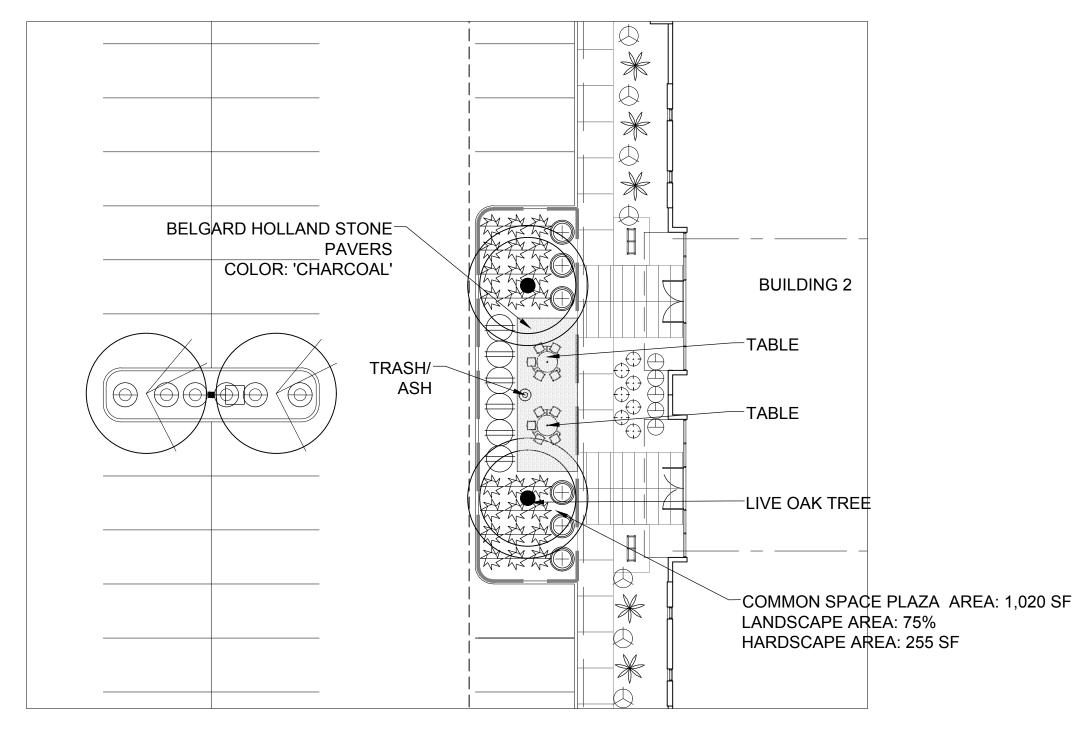


LANDSCAPEFORMS SOLSTICE CYGNUS UMBRELLA COLOR: 'WHITE'




SCALE: 1/16"=1'-0"



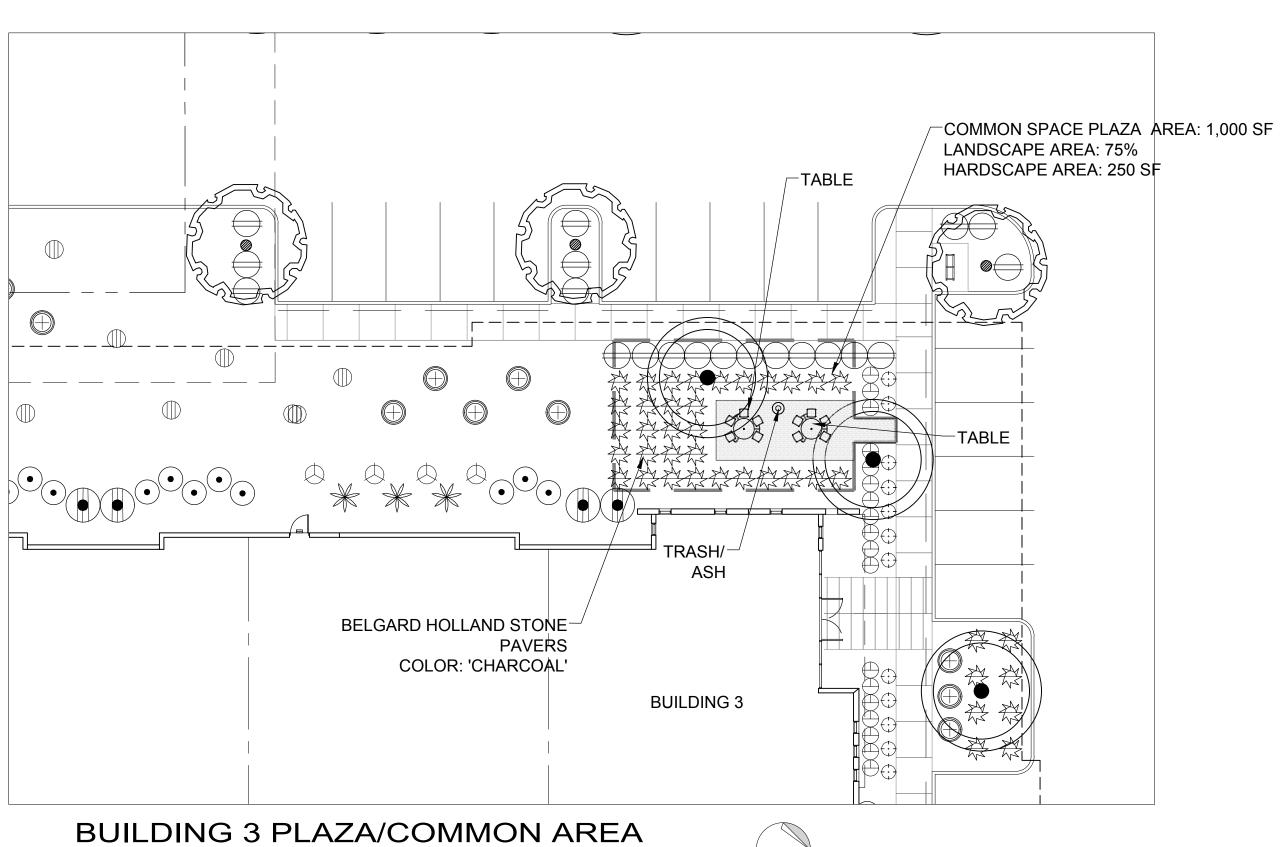



LANDSCAPEFORMS SIDE OPENING LITTER RECEPTACLE, WITH SAND PAN, WITH LOCK COLOR: 'WHITE'

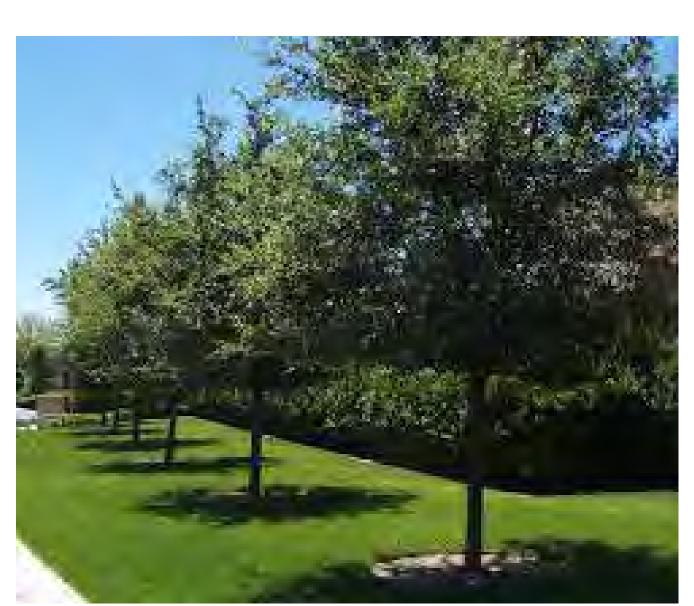

QUERCUS VIRGINIANA SOUTHERN LIVE OAK TREE



LANDSCAPEFORMS
MINGLE TABLE BACKLESS 5 SEAT
SURFACE MOUNT, PERFERATED,
WITH UMBRELLA HOLE
COLOR: 'WHITE'



BELGARD HOLLAND STONE 60MM PAVERS COLOR: CHARCOAL PATTERN: 90 DEGREE HERRINGBONE

DESIGN REVIEW CASE #: DRB22-00730 ZONING CASE #: ZON22-00731 PRE-SUB CASE #: PRS21-01194



hillman workshop

landscape architecture
2901 e. highland ave
phoenix, az 85016
480-686-2001

EXPIRES 09/30/25

Plaza Enlargements

L2.0

09.22.22

# BUILDING 1 - EXTERIOR ELEVATIONS (NORTH)

25 H712 1

<u>43'−0"</u> T.O. PARAPET


→ 32'-0" B.O. ACCENT

27'-0"
WDW HEAD

15'-0"
WDW SILL

14'-0"
T.O. CANOPY

12'-0"
WDW HEAD

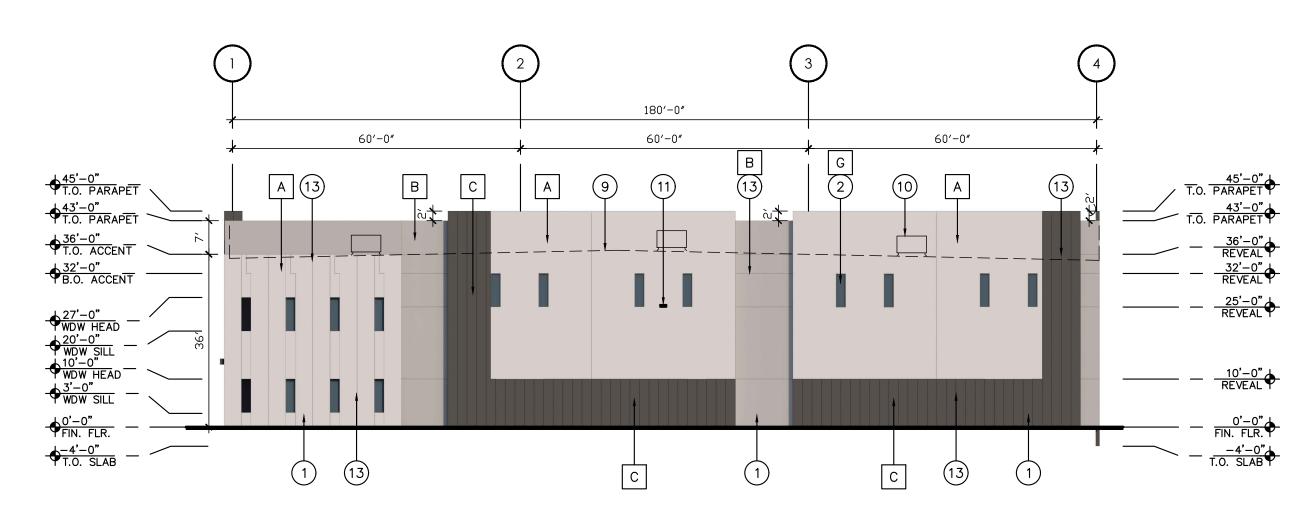


52′-0**″** 

52′-0**″** 

2 10

52′-0**″** 

# BUILDING 1 - EXTERIOR ELEVATIONS (WEST)

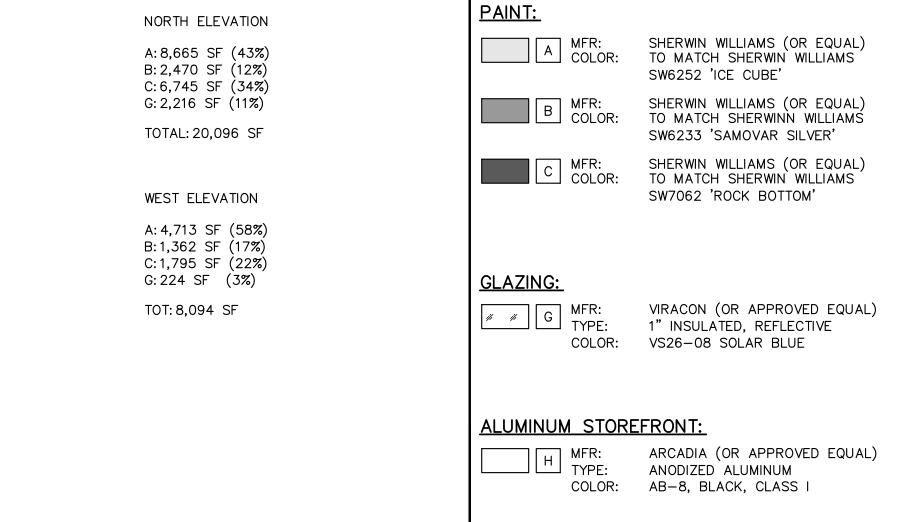

MATERIAL SCHEDULE

MATERIAL CALCULATIONS

448'-0"

52′-0″

5 2 G

## **GENERAL NOTES**

SUPERLITE (OR EQUAL) 8"x8"x16"

SUPERLITE (OR EQUAL)

SUPERLITE (OR EQUAL)

TEXTURE: SMOOTH FACE

COLOR: 'PEARL WHITE'

TEXTURE: SMOOTH FACE

TEXTURE: SPLIT FACE

COLOR: 'OPAL'

8"x8"x16"

COLOR: 'RUTHERFORD GREY'

8"x8"x16"

MASONRY:

J MFR: SIZE:

K MFR: SIZE:

☐ MFR:

SIZE:

52′-0**″** 

- A. BUILDING ARCHITECTURE IS EXPECTED TO CONFORM TO THE BUILDING DESIGN COMPONENTS IN THE DESIGN MANUAL FOR COMMERCIAL, INSUTRIAL AND MULTI-FAMILY RESIDENTIAL DEVELOPMENT.
- BUILDINGS SHALL BE SITED AND DESIGNED TO ACHIEVE AN OPTIMUM LEVEL OF ENERGY EFFICIENCY WITH REGARD TO SOLAR ORIENTATION.

17

- MECHANICAL EQUIPMENT, WHETHER GROUND LEVEL OR ROOF-MOUNTED, SHALL BE SCREENED FROM PUBLIC VIEW AND BE SO LOCATED TO BE PERCEIVED AS AN INTERGRAL PART OF THE BUILDING.
- . EXTERIOR ELECTRICAL WALL EQUIPMENT, INCLUDING BUT NOT LIMITED TO, SERVICE ENTRANCE SECTIONS, ELECTRICAL ACCESS PANELS, AND ELECTRICAL CABINETS, SHALL ME LOCATED IN THE REAR OR SIDE OF THE BUILDING AND BE FULLY ENCLOSED ON IN A RECESSED AREA OF THE BUILDING SO NOT TO PROJECT PAST THE EXTERIOR
- FACADE. ALL SIDES OF A BUILDING SHALL RECEIVE CONSISTENT
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- PEDESTRIAN-OREINTED SITE DESIGN IS REQUIRED. BUILDINGS WITH METAL OR STEEL EXTERIORS SHALL BE ARCHITECTURALLY ALTERED THROUGH THE CONSTRUCTION OF VENEERS, FACADES, OR OTHER ARCHITECTURAL TREATMENTS TO MINIMIZE THE EXTENT OF METAL
- SURFACES VISIBLE. ALL DOWNSPOUTS SHALL BE INTERNALIZED OR ARCHITECTURALLY INTEGRATED INTO THE DESIGN OF A BUILDING.

### **KEYNOTES (ELEVATIONS)**

- NOTE: THE BUILDING ELEVATION KEYNOTES LISTED BELOW ARE TYPICAL TO THE BUILDING AND MAY NOT BE APPLICABLE AND/OR REFERENCED ON ALL SHEETS.
- . PAINTED CONCRETE TILT PANEL.
- 2. 1" INSULATED GLAZING. 3. C.M.U. SCREEN WALL.
- 4. HOLLOW METAL DOOR AND FRAME PAINTED.
- 5. AL/GL DOOR TO MATCH WINDOW SYSTEM.
- 6. OVERHEAD DOOR PAINTED.
- STEEL CANOPY SEE CANOPY DETAILS SHEET A10.02.
- 8. NOT USED.
- 9. LINE OF ROOF BEYOND. 10. LINE OF FUTURE MECHANICAL UNIT BEYOND. 11. LIGHT FIXTURE — SEE ELECTRICAL DRAWINGS.
- 12. NOT USED.
- 13. 1/2" RECESS IN PAINTED CONCRETE TILT PANEL. TYP. 14. NOT USED.
- 15. ADDRESS NUMBERS SHALL BE A MINIMUM OF 24" TALL WITH A 4" BRUSH STROKE OF A CONTRASTING COLOR TO THE BACKGROUND COLOR.

**EXTERIOR** 

(Project Number)

30-22167-00

(Sheet Title)

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9.22.2022

(Revisions)


SITE PLAN

DESIGN REVIEW

DESIGN REVIEW CASE #: DRB22-00730 ZONING CASE #: ZON22-00731 PRE-SUB CASE #: PRS21-01194 **BUILDING 1** COLORED **ELEVATIONS** 

BUILDING 1 - EXTERIOR ELEVATIONS (SOUTH)

<u>+43'−0"</u> T.O. PARAPET >

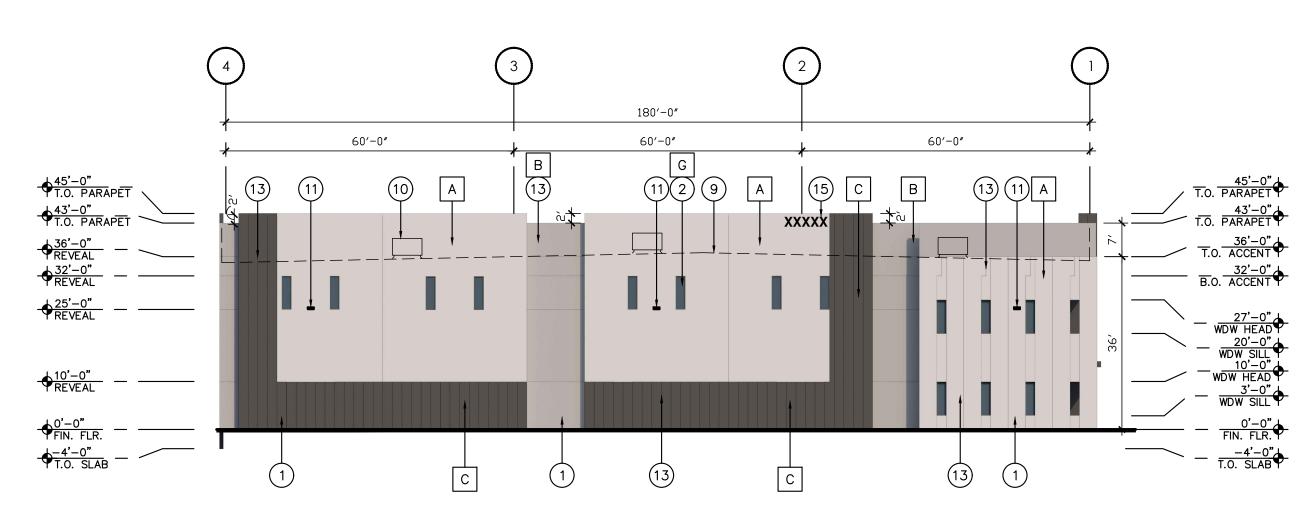

52′-0**″** 

52′-0**″** 

BUILDING 1 - EXTERIOR ELEVATIONS (EAST)

## MATERIAL CALCULATIONS SOUTH ELEVATION A: 9,424 SF (44%) B: 3,720 SF (17%) C: 8,198 SF (38%) G: 0 SF TOT: 21,342 SF EAST ELEVATION A: 4,713 SF (58%) B:1,362 SF (17%) C:1,795 SF (22%) G: 224 SF (3%) TOT: 8,094 SF

### MATERIAL SCHEDULE PAINT:

448'-0"

52′-0**″** 

52′-0**″** 

A MFR: COLOR: SHERWIN WILLIAMS (OR EQUAL) TO MATCH SHERWIN WILLIAMS SW6252 'ICE CUBE' B MFR: COLOR: SHERWIN WILLIAMS (OR EQUAL) TO MATCH SHERWINN WILLIAMS SW6233 'SAMOVAR SILVER'

C MFR: COLOR: SHERWIN WILLIAMS (OR EQUAL) TO MATCH SHERWIN WILLIAMS SW7062 'ROCK BOTTOM'

**GLAZING:** G MFK: TYPE:

VIRACON (OR APPROVED EQUAL) 1" INSULATED, REFLECTIVE COLOR: VS26-08 SOLAR BLUE

**ALUMINUM STOREFRONT:** ARCADIA (OR APPROVED EQUAL) TYPE: ANODIZED ALUMINUM

COLOR: AB-8, BLACK, CLASS I

### MASONRY:

SUPERLITE (OR EQUAL) 8"x8"x16" J MFR: SIZE: TEXTURE: SMOOTH FACE 'PEARL WHITE' COLOR:

K MFR: SIZE: SUPERLITE (OR EQUAL) 8"x8"x16" TEXTURE: SMOOTH FACE COLOR: 'RUTHERFORD GREY'

☐ MFR: SIZE:

SUPERLITE (OR EQUAL) 8"x8"x16" TEXTURE: SPLIT FACE COLOR: 'OPAL'

## **GENERAL NOTES**

52′-0**″** 

A. BUILDING ARCHITECTURE IS EXPECTED TO CONFORM TO THE BUILDING DESIGN COMPONENTS IN THE DESIGN MANUAL FOR COMMERCIAL, INSUTRIAL AND MULTI-FAMILY RESIDENTIAL DEVELOPMENT.

- BUILDINGS SHALL BE SITED AND DESIGNED TO ACHIEVE AN OPTIMUM LEVEL OF ENERGY EFFICIENCY WITH REGARD TO SOLAR ORIENTATION.
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- ALL DOWNSPOUTS SHALL BE INTERNALIZED OR ARCHITECTURALLY INTEGRATED INTO THE DESIGN OF A BUILDING.

### **KEYNOTES (ELEVATIONS)**

NOTE: THE BUILDING ELEVATION KEYNOTES LISTED BELOW ARE TYPICAL TO THE BUILDING AND MAY NOT BE APPLICABLE AND/OR REFERENCED ON ALL SHEETS.

- . PAINTED CONCRETE TILT PANEL.
- 2. 1" INSULATED GLAZING. 3. C.M.U. SCREEN WALL.
- 4. HOLLOW METAL DOOR AND FRAME PAINTED.
- 5. AL/GL DOOR TO MATCH WINDOW SYSTEM. 6. OVERHEAD DOOR — PAINTED.
- STEEL CANOPY SEE CANOPY DETAILS SHEET A10.02. 8. NOT USED.
- 9. LINE OF ROOF BEYOND.
- 10. LINE OF FUTURE MECHANICAL UNIT BEYOND. 11. LIGHT FIXTURE SEE ELECTRICAL DRAWINGS. 12. NOT USED.
- 13. 1/2" RECESS IN PAINTED CONCRETE TILT PANEL. TYP. 14. NOT USED.
- 15. ADDRESS NUMBERS SHALL BE A MINIMUM OF 24" TALL WITH A 4" BRUSH STROKE OF A CONTRASTING COLOR TO THE BACKGROUND COLOR.

(Project Number) 30-22167-00 (Sheet Title) **BUILDING 1** 

DESIGN REVIEW CASE #: DRB22-00730 ZONING CASE #: ZON22-00731

PRE-SUB CASE #: PRS21-01194

COLORED **EXTERIOR ELEVATIONS** 

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9.22.2022


(Revisions)

SITE PLAN

**DESIGN REVIEW** 

## 466'-0" 52′-0**″** 52′-0**″** 52′-0**″** 52′-0″ 52′-0**″** <del>↓45'-0"</del> T.O. PARAPET B C A 10 XXXXX → 32'-0" B.O. ACCENT 15'-0" WDW SILL 14'-0" T.O. CANOPY 12'-0" WDW HEAD 2 5 H 2 G 75 25 H712

# BUILDING 2 - EXTERIOR ELEVATIONS (SOUTH)

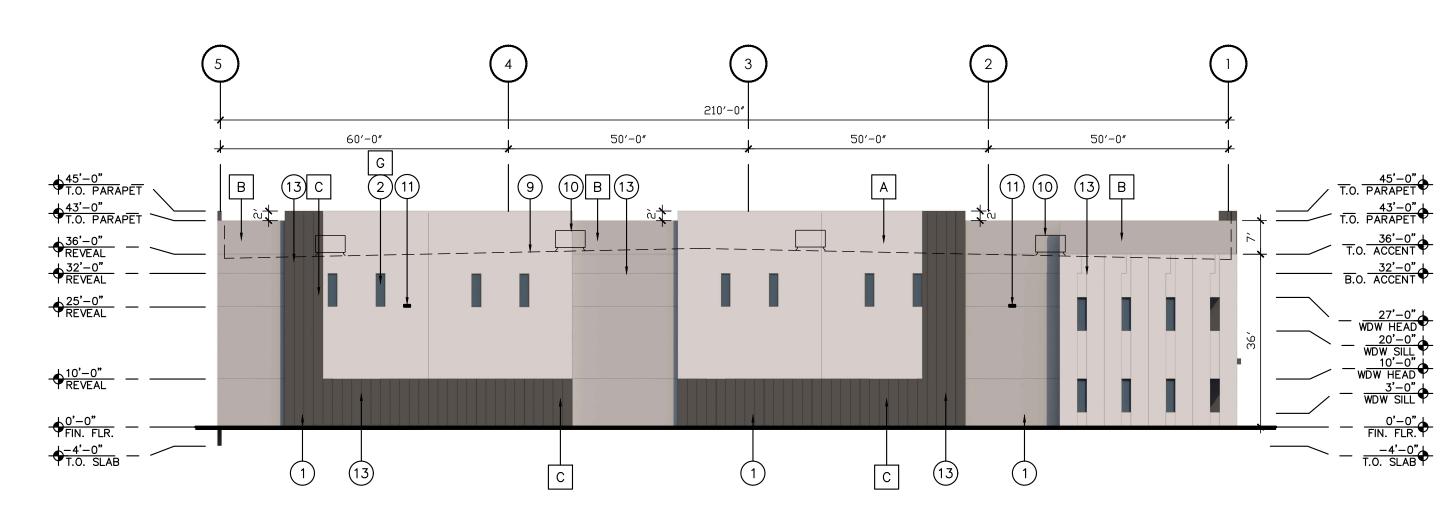

# BUILDING 2 - EXTERIOR ELEVATIONS (WEST)

### MATERIAL CALCULATIONS MATERIAL SCHEDULE PAINT: SOUTH ELEVATION A MFR: COLOR: A: 8,665 SF (42%) B: 3,244 SF (16%) C: 6,745 SF (32%) B MFR: COLOR: G: 2,216 SF (11%) TOT: 20,870 SF C MFR: COLOR: WEST ELEVATION A: 4,713 SF (50%) B: 2,652 SF (28%) C:1,795 SF (19%) G: 224 SF (2%) **GLAZING:** TOT: 9,384 SF VIRACON (OR APPROVED EQUAL) G MFK: TYPE: 1" INSULATED, REFLECTIVE COLOR: VS26-08 SOLAR BLUE

**ALUMINUM STOREFRONT:** 

TYPE:

ARCADIA (OR APPROVED EQUAL)

ANODIZED ALUMINUM

COLOR: AB-8, BLACK, CLASS I

### SHERWIN WILLIAMS (OR EQUAL) SUPERLITE (OR EQUAL) 8"x8"x16" J MFR: SIZE: TO MATCH SHERWIN WILLIAMS SW6252 'ICE CUBE' TEXTURE: SMOOTH FACE 'PEARL WHITE' COLOR: SHERWIN WILLIAMS (OR EQUAL) TO MATCH SHERWINN WILLIAMS K MFR: SIZE: SUPERLITE (OR EQUAL) SW6233 'SAMOVAR SILVER' 8"x8"x16" TEXTURE: SMOOTH FACE SHERWIN WILLIAMS (OR EQUAL) COLOR: 'RUTHERFORD GREY' TO MATCH SHERWIN WILLIAMS SW7062 'ROCK BOTTOM' SUPERLITE (OR EQUAL)

MASONRY:

☐ MFR: SIZE: 8"x8"x16" TEXTURE: SPLIT FACE COLOR: 'OPAL'

## **GENERAL NOTES**

- A. BUILDING ARCHITECTURE IS EXPECTED TO CONFORM TO THE BUILDING DESIGN COMPONENTS IN THE DESIGN MANUAL FOR COMMERCIAL, INSUTRIAL AND MULTI-FAMILY RESIDENTIAL DEVELOPMENT.
- BUILDINGS SHALL BE SITED AND DESIGNED TO ACHIEVE AN OPTIMUM LEVEL OF ENERGY EFFICIENCY WITH REGARD TO SOLAR ORIENTATION.
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- ALL DOWNSPOUTS SHALL BE INTERNALIZED OR ARCHITECTURALLY INTEGRATED INTO THE DESIGN OF A BUILDING.

## **KEYNOTES (ELEVATIONS)**

NOTE: THE BUILDING ELEVATION KEYNOTES LISTED BELOW ARE TYPICAL TO THE BUILDING AND MAY NOT BE APPLICABLE AND/OR REFERENCED ON ALL SHEETS.

. PAINTED CONCRETE TILT PANEL.

THE BACKGROUND COLOR.

- 2. 1" INSULATED GLAZING. 3. C.M.U. SCREEN WALL.
- 4. HOLLOW METAL DOOR AND FRAME PAINTED.
- 5. AL/GL DOOR TO MATCH WINDOW SYSTEM. 6. OVERHEAD DOOR - PAINTED.
- STEEL CANOPY SEE CANOPY DETAILS SHEET A10.02.
- 8. NOT USED.
- 9. LINE OF ROOF BEYOND.
- 10. LINE OF FUTURE MECHANICAL UNIT BEYOND. 11. LIGHT FIXTURE SEE ELECTRICAL DRAWINGS. 12. NOT USED. 13. 1/2" RECESS IN PAINTED CONCRETE TILT PANEL. - TYP.
- 14. NOT USED. 15. ADDRESS NUMBERS SHALL BE A MINIMUM OF 24" TALL WITH A 4" BRUSH STROKE OF A CONTRASTING COLOR TO

30-22167-00 (Sheet Title)

> COLORED **EXTERIOR ELEVATIONS**

DESIGN REVIEW CASE #: DRB22-00730 ZONING CASE #: ZON22-00731 PRE-SUB CASE #: PRS21-01194

(Project Number) **BUILDING 2** 

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9.22.2022

(Revisions)

SITE PLAN

DESIGN REVIEW

### <u> 43'−0"</u> T.O. PARAPET 36'-0" REVEAL 32'-0" REVEAL → 25'-0" — — — 10'-0" — — ◆0'-0" FIN. FLR. 13 C C 13 6

52′-0**″** 

466'-0"

52′-0″


52′-0**″** 

52′-0**″** 

A (9)

## BUILDING 2 - EXTERIOR ELEVATIONS (NORTH)

+45'-0" T.O. PARAPET

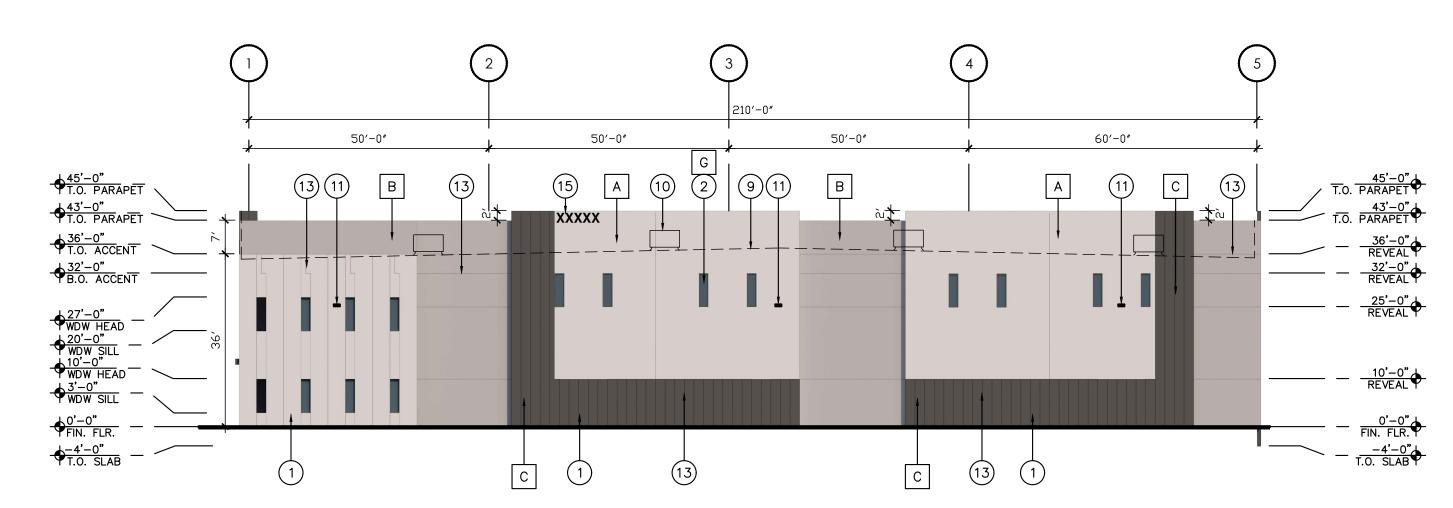

52′-0″

52′-0″

# **BUILDING 2 - EXTERIOR ELEVATIONS (EAST)**

### MATERIAL CALCULATIONS MATERIAL SCHEDULE NORTH ELEVATION A: 9,424 SF (43%)

B: 4,494 SF (20%) C: 8,212 SF (37%) G: 0 SF TOT: 22,130 SF

EAST ELEVATION

A: 4,713 SF (50%) B: 2,652 SF (28%) C:1,795 SF (19%) G: 224 SF (2%)

TOT: 9,384 SF

PAINT: A MFR: COLOR: SHERWIN WILLIAMS (OR EQUAL) TO MATCH SHERWIN WILLIAMS

SW6252 'ICE CUBE' B MFR: COLOR: SHERWIN WILLIAMS (OR EQUAL) TO MATCH SHERWINN WILLIAMS SW6233 'SAMOVAR SILVER'

C MFR: COLOR: SHERWIN WILLIAMS (OR EQUAL) TO MATCH SHERWIN WILLIAMS SW7062 'ROCK BOTTOM'

**GLAZING:** G MFK: TYPE:

VIRACON (OR APPROVED EQUAL) 1" INSULATED, REFLECTIVE COLOR: VS26-08 SOLAR BLUE

**ALUMINUM STOREFRONT:** 

ARCADIA (OR APPROVED EQUAL) H MFR: ANODIZED ALUMINUM COLOR: AB-8, BLACK, CLASS I

### MASONRY:

SUPERLITE (OR EQUAL) 8"x8"x16" J MFR: SIZE: TEXTURE: SMOOTH FACE 'PEARL WHITE' COLOR:

K MFR: SIZE: SUPERLITE (OR EQUAL) 8"x8"x16" TEXTURE: SMOOTH FACE COLOR: 'RUTHERFORD GREY'

☐ MFR: SUPERLITE (OR EQUAL) 8"x8"x16" SIZE: TEXTURE: SPLIT FACE

COLOR: 'OPAL' FACADE.

### FULLY ENCLOSED ON IN A RECESSED AREA OF THE BUILDING SO NOT TO PROJECT PAST THE EXTERIOR

A. BUILDING ARCHITECTURE IS EXPECTED TO CONFORM TO

MANUAL FOR COMMERCIAL, INSUTRIAL AND MULTI-FAMILY

BUILDINGS SHALL BE SITED AND DESIGNED TO ACHIEVE AN

OPTIMUM LEVEL OF ENERGY EFFICIENCY WITH REGARD TO

ROOF-MOUNTED, SHALL BE SCREENED FROM PUBLIC VIEW

AND BE SO LOCATED TO BE PERCEIVED AS AN INTERGRAL

NOT LIMITED TO, SERVICE ENTRANCE SECTIONS, ELECTRICAL

ACCESS PANELS, AND ELECTRICAL CABINETS, SHALL ME

MECHANICAL EQUIPMENT, WHETHER GROUND LEVEL OR

. EXTERIOR ELECTRICAL WALL EQUIPMENT, INCLUDING BUT

THE BUILDING DESIGN COMPONENTS IN THE DESIGN

**GENERAL NOTES** 

SOLAR ORIENTATION.

PART OF THE BUILDING.

RESIDENTIAL DEVELOPMENT.

ALL SIDES OF A BUILDING SHALL RECEIVE CONSISTENT ARCHITECTURAL TREATMENT, ALL BUILDINGS LOCATED WITHIN A UNIFIED, PLANNED DEVELOPMENT, SUCH AS A SHOPPING CENTER OR BUSINESS PARK, SHALL BE ARCHITECTURALLY STYLED TO ACHIEVE HARMONY AND CONTINUITY OF DESIGN. BUILDING ELEVATIONS SHALL BE COORDINATED WITH REGARD TO

COLOR, TEXTURE, MATERIALS, FINISHES, AND FORM. PEDESTRIAN-OREINTED SITE DESIGN IS REQUIRED. BUILDINGS WITH METAL OR STEEL EXTERIORS SHALL BE ARCHITECTURALLY ALTERED THROUGH THE CONSTRUCTION OF VENEERS, FACADES, OR OTHER ARCHITECTURAL TREATMENTS TO MINIMIZE THE EXTENT OF METAL

SURFACES VISIBLE. ALL DOWNSPOUTS SHALL BE INTERNALIZED OR ARCHITECTURALLY INTEGRATED INTO THE DESIGN OF A BUILDING.

## **KEYNOTES (ELEVATIONS)**

NOTE: THE BUILDING ELEVATION KEYNOTES LISTED BELOW ARE TYPICAL TO THE BUILDING AND MAY NOT BE APPLICABLE AND/OR REFERENCED ON ALL SHEETS.

. PAINTED CONCRETE TILT PANEL. 2. 1" INSULATED GLAZING.

3. C.M.U. SCREEN WALL.

4. HOLLOW METAL DOOR AND FRAME - PAINTED.

5. AL/GL DOOR TO MATCH WINDOW SYSTEM. 6. OVERHEAD DOOR — PAINTED.

STEEL CANOPY - SEE CANOPY DETAILS SHEET A10.02.

8. NOT USED. 9. LINE OF ROOF BEYOND.

10. LINE OF FUTURE MECHANICAL UNIT BEYOND. 11. LIGHT FIXTURE — SEE ELECTRICAL DRAWINGS. LOCATED IN THE REAR OR SIDE OF THE BUILDING AND BE

12. NOT USED.

13. 1/2" RECESS IN PAINTED CONCRETE TILT PANEL. - TYP. 14. NOT USED.

15. ADDRESS NUMBERS SHALL BE A MINIMUM OF 24" TALL

WITH A 4" BRUSH STROKE OF A CONTRASTING COLOR TO THE BACKGROUND COLOR.

**BUILDING 2** 

(Project Number)

30-22167-00

(Sheet Title)

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9.22.2022

(Revisions)

SITE PLAN

**DESIGN REVIEW** 


**ELEVATIONS** 

DESIGN REVIEW CASE #: DRB22-00730 ZONING CASE #: ZON22-00731 PRE-SUB CASE #: PRS21-01194 COLORED **EXTERIOR** 

BUILDING 3 - EXTERIOR ELEVATIONS (NORTH)

51′-0″

₩DW HEAD

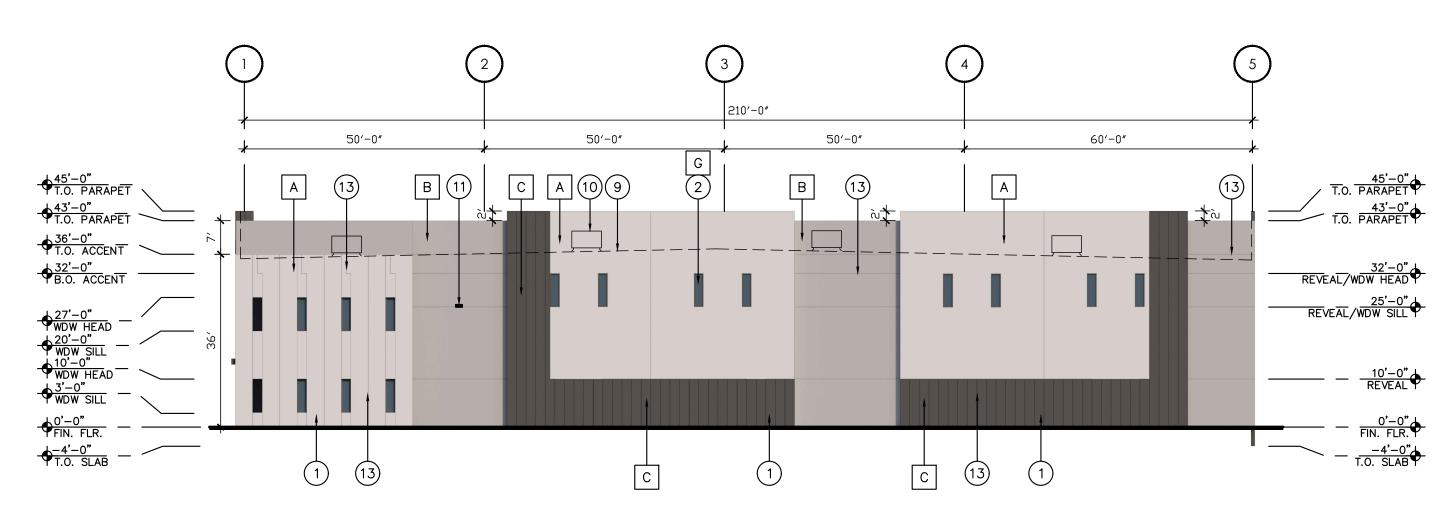

MATERIAL CALCULATIONS

52′-0″

52′-0″

# **BUILDING 3 - EXTERIOR ELEVATIONS (WEST)**

### PAINT: NORTH ELEVATION A MFR: COLOR: SHERWIN WILLIAMS (OR EQUAL) A: 8,665 SF (41%) TO MATCH SHERWIN WILLIAMS B: 3,330 SF (16%) SW6252 'ICE CUBE' C: 6,745 SF (32%) B MFR: COLOR: G: 2,216 SF (11%) SHERWIN WILLIAMS (OR EQUAL) TO MATCH SHERWINN WILLIAMS TOT: 20,956 SF SW6233 'SAMOVAR SILVER' C MFR: COLOR: SHERWIN WILLIAMS (OR EQUAL) TO MATCH SHERWIN WILLIAMS SW7062 'ROCK BOTTOM' WEST ELEVATION A: 4,713 SF (50%) B: 2,652 SF (28%) C:1,795 SF (19%) G: 224 SF (2%) **GLAZING:** TOT: 9,384 SF VIRACON (OR APPROVED EQUAL) G MFK: TYPE: 1" INSULATED, REFLECTIVE COLOR: VS26-08 SOLAR BLUE **ALUMINUM STOREFRONT:** ARCADIA (OR APPROVED EQUAL) H MFR: ANODIZED ALUMINUM COLOR: AB-8, BLACK, CLASS I

MATERIAL SCHEDULE

466′-0″

7 5

52'-0"

### MASONRY:

SUPERLITE (OR EQUAL) 8"x8"x16" J MFR: SIZE: TEXTURE: SMOOTH FACE 'PEARL WHITE' COLOR:

K MFR: SIZE: SUPERLITE (OR EQUAL) 8"x8"x16" TEXTURE: SMOOTH FACE COLOR: 'RUTHERFORD GREY'

☐ MFR: SUPERLITE (OR EQUAL) SIZE:

8"x8"x16" TEXTURE: SPLIT FACE COLOR: 'OPAL'

### BUILDING SO NOT TO PROJECT PAST THE EXTERIOR FACADE. ALL SIDES OF A BUILDING SHALL RECEIVE CONSISTENT

FULLY ENCLOSED ON IN A RECESSED AREA OF THE

A. BUILDING ARCHITECTURE IS EXPECTED TO CONFORM TO

MANUAL FOR COMMERCIAL, INSUTRIAL AND MULTI-FAMILY

BUILDINGS SHALL BE SITED AND DESIGNED TO ACHIEVE AN

OPTIMUM LEVEL OF ENERGY EFFICIENCY WITH REGARD TO

ROOF-MOUNTED, SHALL BE SCREENED FROM PUBLIC VIEW

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ACCESS PANELS, AND ELECTRICAL CABINETS, SHALL ME

MECHANICAL EQUIPMENT, WHETHER GROUND LEVEL OR

. EXTERIOR ELECTRICAL WALL EQUIPMENT, INCLUDING BUT

THE BUILDING DESIGN COMPONENTS IN THE DESIGN

**GENERAL NOTES** 

SOLAR ORIENTATION.

PART OF THE BUILDING.

RESIDENTIAL DEVELOPMENT.

52′-0″

xxxxx

52′-0″

ARCHITECTURAL TREATMENT, ALL BUILDINGS LOCATED WITHIN A UNIFIED, PLANNED DEVELOPMENT, SUCH AS A SHOPPING CENTER OR BUSINESS PARK, SHALL BE ARCHITECTURALLY STYLED TO ACHIEVE HARMONY AND CONTINUITY OF DESIGN. BUILDING ELEVATIONS SHALL BE COORDINATED WITH REGARD TO COLOR, TEXTURE, MATERIALS, FINISHES, AND FORM.

PEDESTRIAN-OREINTED SITE DESIGN IS REQUIRED. BUILDINGS WITH METAL OR STEEL EXTERIORS SHALL BE ARCHITECTURALLY ALTERED THROUGH THE CONSTRUCTION OF VENEERS, FACADES, OR OTHER ARCHITECTURAL TREATMENTS TO MINIMIZE THE EXTENT OF METAL SURFACES VISIBLE.

ALL DOWNSPOUTS SHALL BE INTERNALIZED OR ARCHITECTURALLY INTEGRATED INTO THE DESIGN OF A BUILDING.

## **KEYNOTES (ELEVATIONS)**

NOTE: THE BUILDING ELEVATION KEYNOTES LISTED BELOW ARE TYPICAL TO THE BUILDING AND MAY NOT BE APPLICABLE AND/OR REFERENCED ON ALL SHEETS.

- . PAINTED CONCRETE TILT PANEL. 2. 1" INSULATED GLAZING.
- 3. C.M.U. SCREEN WALL.
- 4. HOLLOW METAL DOOR AND FRAME PAINTED. 5. AL/GL DOOR TO MATCH WINDOW SYSTEM.
- 6. OVERHEAD DOOR PAINTED.
- STEEL CANOPY SEE CANOPY DETAILS SHEET A10.02. 8. NOT USED.
- 9. LINE OF ROOF BEYOND.
- 10. LINE OF FUTURE MECHANICAL UNIT BEYOND. 11. LIGHT FIXTURE SEE ELECTRICAL DRAWINGS. LOCATED IN THE REAR OR SIDE OF THE BUILDING AND BE
  - 12. NOT USED.
  - 13. 1/2" RECESS IN PAINTED CONCRETE TILT PANEL. TYP. 14. NOT USED.
  - 15. ADDRESS NUMBERS SHALL BE A MINIMUM OF 24" TALL WITH A 4" BRUSH STROKE OF A CONTRASTING COLOR TO THE BACKGROUND COLOR.

**EXTERIOR ELEVATIONS** 

(Project Number)

30-22167-00

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CD F

9.22.2022

(Revisions)

SITE PLAN

**DESIGN REVIEW** 

DESIGN REVIEW CASE #: DRB22-00730 ZONING CASE #: ZON22-00731 PRE-SUB CASE #: PRS21-01194

(Sheet Title) **BUILDING 3** COLORED

### 52′-0″ 52′-0″ 52′-0**″** 52′-0″ 52′-0″ 52′-0**″** 52′-0**″** 51′-0″ 51′-0″ 11 10 43'-0" T.O. PARAPET 32'-0" REVEAL/WDW HEAD REVEAL/WDW HEAD →25'-0" REVEAL/WDW SILL REVEAL/WDW SILL +10'-0" — — 1 6 1 6 6 11

## BUILDING 3 - EXTERIOR ELEVATIONS (SOUTH)

50′-0**″** 50'-0" 50′-0**″** PREVEAL/WDW HEAD →25'-0"
REVEAL/WDW SILL

# **BUILDING 3 - EXTERIOR ELEVATIONS (EAST)**

## MATERIAL CALCULATIONS SOUTH A: 10,579 SF (48%) B: 3,917 SF (18%) C: 7,693 SF (35%) G: 0 SF TOT: 22,189 SF EAST ELEVATION A: 4,713 SF (50%) B: 2,652 SF (28%) C:1,795 SF (19%) G: 224 SF (2%) TOT: 9,384 SF

### MATERIAL SCHEDULE PAINT:

A MFR: COLOR: SHERWIN WILLIAMS (OR EQUAL) TO MATCH SHERWIN WILLIAMS SW6252 'ICE CUBE' B MFR: COLOR: SHERWIN WILLIAMS (OR EQUAL) TO MATCH SHERWINN WILLIAMS SW6233 'SAMOVAR SILVER' SHERWIN WILLIAMS (OR EQUAL) TO MATCH SHERWIN WILLIAMS

C MFR: COLOR:

**GLAZING:** G MFK: TYPE:

VIRACON (OR APPROVED EQUAL) 1" INSULATED, REFLECTIVE COLOR: VS26-08 SOLAR BLUE

SW7062 'ROCK BOTTOM'

**ALUMINUM STOREFRONT:** 

ARCADIA (OR APPROVED EQUAL) H MFR: ANODIZED ALUMINUM COLOR: AB-8, BLACK, CLASS I

### MASONRY:

SUPERLITE (OR EQUAL) 8"x8"x16" J MFR: SIZE: TEXTURE: SMOOTH FACE 'PEARL WHITE' COLOR:

K MFR: SIZE: SUPERLITE (OR EQUAL) 8"x8"x16" TEXTURE: SMOOTH FACE COLOR: 'RUTHERFORD GREY'

SIZE:

SUPERLITE (OR EQUAL) 8"x8"x16" TEXTURE: SPLIT FACE COLOR: 'OPAL'

## **GENERAL NOTES**

- A. BUILDING ARCHITECTURE IS EXPECTED TO CONFORM TO THE BUILDING DESIGN COMPONENTS IN THE DESIGN MANUAL FOR COMMERCIAL, INSUTRIAL AND MULTI-FAMILY
- RESIDENTIAL DEVELOPMENT. BUILDINGS SHALL BE SITED AND DESIGNED TO ACHIEVE AN OPTIMUM LEVEL OF ENERGY EFFICIENCY WITH REGARD TO SOLAR ORIENTATION.
- MECHANICAL EQUIPMENT, WHETHER GROUND LEVEL OR ROOF-MOUNTED, SHALL BE SCREENED FROM PUBLIC VIEW AND BE SO LOCATED TO BE PERCEIVED AS AN INTERGRAL PART OF THE BUILDING.
- . EXTERIOR ELECTRICAL WALL EQUIPMENT, INCLUDING BUT NOT LIMITED TO, SERVICE ENTRANCE SECTIONS, ELECTRICAL ACCESS PANELS, AND ELECTRICAL CABINETS, SHALL ME LOCATED IN THE REAR OR SIDE OF THE BUILDING AND BE FULLY ENCLOSED ON IN A RECESSED AREA OF THE BUILDING SO NOT TO PROJECT PAST THE EXTERIOR
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- 2. 1" INSULATED GLAZING. 3. C.M.U. SCREEN WALL.
- 4. HOLLOW METAL DOOR AND FRAME PAINTED.
- 5. AL/GL DOOR TO MATCH WINDOW SYSTEM. 6. OVERHEAD DOOR - PAINTED.
- STEEL CANOPY SEE CANOPY DETAILS SHEET A10.02.
- 8. NOT USED.
- 9. LINE OF ROOF BEYOND. 10. LINE OF FUTURE MECHANICAL UNIT BEYOND. 11. LIGHT FIXTURE — SEE ELECTRICAL DRAWINGS.
- 12. NOT USED.
- 13. 1/2" RECESS IN PAINTED CONCRETE TILT PANEL. TYP. 14. NOT USED.
- 15. ADDRESS NUMBERS SHALL BE A MINIMUM OF 24" TALL WITH A 4" BRUSH STROKE OF A CONTRASTING COLOR TO THE BACKGROUND COLOR.

**EXTERIOR ELEVATIONS** 

(Project Number)

30-22167-00

(Sheet Title)

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9.22.2022

(Revisions)

SITE PLAN

**DESIGN REVIEW** 

DESIGN REVIEW CASE #: DRB22-00730 ZONING CASE #: ZON22-00731 PRE-SUB CASE #: PRS21-01194 **BUILDING 3** COLORED

BUILDING 1 COLOR RENDERING

A4.03C



BUILDING 1 - COLOR RENDERING

SCALE: N.T.S.





Shaine T. Alleman Attorney at Law 602.452.2712 sta@tblaw.com

October 28, 2022

RE: Hopewell Development; 4329 E. McDowell Road, Mesa, Arizona 85215 Planning & Zoning Board Hearing (ZON22-00731)

Dear Neighbor,

We have applied for an application for a Rezone to remove conditions of approval of Zoning Case Number Z80-047, Site Plan Review, and Special Use Permit for the property located at 4329 E. McDowell Road, Mesa 85215. This request is for development of a light industrial use. The case number assigned to this project is ZON22-00731.

This letter is being sent to all property owners within 1000 feet of the property at the request of the City of Mesa Planning Division. Enclosed for your review is a copy of the site plan and elevations of the proposed development. If you have any questions regarding this proposal, please call me at 602-452-2712 or e-mail me at sta@tblaw.com.

This application will be scheduled for consideration by the Mesa Planning and Zoning Board at its meeting held on November 16th, 2022 in the City Council Chambers at 57 East First Street. The meeting will begin at 4:00 p.m. You are invited to attend this meeting and provide any input you may have regarding this proposal.

The public can attend the meeting either in-person or electronically and telephonically. The live meeting may be watched on local cable Mesa channel 11, online at <a href="Mesa11.com/live">Mesa11.com/live</a> or <a href="www.youtube.com/user/cityofmesa11/live">www.youtube.com/user/cityofmesa11/live</a>, or listened to by calling 888-788-0099 or 877-853-5247 (toll free) using meeting ID 530 123 2921 and following the prompts. If you want to provide a written comment or speak telephonically at the meeting, please submit an online comment card by scanning the QR code below or visiting <a href="https://www.mesaaz.gov/government/advisory-boards-committees/planning-zoning-board/online-meeting-comment-card">https://www.mesaaz.gov/government/advisory-boards-committees/planning-zoning-board/online-meeting-comment-card</a> at least 1 hour prior to the start of the meeting. If you want to speak at the meeting, you will need to indicate on the comment card that you would like to speak during the meeting, and you will need to call 888-788-0099 or 877-853-5247 (toll free) using meeting ID 530 123 2921 and following the prompts, prior to the start of the meeting. You will be able to listen to the meeting; and when the item you have indicated that you want to speak on is before the Board, your line will be taken off mute and you will be given an opportunity to speak.


For help with the online comment card, or for any other technical difficulties, please call 480-644-2099.

The City of Mesa has assigned this case to Chloe Durfee Daniel of their Planning Division staff. She can be reached at 480-644-6714 or <u>Chloe.Durfee.Daniel@MesaAZ.Gov</u>, should you have any questions regarding the public hearing process. If you have sold this property in the interim, please forward this correspondence to the new owner.

Shaine T. Alleman

Sincerely.

Camelback Esplanade II, Seventh Floor 2525 East Camelback Road Phoenix, Arizona 85016-4229 602.255.6000 PHONE 602.255.0103 FAX

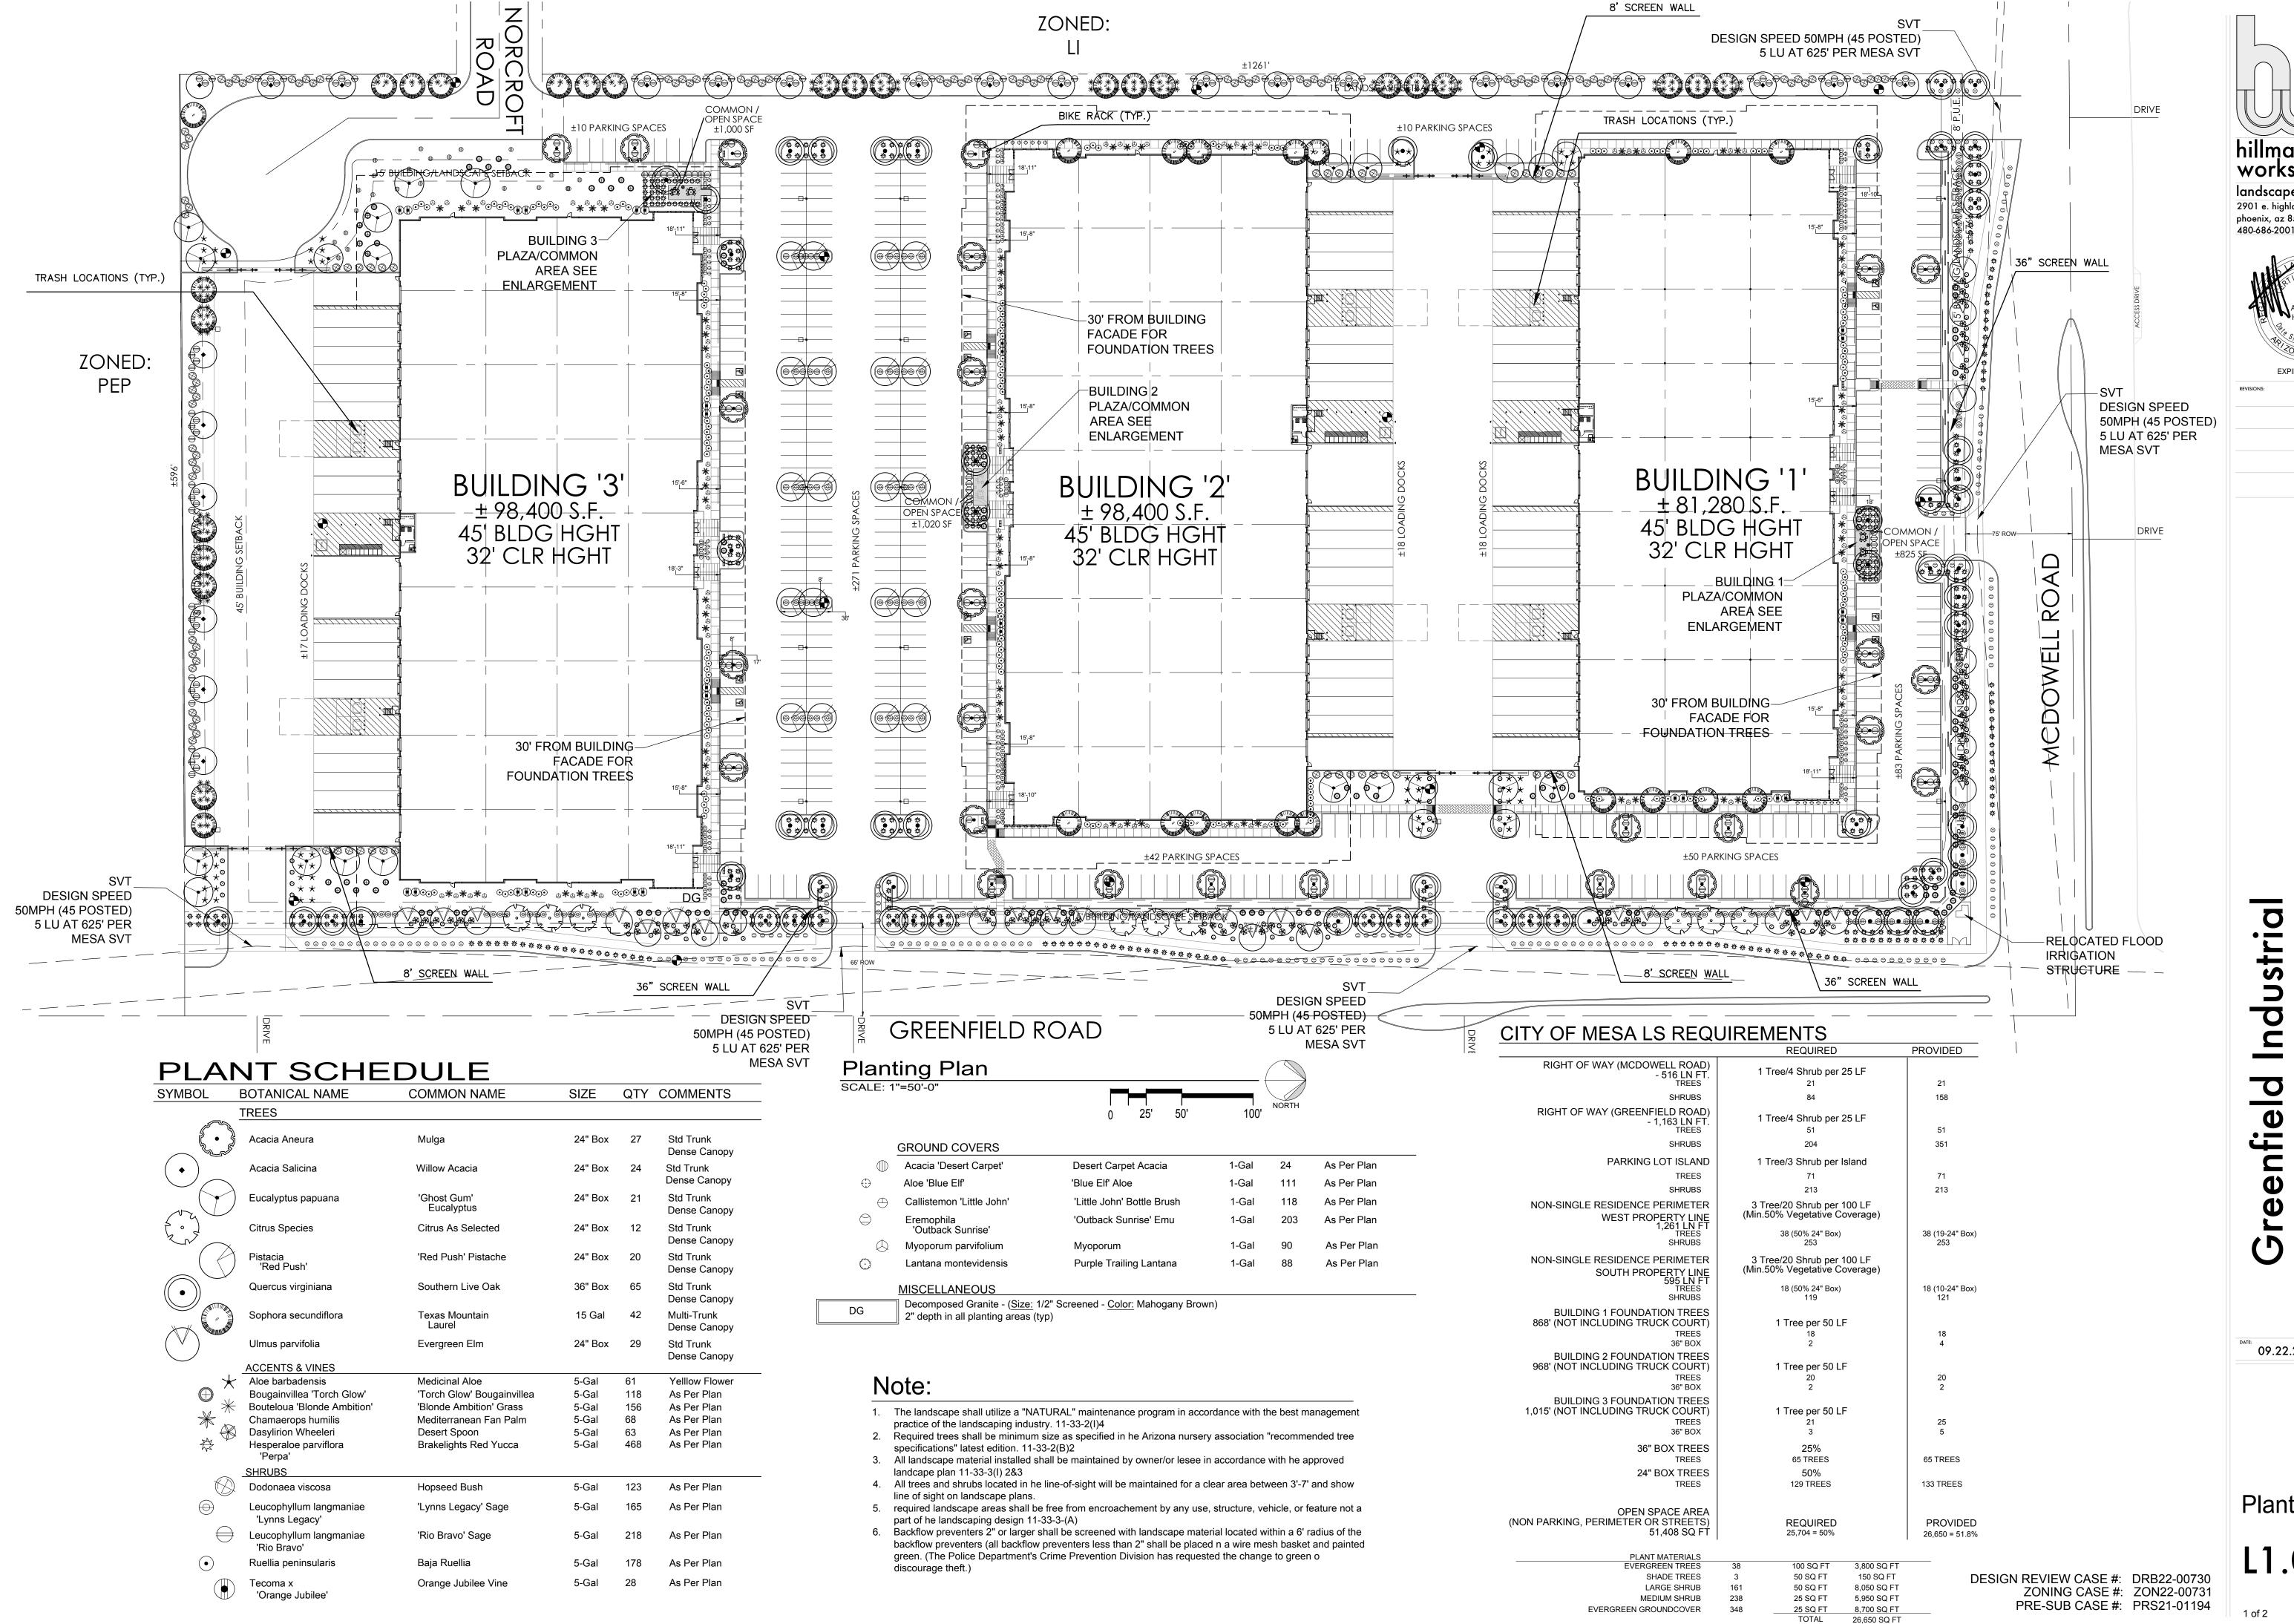

hillman workshop landscape architecture 2901 e. highland ave phoenix, az 85016 480-686-2001



EXPIRES 09/30/25

09.22.22

Planting Plan

BUILDING 1 COLOR RENDERING

A4.03C



BUILDING 1 - COLOR RENDERING

SCALE: N.T.S.

# BUILDING 1 - EXTERIOR ELEVATIONS (NORTH)

25 H712 1

<u>43'−0"</u> T.O. PARAPET


→ 32'-0" B.O. ACCENT

27'-0"
WDW HEAD

15'-0"
WDW SILL

14'-0"
T.O. CANOPY

12'-0"
WDW HEAD

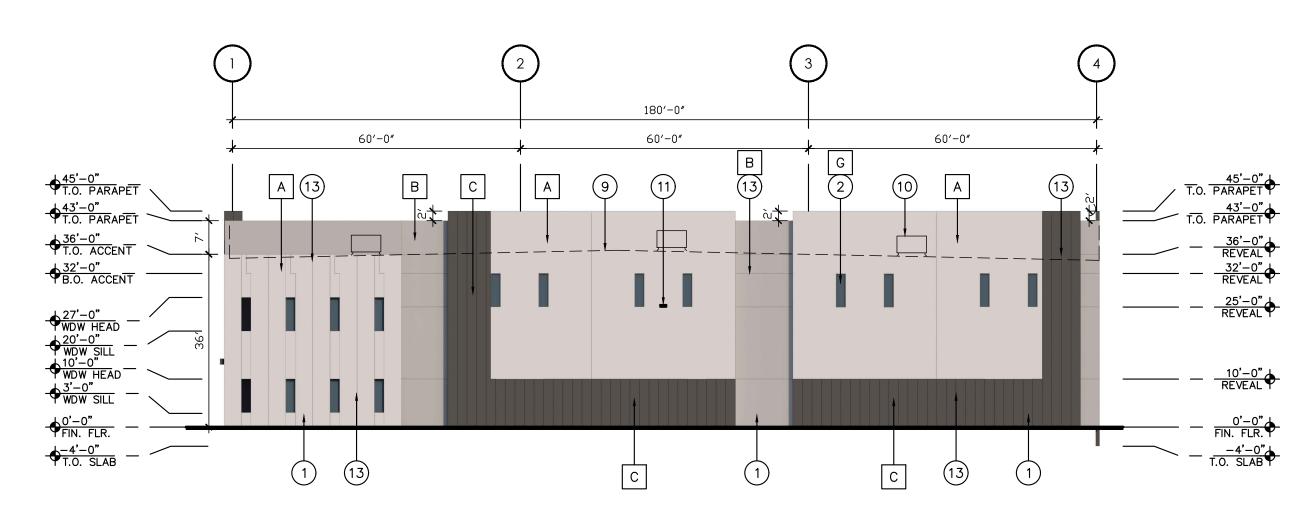


52′-0**″** 

52′-0**″** 

2 10

52′-0**″** 

# BUILDING 1 - EXTERIOR ELEVATIONS (WEST)

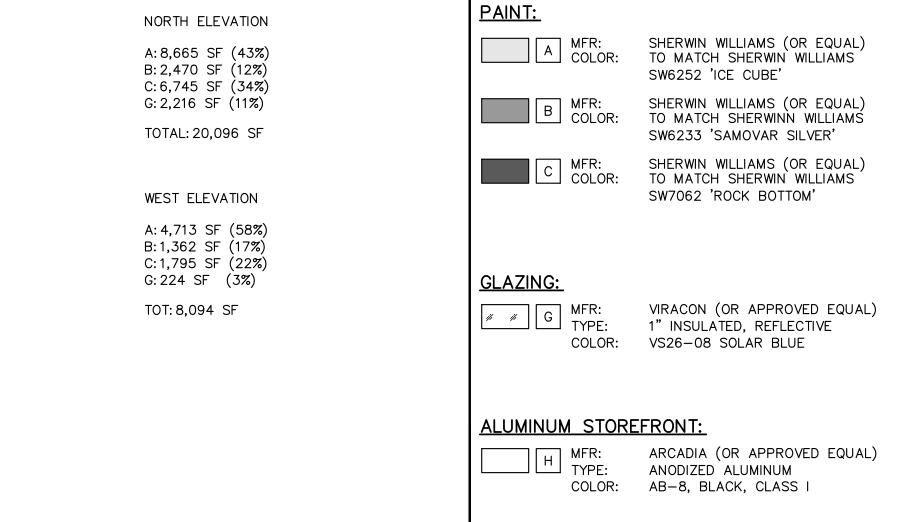

MATERIAL SCHEDULE

MATERIAL CALCULATIONS

448'-0"

52′-0″

5 2 G

## **GENERAL NOTES**

SUPERLITE (OR EQUAL) 8"x8"x16"

SUPERLITE (OR EQUAL)

SUPERLITE (OR EQUAL)

TEXTURE: SMOOTH FACE

COLOR: 'PEARL WHITE'

TEXTURE: SMOOTH FACE

TEXTURE: SPLIT FACE

COLOR: 'OPAL'

8"x8"x16"

COLOR: 'RUTHERFORD GREY'

8"x8"x16"

MASONRY:

J MFR: SIZE:

K MFR: SIZE:

☐ MFR:

SIZE:

52′-0**″** 

- A. BUILDING ARCHITECTURE IS EXPECTED TO CONFORM TO THE BUILDING DESIGN COMPONENTS IN THE DESIGN MANUAL FOR COMMERCIAL, INSUTRIAL AND MULTI-FAMILY RESIDENTIAL DEVELOPMENT.
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17

- MECHANICAL EQUIPMENT, WHETHER GROUND LEVEL OR ROOF-MOUNTED, SHALL BE SCREENED FROM PUBLIC VIEW AND BE SO LOCATED TO BE PERCEIVED AS AN INTERGRAL PART OF THE BUILDING.
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**EXTERIOR** 

(Project Number)

30-22167-00

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9.22.2022

(Revisions)


SITE PLAN

DESIGN REVIEW

DESIGN REVIEW CASE #: DRB22-00730 ZONING CASE #: ZON22-00731 PRE-SUB CASE #: PRS21-01194 **BUILDING 1** COLORED **ELEVATIONS** 

BUILDING 1 - EXTERIOR ELEVATIONS (SOUTH)

<u>+43'−0"</u> T.O. PARAPET >

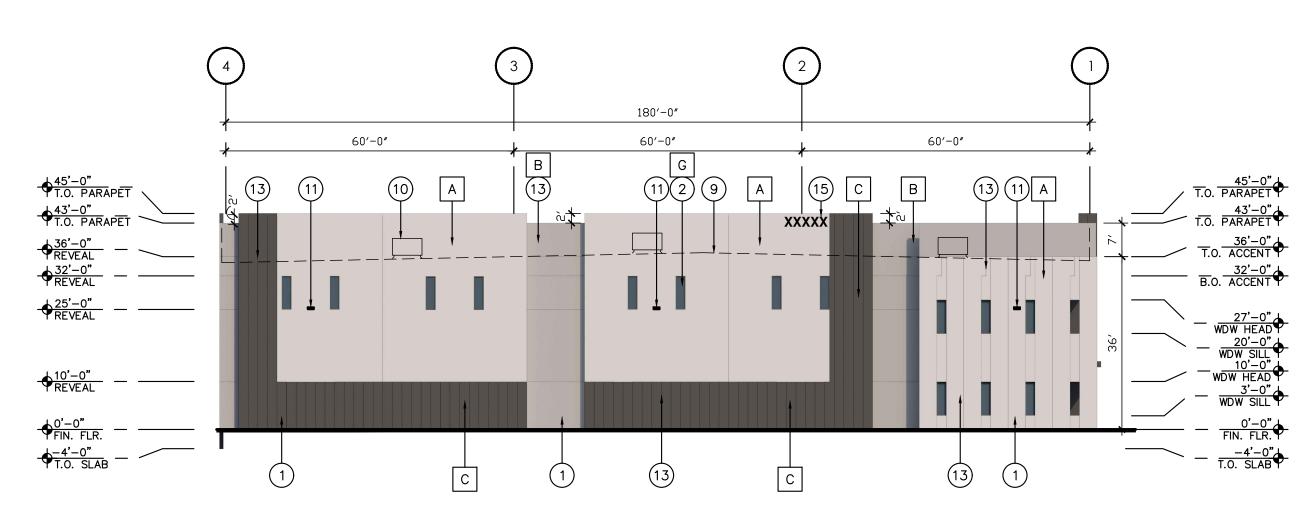

52′-0**″** 

52′-0**″** 

BUILDING 1 - EXTERIOR ELEVATIONS (EAST)

## MATERIAL CALCULATIONS SOUTH ELEVATION A: 9,424 SF (44%) B: 3,720 SF (17%) C: 8,198 SF (38%) G: 0 SF TOT: 21,342 SF EAST ELEVATION A: 4,713 SF (58%) B:1,362 SF (17%) C:1,795 SF (22%) G: 224 SF (3%) TOT: 8,094 SF

### MATERIAL SCHEDULE PAINT:

448'-0"

52′-0**″** 

52′-0**″** 

A MFR: COLOR: SHERWIN WILLIAMS (OR EQUAL) TO MATCH SHERWIN WILLIAMS SW6252 'ICE CUBE' B MFR: COLOR: SHERWIN WILLIAMS (OR EQUAL) TO MATCH SHERWINN WILLIAMS SW6233 'SAMOVAR SILVER'

C MFR: COLOR: SHERWIN WILLIAMS (OR EQUAL) TO MATCH SHERWIN WILLIAMS SW7062 'ROCK BOTTOM'

**GLAZING:** G MFK: TYPE:

VIRACON (OR APPROVED EQUAL) 1" INSULATED, REFLECTIVE COLOR: VS26-08 SOLAR BLUE

**ALUMINUM STOREFRONT:** ARCADIA (OR APPROVED EQUAL) TYPE: ANODIZED ALUMINUM

COLOR: AB-8, BLACK, CLASS I

### MASONRY:

SUPERLITE (OR EQUAL) 8"x8"x16" J MFR: SIZE: TEXTURE: SMOOTH FACE 'PEARL WHITE' COLOR:

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☐ MFR: SIZE:

SUPERLITE (OR EQUAL) 8"x8"x16" TEXTURE: SPLIT FACE COLOR: 'OPAL'

## **GENERAL NOTES**

52′-0**″** 

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- 15. ADDRESS NUMBERS SHALL BE A MINIMUM OF 24" TALL WITH A 4" BRUSH STROKE OF A CONTRASTING COLOR TO THE BACKGROUND COLOR.

(Project Number) 30-22167-00 (Sheet Title)

DESIGN REVIEW CASE #: DRB22-00730 ZONING CASE #: ZON22-00731 PRE-SUB CASE #: PRS21-01194 **BUILDING 1** COLORED **EXTERIOR ELEVATIONS** 

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9.22.2022

(Revisions)

SITE PLAN

**DESIGN REVIEW** 



### City of Mesa Planning Division

## **AFFIDAVIT OF PUBLIC POSTING**

Date: 10/31/22
I, Meghan Liggett, being the owner or authorized agent for the zoning case below do hereby affirm that I have posted the property related to case # ZON22-00731
on SWC MCDowell Rd & Greenfield Rd . The posting was in one place with one notice for eac quarter mile of frontage along perimeter right-of-way so that the notices were visible from the nearest public right-of-way.
SUBMIT PHOTOGRAPHS OF THE POSTINGS MOUNTED ON AN 8.5"
BY 11" SHEET OF PAPER WITH THIS AFFIDAVIT.  Applicant's/Representative's signature:
SUBSCRIBED AND SWORN before me on 10/3 V22
Notary Public MaryBeth Conrad
Notary Public - Arizona Maricopa County Commission # 591461 My Comm Expires Oct 25, 2024



