

- . PROPOSED CONCRETE TILT PANEL BUILDING WITH STEEL
- . FIRE PUMP / RISER ROOM. 5. HOUSE ELECTRICAL ROOM WITH ROOF ACCESS.
- 4. SES LOCATION WITH UTILITY TRANSFORMER. 6. TYPICAL REFUSE AND RECYCLE AREA FOR PROSPECTIVE TENANTS LOCATED IN THE ENCLOSED DOCK YARD BEHIND
- 8' HIGH WALL WITH 50' CLEAR SPACE IN FRONT OF BINS. 8. ACCESSIBLE PATH TO PUBLIC WAY
- 9. FIRE DEPARTMENT CONNECTION 11. CONCRETE DRIVE UP RAMP TO THE BUILDING WITH
- CONCRETE GUARD RAILS . FUTURE SES LOCATION WITH UTILITY TRANSFORMER  $\sim$ 18. PRELIMINARY MONUMENT SIGN LOCATION - SEPARATE
- '. EXISTING STREET LIGHT TO BE RELOCATED 28. PROPOSED LOCATION FOR STREET LIGHT
- 45. EXISTING DRIVEWAY TO BE REMOVED
- 46. CONCRETE CURB AND SIDEWALK TO MATCH EXISTING. REFER TO CIVIL DRAWINGS
- 47. EXISTING CURB, SIDEWALK AND LANDSCAPING TO BE 48. CONCRETE CURB, SIDEWALK, AND PAVING. REFER TO CIVIL
- 50. PROVIDE STAMPED CONCRETE AT PEDESTRIAN CROSS DRIVE AISLE WALKWAYS.

### SITE NOTES

- A. OVERNIGHT STORAGE OF VEHICLES IN THE REAR YARD IS CONSIDERED OUTDOOR STORAGE AND, PER EXHIBIT 7.38 (OF SECTION 7) OF THE CP, OUTDOOR STORAGE REQUIRES AN ADMINISTRATIVE USE PERMIT. AN ADMINISTRATIVE USE PERMIT APPLICATION IS REQUIRED IF THERE WILL BE ANY OVERNIGHT STORAGE OF FLEET OR OTHER VEHICLES IN THE GATED YARDS.
- PER MESA AMENDED FIRE CODE SECTION 510.1 NEW BUILDINGS SHALL HAVE APPROVED RADIO COVERAGE FOR EMERGENCY RESPONDERS WITHIN THE BUILDING. BUILDINGS OR STRUCTURES MORE THAN THREE STORIES ABOVE GROUND LEVEL OR BUILDINGS OR STRUCTURES TOTALING 45,000 SF OR MORE ON ANY SINGLE FLOOR. GC SHALL COORDINATE WITH ARCHITECT DURING CONSTRUCTION.
- ALL MONUMENT SIGNAGE AND BUILDING SIGNAGE WILL BE DEFFERED SUBMITTAL.

### ADA ACCESSIBLE / PEDESTRIAN WALKWAYS

→→>>>>> ADA ACCESSIBLE WALK WAYS

NOTE: WALK WAYS ARE MIN 5' WIDE 6" RAISED CONCRETE SIDEWALKS OUT OF THE LINE OF TRAFFIC. SIDEWALK WALK LOCATIONS THAT CROSS A DRIVE LANE, ARE BUILT OUT OF STAMPED CONCRETE.

### LANDSCAPE LEGEND




COMMON AREA



ENTRY AREA



FOUNDATION AREA

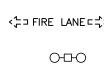


SITE LIGHT POLE LOCATIONS - REFER TO ELECTRICAL DRAWINGS.

NEW FIRE HYDRANT

FIRE TRUCK LANE ACCESS OR DRIVE.



SITE VISIBILITY TRIANGLE AREA PER COM

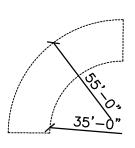

TYPICAL TURNING RADIUS

### SITE DATA

COMMON, ENTRY AND FOUNDATION AREAS

- BUILDING A \* COMMON AREA REQUIRED: 2,250 SF PROVIDED: 2,898 SF ENTRY AREA REQUIRED: 900 SF PROVIDED: 2,011 SF FOUNDATION AREA REQUIRED: 13,260 SF PROVIDED: 13,267 SF
- COMMON AREA REQUIRED: 4,081 SF ENTRY AREA REQUIRED: 900 SF PROVIDED: 3,762 SF FOUNDATION AREA REQUIRED: 15,000 SF PROVIDED: 20,075 SF

REQUIRED: 2,250 SF PROVIDED: 2,561 SF REQUIRED: 900 SF PROVIDED: 2,014 SF FOUNDATION AREA REQUIRED: 13,260 SF PROVIDED: 13,264 SF

### SITE DATA

**PROJECT DESCRIPTION:** 

DEVELOPMENT OF EXISTING VACANT LAND INTO AN INDUSTRIAL BUSINESS PARK WITH MIXTURE OF BUILDING SIZES AND HEIGHTS, ALL BUILDINGS WILL HAVE COMPLEMENTARY ARCHITECTURAL STYLES.

POSSIBLE USERS INCLUDE MANUFACTURE, WAREHOUSE, AND OFFICE. BUILDINGS ARE DESIGNED TO ACCOMMODATE A SINGLE TENANT OR MULTIPLE TENANTS.

#### PARCEL NUMBER:

APN: 304-31-002Q

ZONING: PC LUG-C (AIRFIELD OVERLAY AREA AOA 3)

B, F-1 SITE AREA:

PROPOSED OCCUPANCIES:

1,911,177 SF / ±39.28 ACRES

CONSTRUCTION TYPE: III-B W/ FIRE SPRINKLER

**BUILDING AREA** PRELIMINARY OCCUPANCY PHASE 1

BUILDING A: 225,000 SF (B 22,500 SF) BUILDING B: 408,198 SF (B 40,800 SF) BUILDING C: 225,000 SF (B 22,500 SF)

TOTAL: 858,198 SF

**BUILDING HEIGHT RESTRICTION:** ALLOWED MAX HEIGHT 150' PROVIDED 45'-55'

LANDSCAPE SETBACKS: BUILDING SETBACKS: PER MZO

FRONT - 20' FRONT - 20' REAR - 0' REAR - 0' SIDE - 0' SIDE - 0'

### PARKING CALCULATIONS

COMMUNITY PLAN SECTION 14.3 GENERAL PARKING STANDARDS (SHELL BUILDING) PARKING CALCULÁTION: BUILDING A: 225,000 SF / 1000 = 225 226 23BUILDING B: 408,198 SF / 1000 = 409 409 41

BUILDING C: 225,000 SF / 1000 = 225 225 23 REQUIRED: 859 PROVIDED: 860 TOTAL PARKING TOTAL BIKE PARKING REQUIRED: 87 PROVIDED: 90


ALL BUILDINGS TO BE BUILT IN ONE PHASE.

ACCESSIBLE PARKING SPACES REQUIRED (2% OF TOTAL) = 18 ACCESSIBLE PARKING PROVIDED = 22

### DEFERRED/ SEPARATE **SUBMITTALS**

ANTICIPATED DEFERRED/SEPARATE SUBMITTALS: FIRE SPRINKLER BY GENERAL CONTRACTOR FIRE ALARM— IF REQUIRED BY TENANT SIGNAGE - SEPARATE PERMIT RACKING - IF REQUIRED BY TENANT

# VICINITY MAP

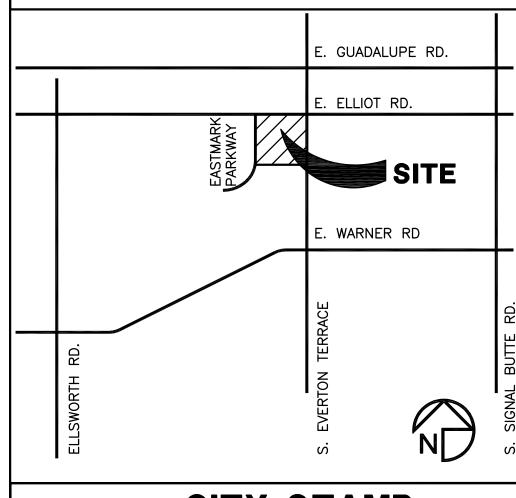

### CITY STAMP

PRS21-00146

PROJECT NO: 22108 DRAWN BY: ET CHK'D BY: KO

COPYRIGHT 2022: DEUTSCH ARCHITECTURE GROUP

**OVERALL SITE** PLAN

**AS-100** 

]2929.COM 0 5 ш 




A Views 4600 **EAST INDIAN SCHOOL RD** 

PHOENIX, ARIZONA 85018 602-840-2929 P 602-840-6646 F

CENTER TERR. OGISTICS
AND EVERTON
SA, AZ EASTMARK 202 LO SWC OF ELLIOT RD. A MESA,

1ST ISSUED: 03/01/22 Revisions O. DATE DESCRIPTION 8/3/22 P&Z AND

EASTMARK COMMENTS

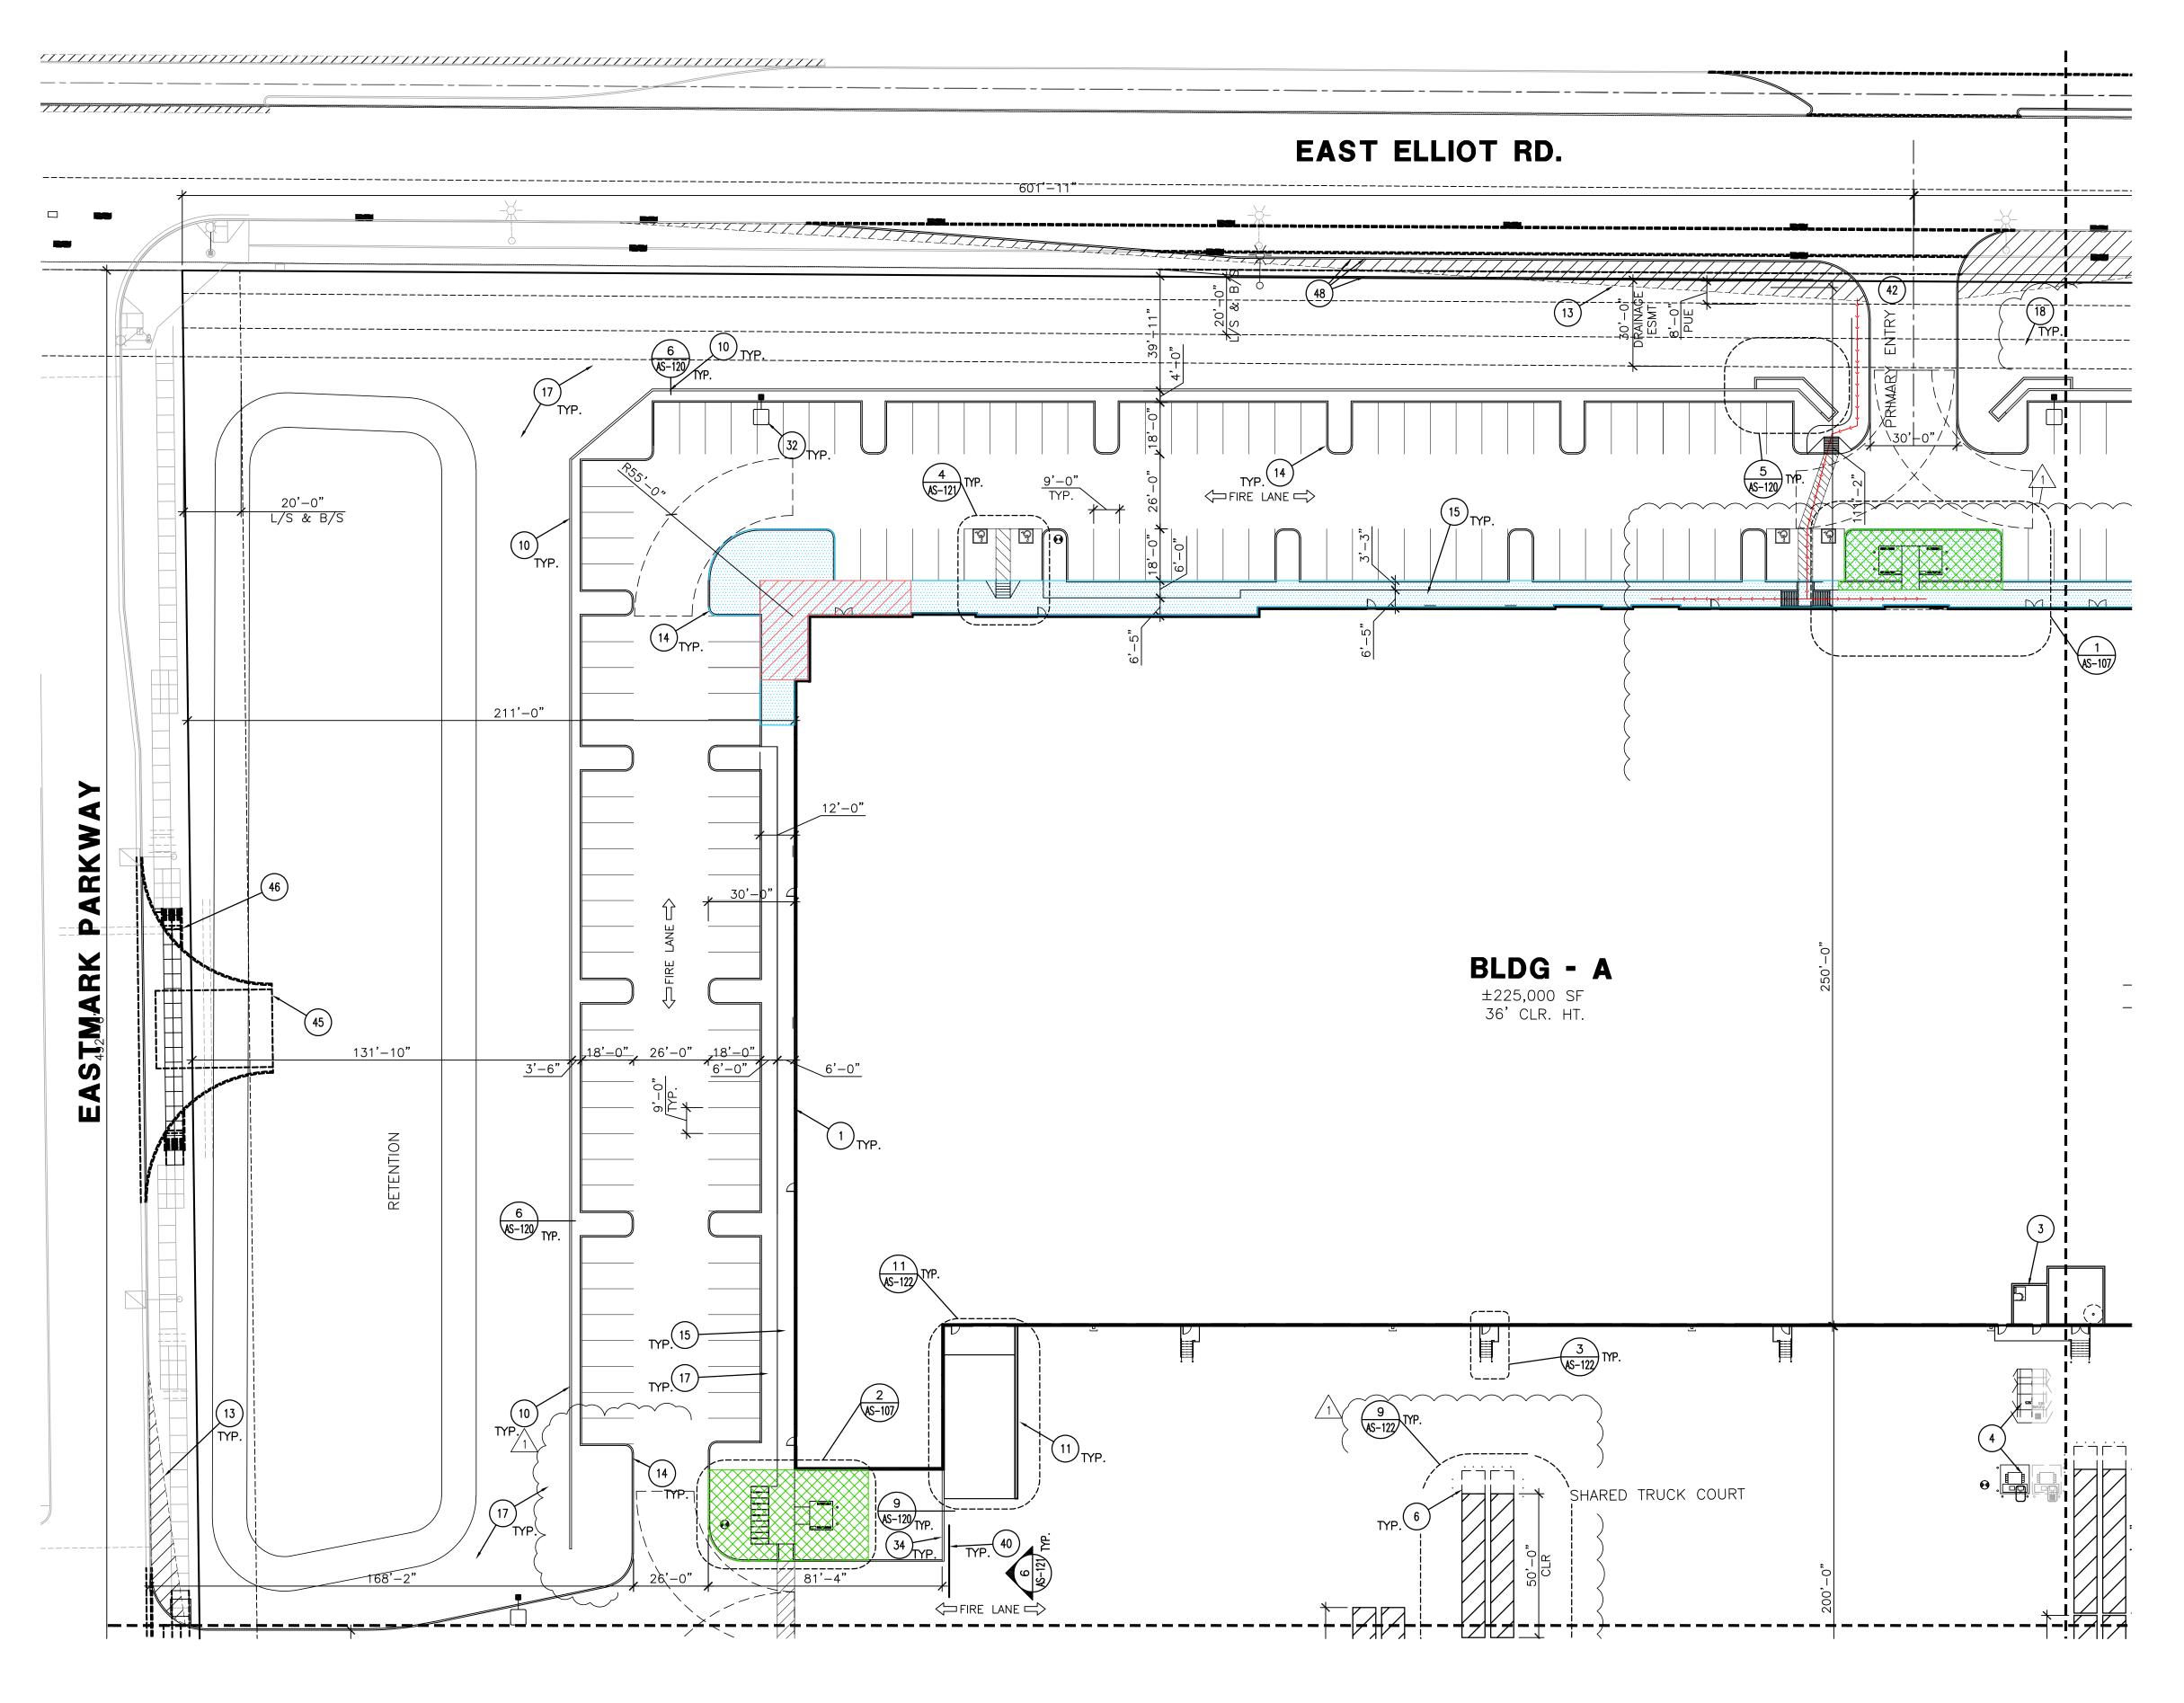

- 1. PROPOSED CONCRETE TILT PANEL BUILDING WITH STEEL
- COLUMNS. 3. HOUSE ELECTRICAL ROOM WITH ROOF ACCESS. 4. SES LOCATION WITH UTILITY TRANSFORMER.
- 6. TYPICAL REFUSE AND RECYCLE AREA FOR PROSPECTIVE TENANTS LOCATED IN THE ENCLOSED DOCK YARD BEHIND 8' HIGH WALL WITH 50' CLEAR SPACE IN FRONT OF BINS. 10. 3'-4" HIGH MASONRY PARKING SCREEN WALL. 11. CONCRETE DRIVE UP RAMP TO THE BUILDING WITH
- CONCRETE GUARD RAILS 13. TRAFFIC VISIBILITY TRIANGLES
- 14. 6" CONCRETE CURB
  15. CONCRETE SIDE WALK MIN, 6' WIDE LANDSCAPE AREA - REFER TO LANDSCAPE PLANS $\sim$ 18. PRELIMINARY MONUMENT SIGN LOCATION — SEPARATE PERMIT REQUIRED.
- 32. SITE LIGHT POLE PER ELECTRICAL 34. 8' HIGH MASONRY SCREEN WALL
- 40. 8' HIGH WROUGHT IRON WITH PERFORATED METAL SCREEN SECURITY GATES, REFER TO SITE DETAIL 11/AS-120. GATES WILL BE OPEN DURING BUSINESS HOURS.
- 42. DRIVEWAY PER CITY OF MESA STANDARDS. REFER TO CIVIL. 45. EXISTING DRIVEWAY TO BE REMOVED 46. CONCRETE CURB AND SIDEWALK TO MATCH EXISTING.
- REFER TO CIVIL DRAWINGS 48. CONCRETE CURB, SIDEWALK, AND PAVING. REFER TO CIVIL

### LANDSCAPE LEGEND



COMMON AREA




ENTRY AREA




FOUNDATION AREA

FIRE TRUCK LANE ACCESS OR DRIVE.

SITE LIGHT POLE LOCATIONS - REFER TO ELECTRICAL DRAWINGS.

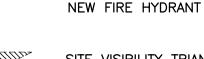



SITE VISIBILITY TRIANGLE AREA PER COM

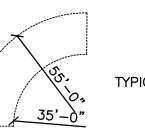


TYPICAL TURNING RADIUS

### **KEYPLAN**

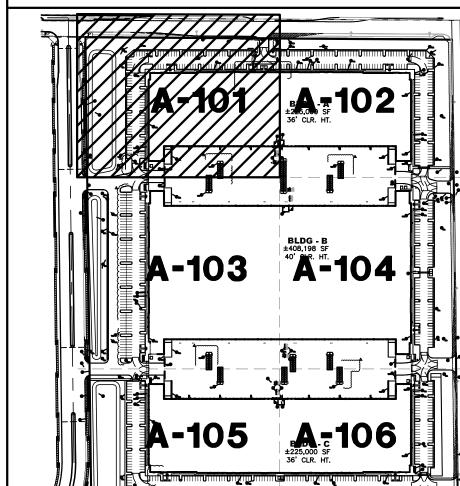

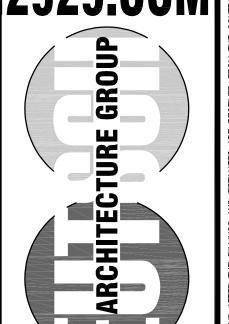

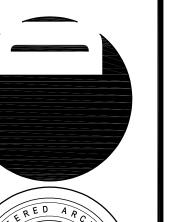



4600 **EAST INDIAN SCHOOL RD** PHOENIX, ARIZONA 85018 602-840-2929 P 602-840-6646 F

CENTER TERR.

OGISTICS (AND EVERTON SA, AZ EASTMARK 202 LO SWC OF ELLIOT RD. AI MESA,

1ST ISSUED: 5/31/22 Revisions


NO. DATE DESCRIPTION


1 8/3/22 P&Z AND
EASTMARK
COMMENTS


PROJECT NO: 22108

DRAWN BY: ET CHK'D BY: KO COPYRIGHT 2022: DEUTSCH ARCHITECTURE GROUP

**BUILDING A PARTIAL SITE** PLAN

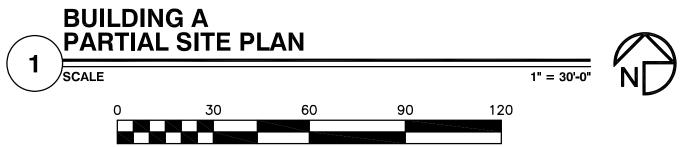

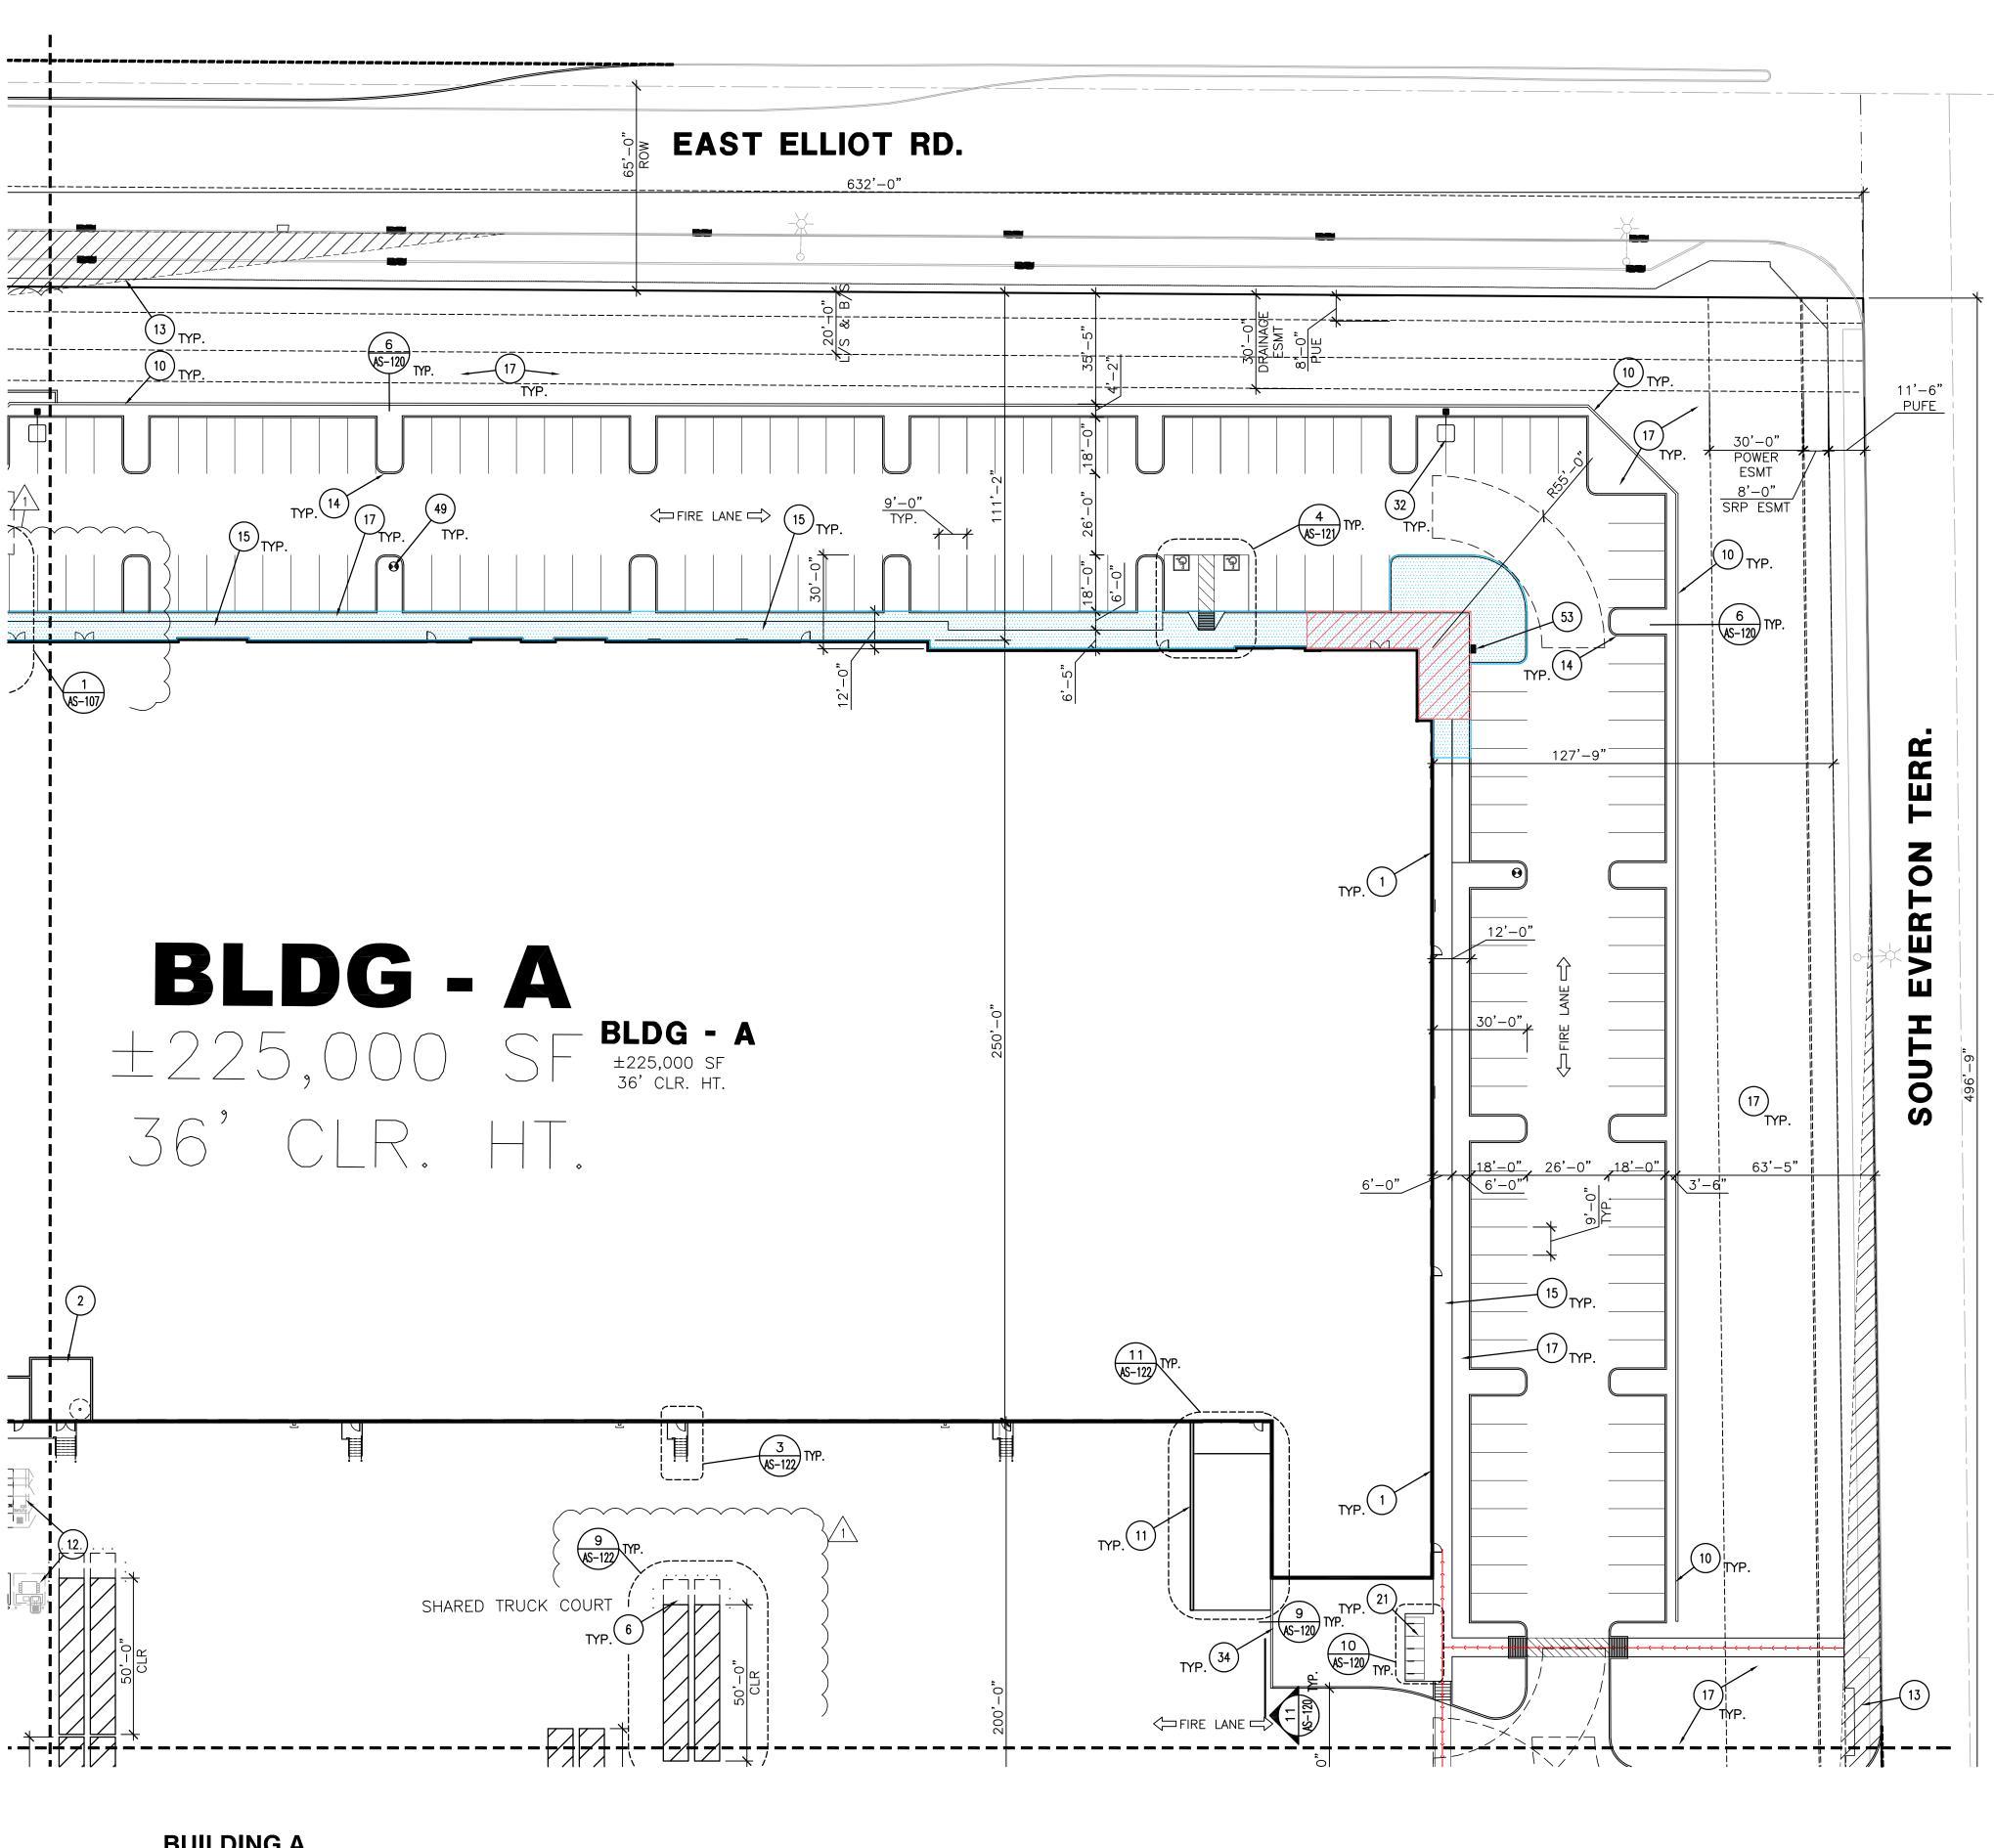

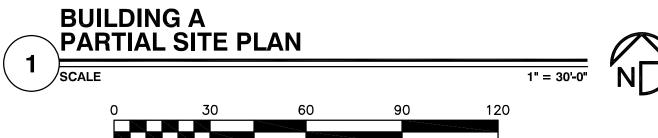

- 1. PROPOSED CONCRETE TILT PANEL BUILDING WITH STEEL
- COLUMNS.

  2. FIRE PUMP / RISER ROOM.

  6. TYPICAL REFUSE AND RECYCLE AREA FOR PROSPECTIVE TENANTS LOCATED IN THE ENCLOSED DOCK YARD BEHIND
- TENANTS LOCATED IN THE ENCLOSED DOCK YARD BEHIND 8' HIGH WALL WITH 50' CLEAR SPACE IN FRONT OF BINS.

  10. 3'-4" HIGH MASONRY PARKING SCREEN WALL.


  11. CONCRETE DRIVE UP RAMP TO THE BUILDING WITH
- CONCRETE GUARD RAILS

  12. FUTURE SES LOCATION WITH UTILITY TRANSFORMER

  13. TRAFFIC VISIBILITY TRIANGLES
- 14. 6" CONCRETE CURB

  15. CONCRETE SIDE WALK MIN 6' WIDE
- 15. CONCRETE SIDE WALK MIN, 6' WIDE 17. LANDSCAPE AREA — REFER TO LANDSCAPE PLANS 21. BIKE PARKING
- 32. SITE LIGHT POLE PER ELECTRICAL
  34. 8' HIGH MASONRY SCREEN WALL
  47. EXISTING CURB, SIDEWALK AND LANDSCAPING TO BE
- 49. FIRE HYDRANT REFER TO CIVIL
  53. 8 DOOR CLUSTER BOX UNIT WITH PEDESTAL IN MORTAR GREY
  FINISH TO MATCH ELEVATIONS

### LANDSCAPE LEGEND

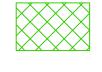

COMMON AREA



ENTRY AREA



FOUNDATION AREA




FIRE TRUCK LANE ACCESS OR DRIVE.


SITE LIGHT POLE LOCATIONS - REFER TO



ELECTRICAL DRAWINGS.

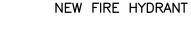


SITE VISIBILITY TRIANGLE AREA PER COM

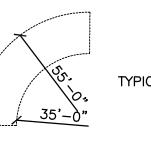


TYPICAL TURNING RADIUS

# KEYPLAN

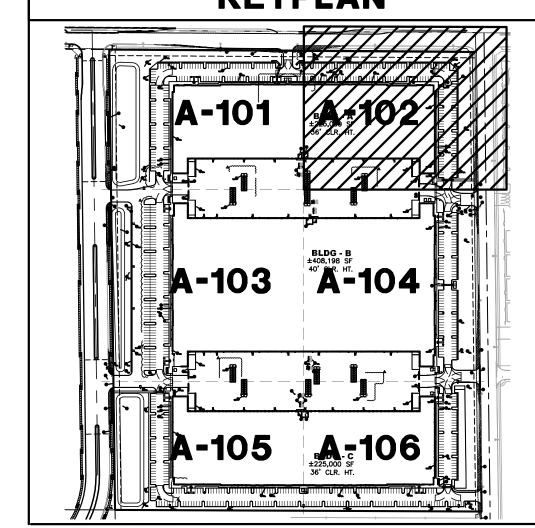

# **|2929.COM**

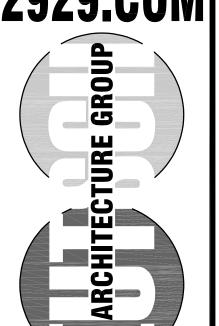





4600 EAST INDIAN SCHOOL RD PHOENIX, ARIZONA 85018 602-840-2929 P 602-840-6646 F

ENIX, ARIZUNA 85018 602-840-2929 P 602-840-6646 F

EASTMARK 202 LOGISTICS C SWC OF ELLIOT RD. AND EVERTON TI MESA, AZ

1ST ISSUED: 5/31/22

Revisions


NO. DATE DESCRIPTION

1 8/3/22 P&Z AND
EASTMARK
COMMENTS

PROJECT NO: 22108

DRAWN BY: ET
CHK'D BY: KO
COPYRIGHT 2022: DEUTSCH
ARCHITECTURE GROUP

BUILDING A PARTIAL SITE PLAN

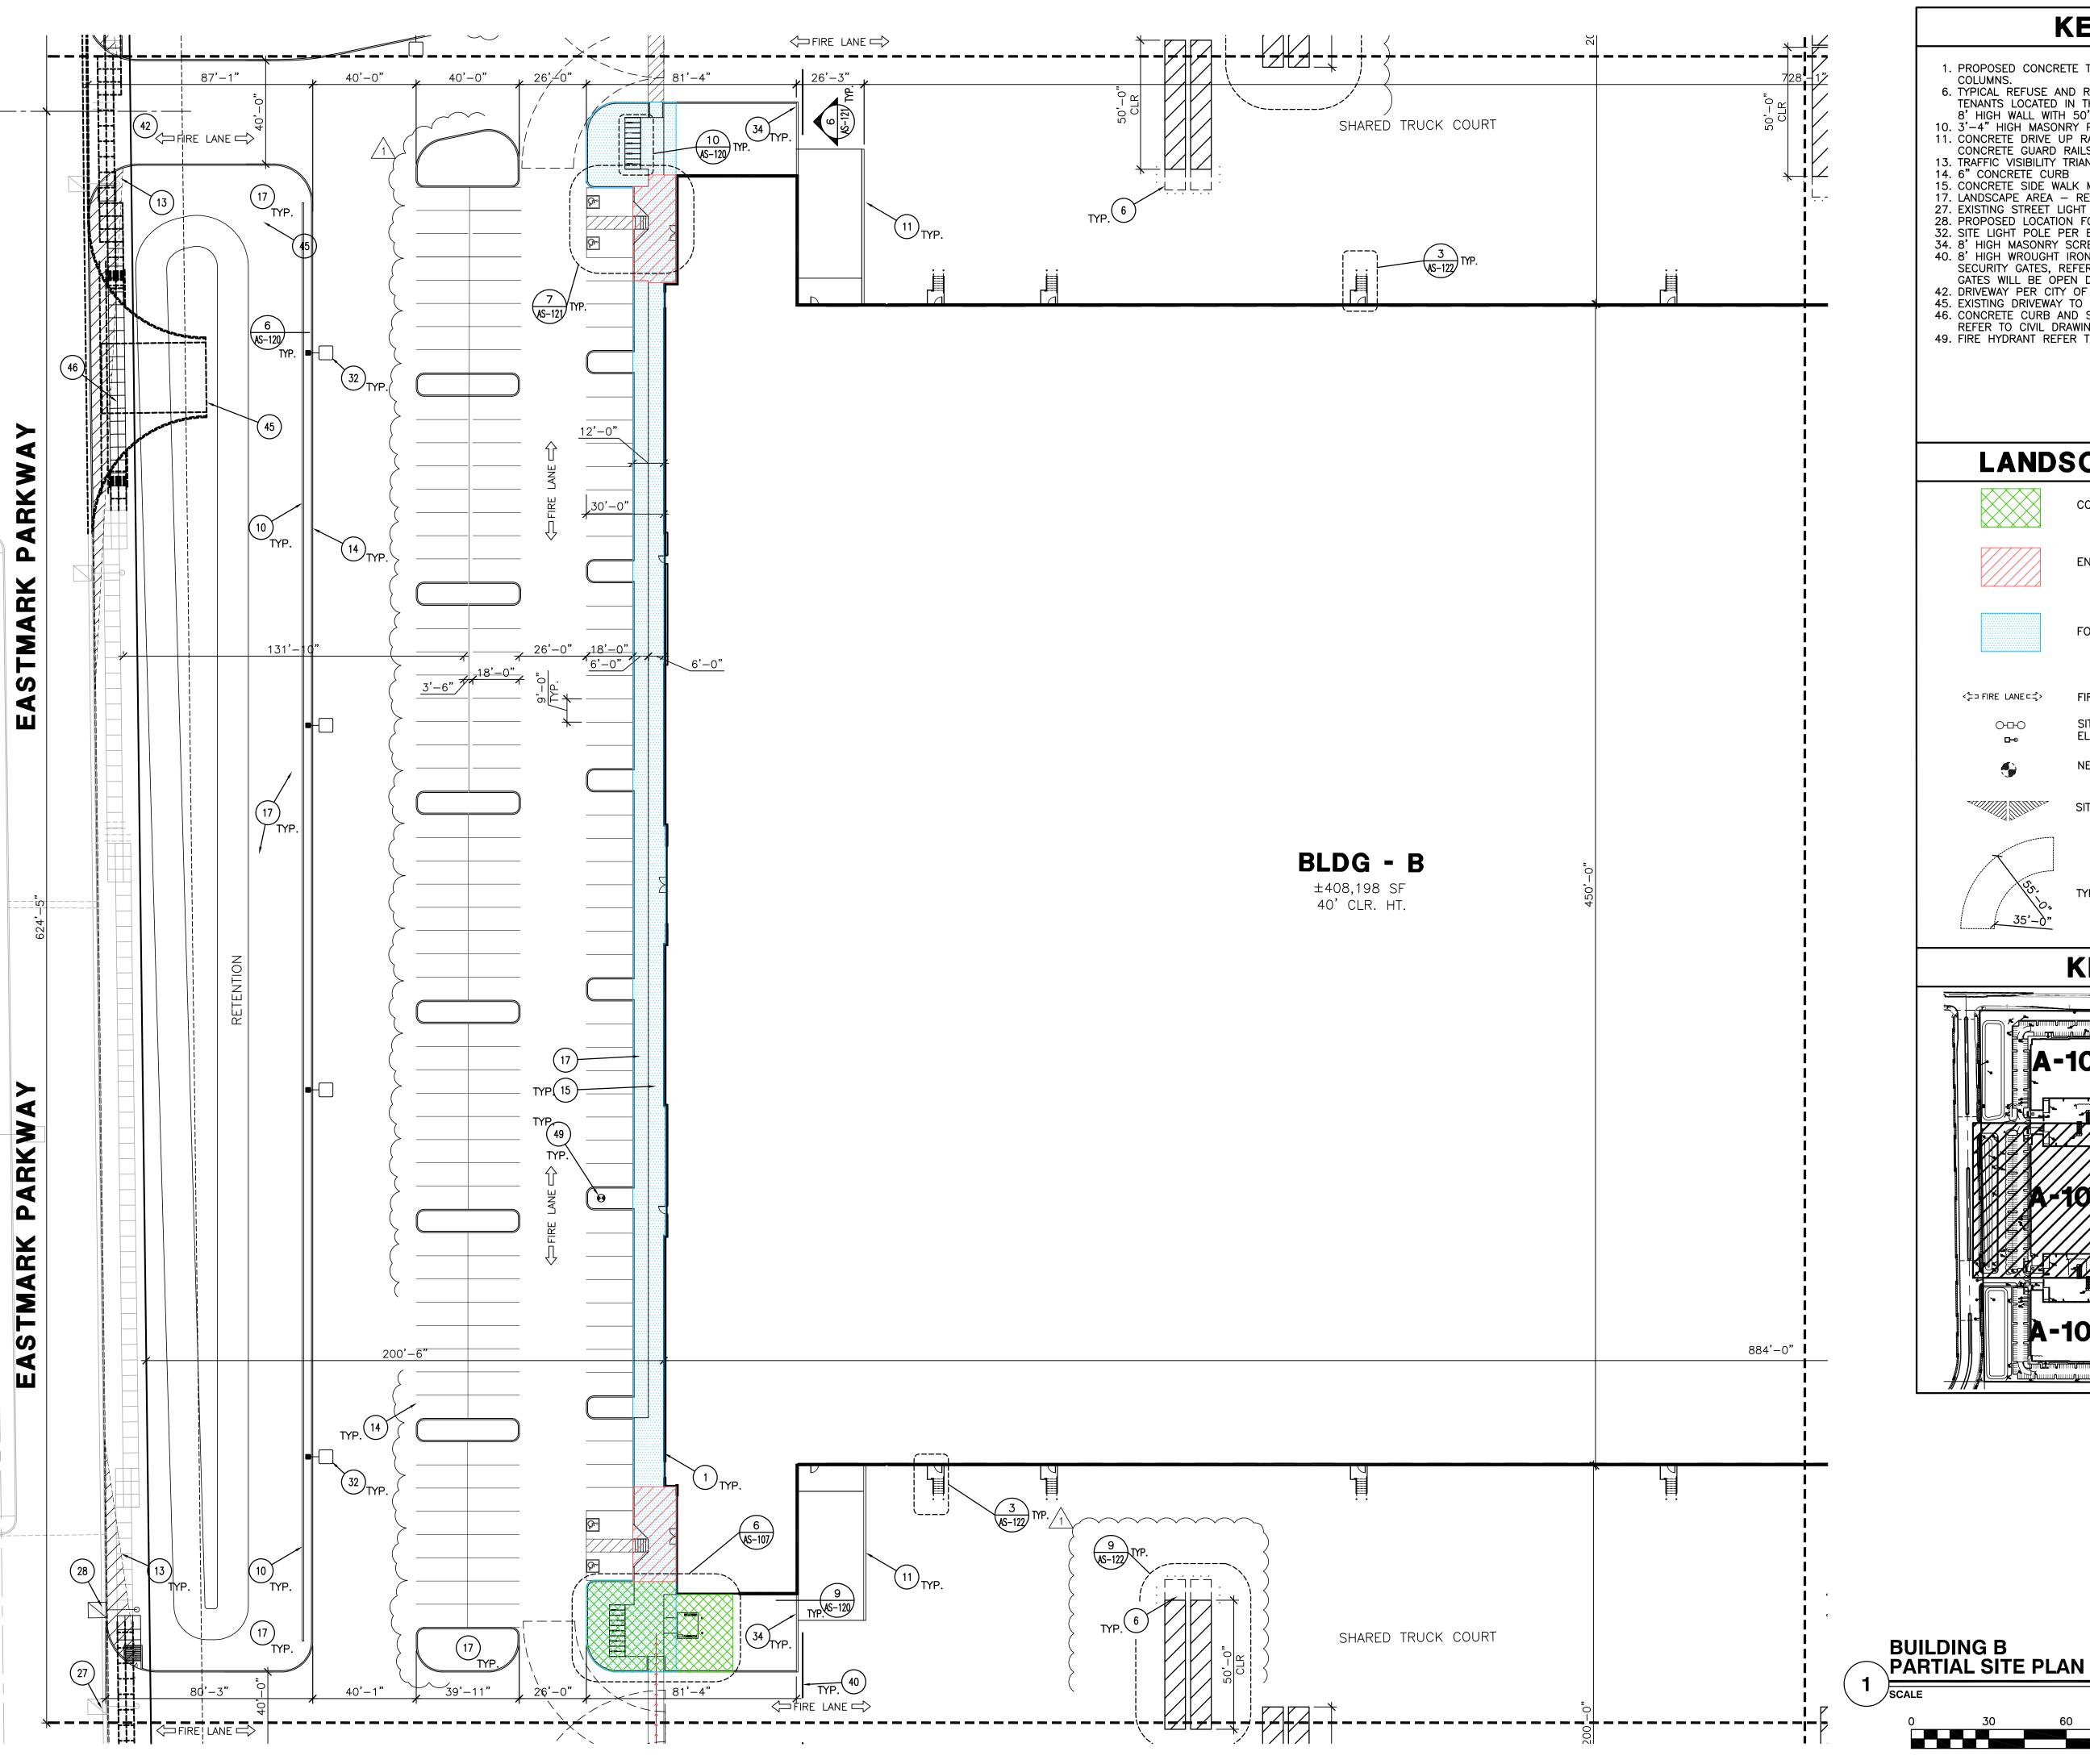

- 1. PROPOSED CONCRETE TILT PANEL BUILDING WITH STEEL COLUMNS.
- 6. TYPICAL REFUSE AND RECYCLE AREA FOR PROSPECTIVE TENANTS LOCATED IN THE ENCLOSED DOCK YARD BEHIND 8' HIGH WALL WITH 50' CLEAR SPACE IN FRONT OF BINS. 10. 3'-4" HIGH MASONRY PARKING SCREEN WALL.
- 11. CONCRETE DRIVE UP RAMP TO THE BUILDING WITH CONCRETE GUARD RAILS 13. TRAFFIC VISIBILITY TRIANGLES
- 14. 6" CONCRETE CURB 15. CONCRETE SIDE WALK MIN, 6' WIDE
- 17. LANDSCAPE AREA REFER TO LANDSCAPE PLANS 27. EXISTING STREET LIGHT TO BE RELOCATED 28. PROPOSED LOCATION FOR STREET LIGHT 32. SITE LIGHT POLE PER ELECTRICAL
- 34. 8' HIGH MASONRY SCREEN WALL 40. 8' HIGH WROUGHT IRON WITH PERFORATED METAL SCREEN SECURITY GATES, REFER TO SITE DETAIL 11/AS-120. GATES WILL BE OPEN DURING BUSINESS HOURS.
- 42. DRIVEWAY PER CITY OF MESA STANDARDS. REFER TO CIVIL. 45. EXISTING DRIVEWAY TO BE REMOVED 46. CONCRETE CURB AND SIDEWALK TO MATCH EXISTING. REFER TO CIVIL DRAWINGS
- 49. FIRE HYDRANT REFER TO CIVIL

# LANDSCAPE LEGEND



COMMON AREA



ENTRY AREA



FOUNDATION AREA


ELECTRICAL DRAWINGS.

<;== FIRE LANE=;=>

FIRE TRUCK LANE ACCESS OR DRIVE. SITE LIGHT POLE LOCATIONS - REFER TO


NEW FIRE HYDRANT

SITE VISIBILITY TRIANGLE AREA PER COM

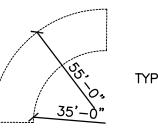

TYPICAL TURNING RADIUS

# **KEYPLAN**

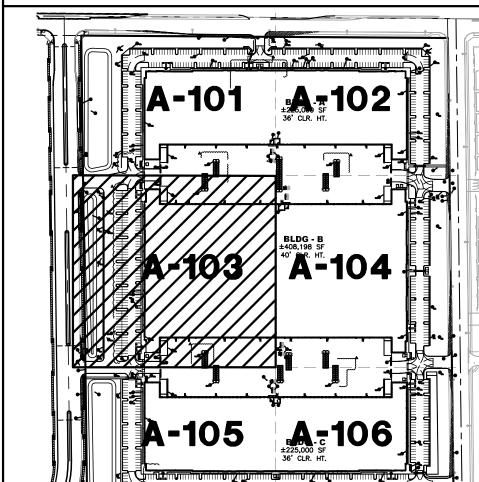

EASTMARK 202 LO SWC OF ELLIOT RD. AI MESA, 1ST ISSUED: 5/31/22

Revisions NO. DATE DESCRIPTION 1 8/3/22 P&Z AND EASTMARK COMMENTS

0

ш

4

KAREN OHMANN

4600

EAST INDIAN SCHOOL RD PHOENIX, ARIZONA 85018 602-840-2929 P

602-840-6646 F


CENTER TERR.

OGISTICS
AND EVERTON
A, AZ

PROJECT NO: 22108

DRAWN BY: ET CHK'D BY: KO COPYRIGHT 2022: DEUTSCH ARCHITECTURE GROUP

**BUILDING B PARTIAL SITE** PLAN

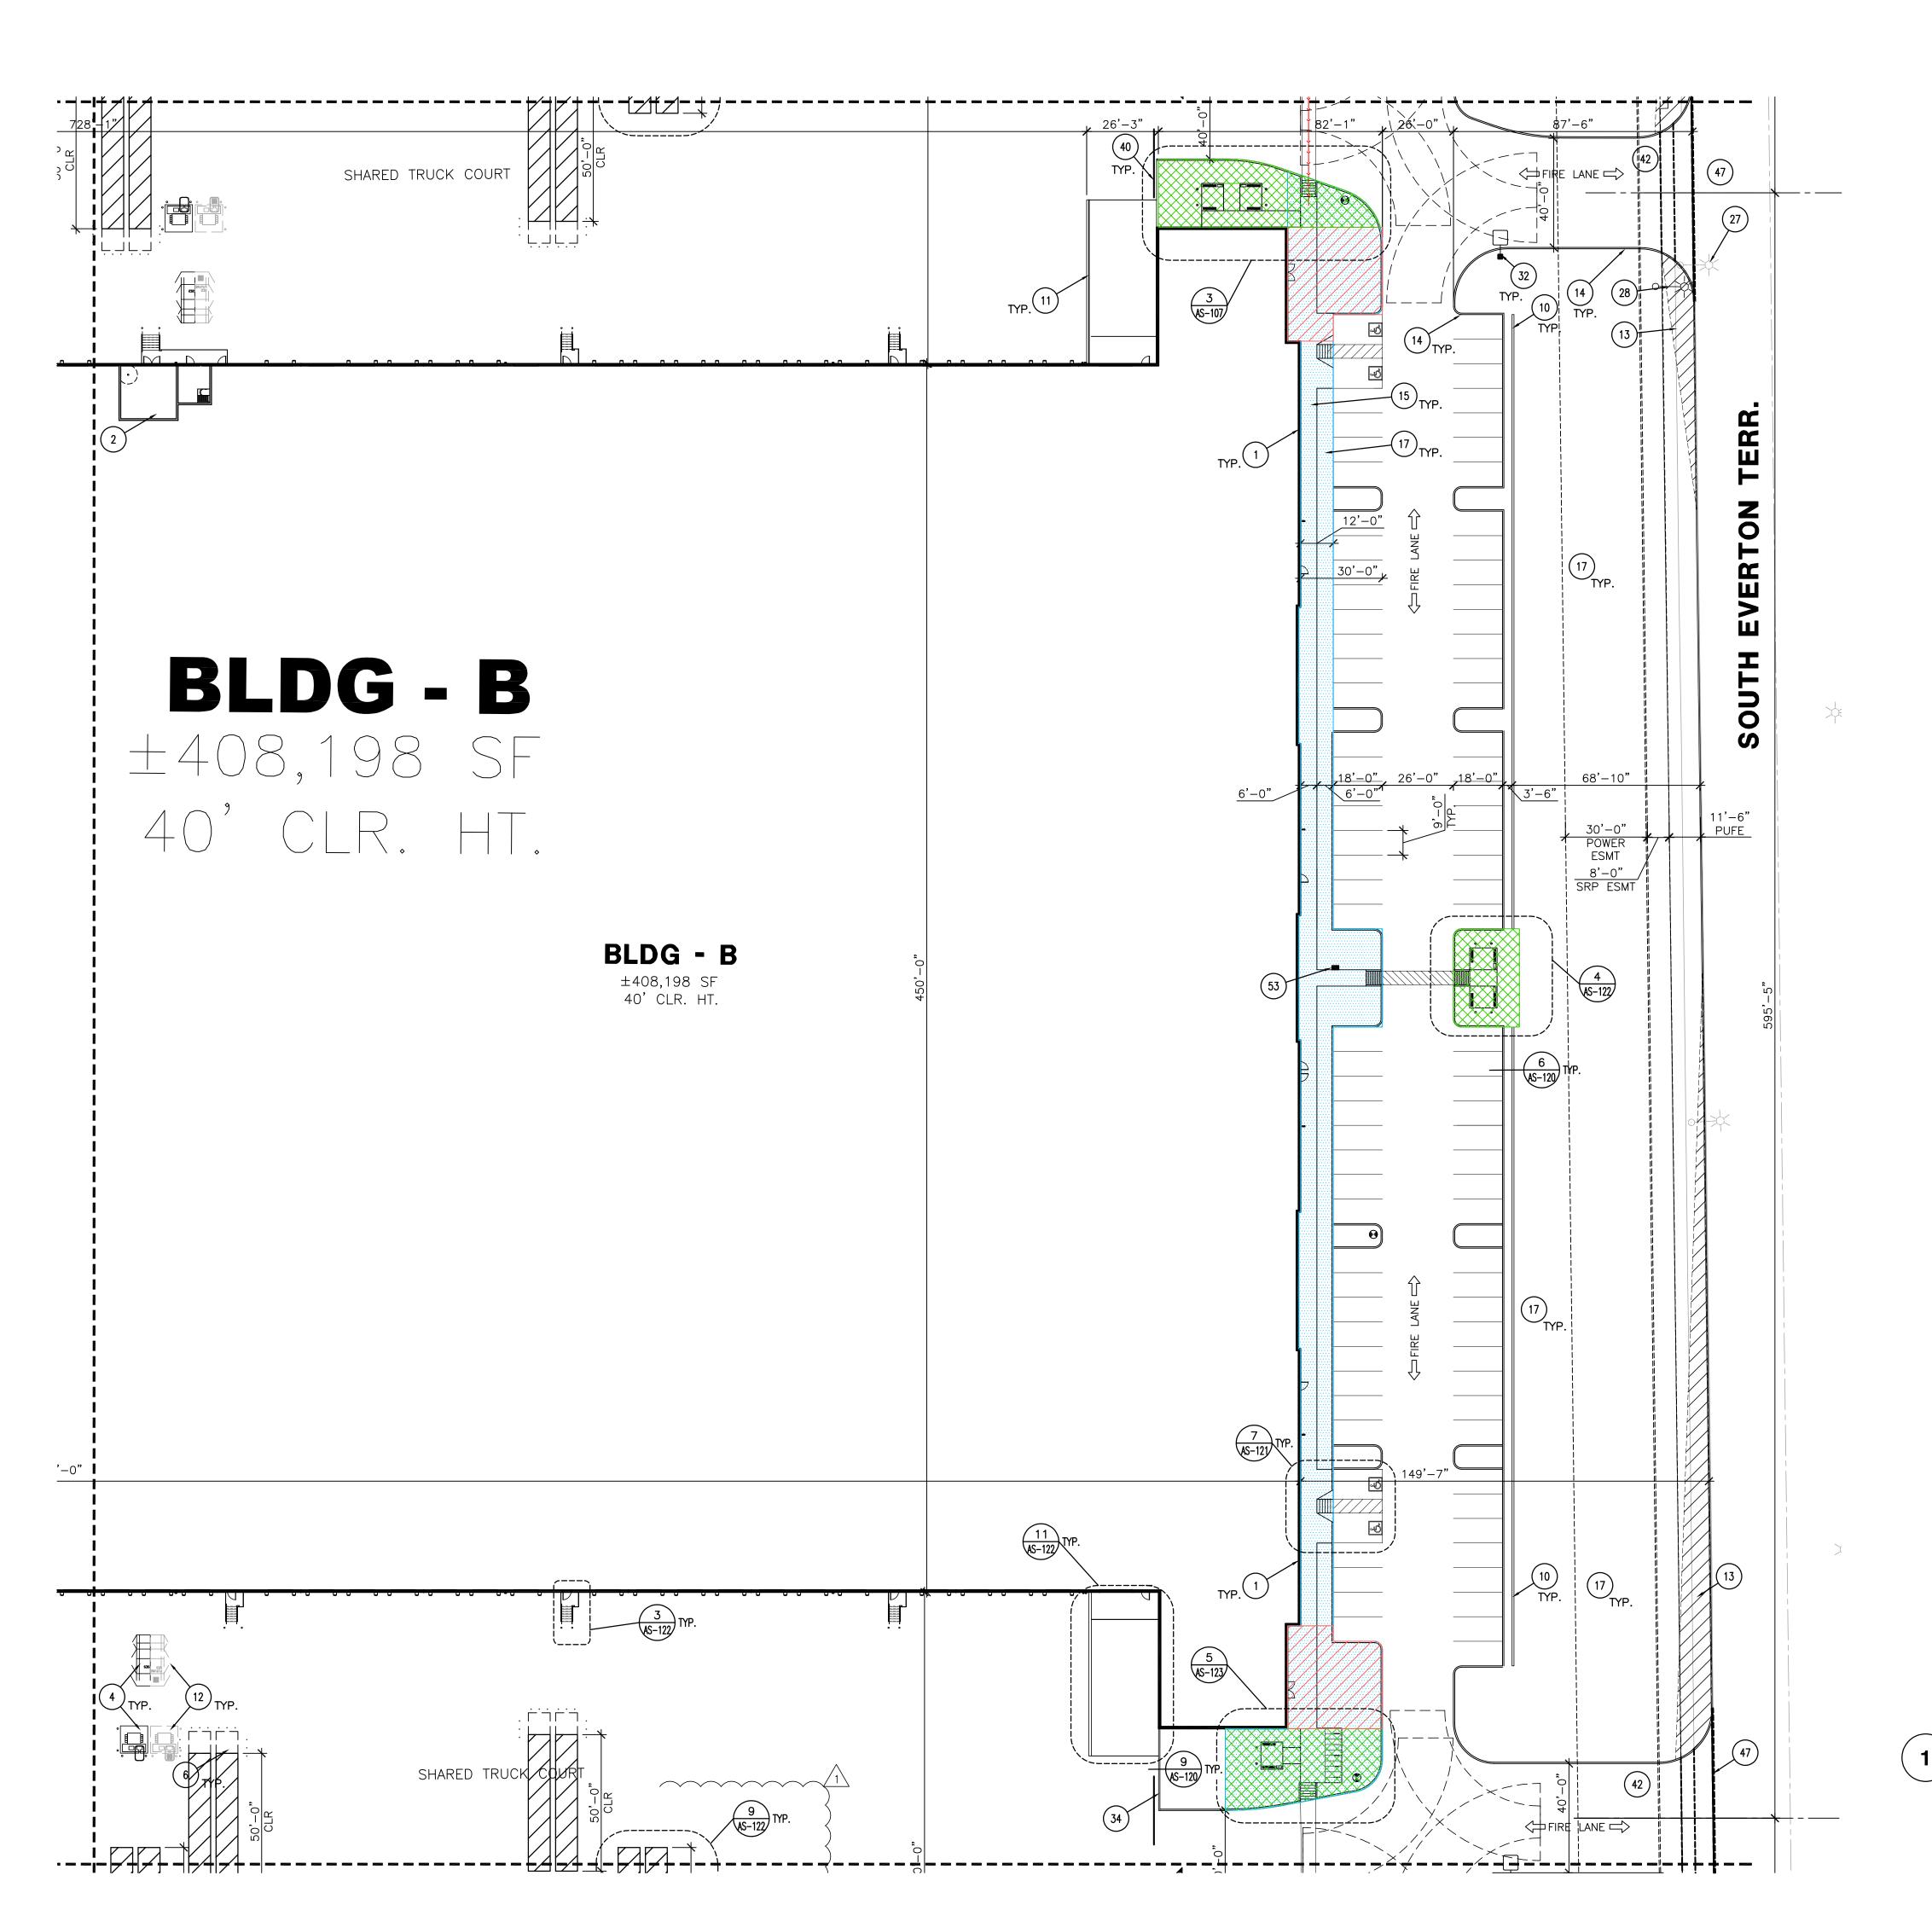

- 1. PROPOSED CONCRETE TILT PANEL BUILDING WITH STEEL

- COLUMNS.

  2. FIRE PUMP / RISER ROOM.

  4. SES LOCATION WITH UTILITY TRANSFORMER.

  6. TYPICAL REFUSE AND RECYCLE AREA FOR PROSPECTIVE TENANTS LOCATED IN THE ENCLOSED DOCK YARD BEHIND 8' HIGH WALL WITH 50' CLEAR SPACE IN FRONT OF BINS. 10. 3'-4" HIGH MASONRY PARKING SCREEN WALL.
- 11. CONCRETE DRIVE UP RAMP TO THE BUILDING WITH CONCRETE GUARD RAILS
- 12. FUTURE SES LOCATION WITH UTILITY TRANSFORMER
  13. TRAFFIC VISIBILITY TRIANGLES
  14. 6" CONCRETE CURB
  15. CONCRETE SIDE WALK MIN, 6' WIDE
  17. LANDSCAPE AREA REFER TO LANDSCAPE PLANS
- 27. EXISTING STREET LIGHT TO BE RELOCATED 28. PROPOSED LOCATION FOR STREET LIGHT
- 32. SITE LIGHT POLE PER ELECTRICAL 34. 8' HIGH MASONRY SCREEN WALL 40. 8' HIGH WROUGHT IRON WITH PERFORATED METAL SCREEN
- SECURITY GATES, REFER TO SITE DETAIL 11/AS-120.
  GATES WILL BE OPEN DURING BUSINESS HOURS.
  42. DRIVEWAY PER CITY OF MESA STANDARDS. REFER TO CIVIL.
  47. EXISTING CURB, SIDEWALK AND LANDSCAPING TO BE
- 753. REMOVED STATE BOX UNIT WITH PEDESTAL IN MORTAR GREY
- FINISH, TO MATCH ELEVATIONS

### LANDSCAPE LEGEND



COMMON AREA



ENTRY AREA



FOUNDATION AREA


NEW FIRE HYDRANT

FIRE TRUCK LANE ACCESS OR DRIVE.

SITE LIGHT POLE LOCATIONS - REFER TO ELECTRICAL DRAWINGS.




SITE VISIBILITY TRIANGLE AREA PER COM

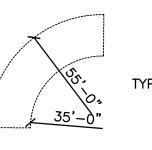

TYPICAL TURNING RADIUS

# **KEYPLAN**

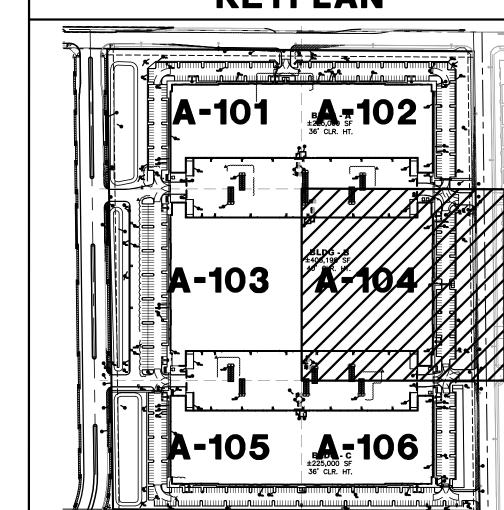

EASTMARK 202 LO SWC OF ELLIOT RD. A MESA, 1ST ISSUED: 5/31/22 Revisions

NO. DATE DESCRIPTION

L 8/3/22 P&Z AND EASTMARK COMMENTS

OGISTICS
AND EVERTON
SA, AZ

PROJECT NO: 22108


DRAWN BY: ET CHK'D BY: KO COPYRIGHT 2022: DEUTSCH ARCHITECTURE GROUP

**BUILDING B PARTIAL SITE** PLAN

**AS-104** 






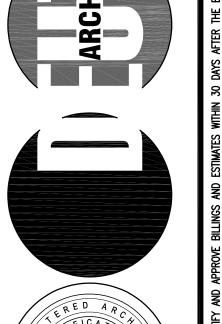

]2929.COM

ш

KAREN OHMANN of 4600 EAST INDIAN SCHOOL RD PHOENIX, ARIZONA 85018 602-840-2929 P 602-840-6646 F CENTER TERR.

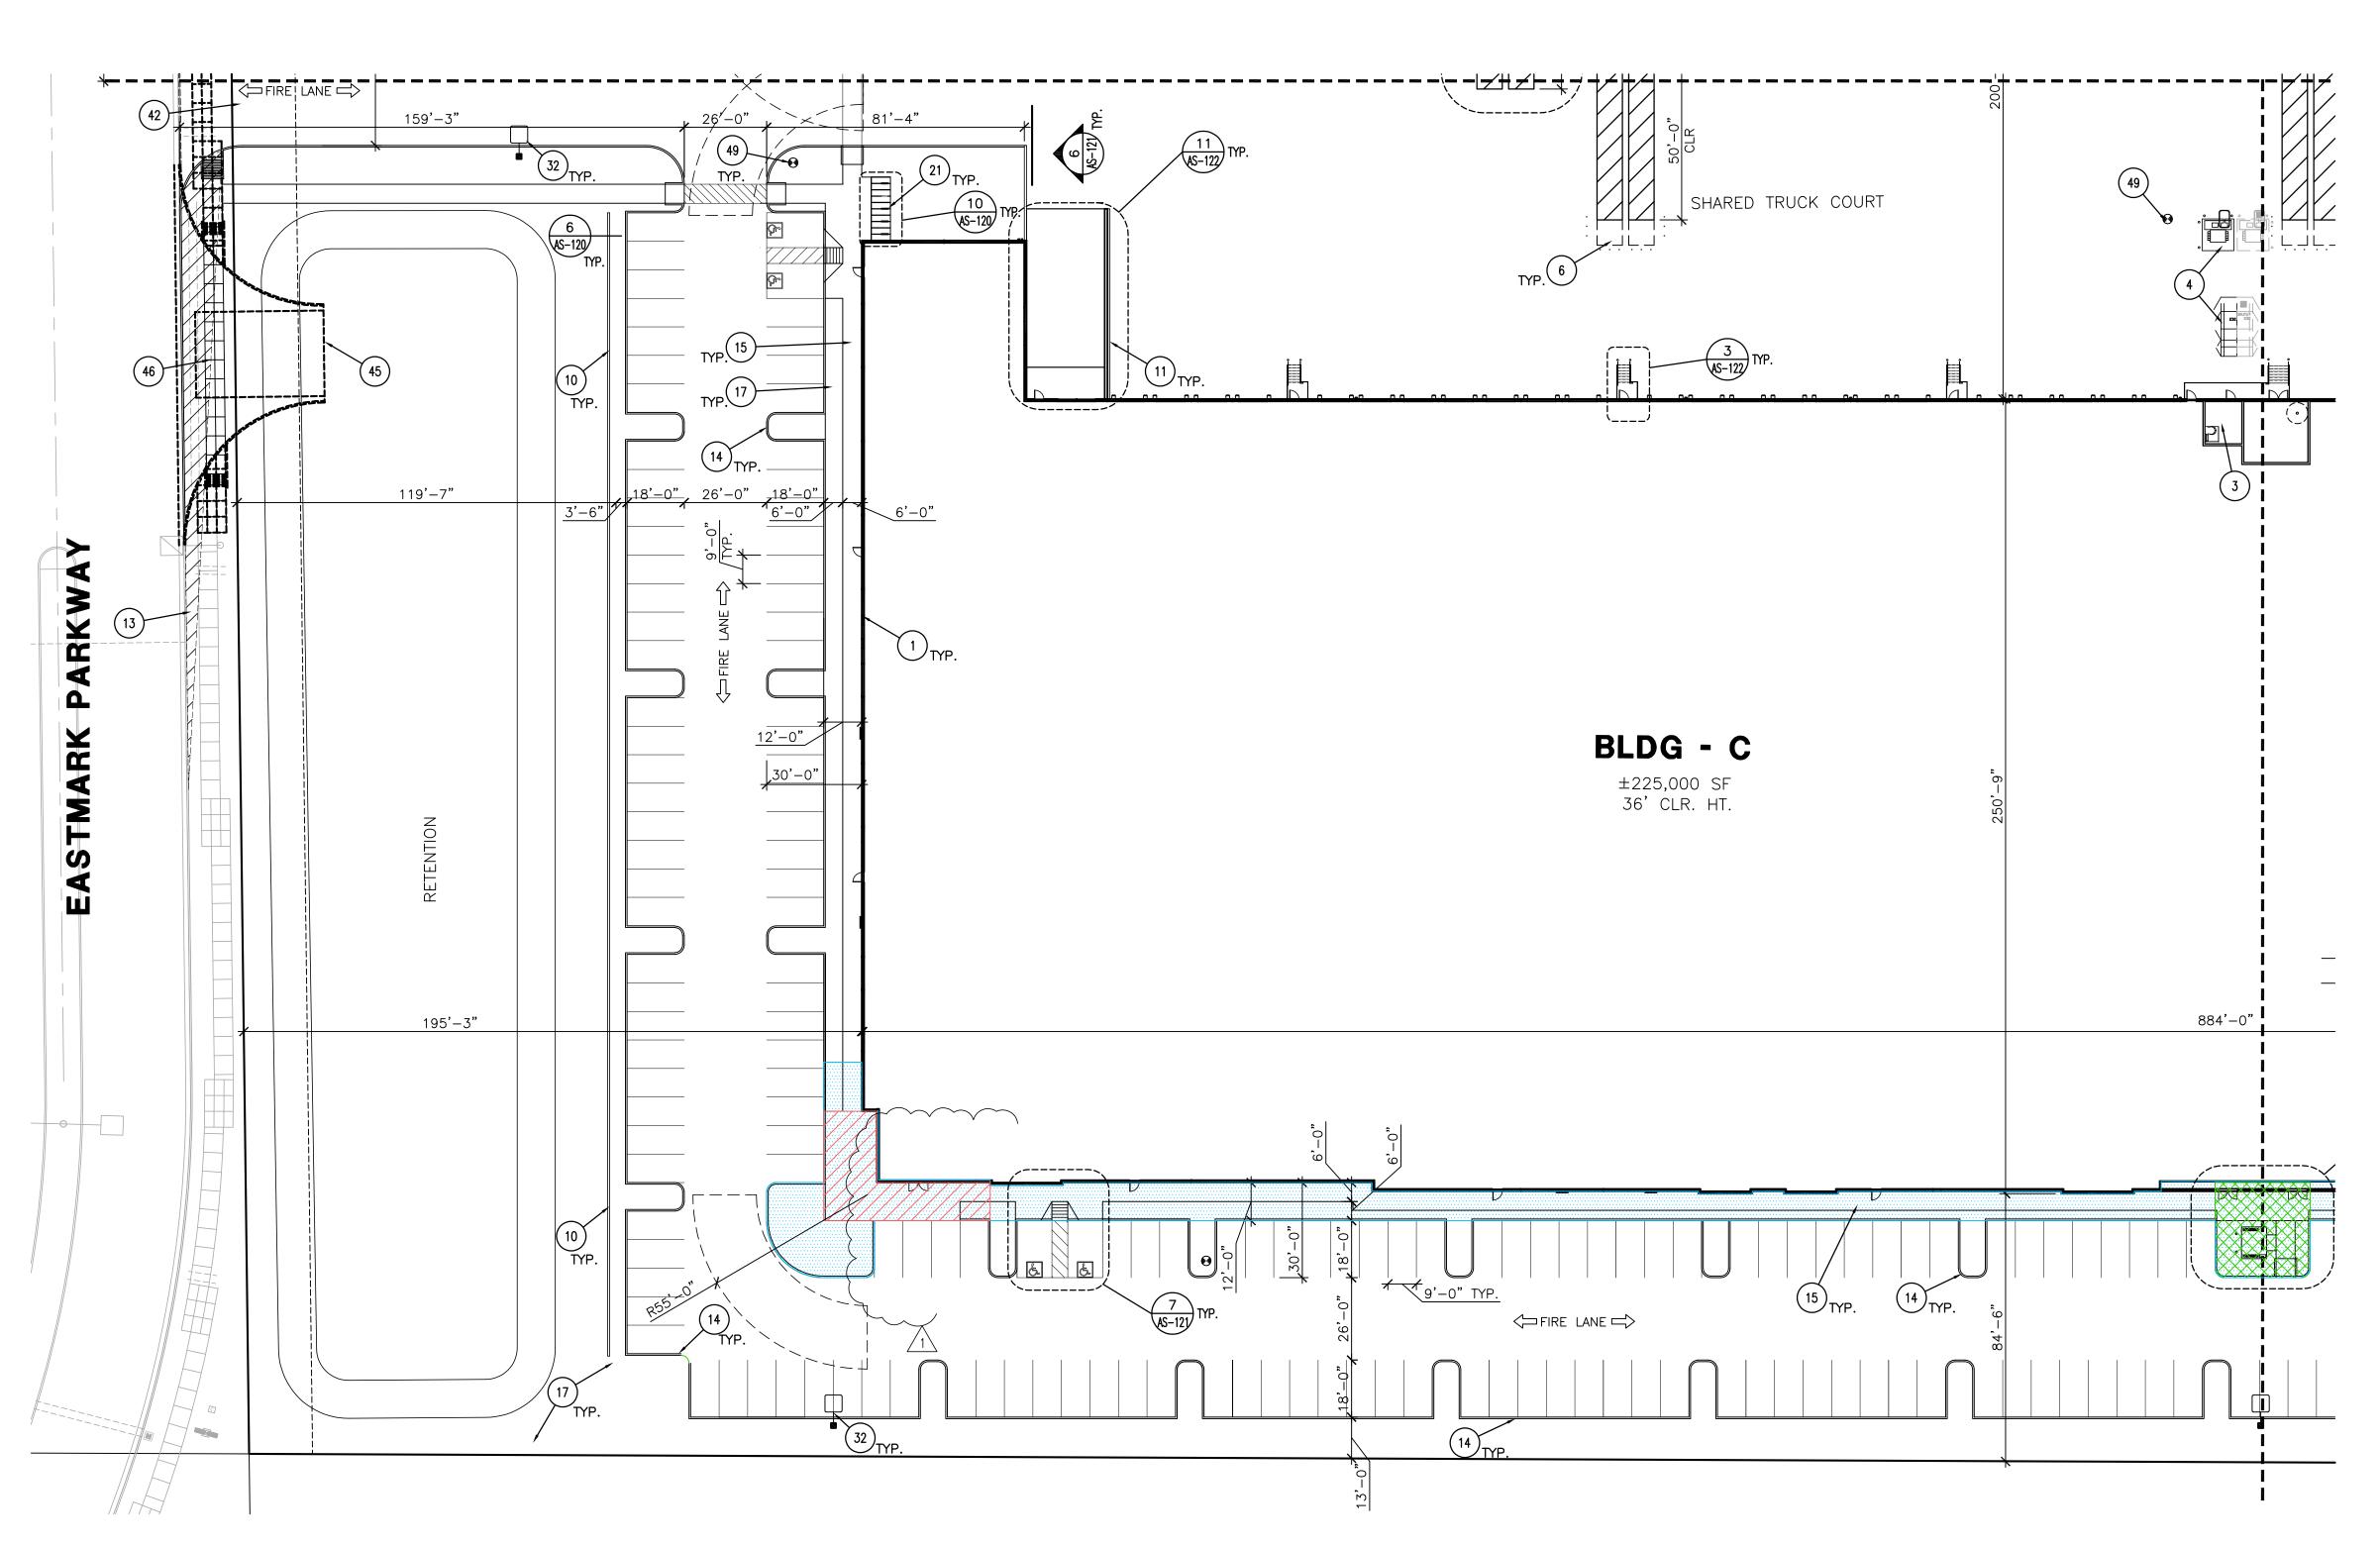

**BUILDING C** 

PARTIAL SITE PLAN

N



- 1. PROPOSED CONCRETE TILT PANEL BUILDING WITH STEEL COLUMNS.
- COLUMNS.

  3. HOUSE ELECTRICAL ROOM WITH ROOF ACCESS.

  4. SES LOCATION WITH UTILITY TRANSFORMER.

  6. TYPICAL REFUSE AND RECYCLE AREA FOR PROSPECTIVE TENANTS LOCATED IN THE ENCLOSED DOCK YARD BEHIND 8' HIGH WALL WITH 50' CLEAR SPACE IN FRONT OF BINS.

  10. 3'-4" HIGH MASONRY PARKING SCREEN WALL.

  11. CONCRETE DRIVE UP RAMP TO THE BUILDING WITH CONCRETE CHARD PAILS.
- CONCRETE GUARD RAILS

  13. TRAFFIC VISIBILITY TRIANGLES
- 14. 6" CONCRETE CURB
- 15. CONCRETE SIDE WALK MIN, 6' WIDE 17. LANDSCAPE AREA REFER TO LANDSCAPE PLANS
- 21. BIKE PARKING 32. SITE LIGHT POLE PER ELECTRICAL 42. DRIVEWAY PER CITY OF MESA STANDARDS. REFER TO CIVIL.
- 45. EXISTING DRIVEWAY TO BE REMOVED 46. CONCRETE CURB AND SIDEWALK TO MATCH EXISTING. REFER TO CIVIL DRAWINGS
- 49. FIRE HYDRANT REFER TO CIVIL

### LANDSCAPE LEGEND



COMMON AREA



ENTRY AREA



FOUNDATION AREA

ELECTRICAL DRAWINGS.


FIRE TRUCK LANE ACCESS OR DRIVE.

NEW FIRE HYDRANT

SITE LIGHT POLE LOCATIONS - REFER TO




SITE VISIBILITY TRIANGLE AREA PER COM

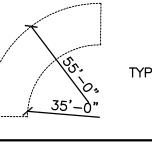



TYPICAL TURNING RADIUS

### **KEYPLAN**

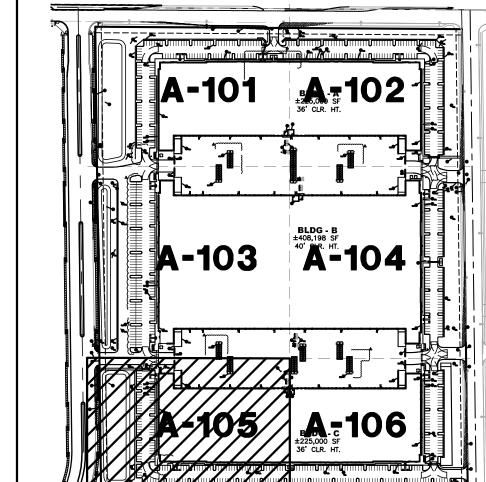

2929.COM

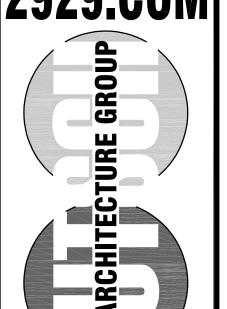

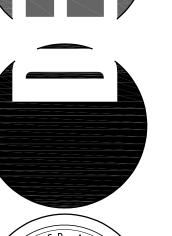

KAREN OHMANN A

4600 EAST INDIAN SCHOOL RD PHOENIX, ARIZONA 85018 602-840-2929 P 602-840-6646 F

CENTER TERR.


OGISTICS (AND EVERTON SA, AZ EASTMARK 202 LO SWC OF ELLIOT RD. AI


1ST ISSUED: 5/31/22 Revisions NO. DATE DESCRIPTION 1 8/3/22 P&Z AND
EASTMARK
COMMENTS

PROJECT NO: 22108

DRAWN BY: ET CHK'D BY: KO COPYRIGHT 2022: DEUTSCH ARCHITECTURE GROUP

**BUILDING C PARTIAL SITE** PLAN

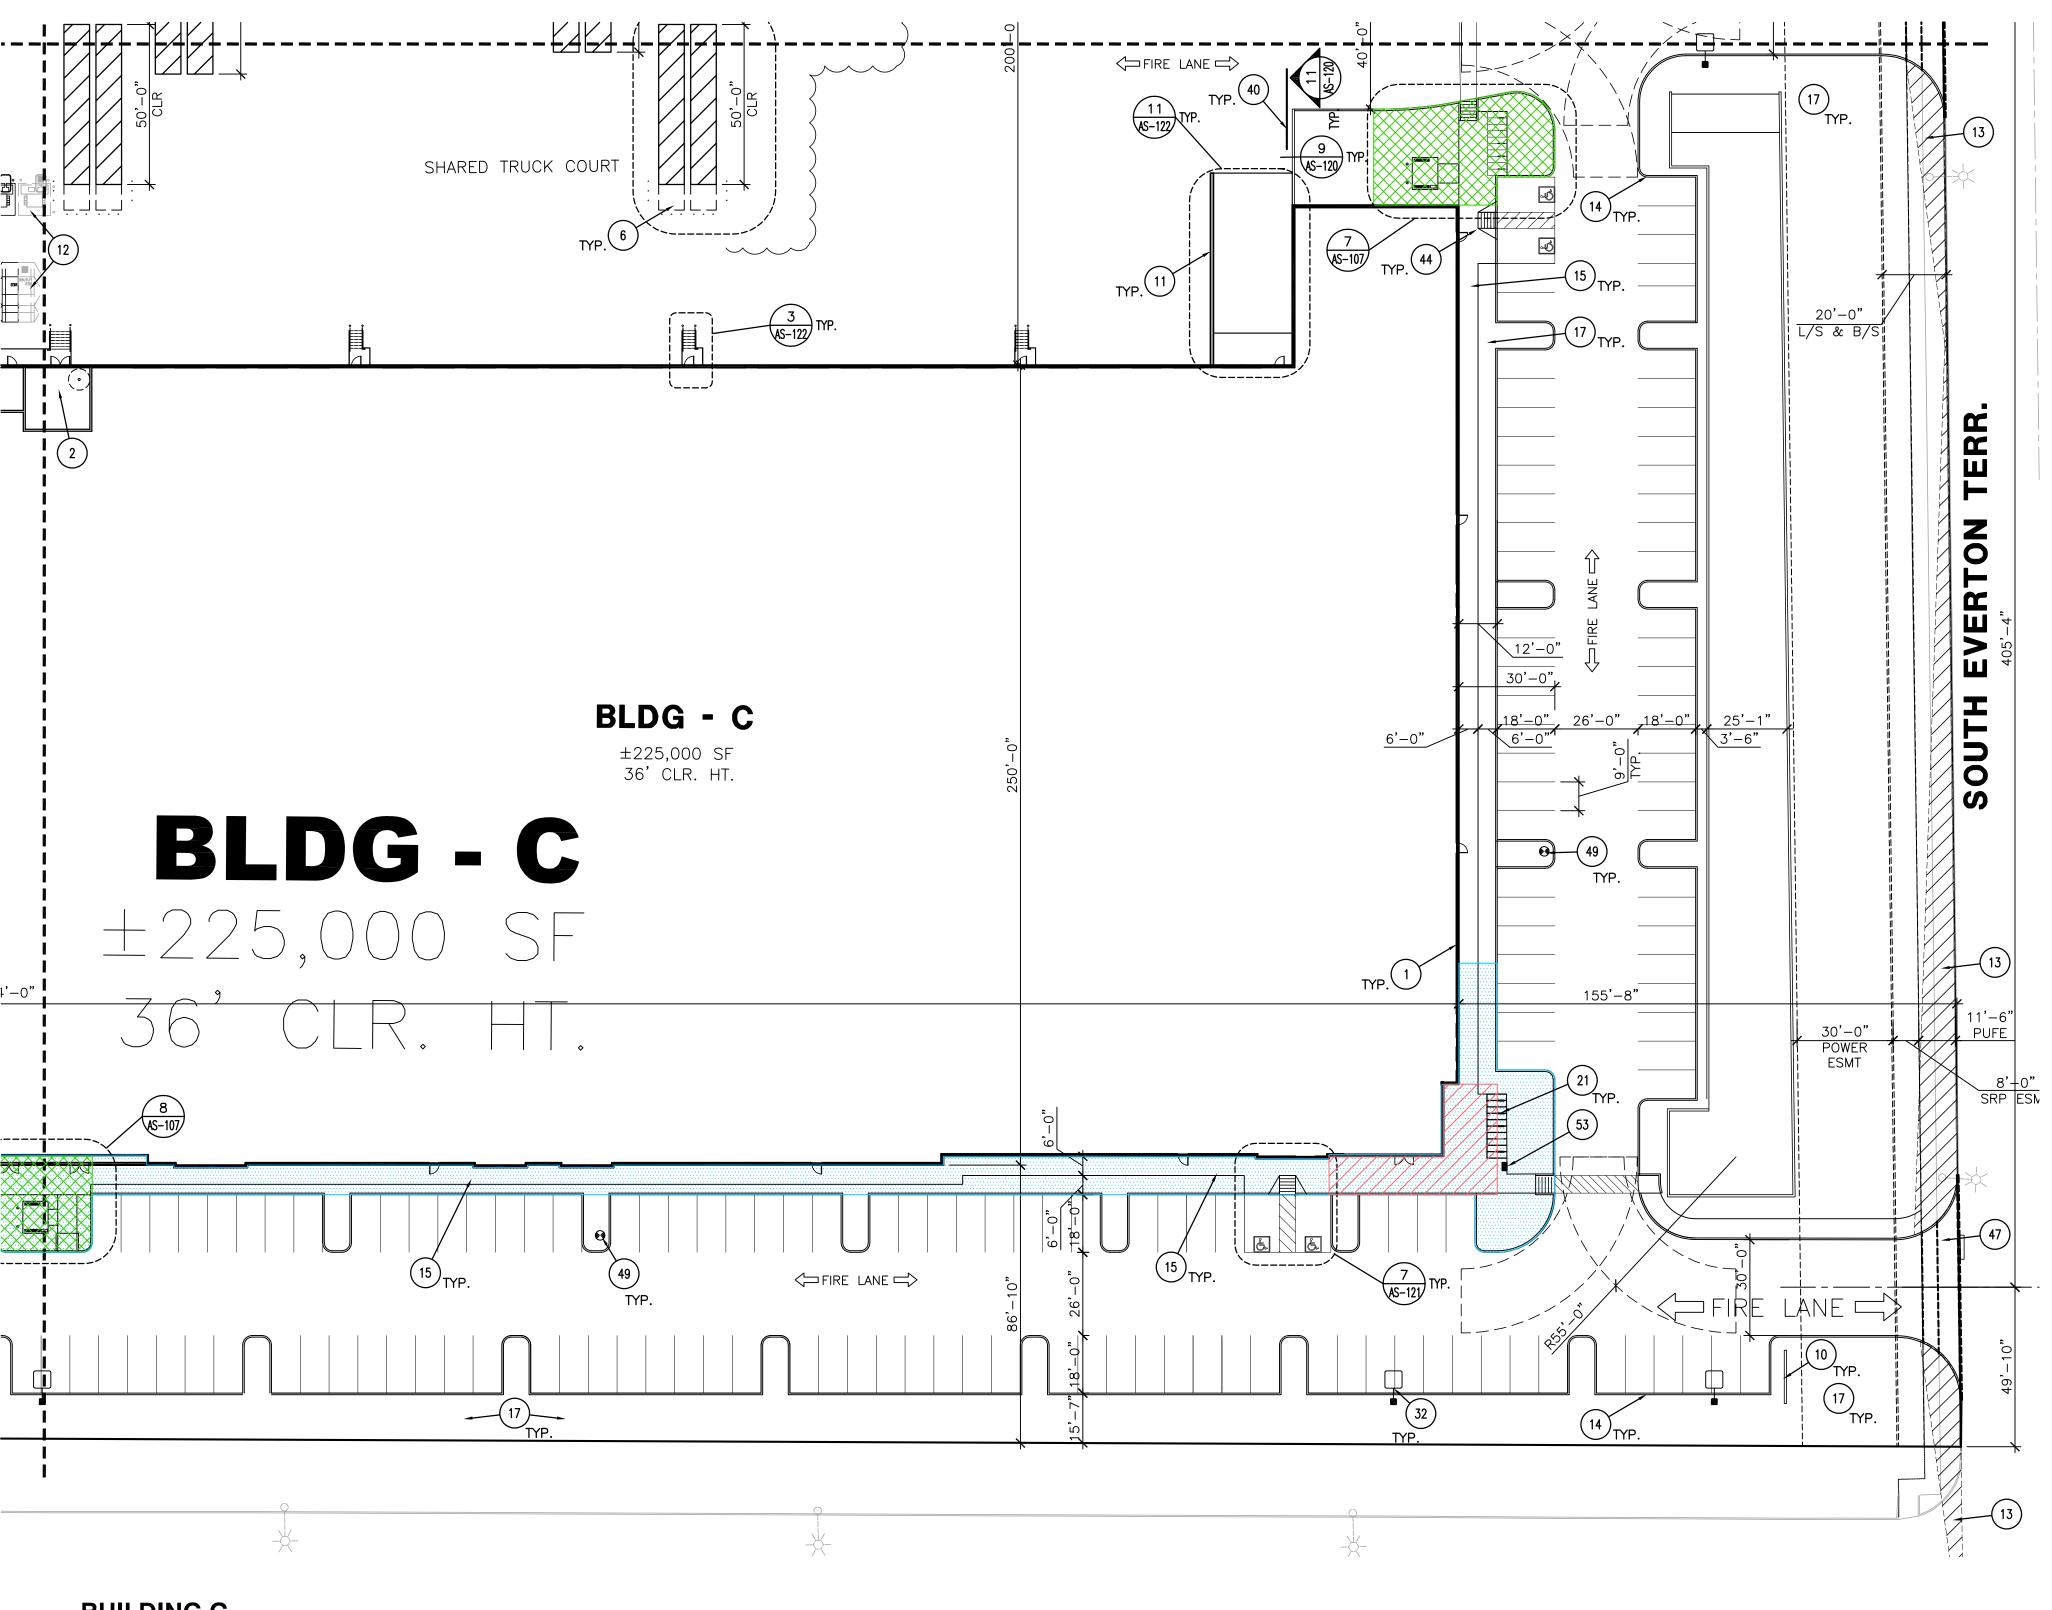

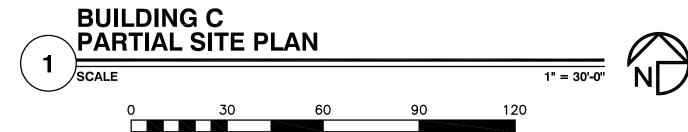

- 1. PROPOSED CONCRETE TILT PANEL BUILDING WITH STEEL COLUMNS.
- COLUMNS.

  2. FIRE PUMP / RISER ROOM.


  6. TYPICAL REFUSE AND RECYCLE AREA FOR PROSPECTIVE TENANTS LOCATED IN THE ENCLOSED DOCK YARD BEHIND 8' HIGH WALL WAS NEXT ARRIVING SCREEN WALL.
- 10. 3'-4" HIGH MASONRY PARKING SCREEN WALL.
  11. CONCRETE DRIVE UP RAMP TO THE BUILDING WITH CONCRETE GUARD RAILS
  12. FUTURE SES LOCATION WITH UTILITY TRANSFORMER
  13. TRAFFIC VISIBILITY TRIANGLES
- 14. 6" CONCRETE CURB15. CONCRETE SIDE WALK MIN, 6' WIDE17. LANDSCAPE AREA REFER TO LANDSCAPE PLANS
- 21. BIKE PARKING
  32. SITE LIGHT POLE PER ELECTRICAL
  40. 8' HIGH WROUGHT IRON WITH PERFORATED METAL SCREEN SECURITY GATES, REFER TO SITE DETAIL 11/AS-120.
- GATES WILL BE OPEN DURING BUSINESS HOURS.

  44. ADA RAMP PER DETAILS

  47. EXISTING CURB, SIDEWALK AND LANDSCAPING TO BE REMOVED
- 49. FIRE HYDRANT REFER TO CIVIL

  53. 8 DOOR CLUSTER BOX UNIT WITH PEDESTAL IN MORTAR GREY
  FINISH TO MATCH ELEVATIONS

### LANDSCAPE LEGEND

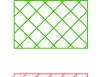

COMMON AREA



ENTRY AREA



FOUNDATION AREA

⊐ FIRE LANE⊏弌>


FIRE TRUCK LANE ACCESS OR DRIVE.

SITE LIGHT POLE LOCATIONS — REFER TO




NEW FIRE HYDRANT

ELECTRICAL DRAWINGS.

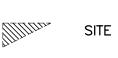


SITE VISIBILITY TRIANGLE AREA PER COM

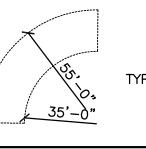


TYPICAL TURNING RADIUS

### **KEYPLAN**

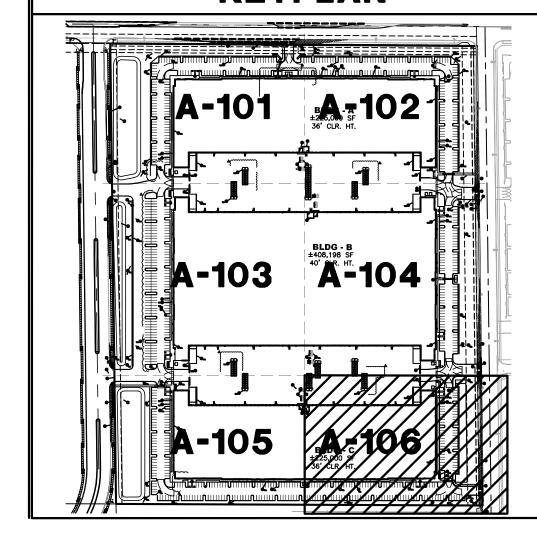

# **12929.COM**

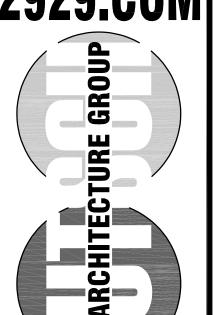





4600 EAST INDIAN SCHOOL RD PHOENIX, ARIZONA 85018 602-840-2929 P 602-840-6646 F

GISTICS CENTER
D EVERTON TERR.
AZ

EASTMARK 202 LOGISTICS
SWC OF ELLIOT RD. AND EVERTON
MESA, AZ

1ST ISSUED: 5/31/22

Revisions

NO. DATE DESCRIPTION


1 8/3/22 P&Z AND
EASTMARK
COMMENTS

PROJECT NO: 22108

DRAWN BY: ET

CHK'D BY: KO
COPYRIGHT 2022: DEUTSCH
ARCHITECTURE GROUP

BUILDING C Partial Site Plan

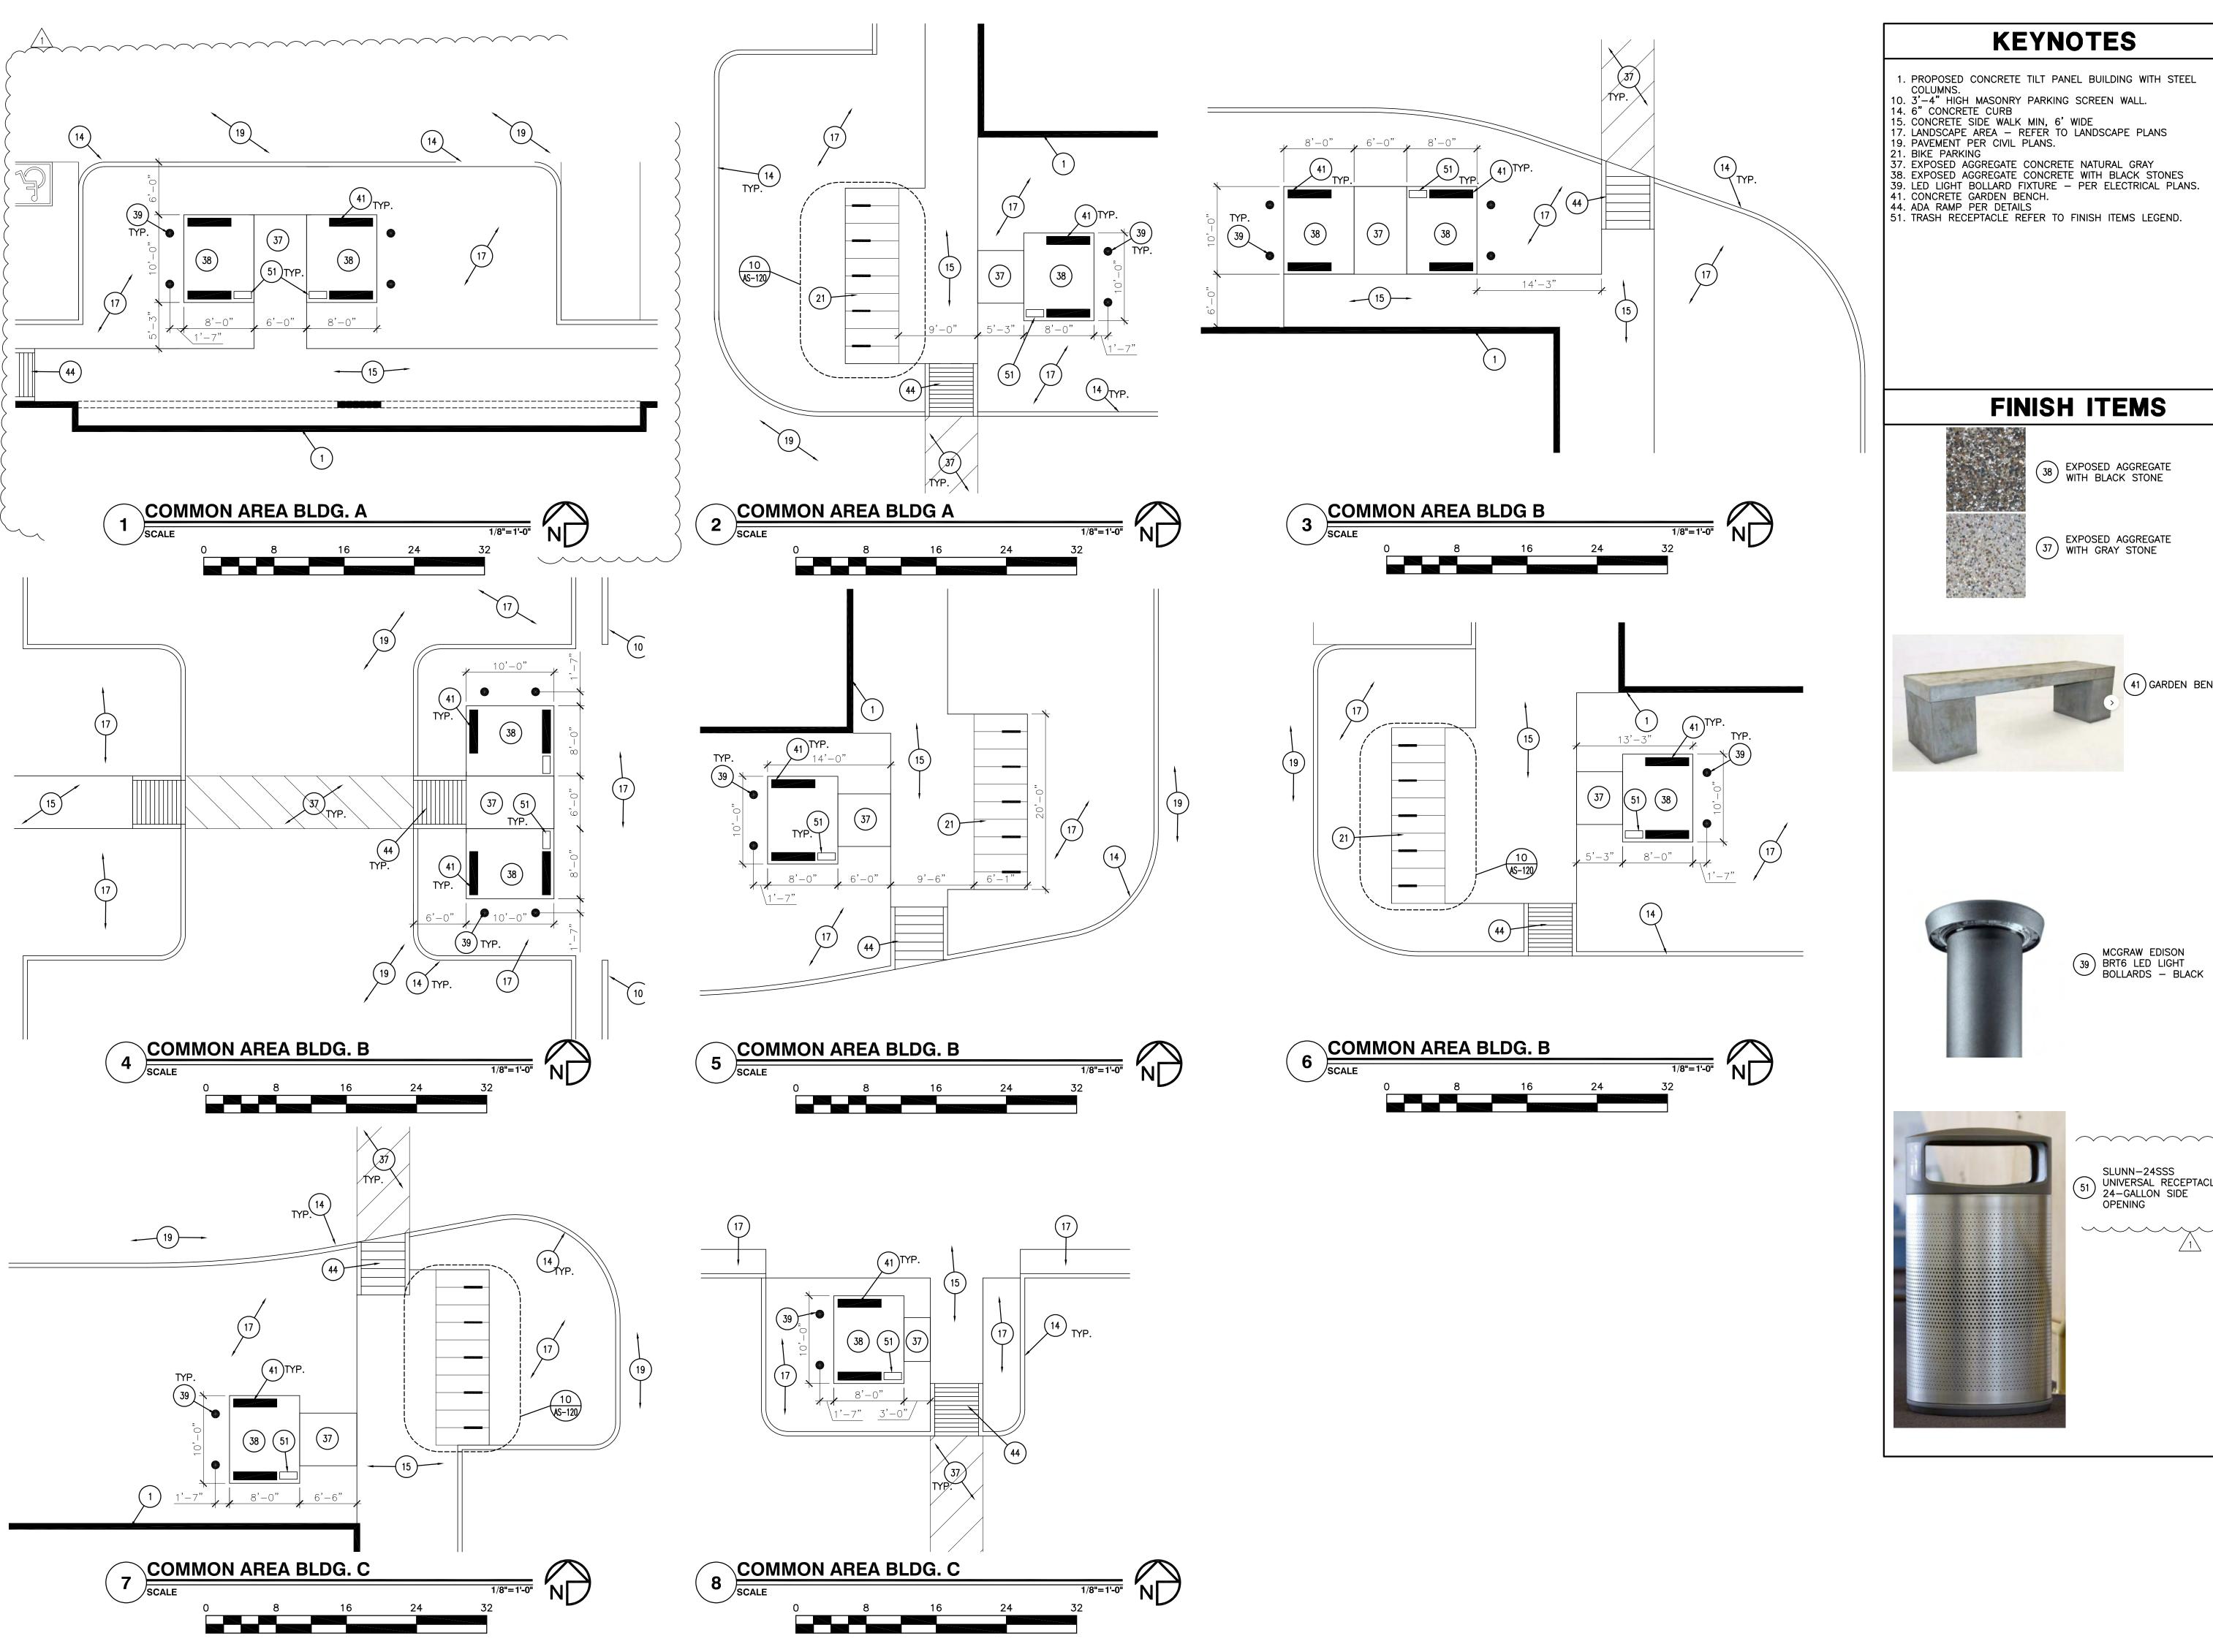

2929.COM

0

KAREN

4600 EAST INDIAN SCHOOL RD PHOENIX, ARIZONA 85018

602-840-2929 P 602-840-6646 F

CENTER TERR.

OGISTICS
AND EVERTON
SA, AZ

EASTMARK 202 LO SWC OF ELLIOT RD. AI

1ST ISSUED: 5/31/22

OHMANN

38 EXPOSED AGGREGATE WITH BLACK STONE

41) GARDEN BENCH


MCGRAW EDISON BRT6 LED LIGHT BOLLARDS — BLACK


Revisions
NO. DATE DESCRIPTION L 8/3/22 P&Z AND EASTMARK COMMENTS


SLUNN-24SSS
UNIVERSAL RECEPTACLE,
24-GALLON SIDE
OPENING


PROJECT NO: 22108 DRAWN BY: ET CHK'D BY: KO COPYRIGHT 2022: DEUTSCH ARCHITECTURE GROUP

**ENLARGE SITE** PLAN

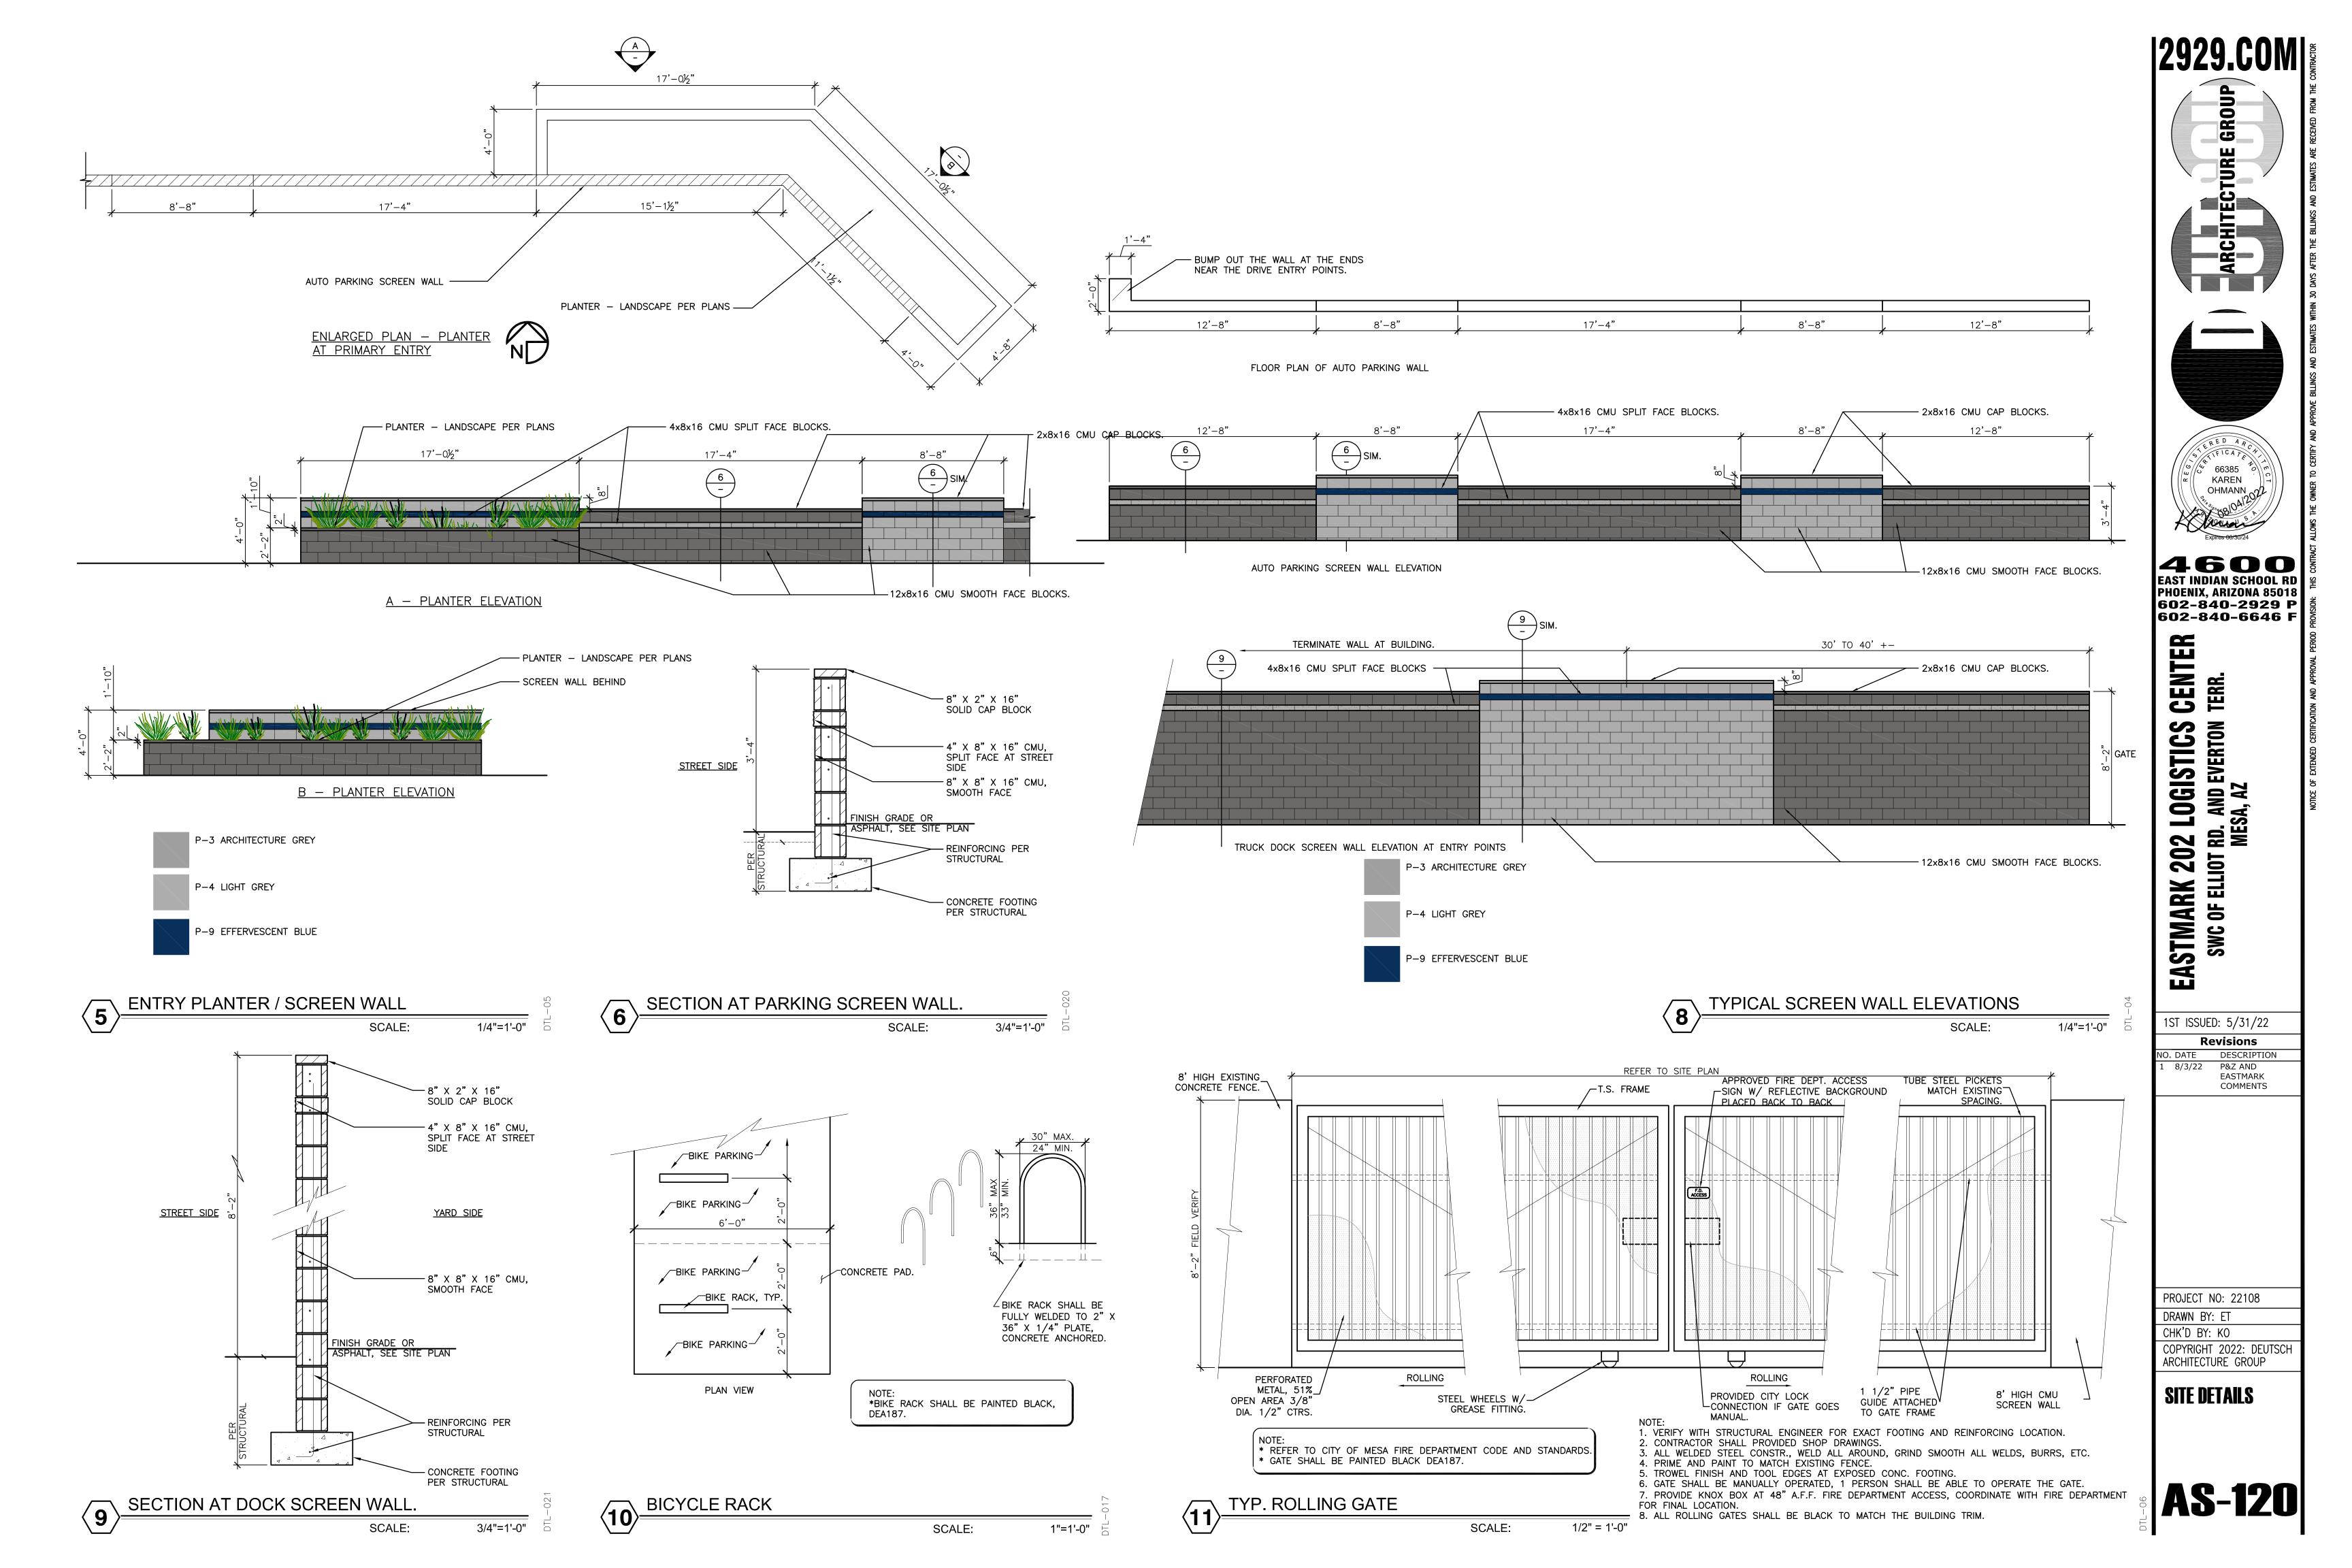


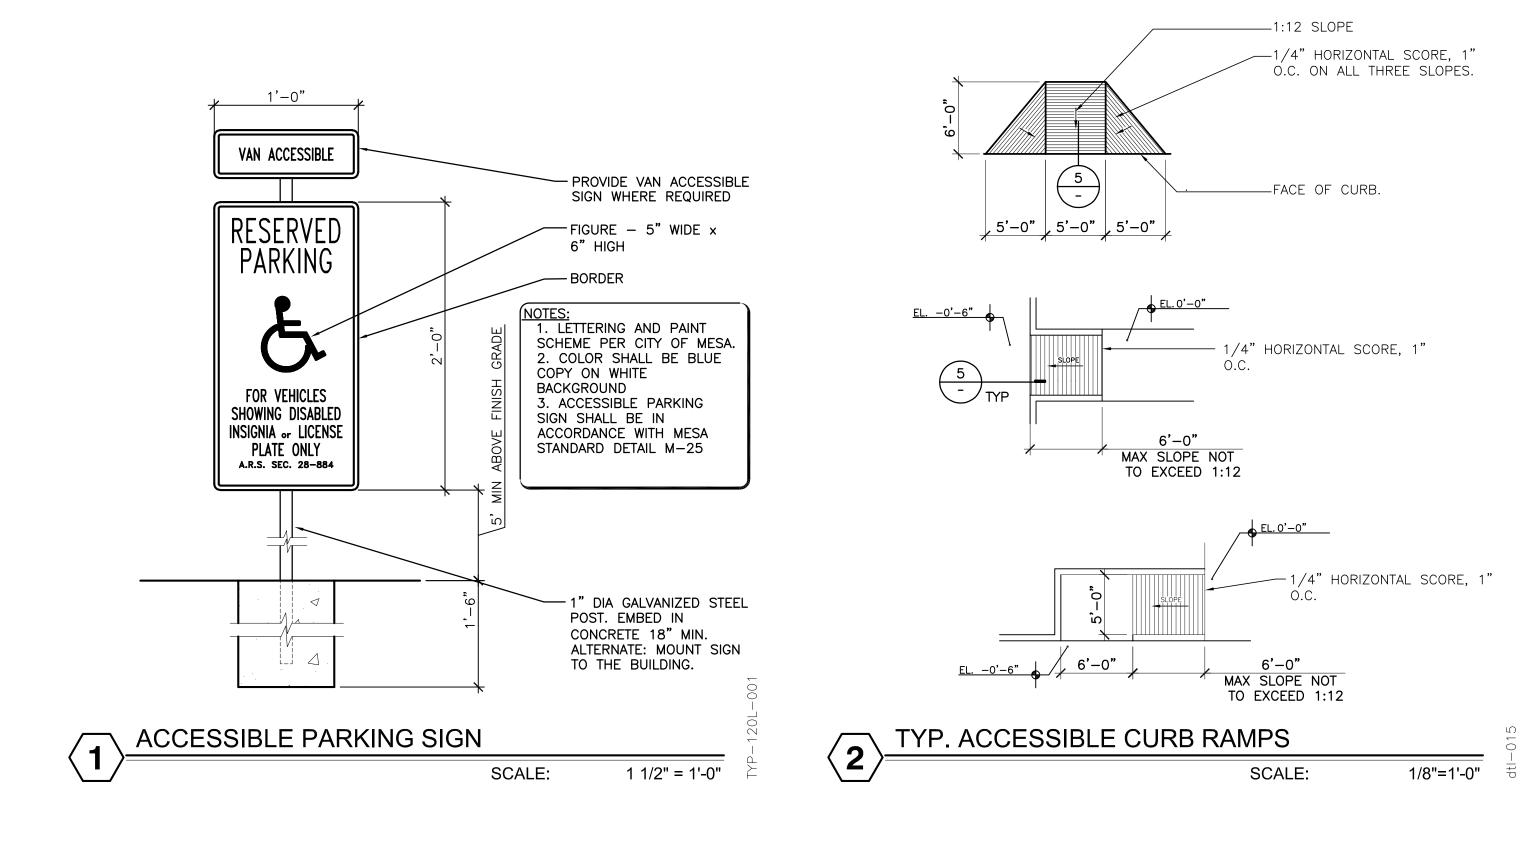

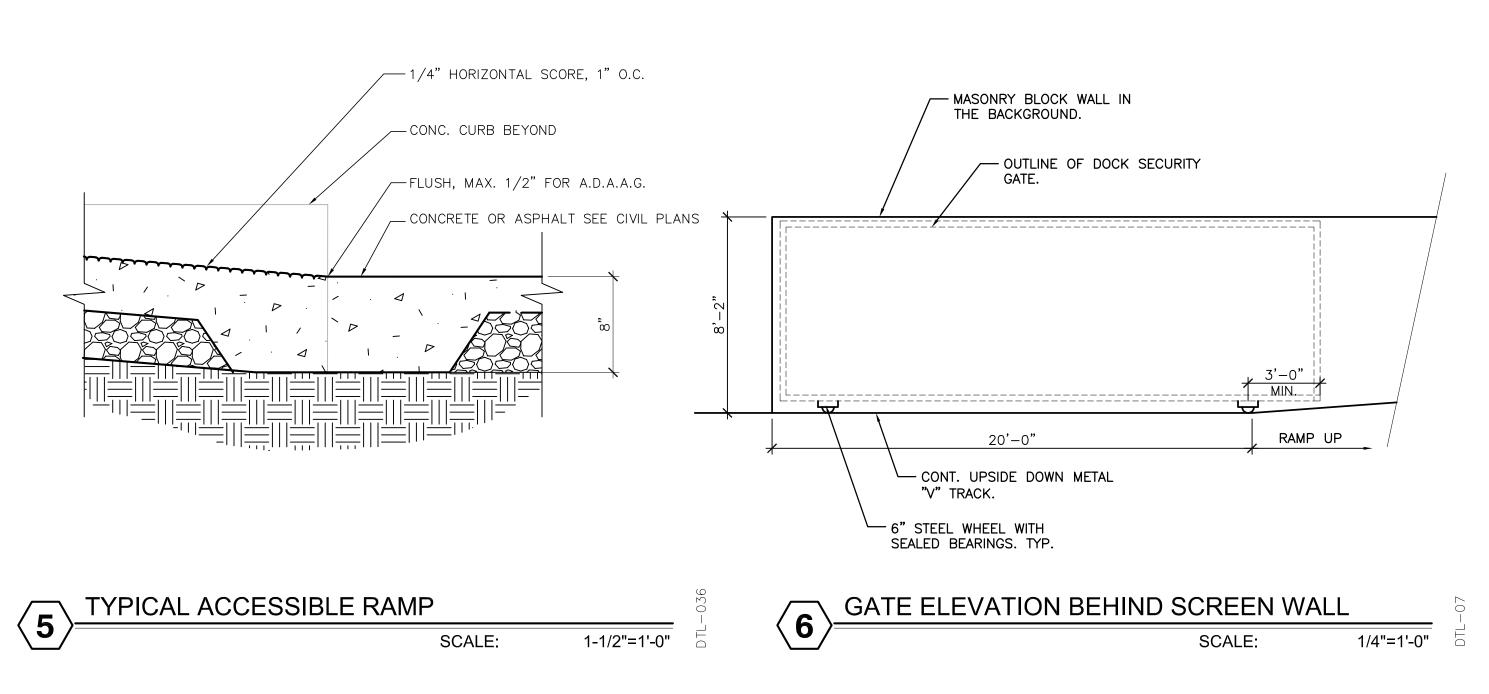

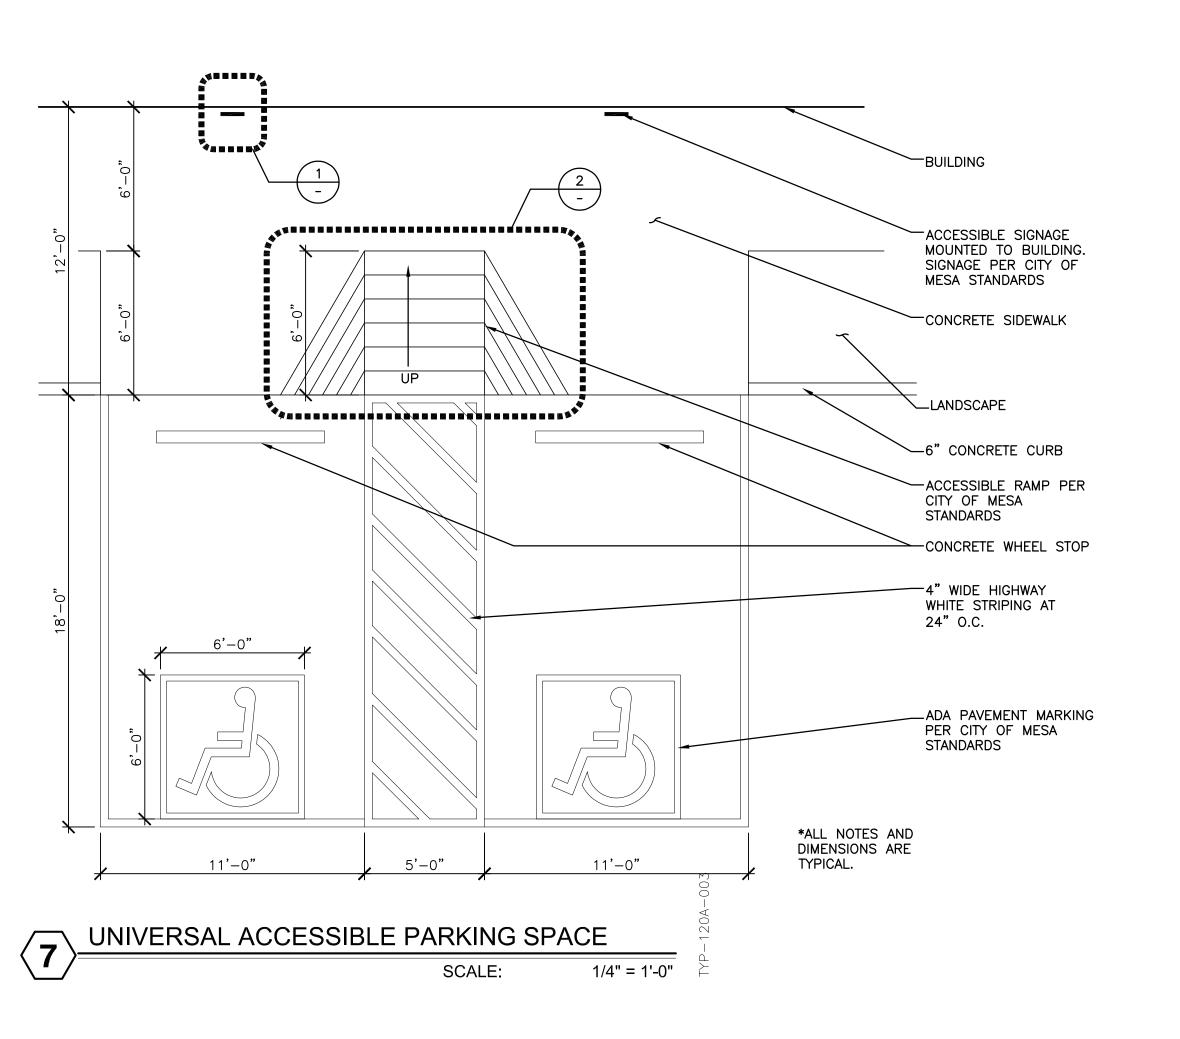



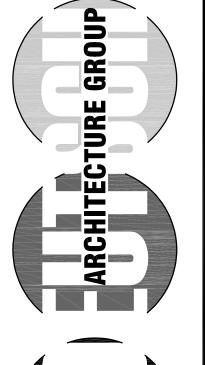



4600 EAST INDIAN SCHOOL RD PHOENIX, ARIZONA 85018 602-840-2929 P 602-840-6646 F

EASTMARK 202 LOGISTICS CENTER SWC OF ELLIOT RD. AND EVERTON TERR. MESA, AZ

1ST ISSUED: 5/31/22

Revisions

NO. DATE DESCRIPTION

1 8/3/22 P&Z AND
EASTMARK
COMMENTS

PROJECT NO: 22108
DRAWN BY: ET


DRAWN BY: ET


CHK'D BY: KO

COPYRIGHT 2022: DEUTSCH


ARCHITECTURE GROUP


SITE DETAILS

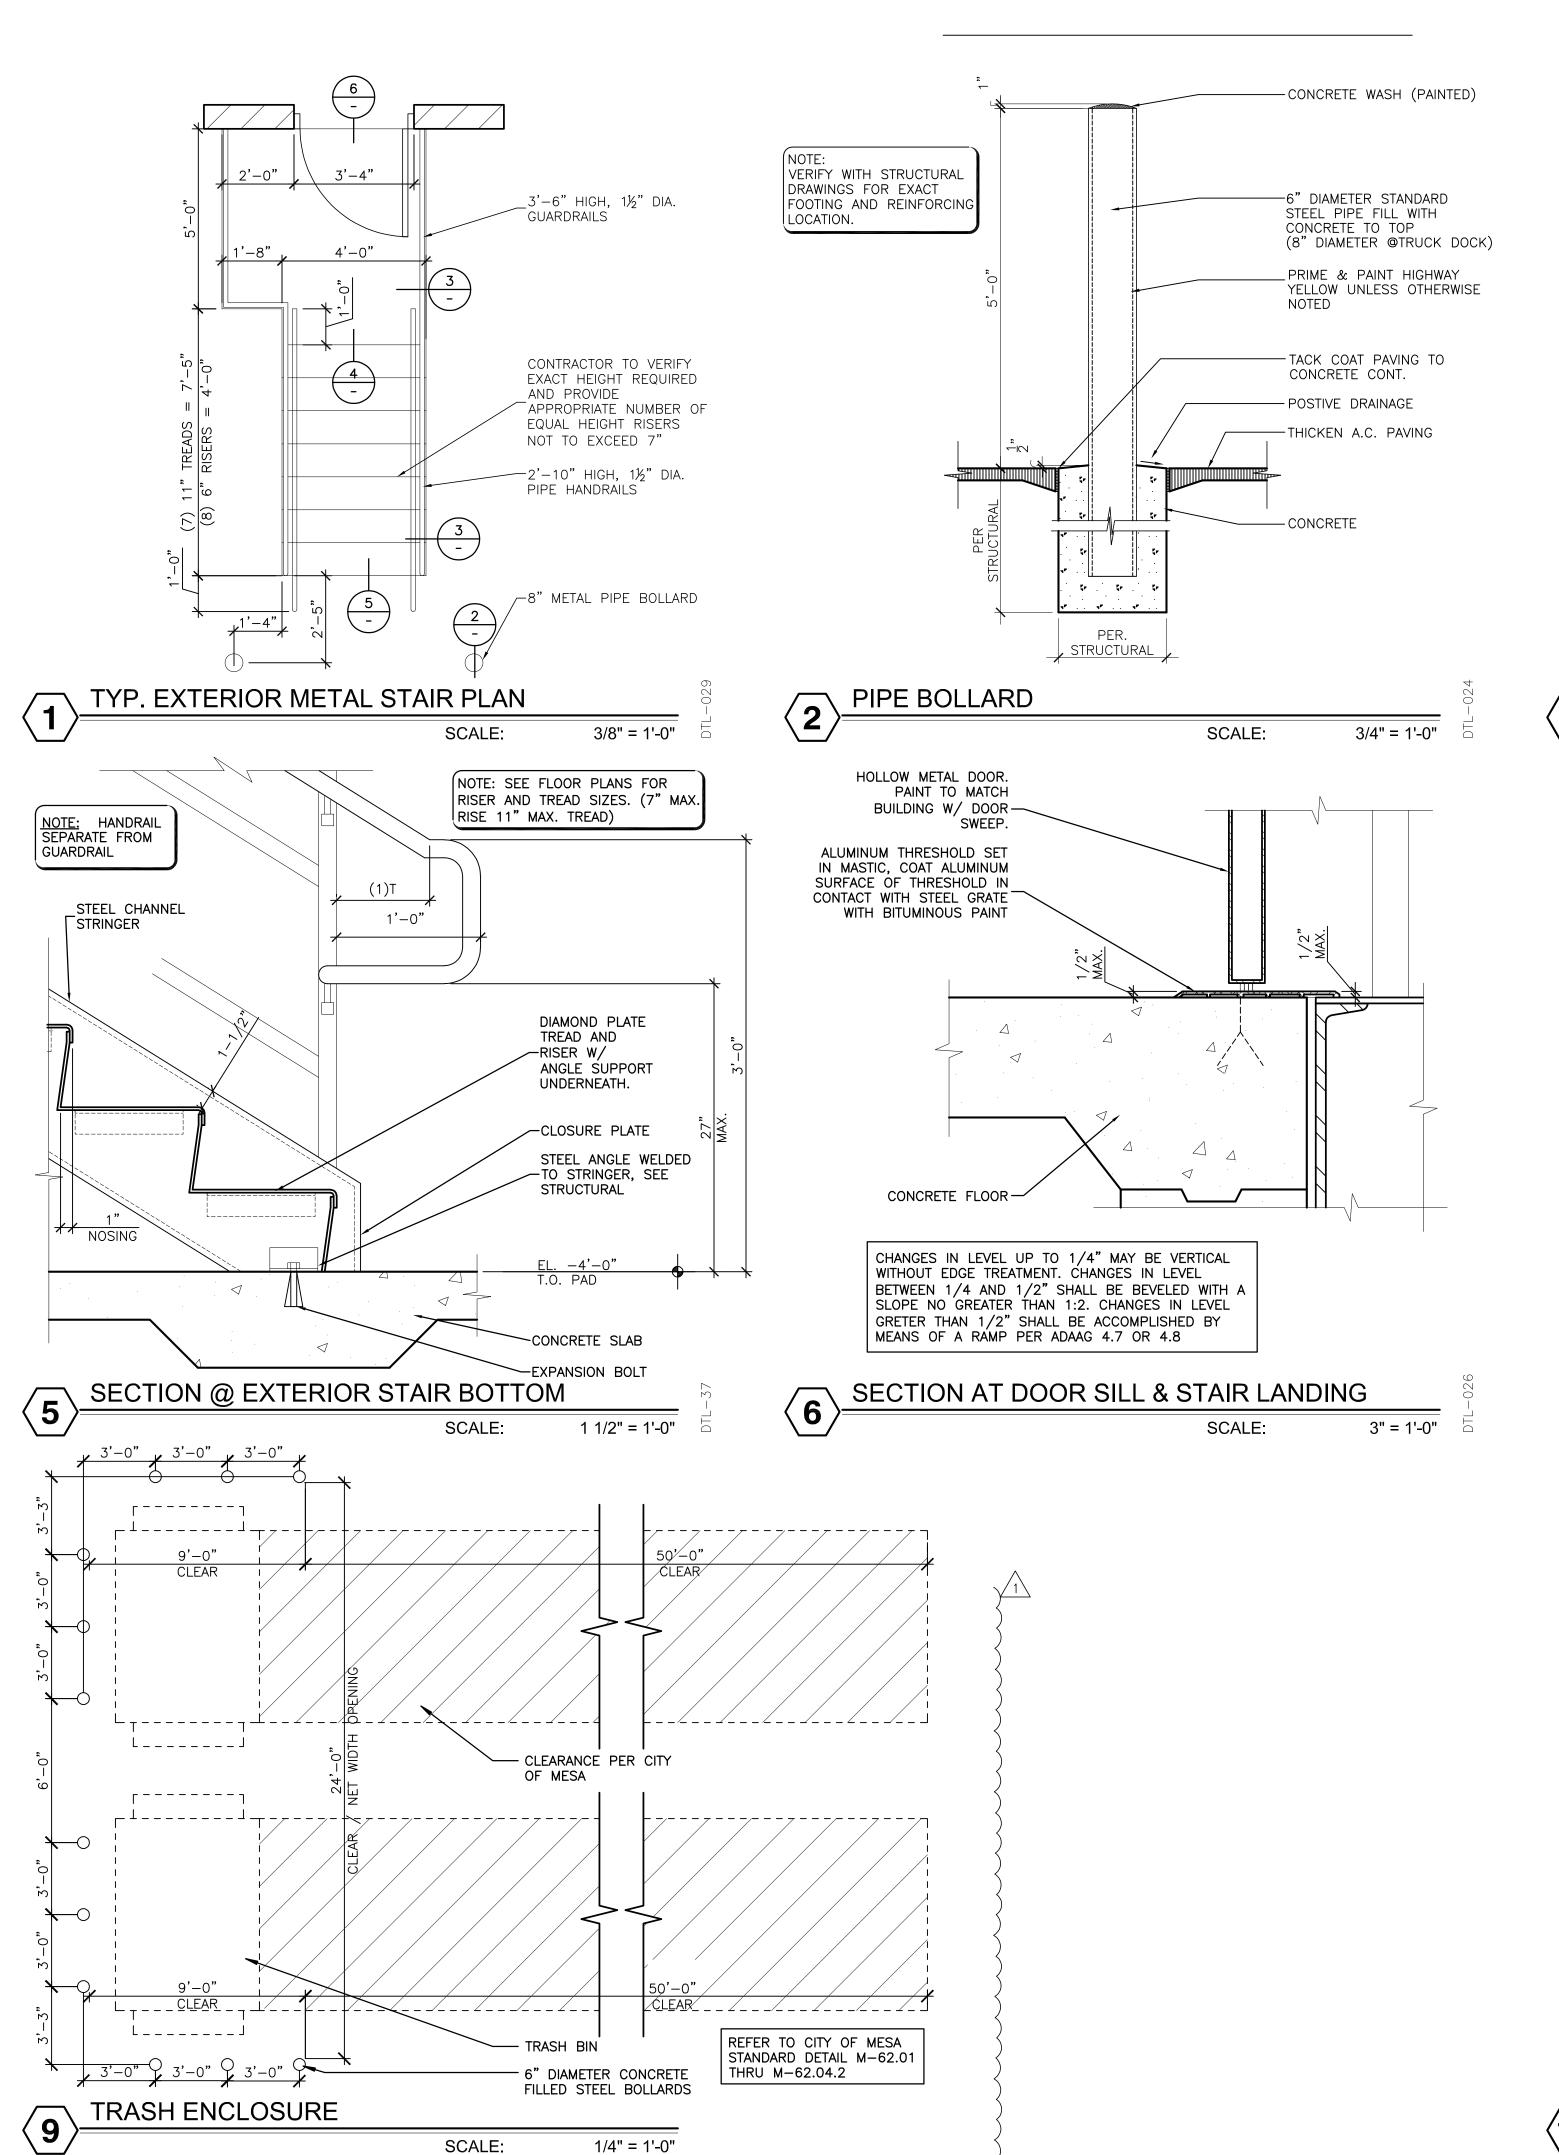

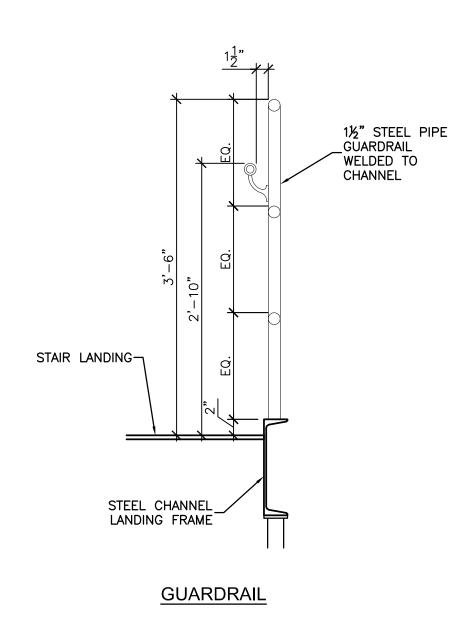



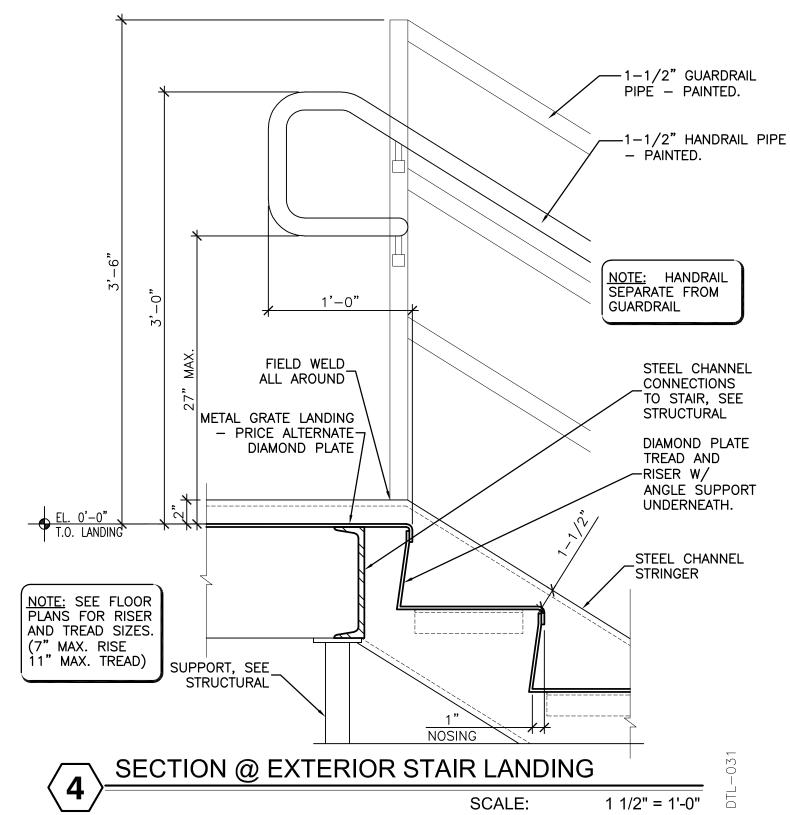


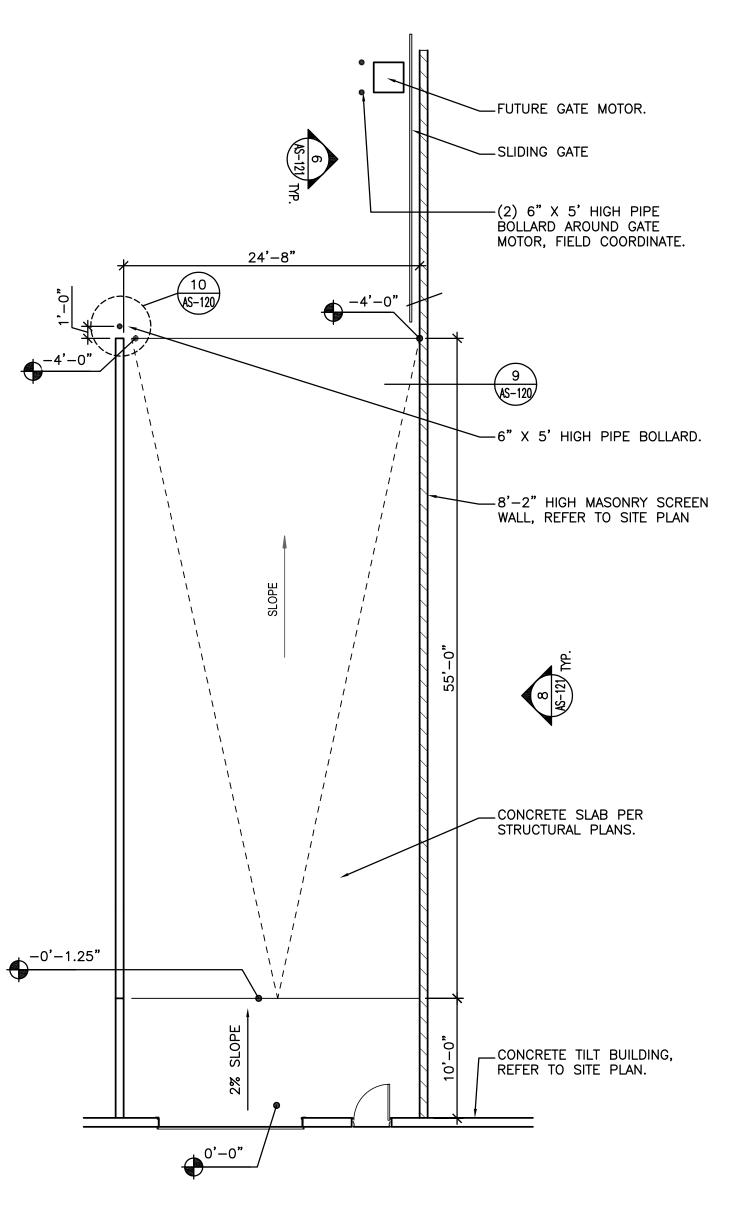

SCALE:

1/8"=1'-0"

TYP. DOCK RAMP FLOOR PLAN

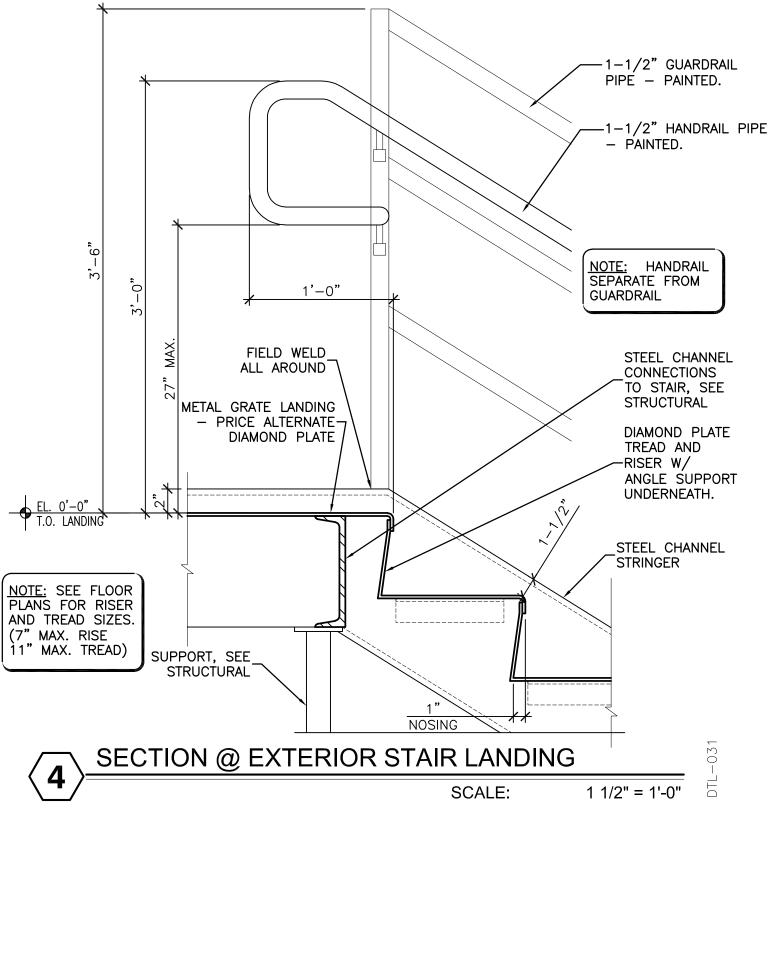

EASTMARK 202 LO SWC OF ELLIOT RD. A MESA, 1ST ISSUED: 5/31/22 Revisions NO. DATE DESCRIPTION 8/3/22 P&Z AND

ш

<u></u>

KAREN

4600

EAST INDIAN SCHOOL RD PHOENIX, ARIZONA 85018

602-840-2929 P

602-840-6646 F

CENTER TERR.

OGISTICS (AND EVERTON 'A, AZ

OHMANN 77

EASTMARK

PROJECT NO: 22108 DRAWN BY: ET CHK'D BY: KO

COPYRIGHT 2022: DEUTSCH ARCHITECTURE GROUP

SITE DETAILS