


EXISTING SITE PLAN SCALE: 1"= 10'-0"

LOT AREA Lot Square Footage:	7,635.6 Sq.Ft.
LOT COVERAGE	
Building (s) footprint:	1,656 Sq.Ft.
Existing Coverage	22 %
LIVABLE	949 Sq.Ft.
GARAGE	302 Sq.Ft.
PATIO	310 Sq.Ft.
FRONT PORCH	95 Sq.Ft.
	1,656 Sq.Ft.

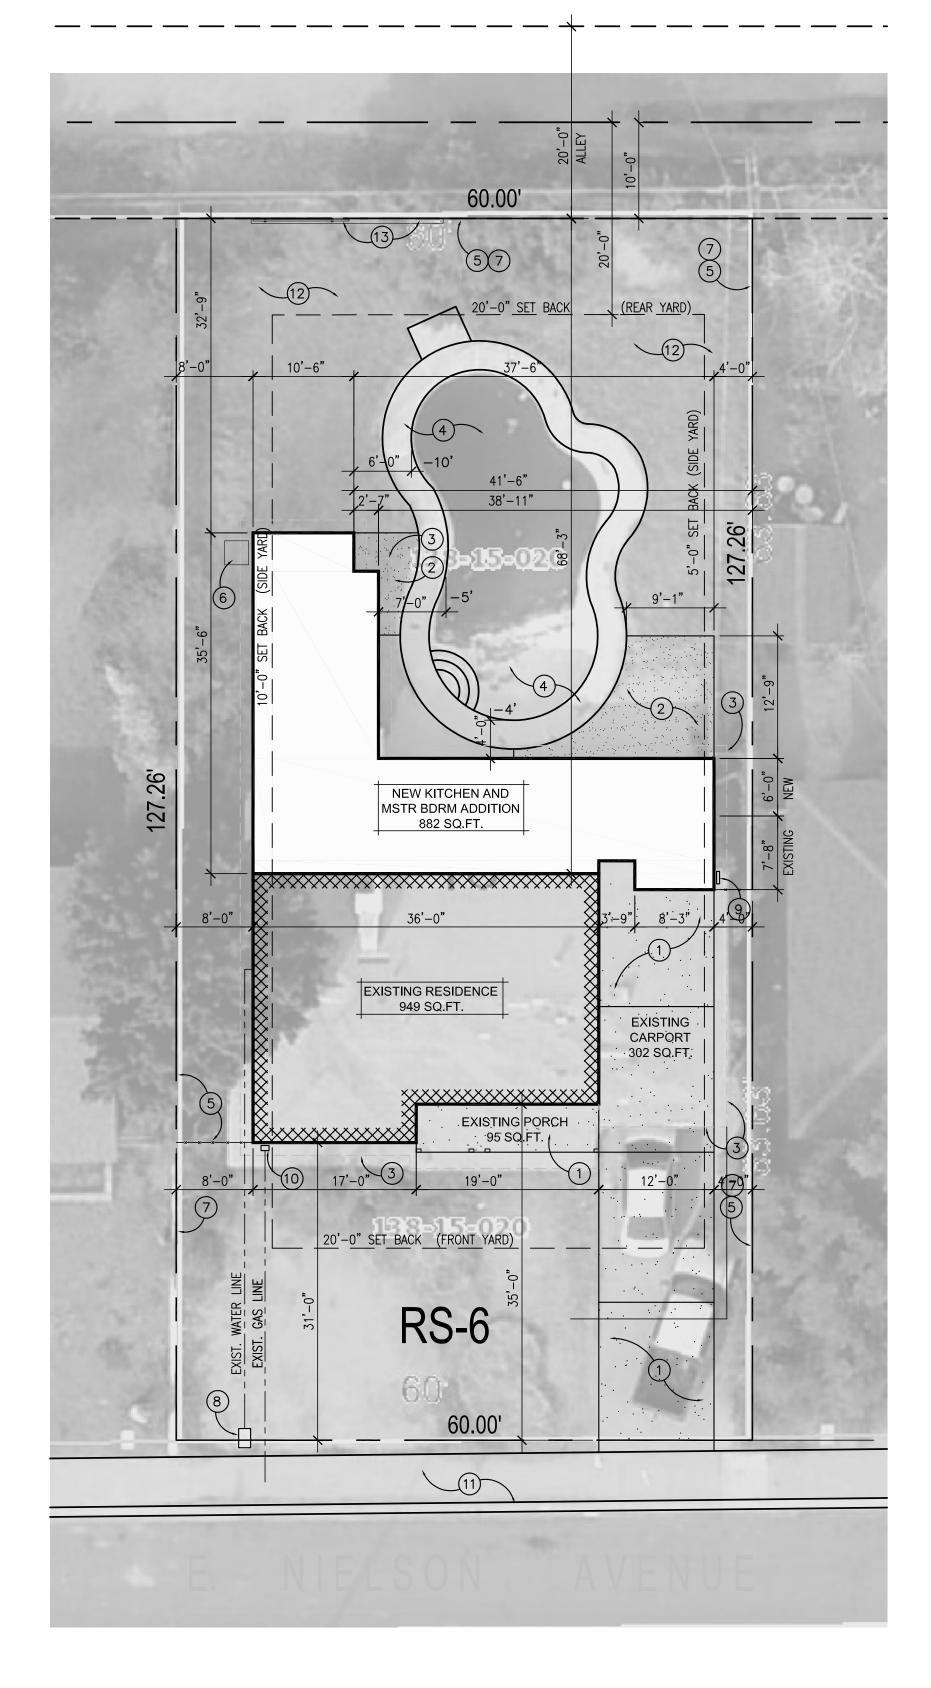

SITE PLAN

INOITH	
LOT AREA Lot Square Footage:	7,635.6 Sq.Ft.
LOT COVERAGE Building (s) footprint: Coverage	2,228 Sq.Ft. 29 %
LIVABLE EXISTING CARPORT	1831 Sq.Ft. 302 Sq.Ft.
FRONT PORCH	95 Sq.Ft.
	2,228 Sq.Ft.

GENERAL NOTES

- G1. CONTRACTOR SHALL FOLLOW ALL CODES AND REGULATIONS MANDATED BY FEDERFAL, STATE, COUNTY AND CITY AGENCIES. G2. CONTRACTOR SHALL REPAIR AND OR REPLACE ALL FINISHES THAT
- ADDITONAL COST TO THE OWNER
- LINES DAMAGED SURING THE COURSE OF CONSTRUCTION DURING CONSTRUCTION. ALL THEFT AND VANDALISM SHALL BE
- DISPOSAL SITE

SITE NOTES

- S1. PRIOR TO CONSTRUCTION FIELD VERIFY ALL SETBACK EASEMENTS, PROPERTY LINES, LOT NUMBER AND SUB-DIVISION.
- S3. STRIP AND REMOVE ALL SOILS, VEGETATION, DEBRIS AND RUBBLE FROM THE PAVING AREA. CLEAN AND WIDEN DEPRESSION RESTULTING FROM TREE REMOVAL TO ACCOMODATE COMPACTION
- EXPOSED SUB GRADE SOILS TO A MINIMUM DEPTH OF 8"
- LIFTS TO FINISH SUB GRADE LEVELS, LIFT THICKNESS SHOULD BE CONTINGENT UPON COMPACTION EQUIPMENT USED TO ACHIVE MINIMUM UNIFORM DENSITIES. ON-SITE SOILS DERIVED FROM SHALLOW EXCAVATIONS CLEAN AND FREE OF ANY VEGITATION AND SPOILS WILL BE SUITABLE FOR FILL UNDER PAVEMENT AREAS
- S6. SUBGRADE PREP AND FILL SHOULD BE ACCOMPLISHED UNDER OBSERVATION
- SOILS REPORT SPECIFICATIONS AND MINIMUM COMPACTION S8. EXCAVATED DIRT IS NOT TO BE EXPORTED OFF-SITE.
- S10. SLOPE BERMS AWAY FROM BUILDING, TYPICAL AT ALL SIDES

- ARE DAMAGED DURING THE COURSE OF CONSTRUCTION AT NO
- G3. CONTRACTOR SHALL REPAIR OR REPLACE ALL EXISTING UTILITY LINES DAMAGED SURING THE COURSE OF CONSTRUCTION
- G4. CONTRACTOR SHALL REPAIR OR REPLACE ALL EXISTING UTILITY G5. CONTRACTOR SHALL SECURE MAINTAIN THE JOB SITE AT ALL TIMES
- THE RESPONSIBILITY OF THE CONTRACTOR. G6. ALL WAIST MATERIAL SHALL BE DEPOSITED IN A PROPERLY

- S2. VERIFY ALL FIELD CONDITIONS PRIOR TO COMMENCEMENT

- IF ANY, OWNER WILL DESIGNATE PLACEMENT S9. VERIFY ALL EXISTING ELECTRICAL, WATER, SEWER AND

PROJECT DATA

1144 E. Nielson Avenue Mesa, Az. 85204 LEGAL DESCRIPTION PARCEL 1

138-15-020 Section Township Range: NE 1/4, SECTION 29, T.2S., R.6E.

ZONING:

CONSTRUCTION TYPE: ADDITION BUILDING AREA: LIVABLE 882

LOT AREA:

- OF CONSTRUCTION
- S4. SCARIFY, MOISTEN OR DRY, AS REQUIRED, AND COMPACT ALL
- S5. PLACE AND COMPACT REQUIRED FILL IN HORIZANTAL COMPACTED
- S7. TESTING THAT IS DIRECTED BY A SOILS ENGINEER SHALL MEET

EXISTING BUILDING AREA: LIVABLE 949 7,635.6 SUBDIVISION: DE LOS SANTOS

SCOPE OF WORK:

882 SQ.FT. ADDITION ON 7,635.6 SQ.FT. LOT. IN THE CITY OF MESA. THE ADDITION WILL CONSIST OF THE RELOCATION OF THE EXISTING KITCHEN AND DINING AREA. ADDITION OF A NEW LAUNDRY ROOM, MASTER BEDROOM, MASTER BATHROOM AND CLOSET.

GOVERNING CODES:

BUILDING: 2018 INTERNATIONAL RESIDENTIAL CODE (IRC) MECHANICAL: 2018 INTERNATIONAL RESIDENTIAL CODE (IMC) ELECTRICAL: 2017 NATIONAL ELECTRICAL CODE (NEC) PLUMBING: 2018 INTERNATIONAL PLUMBING CODE (IPC) FUEL GAS: 2018 INTERNATIONAL FUEL GAS CODE (IFGC) ENERGY: 2018 INTERNATIONAL ENERGY CONSERVATION CODE (IFGC) P00L: 2018 INTERNATIONAL SWIMMING POOL-SPA

SHEET INDEX:

COVER SHEET / SITE PLANS FLOOR PLAN FRAMING / FOUNDATION PLANS ELEVATIONS / BUILDING SECTIONS DETAILS - CARPORT PLAN

MECHANICAL/PLUMBING/ELECTRICAL PLAN

CODE (ISPC)

KEY NOTES

- 1. EXISTING CONCRETE SLAB 8. WATER METER
- 2. NEW EXTERIOR CONCRETE SLAB. 9. EXISTING ELECTRICAL PANEL/METER
- 3. ROOF LINE ABOVE.
- 4. EXISTING POOL AND DECK
- 5. EXISTING CHAINLINK FENCE
- 6. NEW A/C COMPRESSOR

7. PROPERTY LINE

- 10. EXISTING GAS METER 11. EXISTING SIDEWALK, CURB AND
- 12. EXISTING LAWN
- 13. NEW CHAINLINK ROLLING GATE

VICINITY MAP





A RESIDENTIA ALEX BA VIELSON AVENUE

COVER SHEET/ SITE PLANS

DRAWN CHECKED 12.27.18 SCALE PER PLAN JOB NO. AS1.0

04.06.22