GENERAL SITE NOTES

1. THE CONTRACTOR SHALL PERFORM THE WORK IN ACCORDANCE WITH ALL LAWS, CODE. ORDINANCES, RULES AND REGULATIONS OF ALL GOVERNING AGENCIES. OCCUPANTS ADJACENT TO THE E PROJECT AREA BOUNDARIES SHALL CONTINUE UNINTERRUPTED OCCUPANCY DURING CONSTRUCTION OF THE PROJECT.

2. IT IS THE SOLE RESPONSIBILITY OF THE CONTRACTOR TO NOTIFY THE LANDSCAPE ARCHITECT OF ANY AND ALL CONFLICTS WITH WORK RELATED TO THE HARDSCAPE AND 9. THE CONTRACTOR SHALL HAVE ALL BELOW-GRADE UTILITY AND SLEEVING WORK LANDSCAPE FEATURES PRIOR TO INSTALLATION OF THE UTILITIES IN ORDER TO MAINTAIN INSPECTED AND APPROVED PRIOR TO BEGINNING HARDSCAPE THE HIGHEST LEVEL OF DESIGN INTENT OF THE HARDSCAPE AND LANDSCAPE FEATURES. LAYOUT/MARKING/STAKING AND CONSTRUCTION.

3. THE CONTRACTOR SHALL PERFORM NO PORTION OF THE WORK AT ANY TIME WITHOUT 10. IT IS THE SOLE RESPONSIBILITY OF THE GENERAL CONTRACTOR AND ANY CONTRACT DOCUMENTS OR, WHERE REQUIRED, APPROVED SHOP DRAWINGS, PRODUCT SUBCONTRACTORS TO COORDINATE SERVICE ROUTING OF ALL UTILITIES INCLUDING DATA, OR SAMPLES FOR SUCH PORTIONS OF THE WORK.

4. COORDINATE THE WORK WITH ALL REQUIREMENTS INDICATED IN THE PROJECT DOCUMENTS.

AND COMPLY WITH ALL REQUIREMENTS INDICATED ON THE PROJECT DOCUMENTS.

6. THE CONTRACTOR SHALL COORDINATE THE WORK WITH EQUIPMENT, FURNISHINGS AND SYSTEMS PRESENT OR PROVIDED BY THE OWNER.

7. VERIFY LOCATIONS OF ALL BUILDINGS, WALLS, EXISTING STRUCTURES, PIPES, ELECTRICAL AND ALL ELEMENTS AFFECTING LANDSCAPE SCOPE OF WORK WITH ARCHITECTURAL AND ENGINEERING DRAWINGS. INFORMATION IN LANDSCAPE ARCHITECTURE PACKAGE IS TO BE READ IN CONJUNCTION WITH ALL RELEVANT ARCHITECTURAL AND ENGINEERING INFORMATION. ADDITIONAL UTILITIES AND SITE ELEMENTS MAY EXIST WHICH ARE NOT SHOWN HEREIN.

8. VERIFY LOCATION OF ALL ADJACENT AND BELOW-GRADE ELECTRICAL, PLUMBING. DATA, CONDUIT, PIPING, DRAINAGE STRUCTURES AND OTHER UTILITY CONNECTIONS WITH THE APPROPRIATE AS-BUILT OR ENGINEERING DRAWINGS. THE CONTRACTOR IS RESPONSIBLE FOR THIS VERIFICATION AND THE PROTECTION OF THESE ELEMENTS. THE CONTRACTOR IS RESPONSIBLE FOR REPAIR OF ANY DAMAGE INCURRED DURING THE EXECUTION OF THE WORK.


BUT NOT LIMITED TO WATER, GAS, TELEPHONE, ELECTRICAL, STORM, SEWER, AND IRRIGATION WITH THE OWNER AND TO AVOID CONFLICTS WITH HARDSCAPE AND LANDSCAPE FEATURES. ALL CONSTRUCTION MUST COMPLY WITH THE PROJECT SPECIFICATIONS AND NOT INTERFERE WITH BUILDING ELEMENTS TO BE PRESERVED.

5. THE CONTRACTOR SHALL PROVIDE COMPLETE PROJECT SYSTEMS AND COMPONENTS 11. ALL MATERIAL SHALL BE NEW, UNUSED AND TO THE HIGHEST QUALITY IN EVERY RESPECT UNLESS OTHERWISE NOTED.

> 12. PERFORM THE WORK AT THE PROJECT SITE DURING HOURS SPECIFIED BY THE OWNER.

13. ANY DAMAGE INCURRED DURING THE EXECUTION OF CONSTRUCTION TO EXISTING TREES OR STRUCTURES IS THE SOLE RESPONSIBILITY OF THE CONTRACTOR.

14. THE CONTRACTOR WILL BE RESPONSIBLE FOR CLEANING ALL WALLS, PAVEMENTS, AND OTHER SURFACES PRIOR TO FINAL INSPECTION.

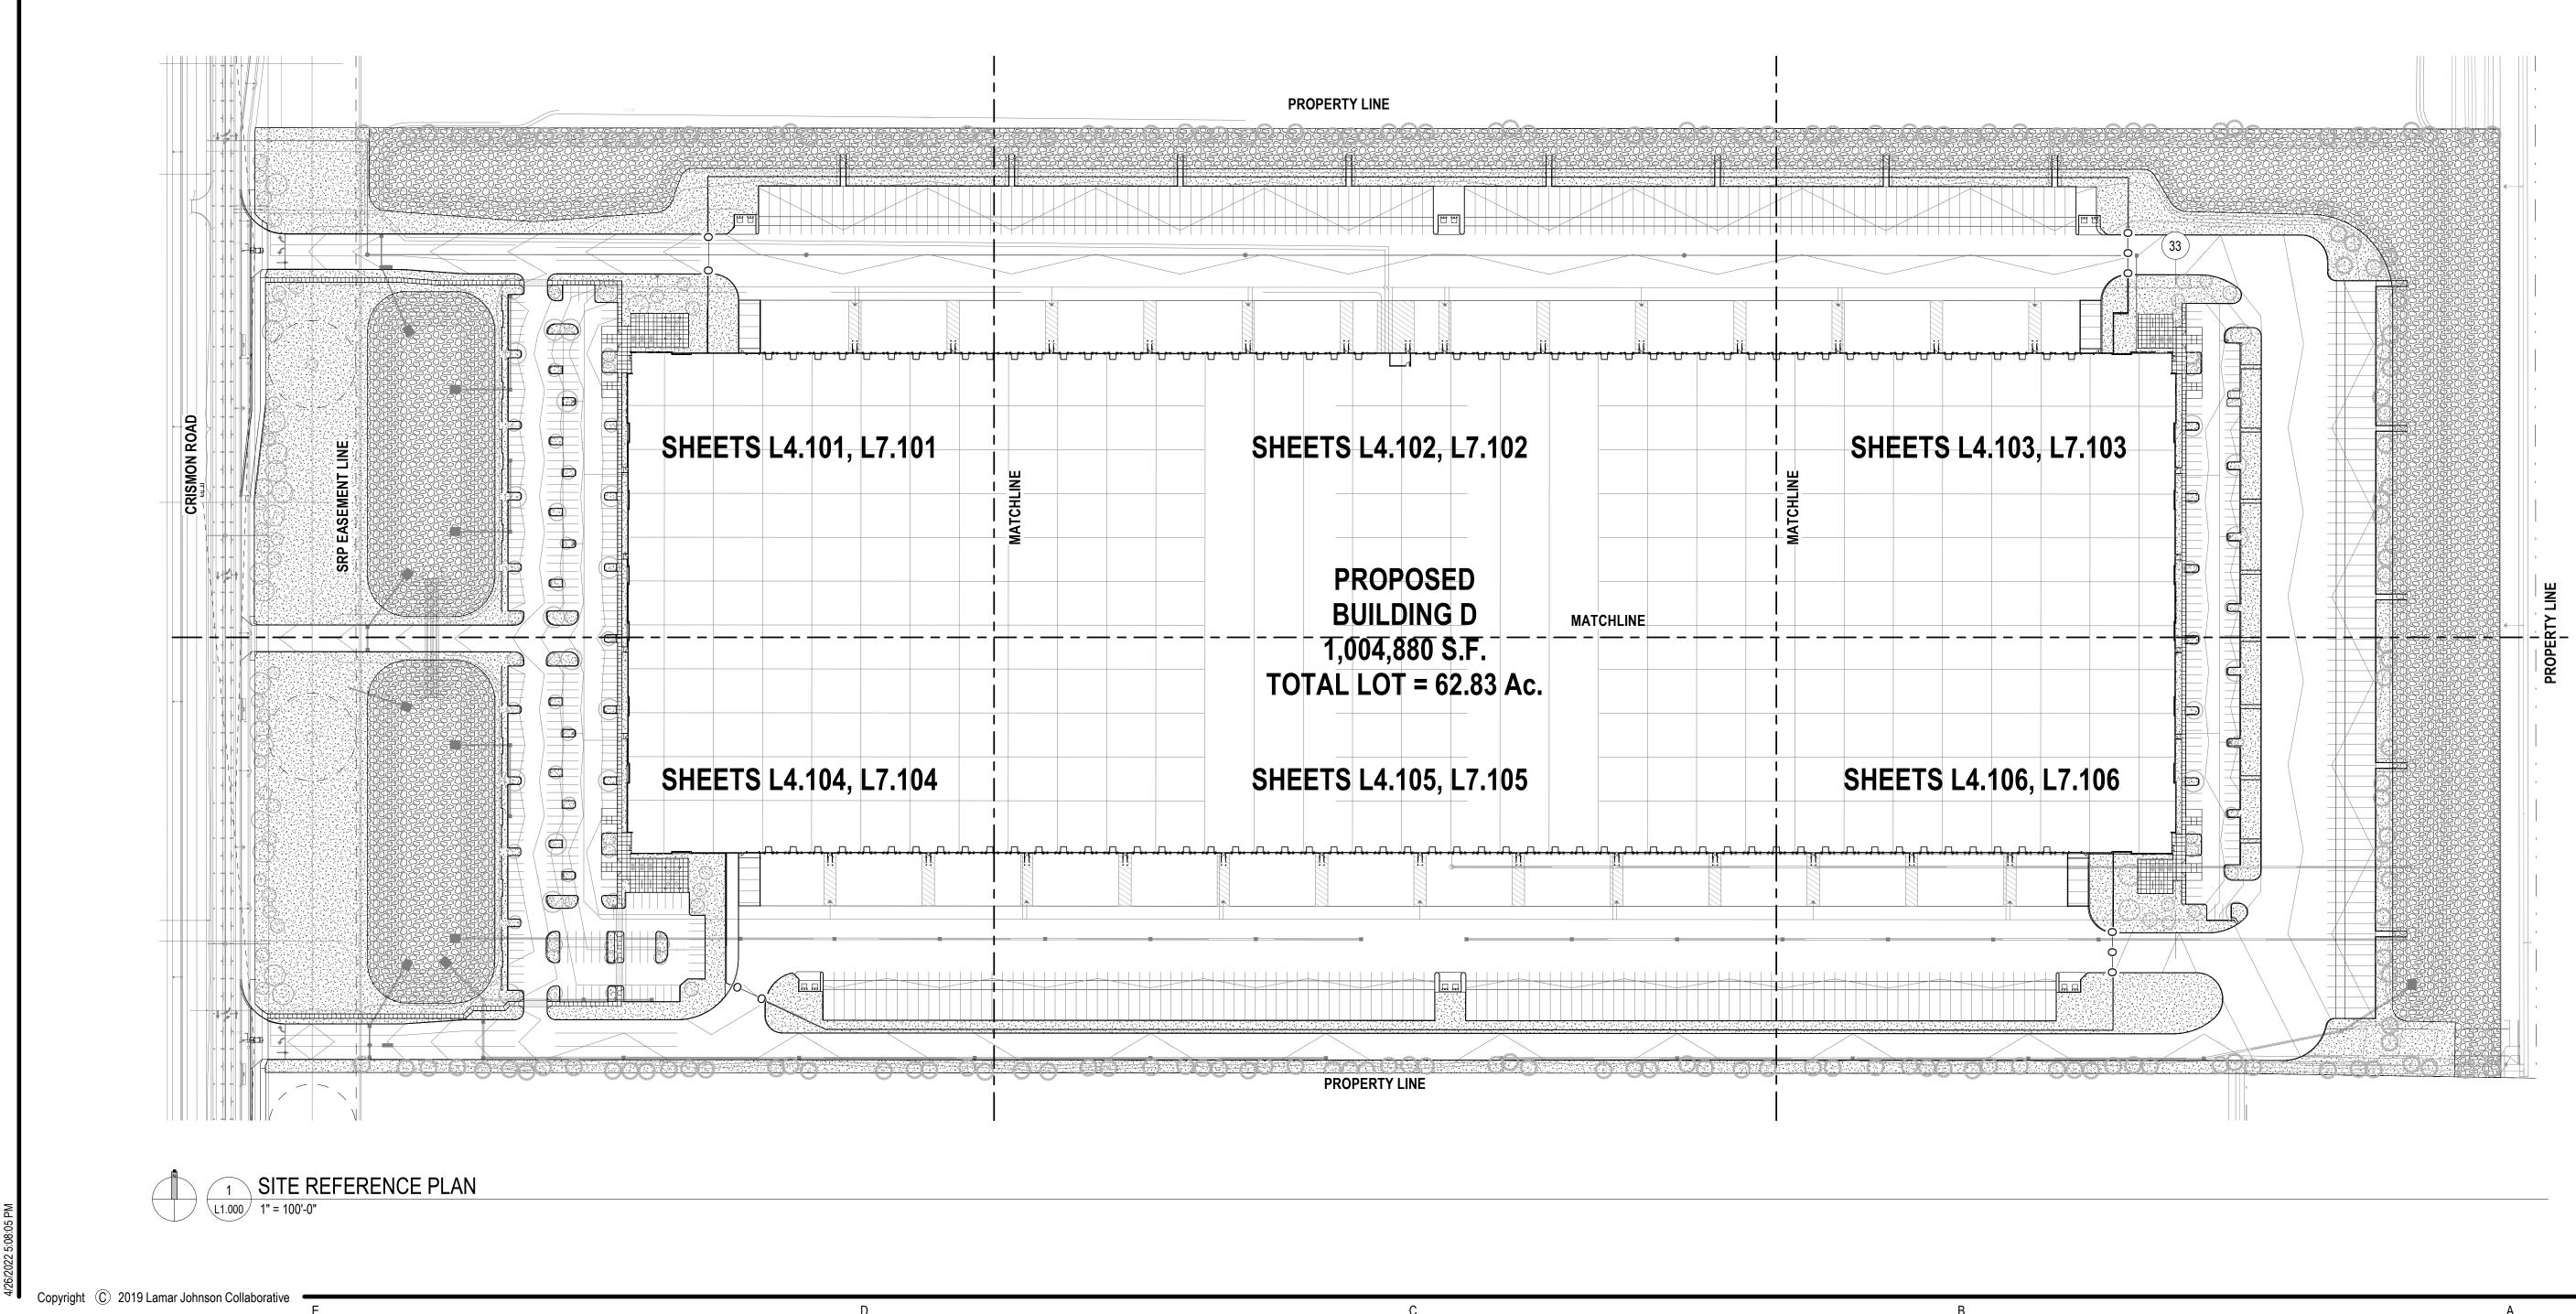

15. REFERENCE TO SCALE IS FOR FULL-SIZE DRAWINGS. DIMENSIONS SHOWN ON DRAWINGS TAKE PRECEDENCE OVER SCALED DIMENSIONS. DO NOT SCALE FROM DRAWINGS.

16. THE CONTRACTOR IS RESPONSIBLE FOR ACCURATE HORIZONTAL AND VERTICAL ALIGNMENT AND PREPARATION OF LAYOUT/MARKING/STAKING. THE CONTRACTOR IS REQUIRED TO PERFORM CONSTRUCTION LAYOUT/MARKING/STAKING AND SET ELEVATIONS FOR THE FORM WORK PRIOR TO INSPECTION BY THE ARCHITECT FOR APPROVAL.

17. ALL BUILDINGS, WALLS, COLUMNS, STRUCTURES, AND ANY VERTICAL ELEMENTS THAT ABUT CONCRETE PAVING ARE TO HAVE EXPANSION JOINT AS DETAILED HEREWITH.

18. ALL FORM WORK SHALL BE APPROVED FOR GEOMETRY AND GRADES BY THE ARCHITECT PRIOR TO INSTALLATION OF PAVEMENT, PLANTERS OR WALLS.

19. ALL ANGLES TO BE 90 DEGREES AND ALL LINES OF PAVING TO BE PARALLEL UNLESS OTHERWISE NOTED. MAINTAIN HORIZONTAL ALIGNMENT OF ADJACENT ELEMENTS AS NOTED ON THE DRAWINGS.

20. "TYPICAL" OR "TYP" INDICATES IDENTICAL COMPLETE SYSTEM SHALL BE PROVIDED FOR EACH OCCURRENCE OF THE CONDITION NOTES.

21. "SIMILAR" OR "SIM" INDICATES COMPLETE SYSTEM AND COMPONENTS SHALL BE PROVIDED COMPARABLE TO THE CHARACTERISTICS FOR THE CONDITION NOTED.

22. "AS REQUIRED" INDICATES COMPONENTS REQUIRED TO COMPLETE THE E NOTED SYSTEM AS INDICATED IN THE PROJECT DOCUMENTS SHALL BE PROVIDED. 23. "ALIGN" INDICATES ACCURATELY PROVIDE FINISH OF FACES OF MATERIALS IN STRAIGHT, TRUE, AND PLUMB RELATION TO ADJACENT MATERIALS.

24. TAKE ALL DIMENSIONS FROM FACE OF FIXED OBJECTS, WALL, OR BUILDING OR TO CENTERLINE OF COLUMNS UNLESS OTHERWISE NOTED. ALL DIMENSIONS CALLED OUT AS "EQUAL" ARE EQUIDISTANT MEASUREMENTS TO DESIGNATED CENTERLINE(S).

25. ALL LANDSCAPE DIMENSIONS TAKEN TO CENTERLINE OF BUILDING COLUMN SHALL MEAN THE FIRST ROW OF COLUMNS CLOSEST TO THE FACE OF THE BUILDING. SEE ARCHITECTURAL AND AS-BUILT DRAWINGS FOR CORRESPONDING COLUMN LINES.

26. TAKE ALL DIMENSIONS PERPENDICULAR TO ANY REFERENCE LINE, WORK LIKE, FACE OF BUILDING, FACE OF WALL, OR CENTERLINE.

27. WHERE NOT SHOWN ON LANDSCAPE DRAWINGS, SEE ENGINEERING AND AS-BUILT DRAWINGS FOR COLUMN GRID, CENTERLINES, BUILDING FACES, AND BENCHMARKS.

28. SEE DRAWINGS FOR DIMENSION OF SITE ELEMENTS. NOTES AND DETAILS ON SPECIFIC DRAWINGS TAKE PRECEDENCE OVER GENERAL NOTES AND TYPICAL DETAILS.

29. IF DIMENSIONS VARY BY 1" OR MORE, CONTACT THE ARCHITECT FOR REVIEW AND CONFIRMATION PRIOR TO PROCEEDING WITH CONSTRUCTION.

30. FINISH ELEVATIONS ARE INDICATED TO THE FACE OF PAVEMENT OR FINISHED GRADE OF SOIL AS APPLICABLE, UNLESS OTHERWISE NOTED.

31. ALL NEW WORK TO MEET FLUSH WITH ALL EXISTING GRADES AND FINISH FLOOR ELEVATIONS AT DOORS. THRESHOLDS. STAIRWELLS. PAVEMENTS TO REMAIN, COLUMNS, AND BUILDING ELEMENTS EXCEPT AS NOTED HEREIN.


32. GRADES BETWEEN SPOT ELEVATIONS ARE INTENDED TO BE CONSTANT SLOPES.

33. NO FINISHED SLOPES SHALL BE LESS THAN 1/2 (HALF) PERCENT AND ALL SHALL HAVE A POSITIVE FLOW.

34. THE CONTRACTOR SHALL PROVIDE PLANT MATERIAL QUANTITIES TO MATCH THE DRAWINGS AND TO PROVIDE TOTAL COVERAGE AT THE SPECIFIED SPACING.

35. THERE SHALL BE NO SUBSTITUTIONS OF PLANT MATERIAL WITHOUT APPROVAL OF THE OWNER/ARCHITECT. THE OWNER/ARCHITECT ALONE SHALL DETERMINE EQUALITY BASED UPON COMPLETE INFORMATION SUBMITTED BY THE CONTRACTOR. SUBSTITUTIONS SHALL NOT BE MADE UNLESS DRAWINGS AND/OR WRITTEN REQUESTS ARE SUBMITTED TO THE OWNER/ARCHITECT FOR APPROVAL.



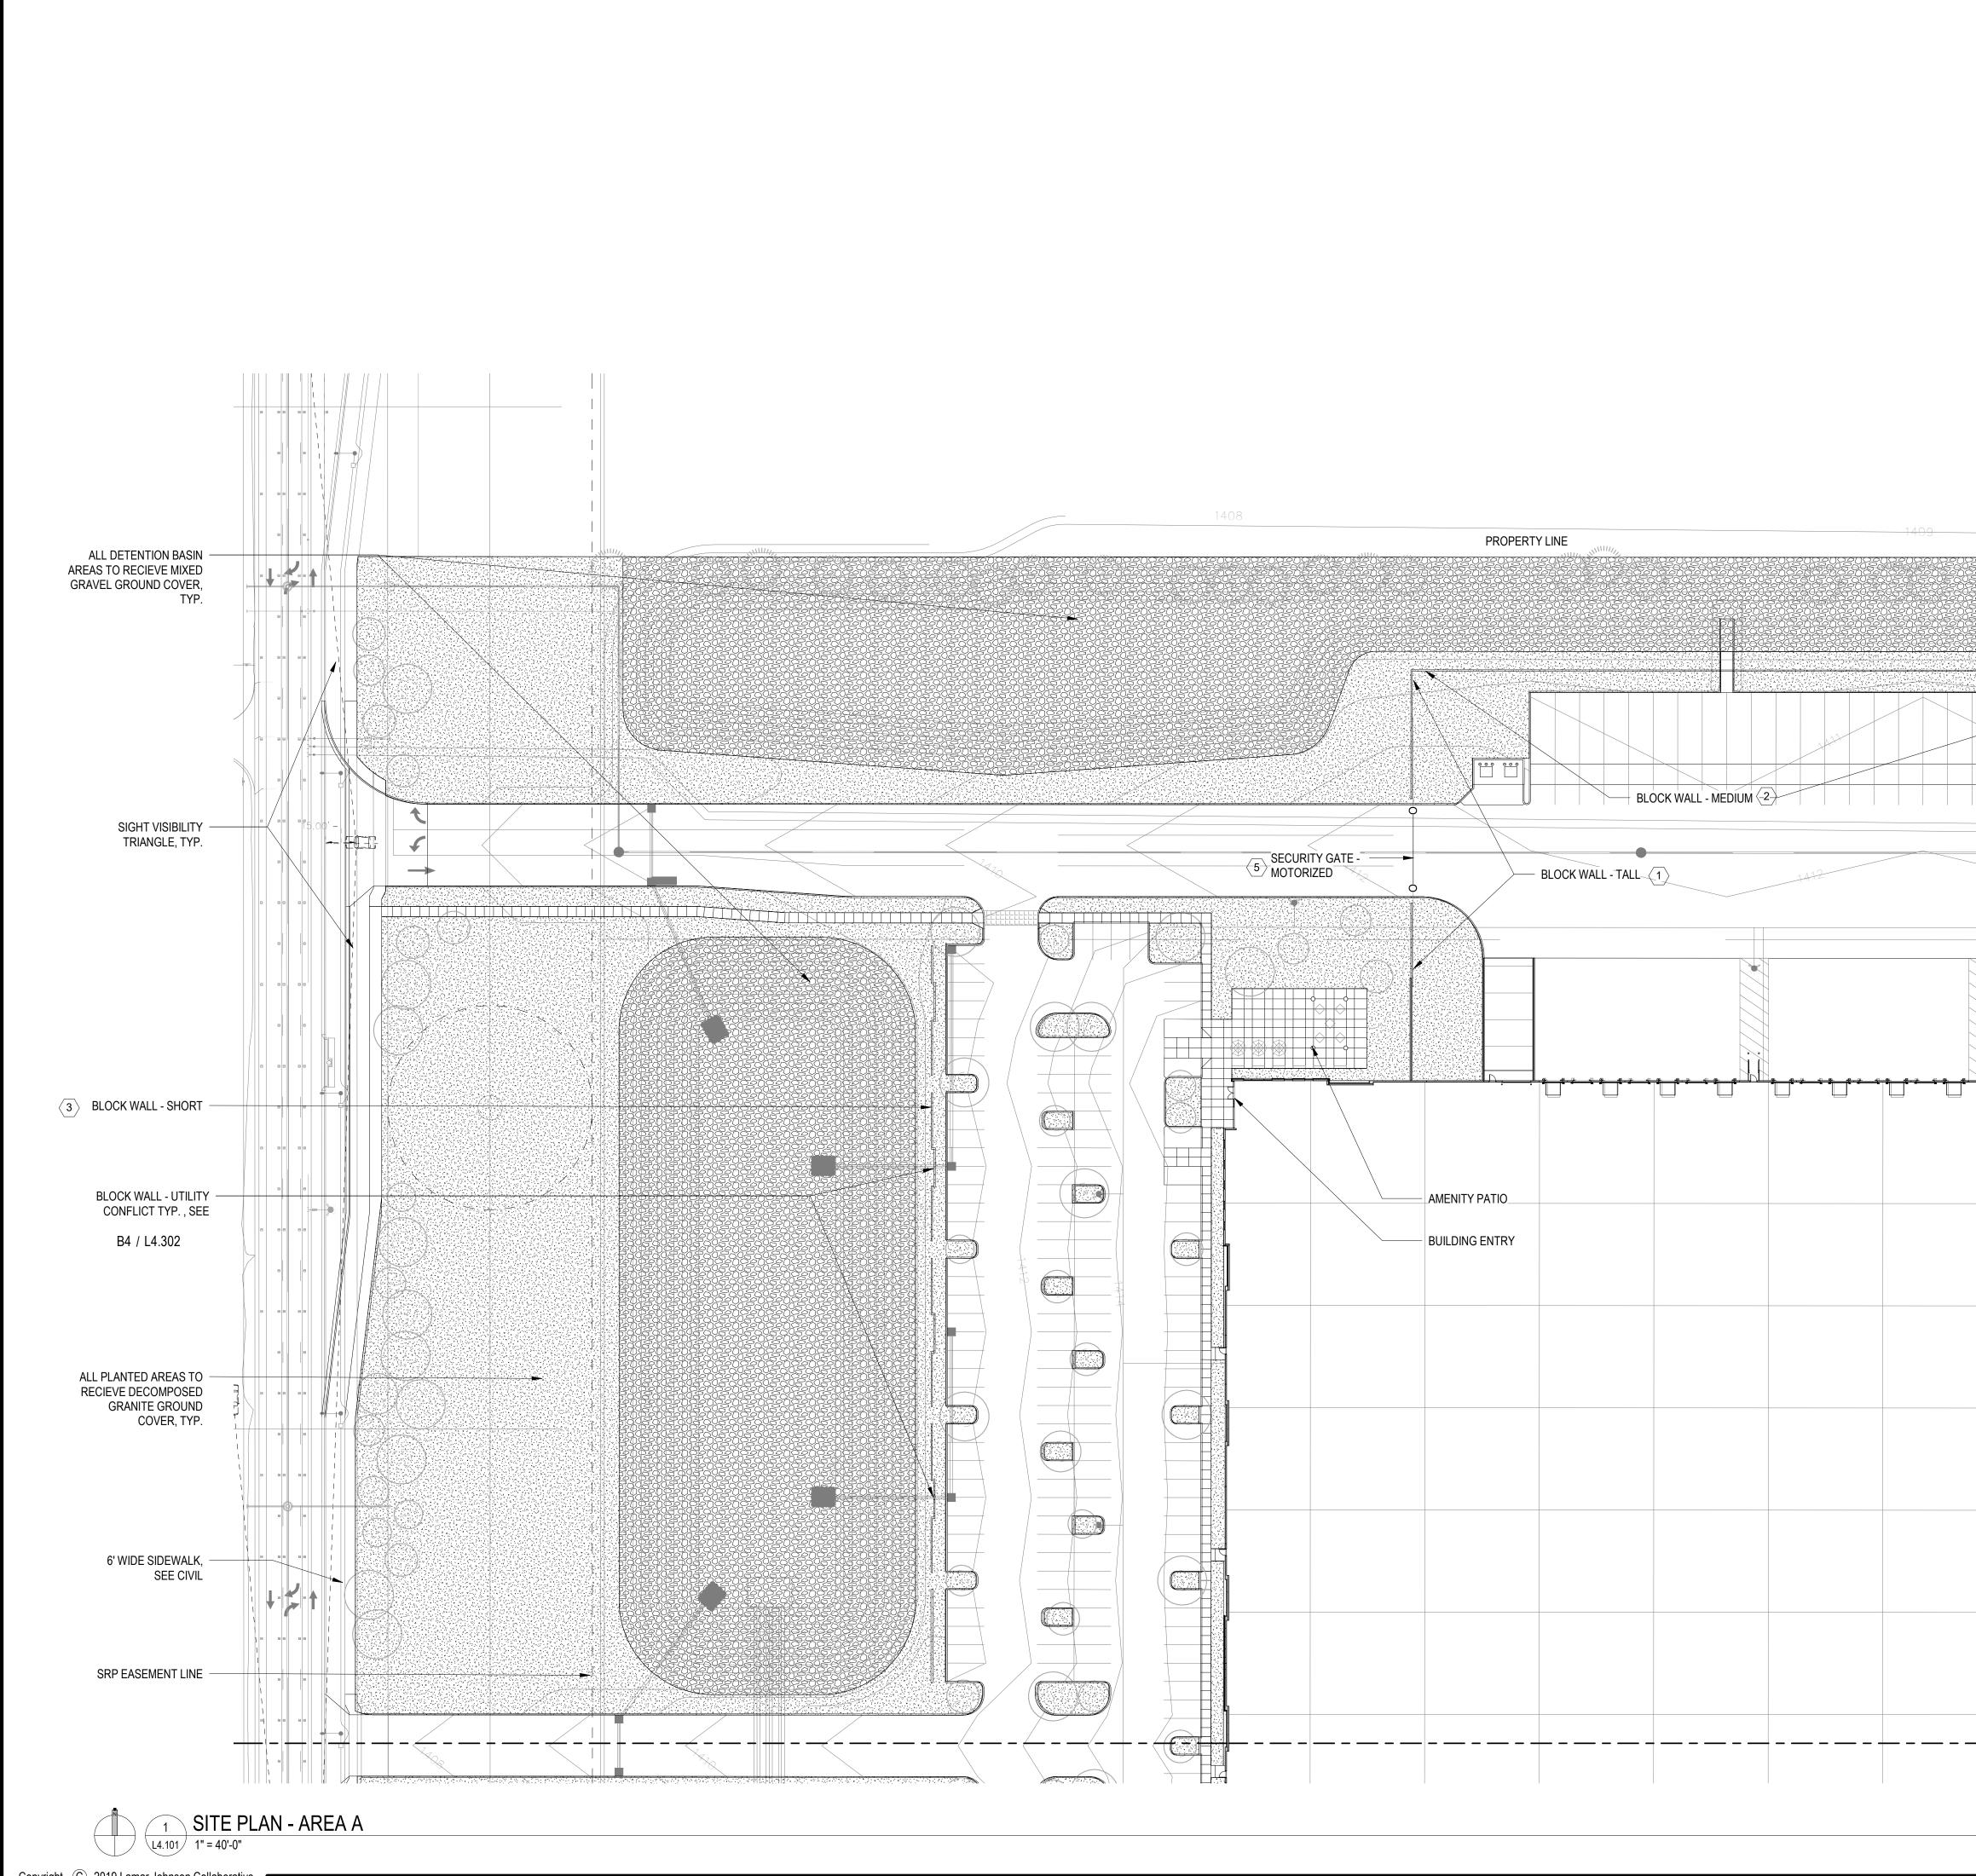

Copyright C 2019 Lamar Johnson Collaborative


Е

D

С


В

		ET NOTES	DETAIL B2 / L4.301	
	2. CONCRET	TE BLOCK WALL - MEDIUM TE BLOCK WALL - SHORT	B2 / L4.301 B2 / L4.301 B1 / L4.301	
	5. SECURITY 6. SECURITY	Y GATE - MOTORIZED Y GATE	E1 / L4.302 SEE SPECS	4 5NICTING
		R TO PROVIDE SHOP DRAWINGS FOR F GATES. SEE SPECS FOR REQUIREMEN		OF BUIL
	LEGEND SYMBOL	DESCRIPTION	DETAIL	CLLAXCO THE ART & SCIENCE OF B 2199 INNERBELT BUSINESS CENTER DRIVE ST. LOUIS, MISSOURI 63114 Ph 314.429.5100 Fx 314.429.3137
		CONCRETE WALK	SEE CIVIL	T BUSINE SOURI 63 FX 314.4
		DETENTION BASIN WITH GRAVEL	C4 / L4.301	THE ART & NINERBELT BUSI DUIS, MISSOURI
		DECOMPOSED GRANITE	E4 / L4.301	2199 IP ST. LO Ph 314
				Lamar Johnson Collaborative 「
				2199 INNERBELT BUSINESS CENTER DRIVI ST. LOUIS, MISSOURI 6311 Ph 314.429.101
				3
				70418 MATTHEW
				MARANZANA
				04.25.20
				CRG INTEGRATE REAL ESTA SOLUTIONS
				85212 B5212
				A, AZ
				 - BULLDINC S CRISMON RD, MESA, AZ 85
SE I				SISMC N
				S B S
				MESA E PECOS RD & S
				DRAWING ISSUE DESCRIPTION DATE DESIGN REVIEW 04/25/202
				DESIGN REVIEW 04/25/202
				1
				DRAWING TITLE SITE PLAN - AREA A
				DRAWING NO.
				L4.101

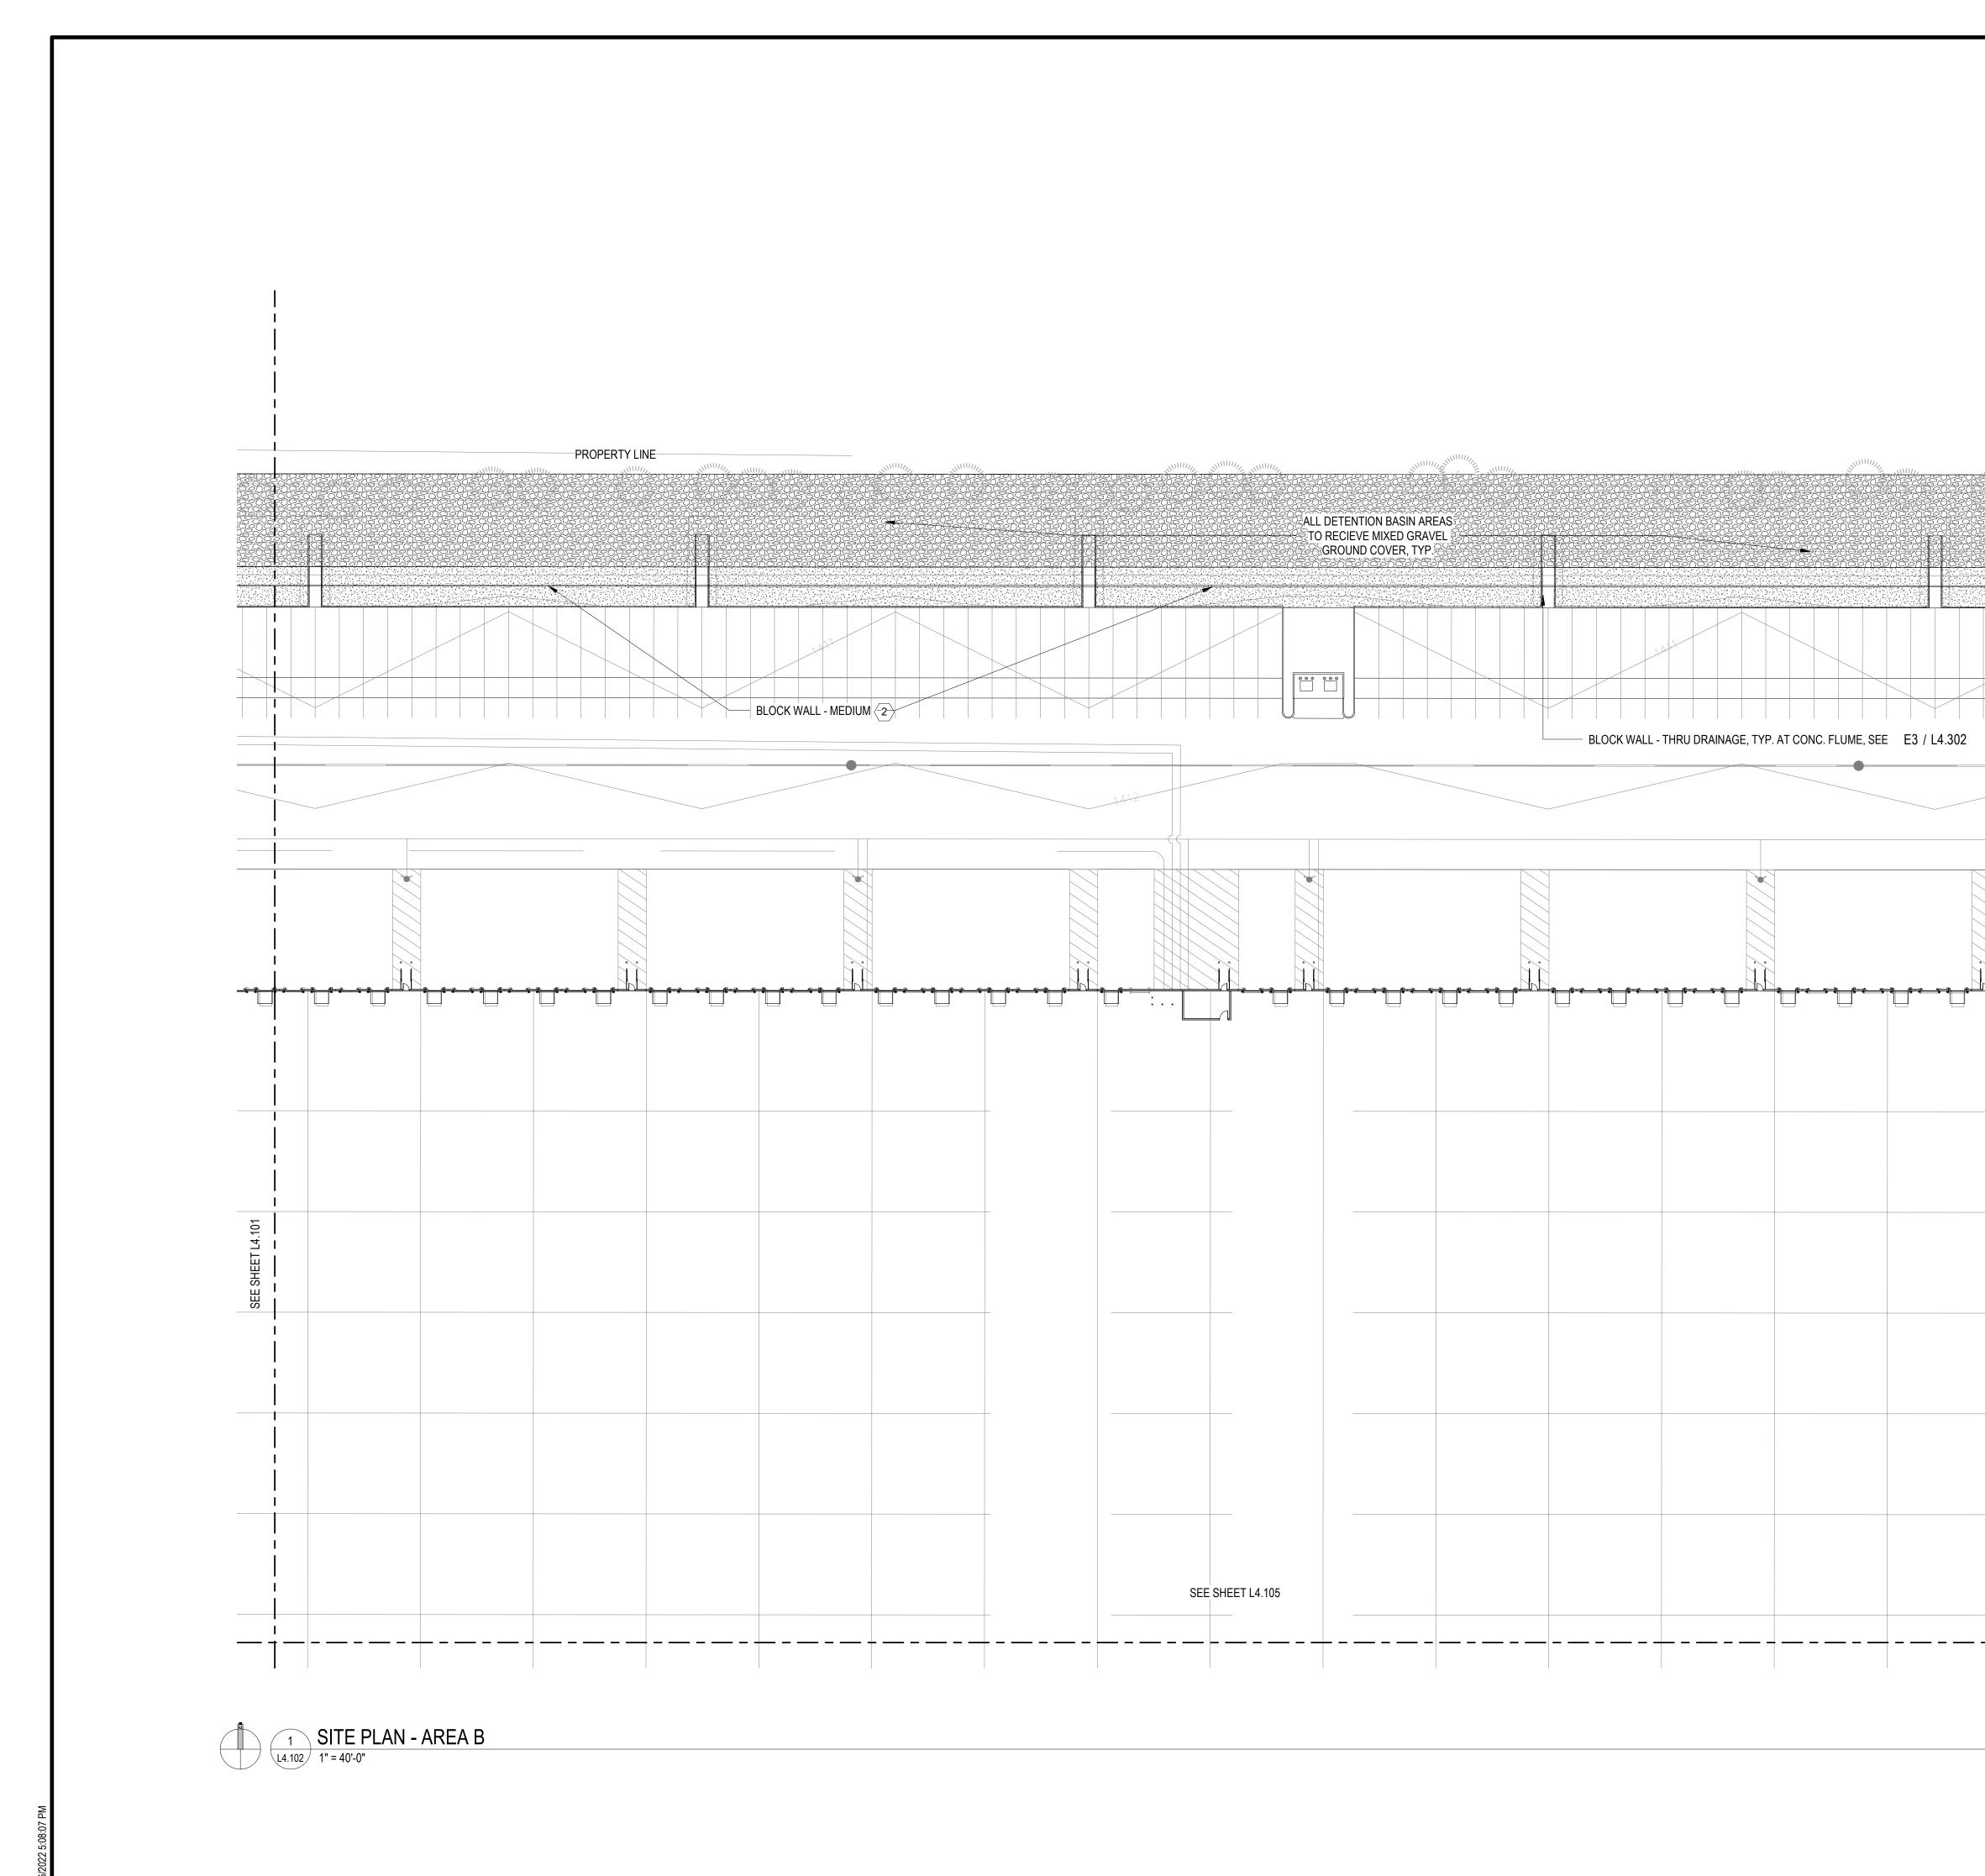


F

2. CONCRI 3. CONCRI 4	ETE BLOCK WALL - TALL ETE BLOCK WALL - MEDIUM ETE BLOCK WALL - SHORT IY GATE - MOTORIZED IY GATE	B2 / L4.301 B2 / L4.301 B1 / L4.301 E1 / L4.302 SEE SPECS	U Z
NOTE: CONTRACTO	OR TO PROVIDE SHOP DRAWINGS FOR F L GATES. SEE SPECS FOR REQUIREMEN	ENCING AND NON-	OF BUILDING DRIVE
LEGEND SYMBOL	DESCRIPTION CONCRETE WALK DETENTION BASIN WITH GRAVEL DECOMPOSED GRANITE	DETAIL SEE CIVIL C4 / L4.301 E4 / L4.301	THE ARE A CIENCE OF B DECADOR OF B THE AR SCIENCE OF B 101314205100 FX314203131 D1314205100 FX314203131 D1314205100 FX314203131 D1314205100 FX314203131 D1314205100 FX314203131 D131420510 FX31420510 FX314203131 D131420510 FX31420510 FX31420510 FX314203131 D131420510 FX31420510 FX31420510 FX31420510 D131420510 FX31420510 FX31420510 FX31420510 FX31420510 D131420510 FX31420510 FX31420510 FX31420510 D131420510 FX31420510 FX31420510 D131420510 FX31420510 FX31420510 D131420510 FX31420510 D131420510 FX31420510 D131420510 FX31420510 D131420510 FX31420510 D131420510 FX31420510 D131420510 FX31420510 D131420510 FX31420510 D1314200000000000000000000000000000000000
			3 TOTALS
SEE SHEET L4.103			A - BULLDING D & S CRISMON RD, MESA, AZ 85212
			Sign and seven and se
			1

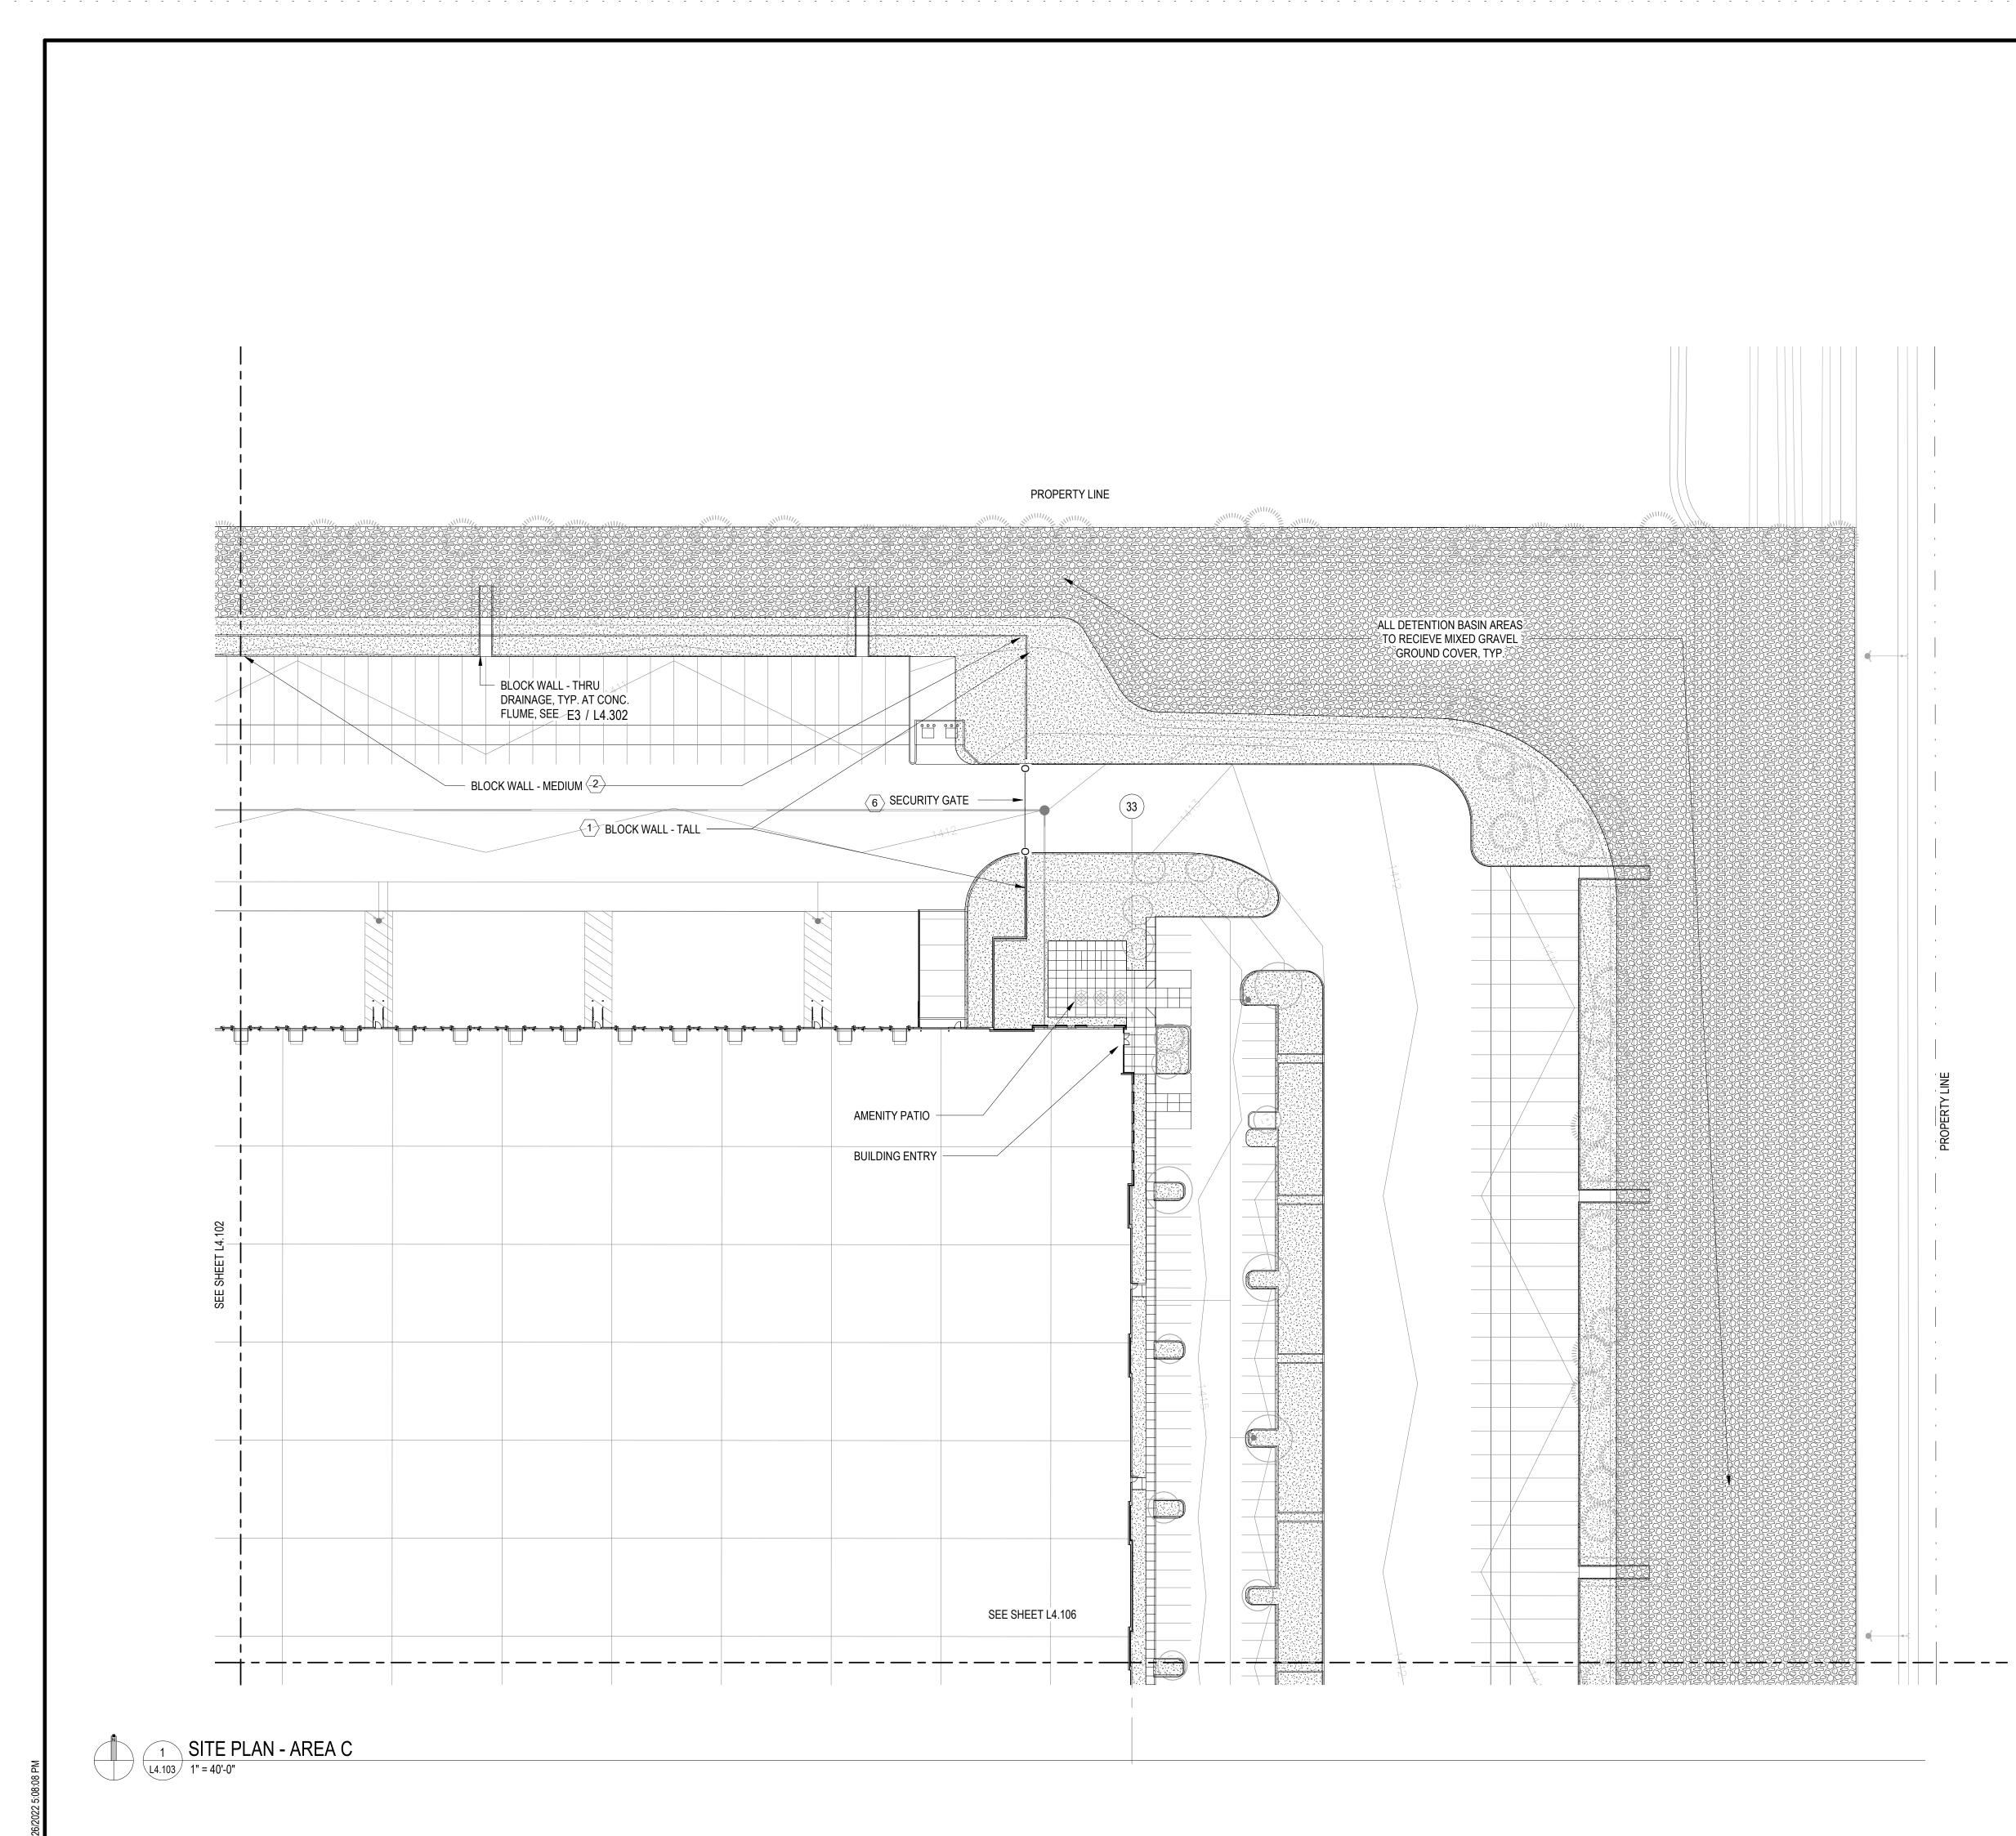



F

2. CONCRETE BI	LOCK WALL - TALL LOCK WALL - MEDIUM	B2 / L4.301 B2 / L4.301 B1 / L4.301	
 CONCRETE BI - SECURITY GA SECURITY GA 		B1 / L4.301 E1 / L4.302	U Z
NOTE: CONTRACTOR TO	PROVIDE SHOP DRAWINGS FOR F ES. SEE SPECS FOR REQUIREMEN		OF BUILDING DRIVE
LEGEND			CLANCO THE ART & SCIENCE OF B 2199 INNERBELT BUSINESS CENTER DRIVE ST. LOUIS, MISSOURI 63114 ST. LOUIS, MISSOURI 63114
SYMBOL D	ESCRIPTION	DETAIL	& SC BUSINESS
ESSE	ONCRETE WALK	SEE CIVIL	E ART E ART S, MISSOL
	ETENTION BASIN WITH GRAVEL		TH TH
**************************************	ECOMPOSED GRANITE	E4 / L4.301	
			Lamar Johns Collaborative
			2199 INNERBELT BUSINESS CENTE ST. LOUIS, MISSOUF Ph 314.
			3
			SEPTIFICATE NO.
			MATTHEW
			A A A A A A A A A A A A A A A A A A A
			04.
			CRG INTEG
			Z 85212
			E PECOS RD & S CRISMON RD, MESA, AZ 8
			E PECOS RD
			DRAWING ISSUE
			DESIGN REVIEW 04/2
			1
			DRAWING TITLE SITE PLAN - AREA C

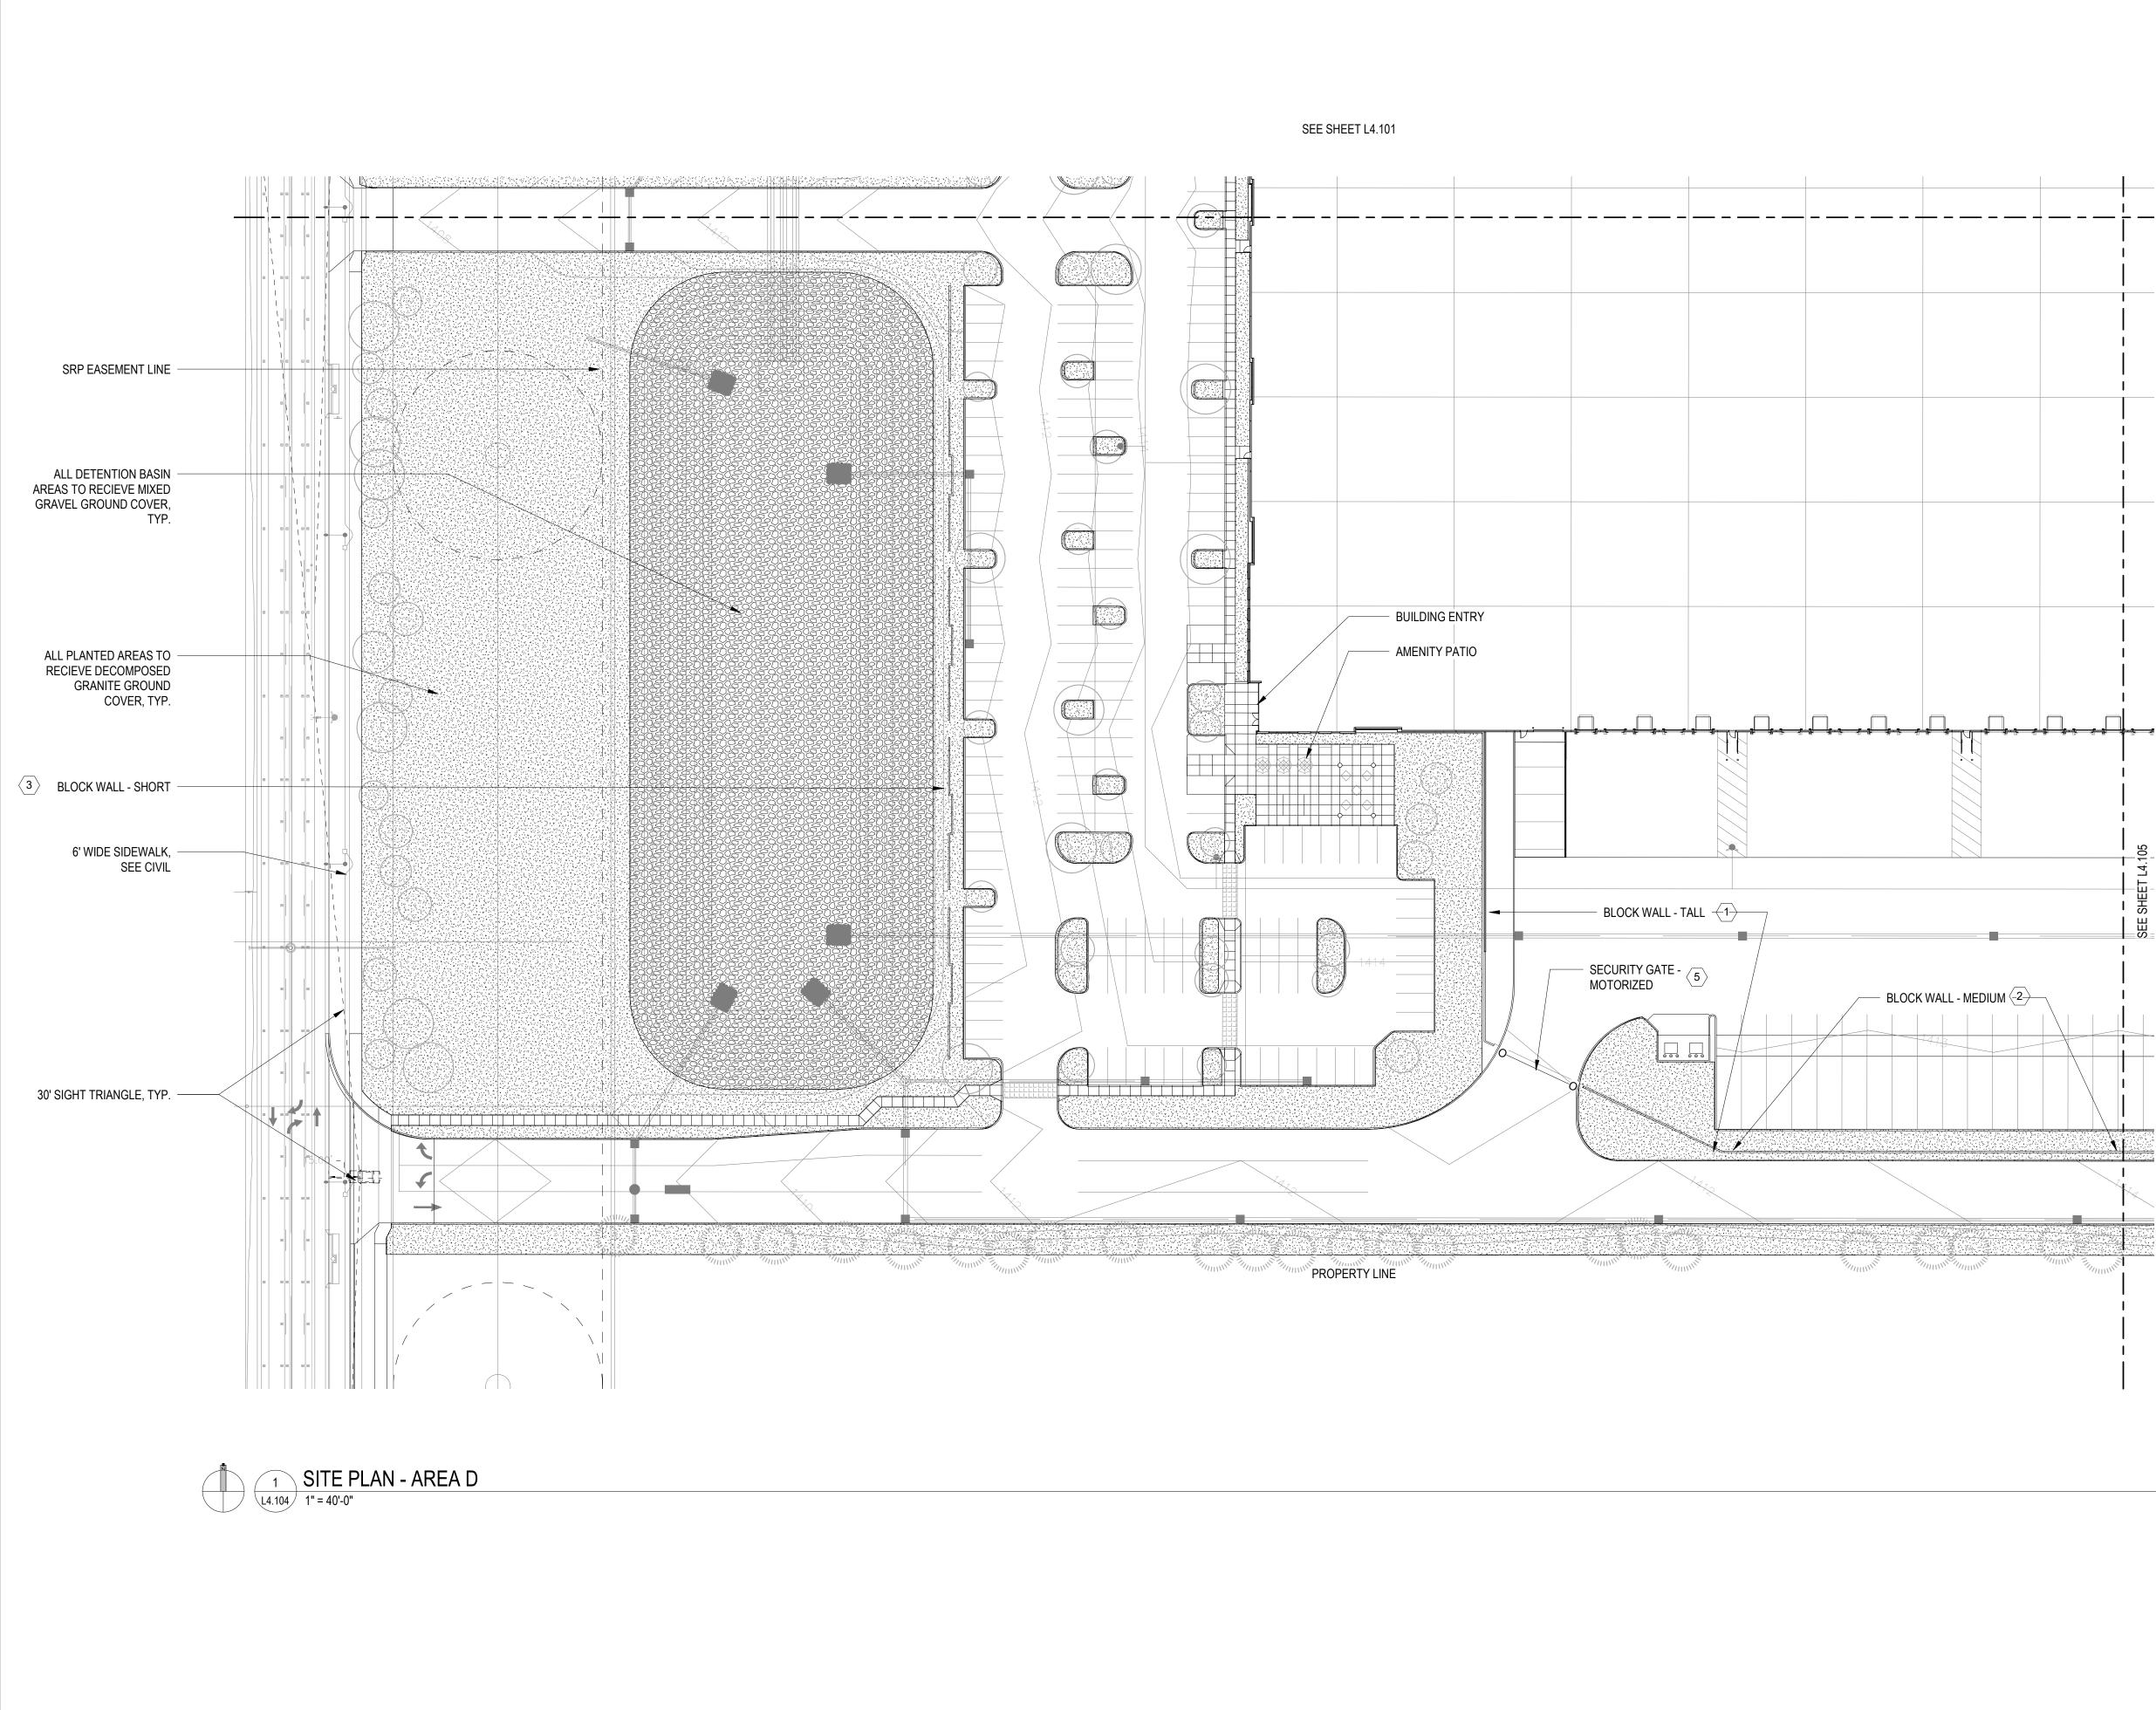

F

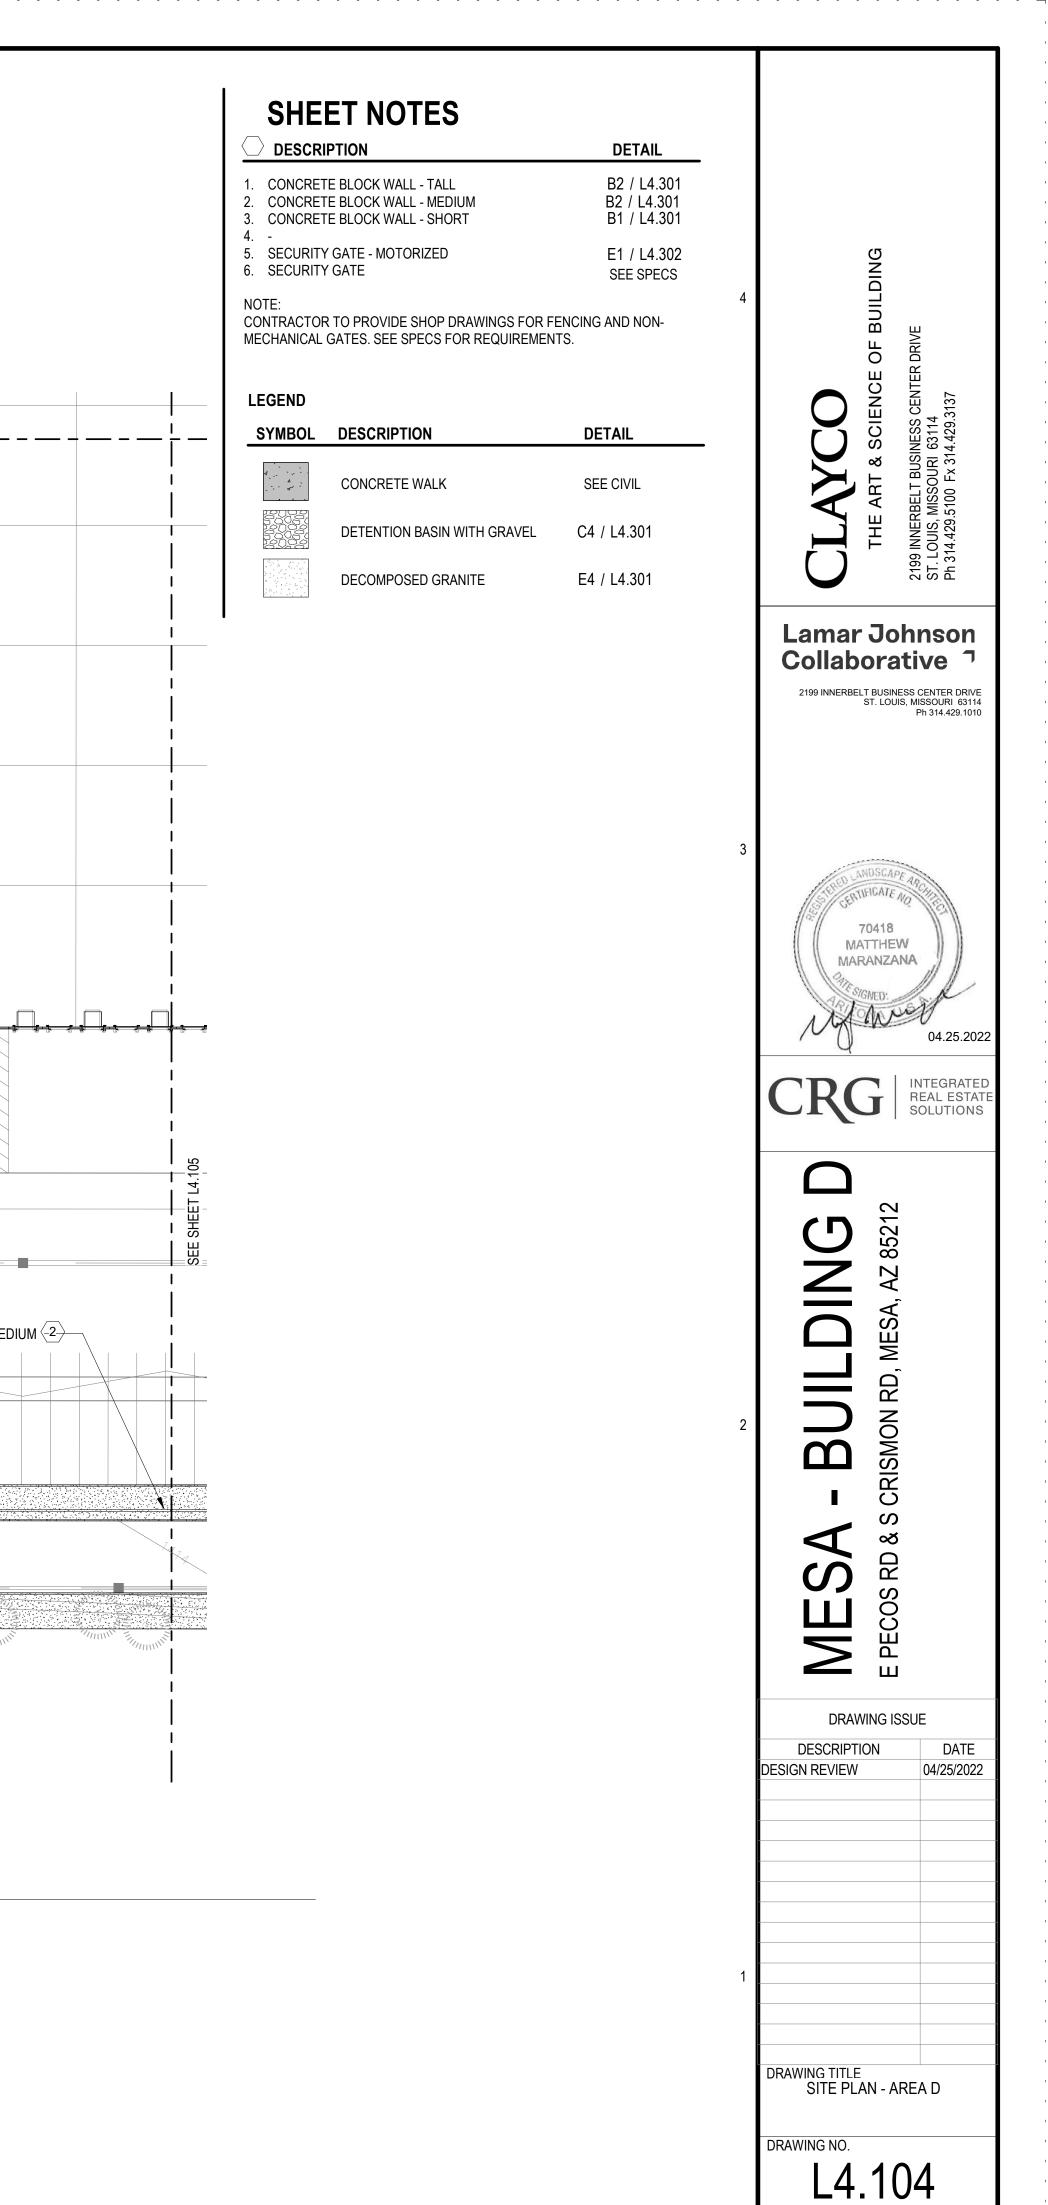

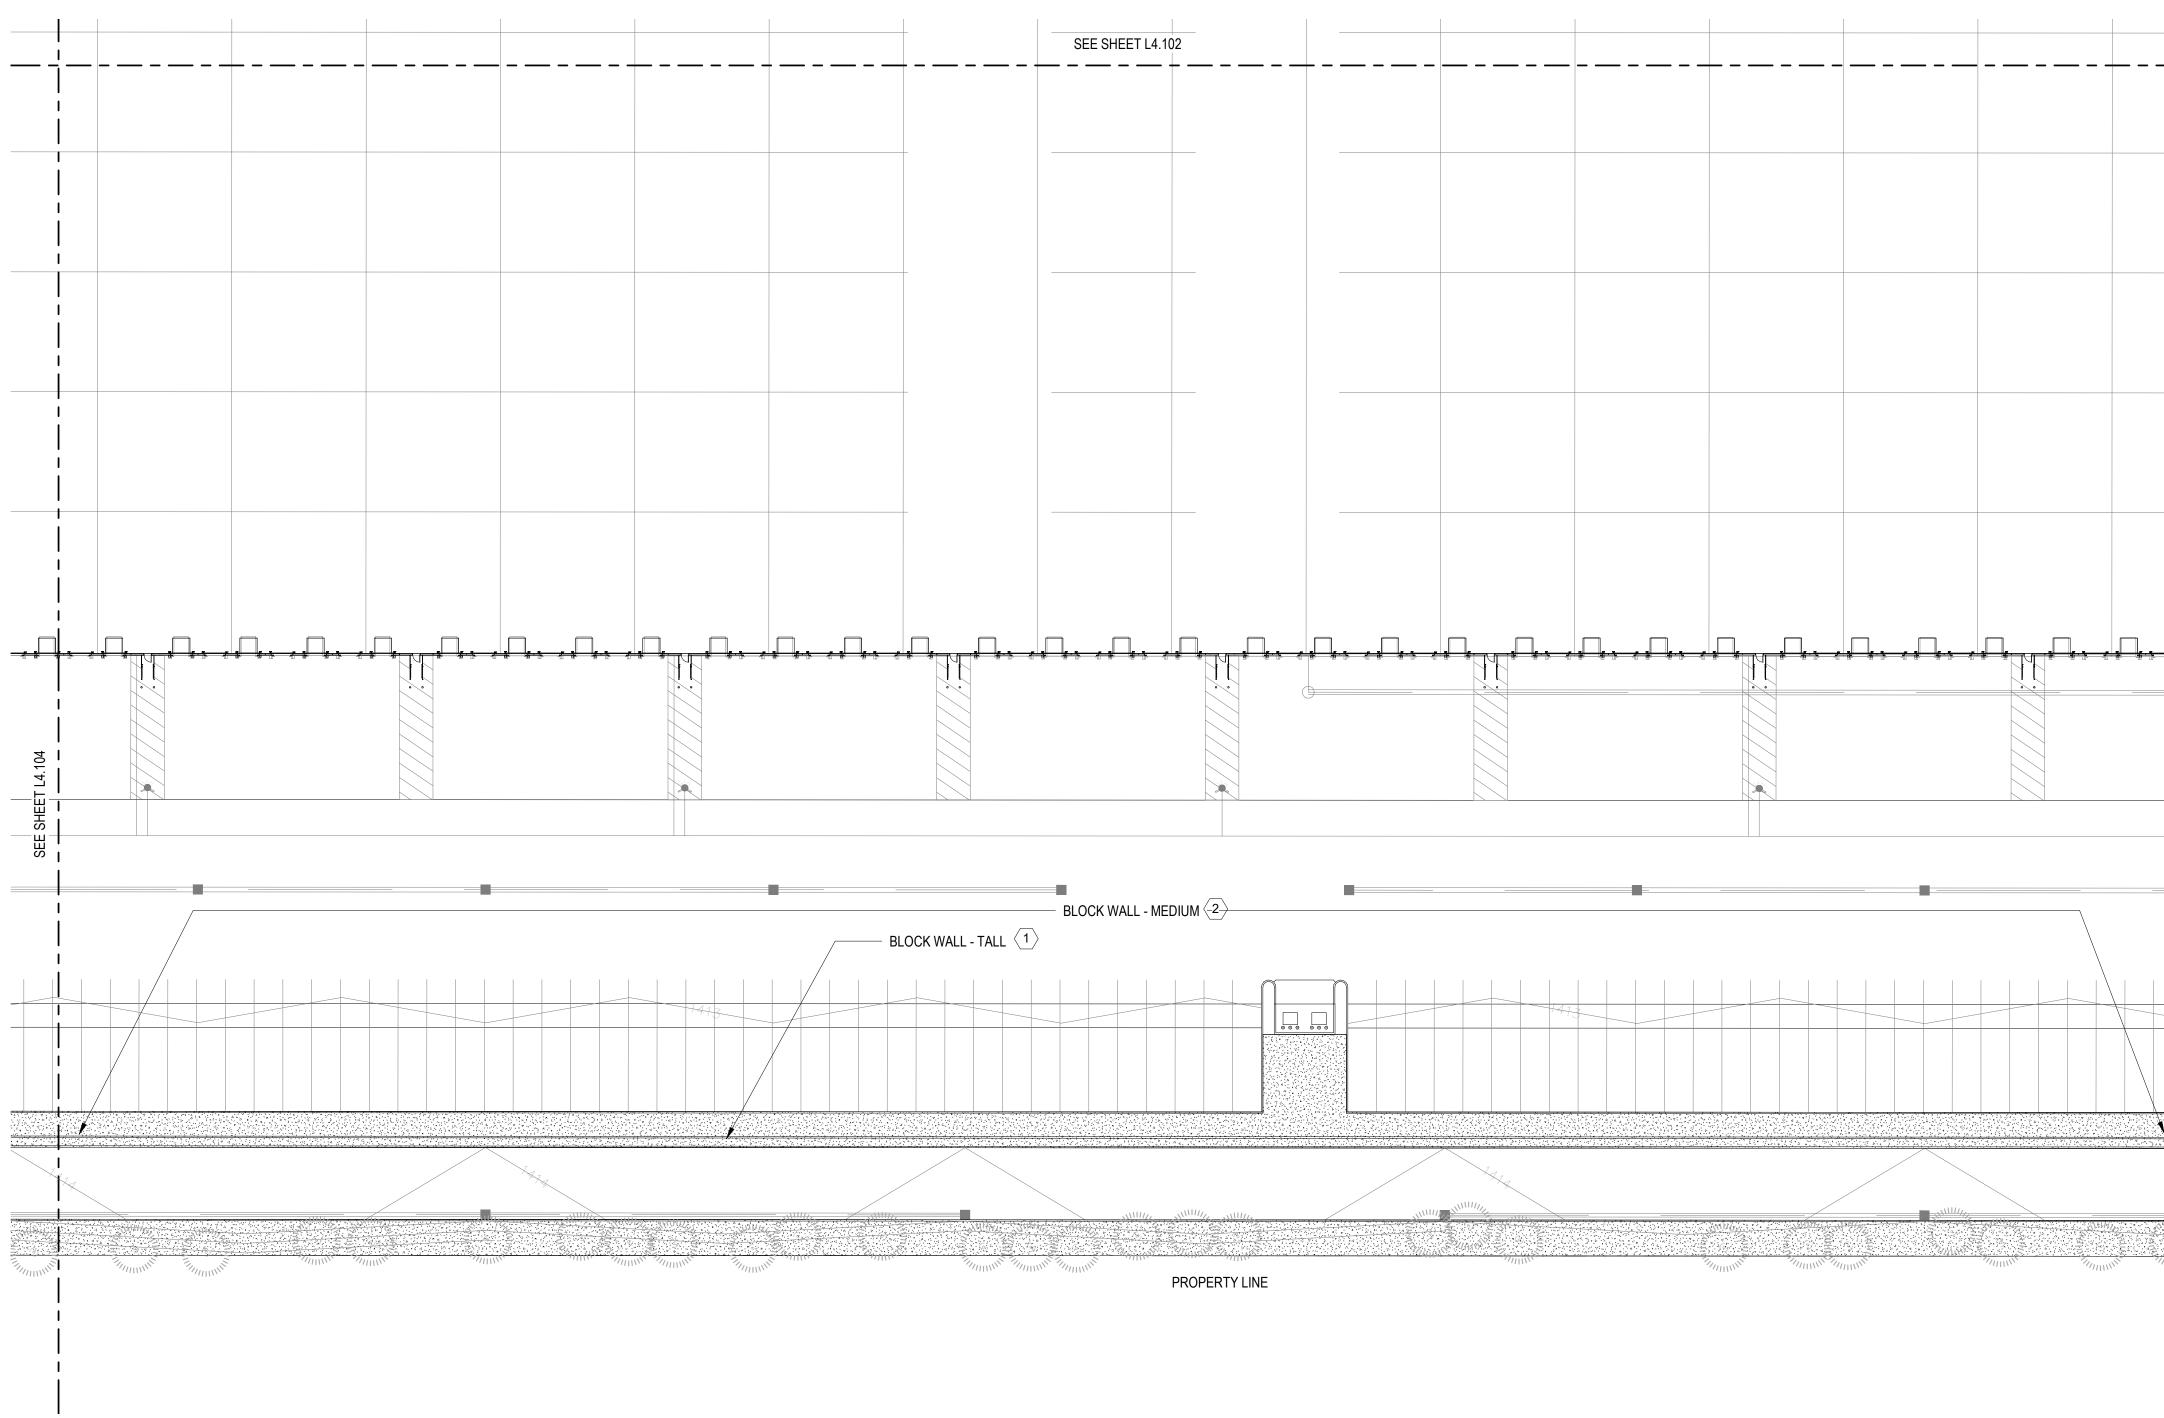




Е

DESC 1. CONCR 2. CONCR 3. CONCR 4 5. SECURI	EET NOTES RIPTION ETE BLOCK WALL - TALL ETE BLOCK WALL - MEDIUM ETE BLOCK WALL - MEDIUM ETE BLOCK WALL - SHORT TY GATE - MOTORIZED TY GATE	DETAIL B2 / L4.301 B2 / L4.301 B1 / L4.301 E1 / L4.302 SEE SPECS	Ŋ
	DR TO PROVIDE SHOP DRAWINGS FOR I L GATES. SEE SPECS FOR REQUIREMEI	FENCING AND NON-	OF BUILDING
LEGEND			CLLAYCO THE ART & SCIENCE OF B 2199 INNERBELT BUSINESS CENTER DRIVE ST. LOUIS, MISSOURI 63114 Ph 314.429.5100 Fx 314.429.3137
SYMBOL	DESCRIPTION CONCRETE WALK	SEE CIVIL	LEUSINES OURI 63142
	DETENTION BASIN WITH GRAVEL		HE AR INERBELT JIS, MISS
	DECOMPOSED GRANITE	E4 / L4.301	2199 IN T
			Lamar Johnson Collaborative
			3 Study LANDSCAPE ARC GENTIFICATE ARC TO418 MATTHEW MARANZANA
			CRG INTEGRATE REAL ESTA SOLUTION
			G ³⁵²¹²
			A, AZ 8
			Recose RD & S CRISMON RD, MESA, AZ 84
			DRAWING ISSUE
			1
			DRAWING TITLE SITE PLAN - AREA E
			drawing no.



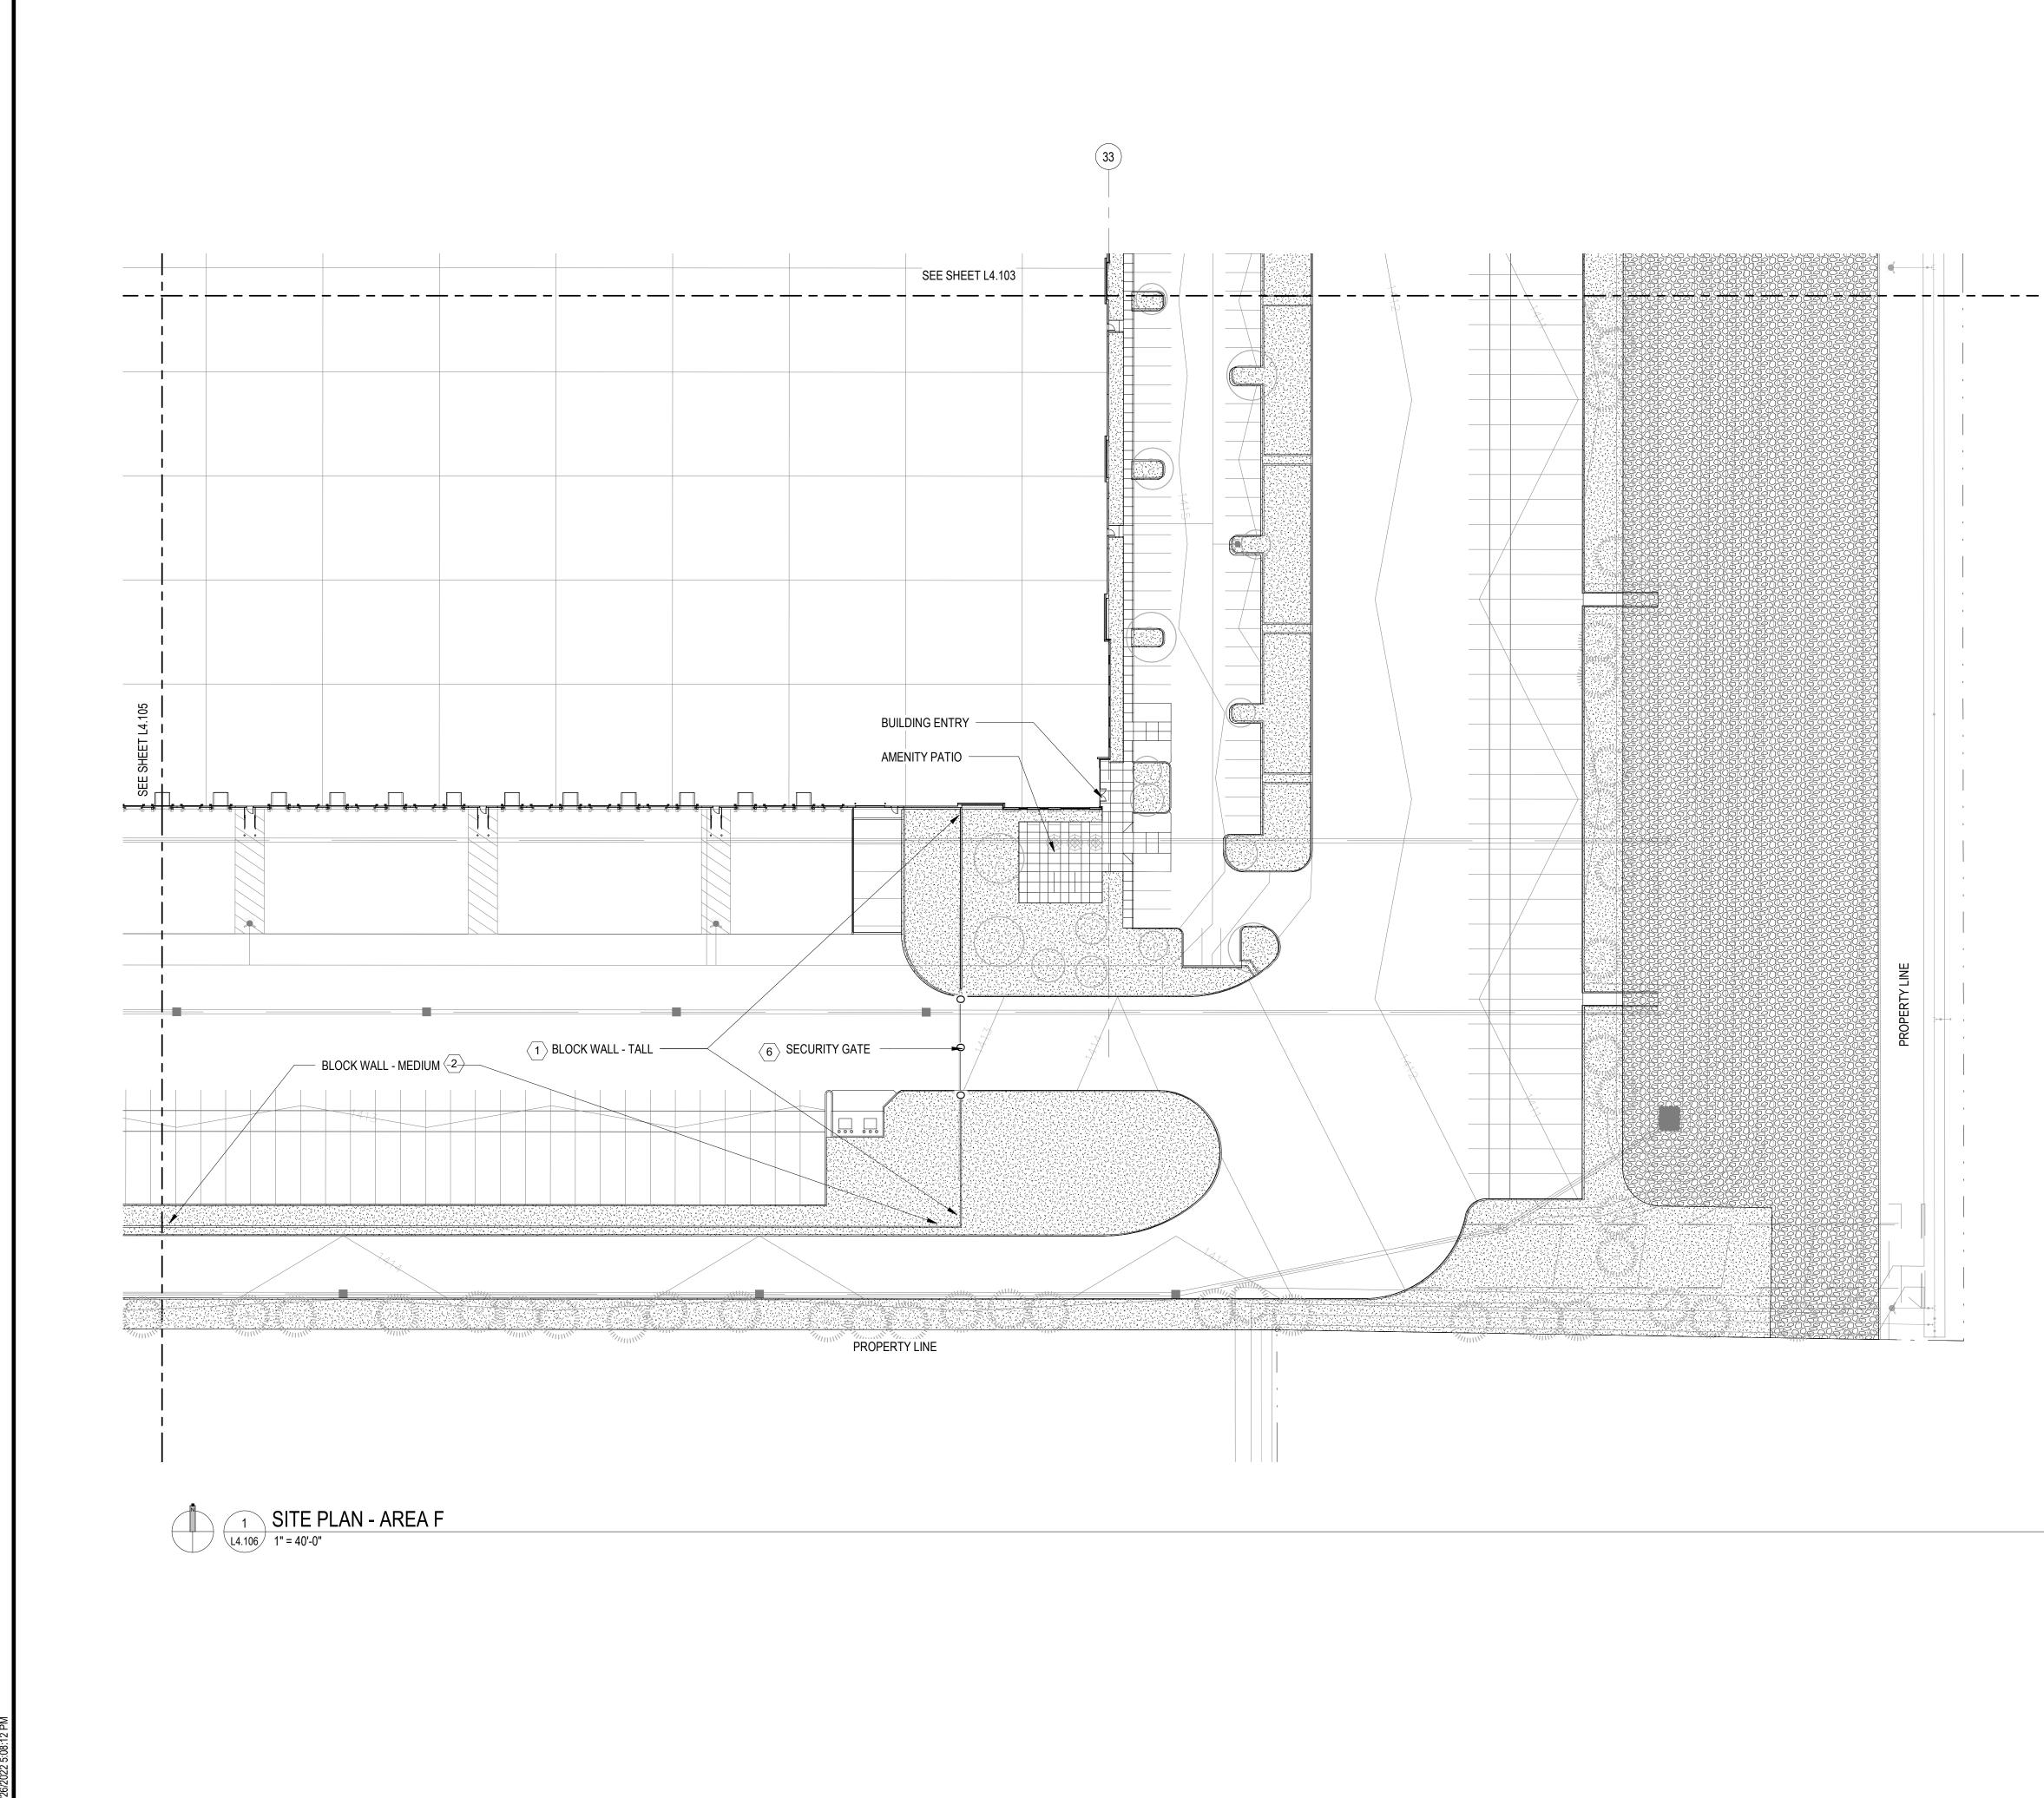


Е


	IPTION TE BLOCK WALL - TALL TE BLOCK WALL - MEDIUM	DETAIL B2 / L4.301 B2 / L4.301	
3. CONCRE [®] 4	TE BLOCK WALL - MEDIOM TE BLOCK WALL - SHORT Y GATE - MOTORIZED	B2 / L4.301 B1 / L4.301 E1 / L4.302	ري ري
5. SECURIT [®] NOTE:		SEE SPECS	4 5NICTIN
	R TO PROVIDE SHOP DRAWINGS FOR F GATES. SEE SPECS FOR REQUIREMEN		OF BU
LEGEND SYMBOL	DESCRIPTION	DETAIL	CLLAYCO THE ART & SCIENCE OF B 2199 INNERBELT BUSINESS CENTER DRIVE ST. LOUIS, MISSOURI 63114 Ph 314.429.5100 Fx 314.429.3137
	CONCRETE WALK	SEE CIVIL	T BUSINE FX 314.4
	DETENTION BASIN WITH GRAVEL		THE AF
	DECOMPOSED GRANITE	E4 / L4.301	2199 IN 2199 IN 314
			Lamar Johnso Collaborative 2199 INNERBELT BUSINESS CENTER DI ST. LOUIS, MISSOURI 6 Ph 314.429.
			3 Totals MATTHEW MARANZANA Od.25. CRGG INTEGRA Solution
			E PECOS RD & S CRISMON RD, MESA, AZ 85212
			Signature Signature DRAWING ISSUE DESCRIPTION DESIGN REVIEW 04/25/2
			1

А


DRAWING NO.

L4.106

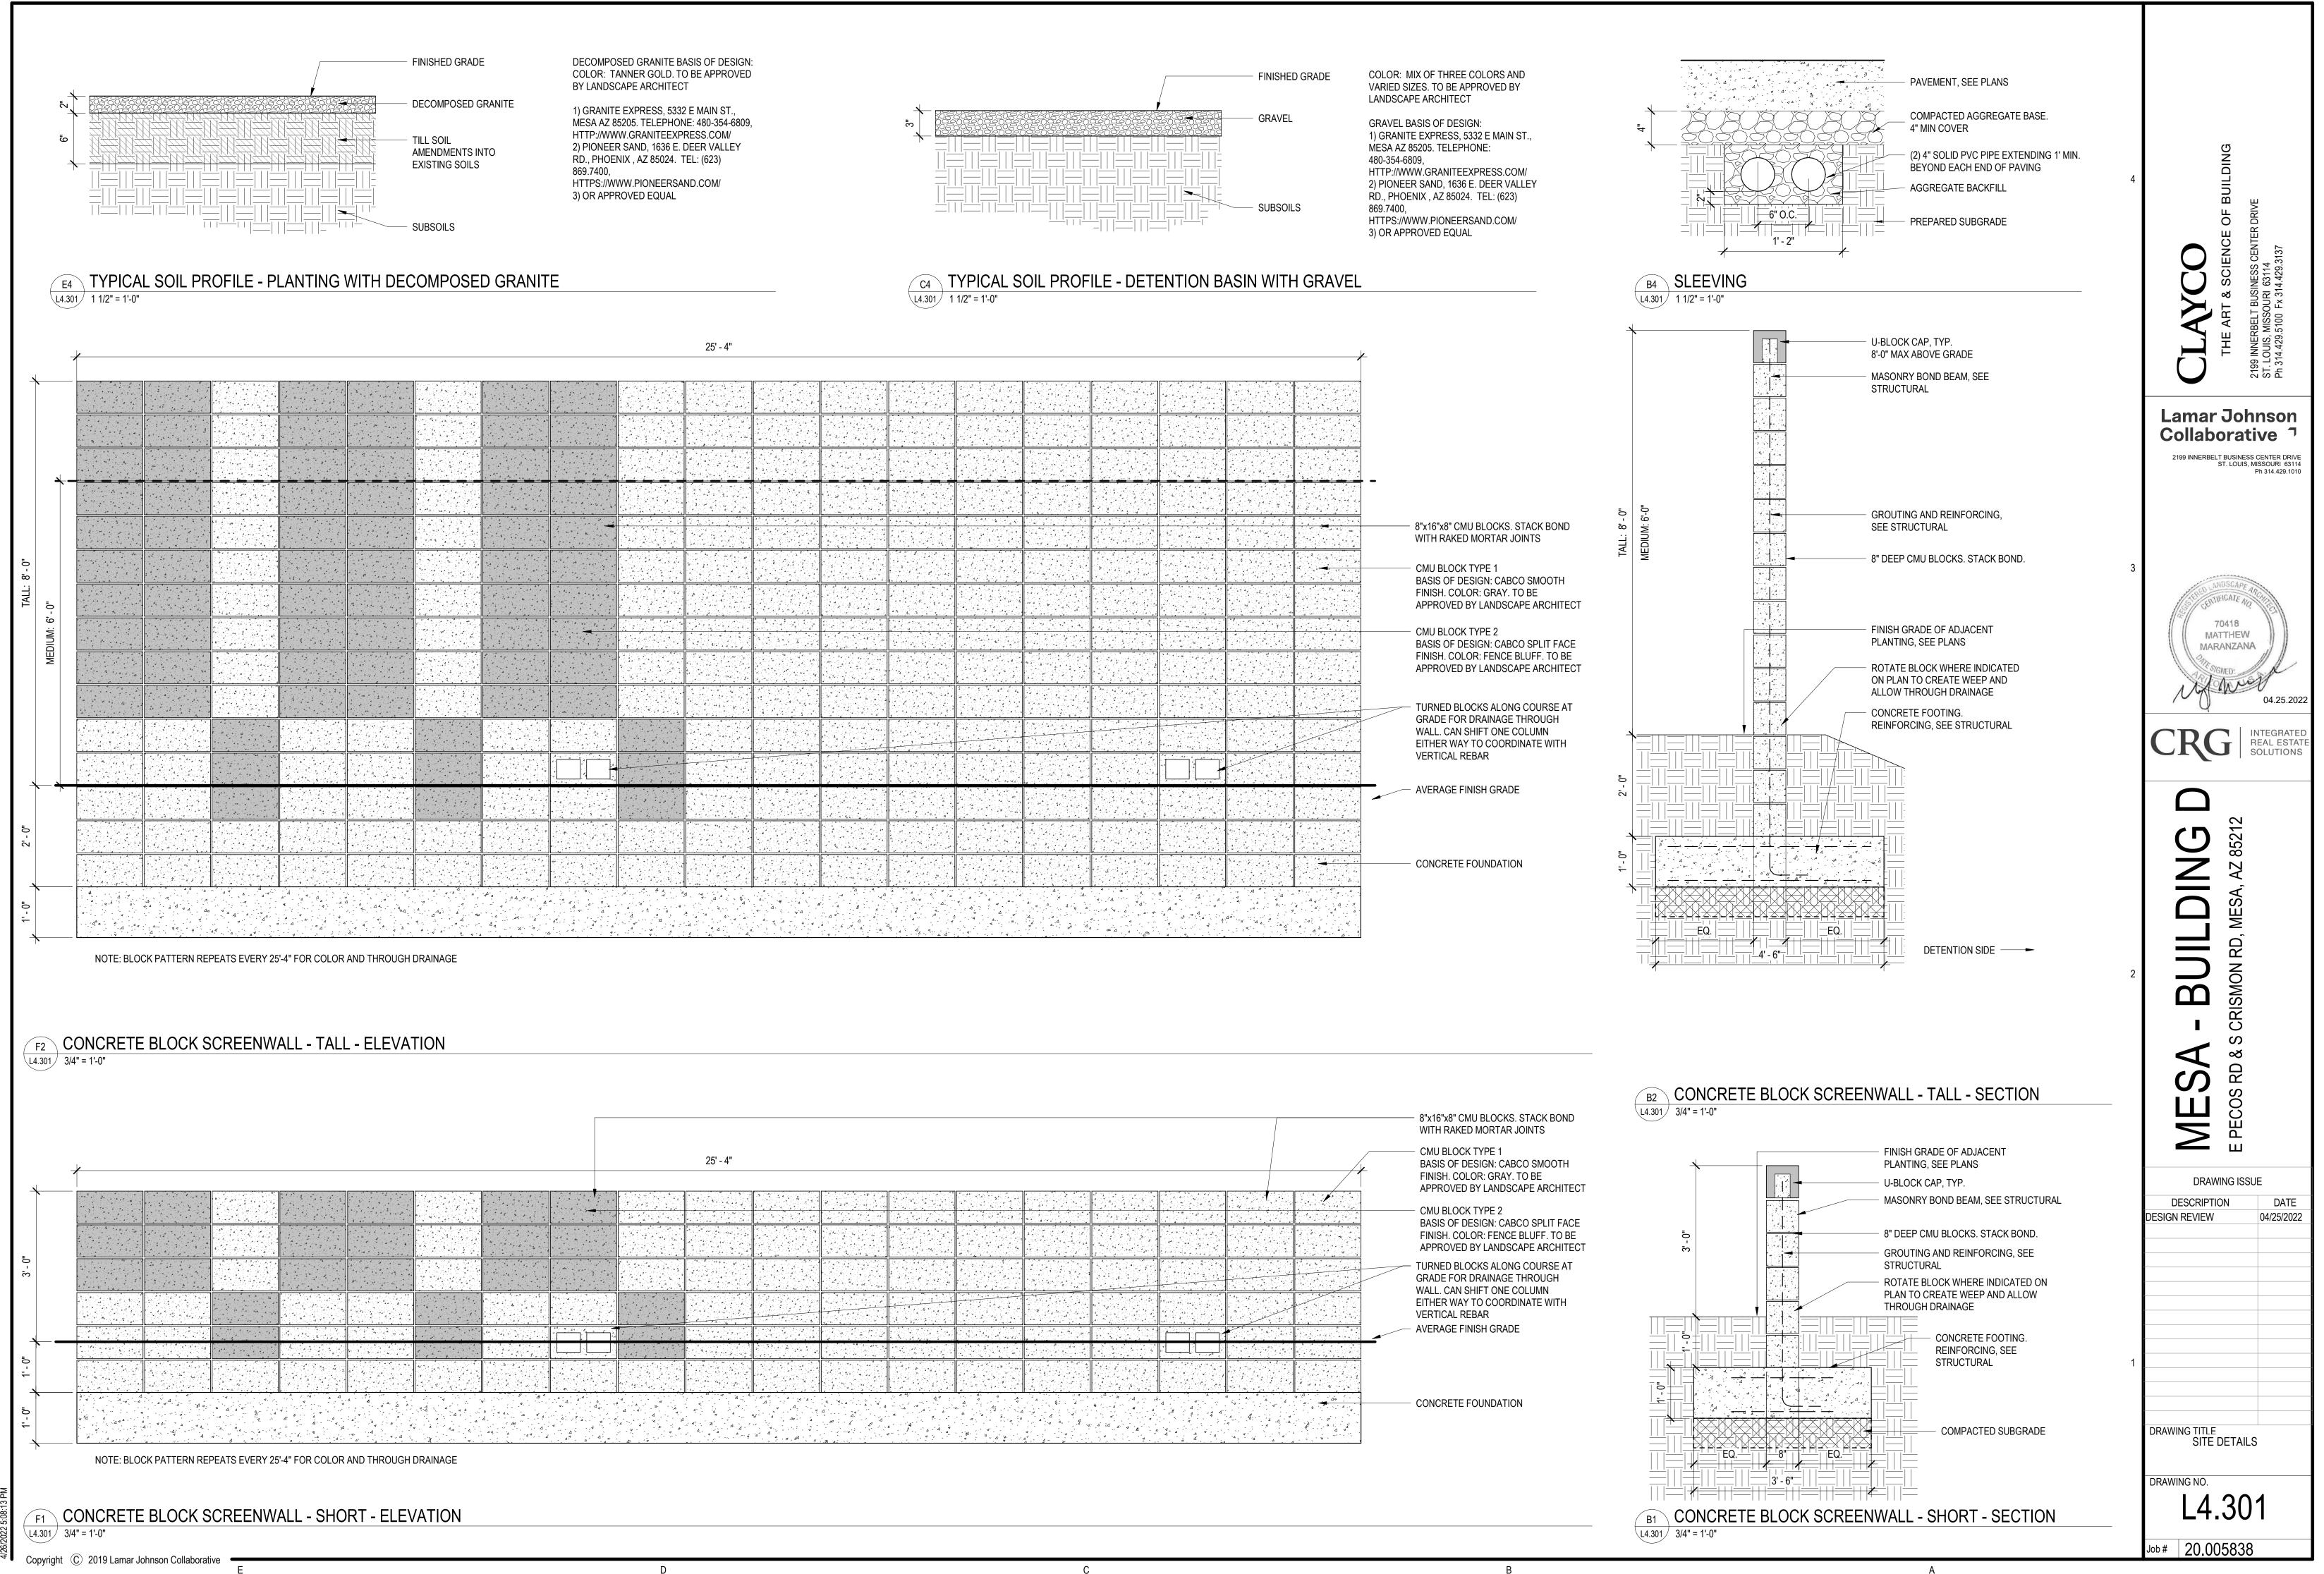

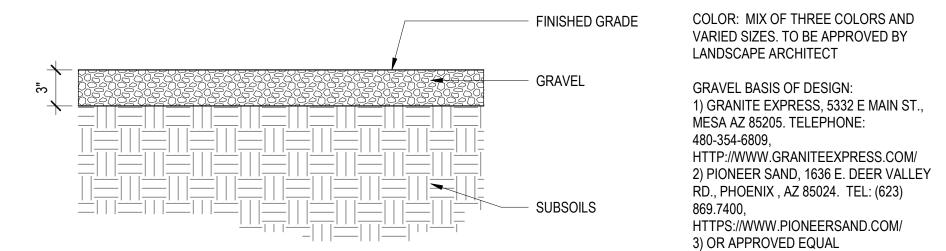



/	
	8"x16"x8" CMU BLOCKS. STACK BOND WITH RAKED MORTAR JOINTS
	- CMU BLOCK TYPE 1 BASIS OF DESIGN: CABCO SMOOTH
	FINISH. COLOR: GRAY. TO BE APPROVED BY LANDSCAPE ARCHITECT
	- CMU BLOCK TYPE 2 BASIS OF DESIGN: CABCO SPLIT FACE
	FINISH. COLOR: FENCE BLUFF. TO BE APPROVED BY LANDSCAPE ARCHITECT
	- TURNED BLOCKS ALONG COURSE AT
	GRADE FOR DRAINAGE THROUGH WALL. CAN SHIFT ONE COLUMN EITHER WAY TO COORDINATE WITH
	VERTICAL REBAR
	- AVERAGE FINISH GRADE
	- CONCRETE FOUNDATION

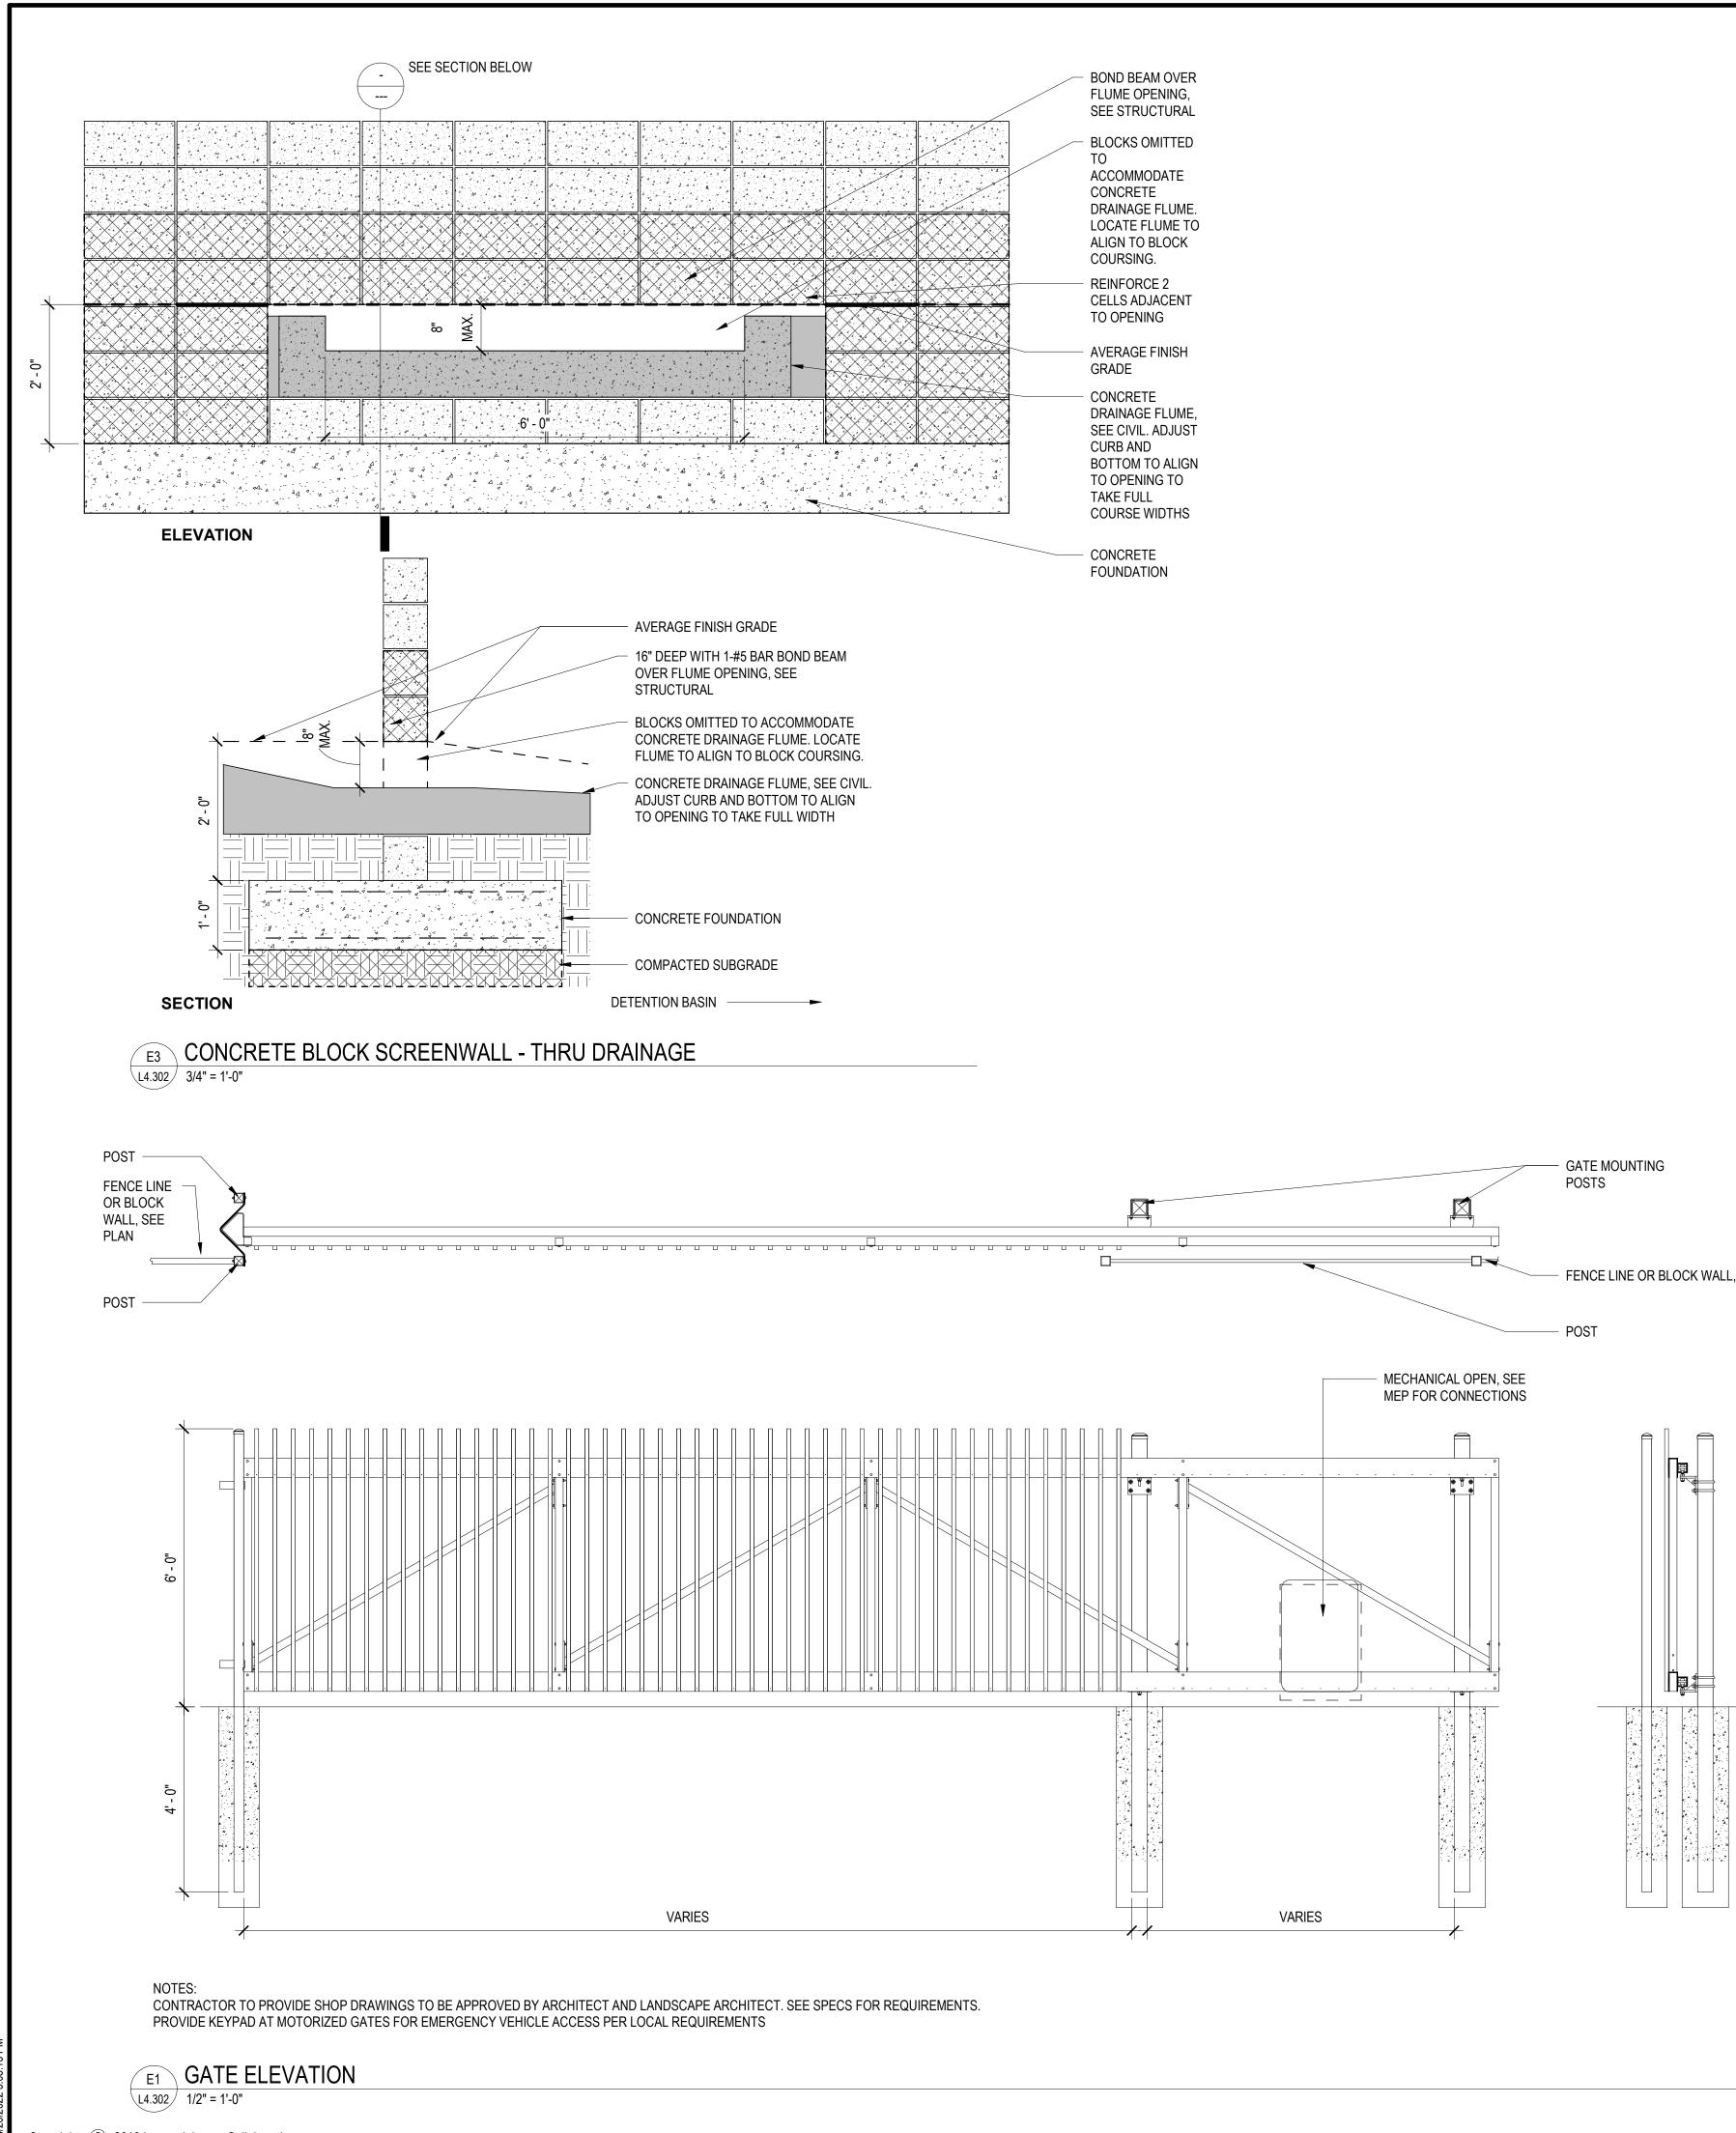

Copyright C 2019 Lamar Johnson Collaborative

D

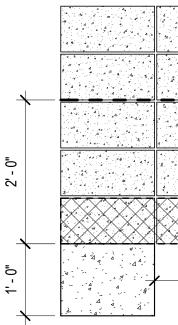

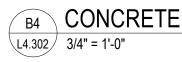



- FENCE LINE OR BLOCK WALL, SEE PLANS

	- AVERAGE FINISH GRADE - BOND BEAM OVER UTILITY CONFLICT, SEE STRUCTURAL 4	OF BUILDING DRIVE
(3) COURSE MAX.	 CONCRETE FOUNDATION. OMIT AT CONFLICT LOCATION 	E OF E
E BLOCK SCREENWALL - UTILITY CONFLICT	- STORM SEWER PIPE	CLAYCO B THE ART & SCIENCE OF B 2199 INNERBELT BUSINESS CENTER DRIVE ST. LOUIS, MISSOURI 63114 Ph 314.429.5100 Fx 314.429.3137
		Lamar Johnson Collaborative Collaborative 2199 INNERBELT BUSINESS CENTER DRIVE ST. LOUIS, MISSOURI 63114 Ph 314.429.1010

SERTI MA	in the	04.25.2022
MESA - BUILDING D	E PECOS RD & S CRISMON RD, MESA, AZ 85212	
DRAW	/ING ISS ON	SUE DATE
DESIGN REVIEW		04/25/2022

DRAWING TITLE	
SITE DETAILS	

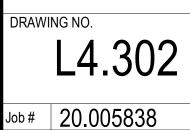

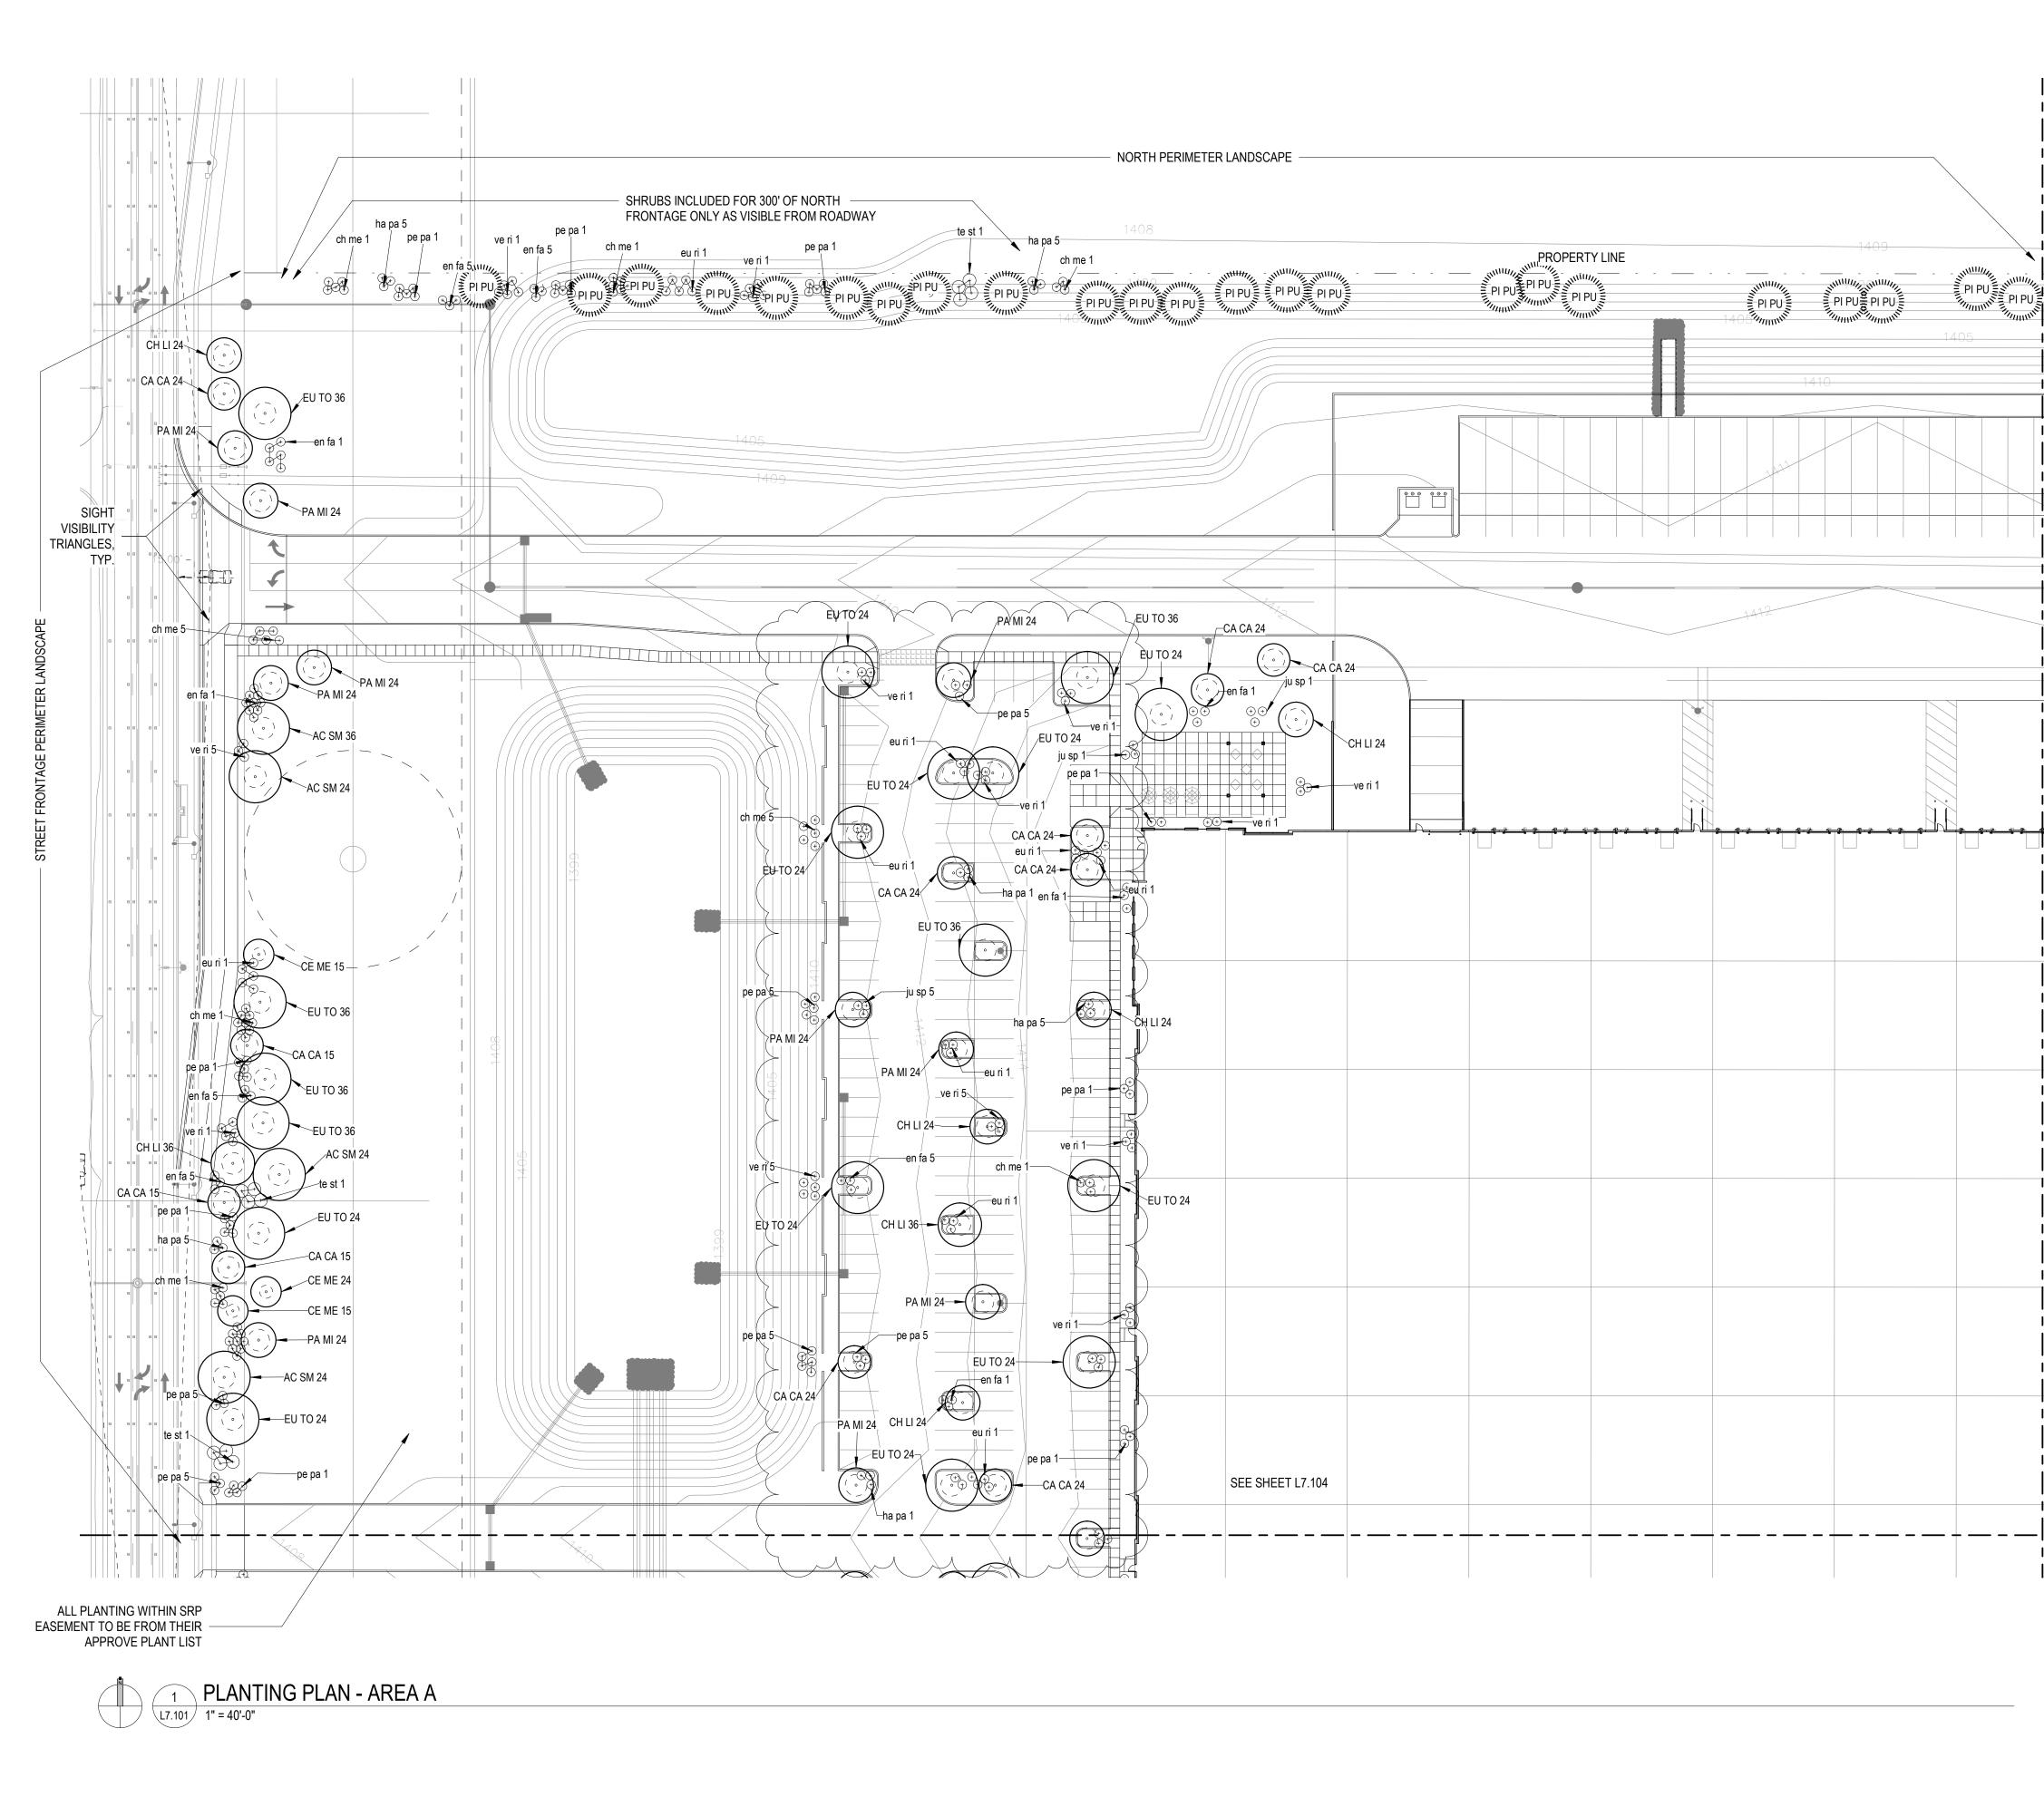



5

ත්

щ

CITY OF MESA GENERAL NOTES FOR LANDSCAPE PLAN

- 1. LANDSCAPE CONTRACTOR SHALL CONFIRM LOCATION OF ALL UNDERGROUND UTILITIES PRIOR TO
- ANY EXCAVATION AND SHALL BE RESPONSIBLE FOR THE FOLLOWING: 2. DAMAGES TO SUCH UTILITIES CAUSED AS A RESULT OF THE CONTRACTOR'S ACTIVITIES.
- 3. DAMAGES TO EXISTING WALKS, WALLS, DRIVES, CURBS, ETC.
- 4. INSPECTING THE SITE IN ORDER TO BE FULLY AWARE OF EXISTING CONDITIONS PRIOR TO SUBMITTING A BID.

2. INSTALLATION OF ALL LANDSCAPE AND IRRIGATION MATERIALS SHALL COMPLY WITH SECTIONS 424, 425, 757, AND 795 OF THE MAG STANDARD SPECIFICATIONS. 3. CONTRACTOR SHALL REPAIR ANY DAMAGE MADE TO THE EXISTING SPRINKLER SYSTEM TO THE

SATISFACTION OF THE CITY AT NO ADDITIONAL COST TO THE CITY. LANDSCAPE REMOVAL IS A NON-PAY ITEM UNLESS OTHERWISE NOTED.

5. ALL EXISTING VEGETATION, WEEDS, DEBRIS, ETC. NOTED TO BE REMOVED ON THE PLANS AND SPECIFICATIONS SHALL BE REMOVED FROM PROJECT AREA AND DISPOSED OF PROPERLY OFF THE SITE AT THE CONTRACTOR'S EXPENSE (SCARIFY EXISTING SUBGRADE, MINIMUM SIX (6) INCHES DEPTH).

6. DAMAGE TO TURF SHALL BE REPAIRED BY CONTRACTOR, I.E., RUTS FILLED WITH CLEAN SOIL, COMPACTED TO MATCH SURROUNDING GRADES, EXCESS SOIL, ROCK, ETC. SHALL BE REMOVED TO LEAVE THE SITE CLEAN.

7. ALL PLANT MATERIAL, OTHER THAN TREES, SHALL CONFORM TO GRADING, TYPE, ETC. AS SET FORTH IN THE AMERICAN STANDARD FOR NURSERY STOCK BY THE AMERICAN ASSOCIATION OF NURSERYMEN. ALL TREES SHALL CONFORM TO THE CURRENT ARIZONA NURSERY ASSOCIATION TREE SPECIFICATIONS AND MAG SPEC 795.7. SHOULD ANY CONFLICTS IN THE SPECIFICATIONS OCCUR, THE ARIZONA NURSERY ASSOCIATION'S SPECIFICATIONS SHALL PREVAIL.

8. CITY RESERVES THE RIGHT TO INSPECT SHRUBS AND CONTAINERED TREES FOR CONDITION OF ROOT BALLS. FOR ANY SUCH INSPECTIONS WHICH MAY DESTROY ROOTBALL, CONTRACTOR SHALL SUPPLY ADDITIONAL PLANT AT NO COST TO CITY. 9. PLANT PITS SHALL BE INSPECTED BY CITY PRIOR TO PLANTING BY THE CONTRACTOR BY

REQUESTING AN INSPECTION 48 HOURS IN ADVANCE. 10. ROUGH AND FINE GRADING TO ESTABLISH UNIFORM SMOOTH GRADE IS INCLUDED IN THIS PROJECT.

11. SOIL TEST FOR FERTILITY AND ADDITIVE RECOMMENDATIONS (FOR TURF AND ORNAMENTALS) SHALL BE COMPLETED BY CONTRACTOR TO DETERMINE IF ADDITIVES ARE REQUIRED. CONTRACTOR SHALL PROVIDE COPY OF SOIL TEST RESULTS FOR REVIEW AND APPROVAL TO ENGINEERING INSPECTOR AT LEAST SEVEN (7) DAYS PRIOR TO ANTICIPATED PLANTING. AFTER APPROVAL BY THE CITY, THE CONTRACTOR SHALL PROVIDE AND INCORPORATE ANY ADDITIVES REQUIRED PRIOR TO OR AT TIME OF PLANTING.

12. PLANT PIT SOIL MIXTURE SHALL CONSIST OF FOUR AND ONE-HALF PARTS NATURAL FERTILE, FRIABLE SOIL AND ONE PART HUMUS BY VOLUME, THOROUGHLY MIXED PRIOR TO BACKFILLING IN PITS. BACKFILLING SHALL BE IN 6" LIFTS WITH EACH LIFT WATER SETTLED WITHOUT PUDDLING. 13. CONTRACTOR SHALL STAKE TREE AND SHRUB LOCATIONS FOR 5-GALLON PLANTS AND LARGER. STAKES SHALL BE MARKED WITH PLANT NAME OR PLANT LEGEND ITEM NUMBER FROM PLANS. 14. ALL EXISTING (GAS, ELECTRIC, WATER, ETC.) COVERS AND BOXES SHALL REMAIN UNCOVERED. CONTRACTOR TO ADJUST TO FINAL GRADE AS NECESSARY. NON-PAY ITEM (NPI) UNLESS OTHERWISE NOTED.

15. THE CONTRACTOR SHALL BE RESPONSIBLE FOR LOCATING THE UNDERGROUND SPRINKLER SYSTEMS IN ADVANCE OF CONSTRUCTION. THE SPRINKLER SYSTEM LOCATIONS NOTED ON PLANS ARE FOR REFERENCE ONLY.

16. CONTRACTOR TO VERIFY DEPTH OF ALL INLET STRUCTURES AND SPRINKLER SYSTEMS PRIOR TO TRENCHING FOR LOW-FLOW CHANNEL.

17. CONTRACTOR TO PROVIDE PUMPING WITHIN FIVE (5) DAYS AFTER THE NOTICE TO PROCEED IS GIVEN AS REQUIRED TO DRY THE AREA SUFFICIENTLY TO BEGIN CONSTRUCTION. 18. CONTRACTOR SHALL ARRANGE FOR SPRINKLER SYSTEM SHUTDOWN DURING CONSTRUCTION BY

CONTACTING THE ENGINEERING INSPECTOR. 19. NO ROCKS LARGER THAN 1" IN DIAMETER SHALL BE ALLOWED IN THE TOP SIX (6) INCHES OF

TOPSOIL WHERE TURF ESTABLISHMENT IS SPECIFIED. ROCK REMOVAL AS NECESSARY IS A NON-PAY (NPI) ITEM UNLESS OTHERWISE NOTED.

20. WHERE CALICHE IS ENCOUNTERED IN PLANT PITS, DEPTH AND WIDTH OF PIT SHALL BE INCREASED BY ONE-THIRD (1/3) OVER SPECIFICATION, AND A LIQUID PENETRATOR, "AL-KALICHE" OR EQUAL, SHALL BE INCORPORATED FOR EACH PIT PER MANUFACTURER'S RECOMMENDATIONS.

21. CONTRACTOR SHALL INSTALL DECOMPOSED GRANITE TO A ROLLED DEPTH PER THE APPROVED PLANS AND SPECIFICATIONS. DECOMPOSED GRANITE SHALL BE PER THE APPROVED PLANS AND SPECIFICATIONS WITH THE COLOR AS SPECIFIED ON THE PLANS. PRE-EMERGENT HERBICIDE SHALL BE APPLIED BEFORE AND AFTER PLACEMENT OF DECOMPOSED GRANITE PER THE MANUFACTURER'S RECOMMENDATIONS. PRE-EMERGENT HERBICIDE SHALL BE SURFLAN, DACTHAL, OR APPROVED EQUAL. SAMPLE TO BE PROVIDED FOR CITY REVIEW AND APPROVAL. CONTRACTOR SHALL WASH OFF ROCK MULCH ONCE FINAL PLACEMENT HAS OCCURRED.

22. RESTORE ALL EXISTING LANDSCAPE IRRIGATION SYSTEMS, COMPONENTS AND LANDSCAPE AREAS IMPACTED BY ANY WORK UNDER THIS CONTRACT. RESTORE ALL EXISTING IRRIGATION AND LANDSCAPE IN ACCORDANCE WITH THE LANDSCAPE RESTORATION NOTES INDICATED WITHIN THESE DOCUMENTS, AT A MINIMUM, ALL RESTORATION SHALL BE IN ACCORDANCE WITH M.A.G.

SPECIFICATION 107.9 - PROTECTION AND RESTORATION OF PROPERTY AND LANDSCAPE. ALL RESTORATION WORK SHALL BE COMPLETED TO THE SATISFACTION OF THE CITY OF MESA ENGINEER. 23. ALL RESTORATION WORK SHALL BE COMPLETED IN ACCORDANCE WITH THE REFERENCED DETAILS AND ANY ADDITIONAL DETAILS PROVIDED.

24. REFER TO LANDSCAPE PLANTING SHEETS AND ENGINEERING DRAWINGS FOR ADDITIONAL RESTORATION NOTES AND REQUIRED COORDINATION.

		TREE LEGEN	D	
Code	Botanical Name	Cultivar	Common Name	Size
AC SM 24	Acacia smallii		Sweet Acacia	24" BOX
AC SM 36	Acacia smallii		Sweet Acacia	36" BOX
CA CA 15	Caesalpinia cacalaco	'Smoothie'	Thornless Cascalote	15 GAL.
CA CA 24	Caesalpinia cacalaco	'Smoothie'	Thornless Cascalote	24" BOX
CE ME 15	Cercis mexicana		Mexican Redbud	15 GAL.
CE ME 24	Cercis mexicana		Mexican Redbud	24" BOX
CH LI 24	Chilopsis Linearis		Desert Willow	24" BOX
CH LI 36	Chilopsis Linearis		Desert Willow	36" BOX
EU TO 24	Eucalyptus torquata		Coral Gum	24" BOX
EU TO 36	Eucalyptus torquata		Coral Gum	36" BOX
PA MI 24	Parkinsonia microphylla		Foothill Palo Verde	24" BOX
PI PU	Pinus cembroides		Mexican Pinon Pine	15 GAL.


		SHRUB LEGEN	ND.	
Code	Botanical Name	Cultivar	Common Name	Size
ch me 1	Chrysactinia mexicana Chrysactinia mexicana		Damianita Daisy	1 Gal
ch me 5	Chrysactinia mexicana Chrysactinia mexicana		Damianita Daisy	5 Gal.
en fa 1	Encelia farinosa		Brittlebush	1 Gal
en fa 5	Encelia farinosa		Brittlebush	5 Gal.
eu ri 1	euphorbia rigida		Gopher Plant	1 Gal
eu ri 5	euphorbia rigida		Gopher Plant	5 Gal.
ha pa 1	Hamelia patens	'Sierra Red'	Fire Bush	1 Gal
ha pa 5	Hamelia patens	'Sierra Red'	Fire Bush	5 Gal.
ju sp 1	Justicia spicigera		Mexican Honeysuckle	1 Gal
ju sp 5	Justicia spicigera		Mexican Honeysuckle	5 Gal.
pe pa 1	Penstemon parryi		Parry's Penstemon	1 Gal
pe pa 5	Penstemon parryi		Parry's Penstemon	5 Gal.
te st 1	Tecoma stans	'Gold Star'	Yellow Bells	1 Gal
te st 5	Tecoma stans	'Gold Star'	Yellow Bells	5 Gal.
ve ri 1	verbena rigida		Sandpaper Verbena	1 Gal
ve ri 5	verbena rigida		Sandpaper Verbena	5 Gal.

NOTE: NUMBER IN PLANT CODE INDICATED PLANT SIZE, NOT QUANTITY.

4	<section-header><section-header><section-header><section-header><section-header><section-header><section-header><section-header><section-header><section-header><text></text></section-header></section-header></section-header></section-header></section-header></section-header></section-header></section-header></section-header></section-header>
3	
2	CRGG INTEGRATED REAL ESTATE SOLUTIONS A A A B B B B B B B B B B B B B B B D B D B D B D B D B D B D B D C </th
1	
	DRAWING TITLE PLANTING PLAN - AREA A DRAWING NO. L7.101

Job # 20.005838

Α

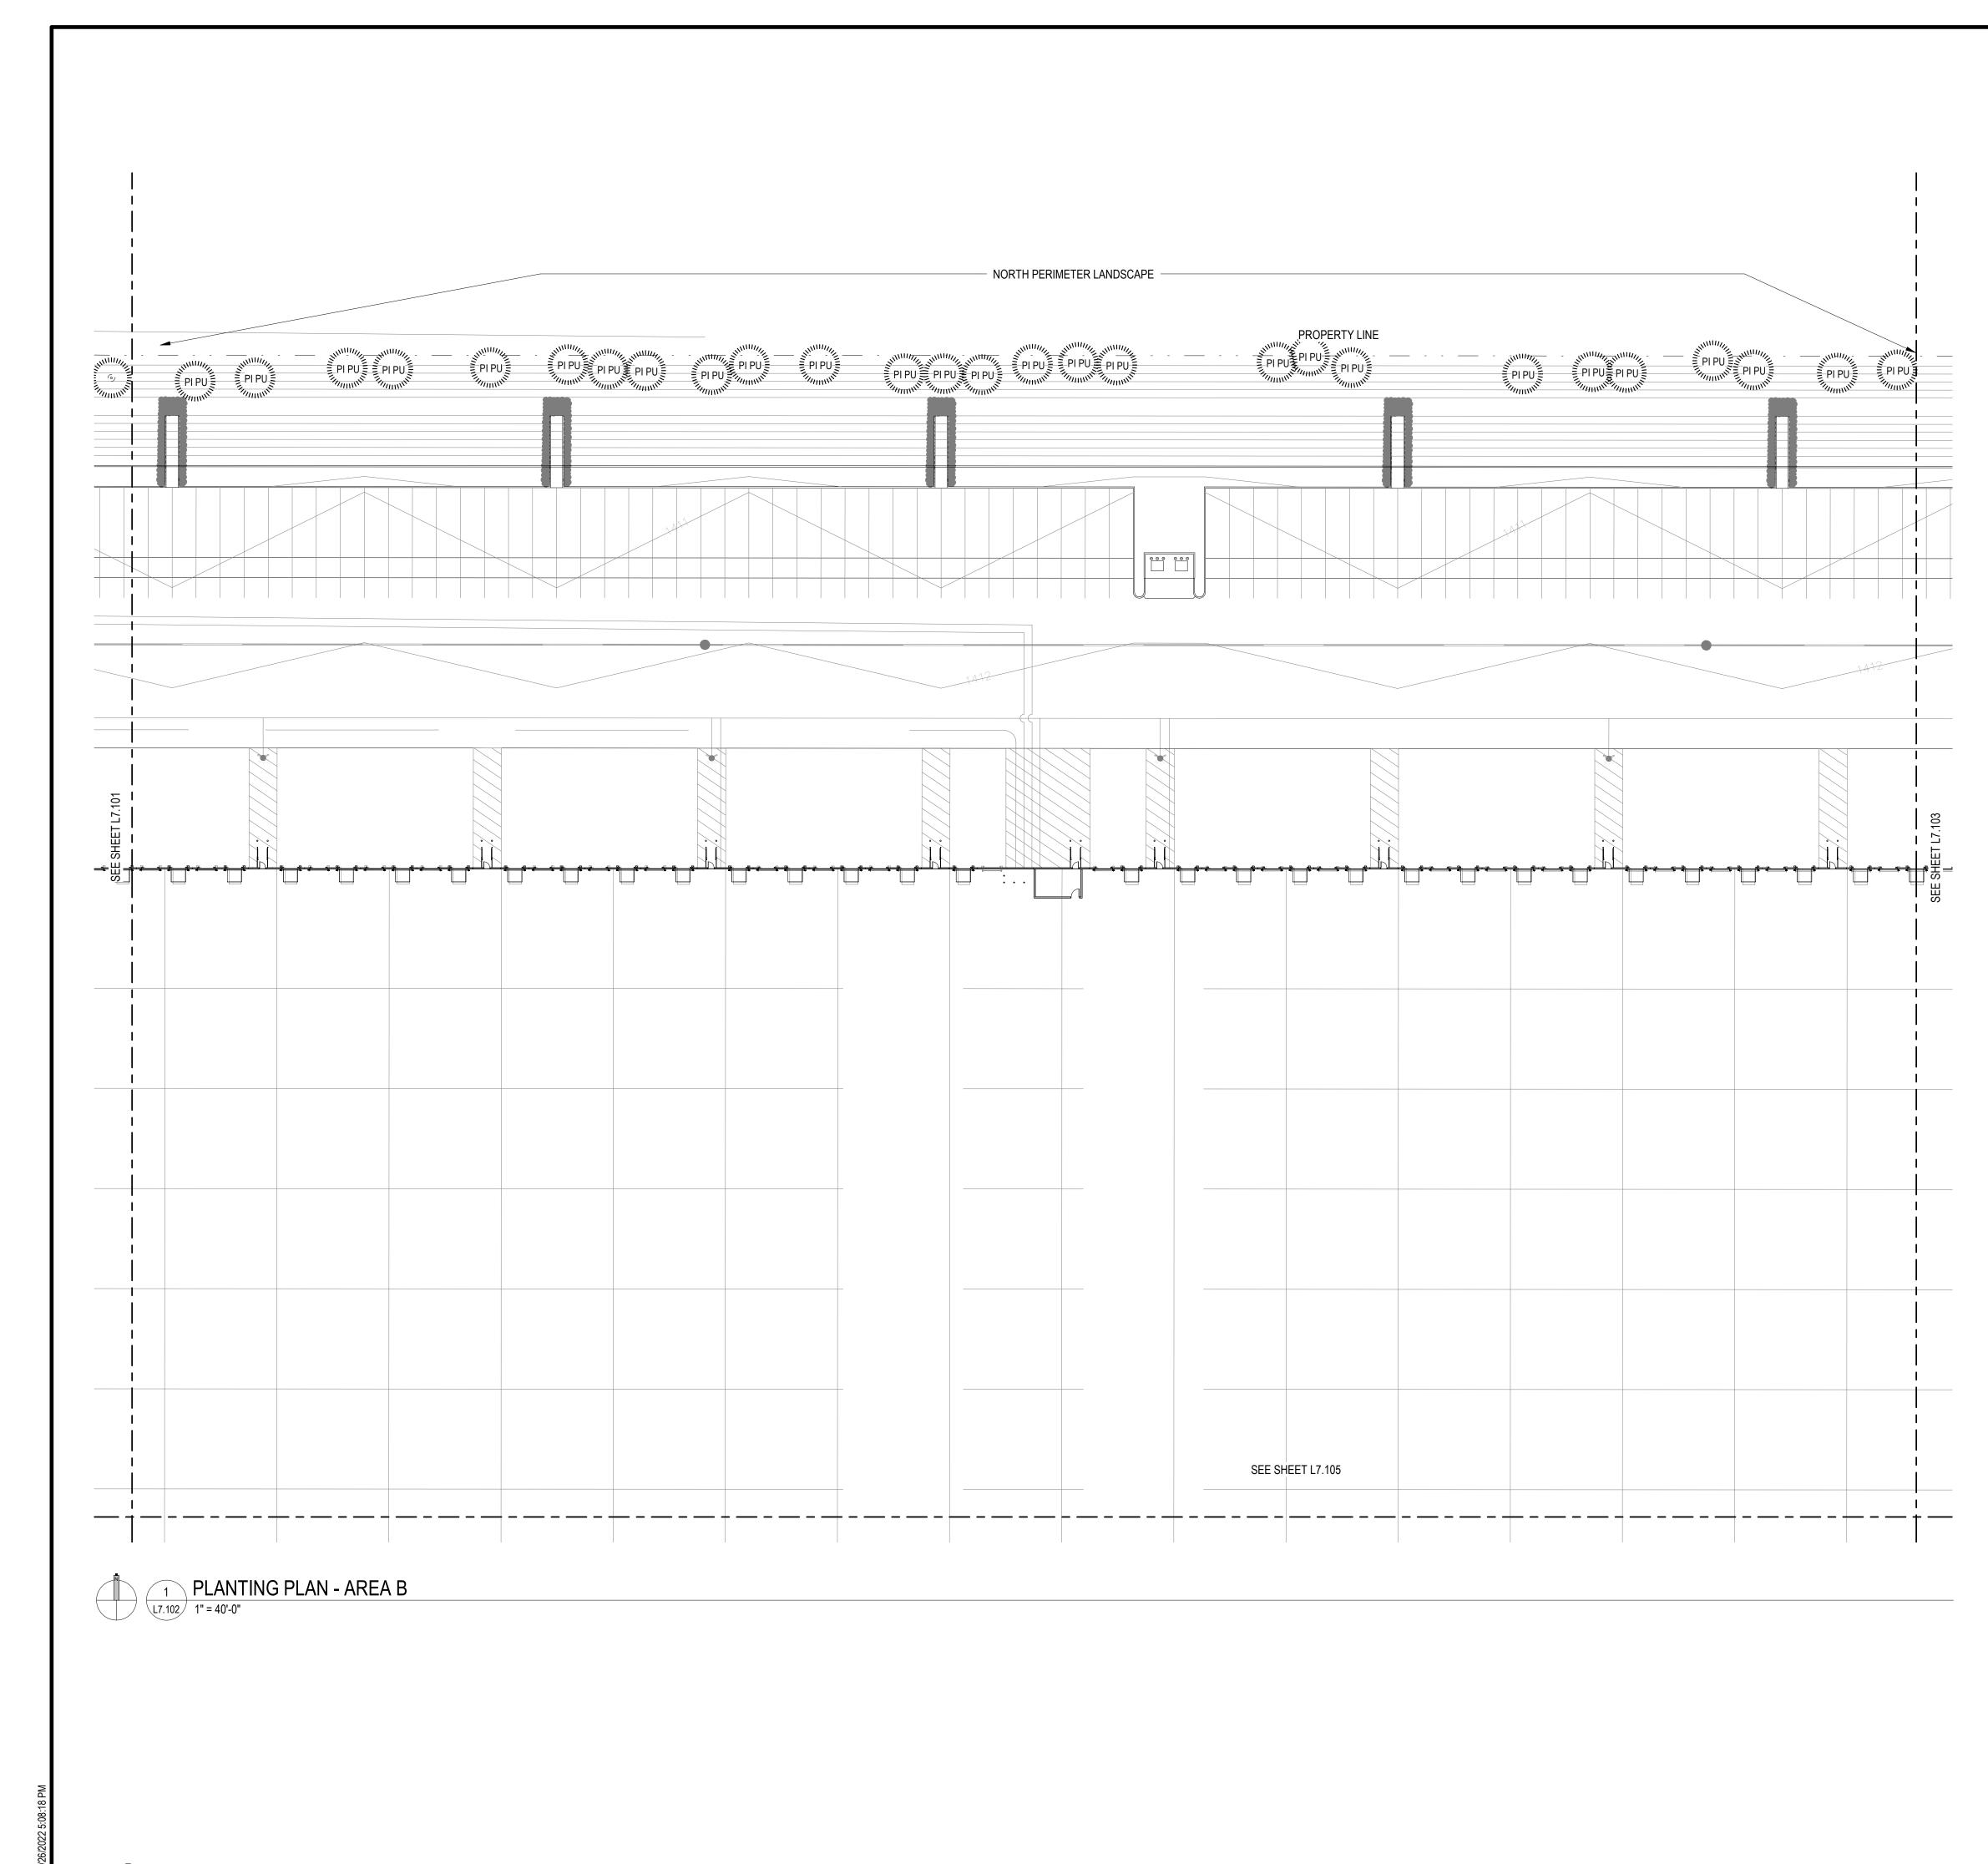

С

CITY OF MESA GENERAL NOTES FOR LANDSCAPE PLAN

- LANDSCAPE CONTRACTOR SHALL CONFIRM LOCATION OF ALL UNDERGROUND UTILITIES PRIOR TO ANY EXCAVATION AND SHALL BE RESPONSIBLE FOR THE FOLLOWING:
- 2. DAMAGES TO SUCH UTILITIES CAUSED AS A RESULT OF THE CONTRACTOR'S ACTIVITIES.
- DAMAGES TO EXISTING WALKS, WALLS, DRIVES, CURBS, ETC.
 INSPECTING THE SITE IN ORDER TO BE FULLY AWARE OF EXISTING CONDITIONS PRIOR TO SUBMITTING A RID.
- SUBMITTING A BID. 2. INSTALLATION OF ALL LANDSCAPE AND IRRIGATION MATERIALS SHALL COMPLY WITH SECTIONS
- 424, 425, 757, AND 795 OF THE MAG STANDARD SPECIFICATIONS.CONTRACTOR SHALL REPAIR ANY DAMAGE MADE TO THE EXISTING SPRINKLER SYSTEM TO THE SATISFACTION OF THE CITY AT NO ADDITIONAL COST TO THE CITY.
- LANDSCAPE REMOVAL IS A NON-PAY ITEM UNLESS OTHERWISE NOTED.
 ALL EXISTING VEGETATION, WEEDS, DEBRIS, ETC. NOTED TO BE REMOVED ON THE PLANS AND SPECIFICATIONS SHALL BE REMOVED FROM PROJECT AREA AND DISPOSED OF PROPERLY OFF THE SITE AT THE CONTRACTOR'S EXPENSE (SCARIFY EXISTING SUBGRADE, MINIMUM SIX (6) INCHES DEPTH).

6. DAMAGE TO TURF SHALL BE REPAIRED BY CONTRACTOR, I.E., RUTS FILLED WITH CLEAN SOIL, COMPACTED TO MATCH SURROUNDING GRADES, EXCESS SOIL, ROCK, ETC. SHALL BE REMOVED TO LEAVE THE SITE CLEAN.

7. ALL PLANT MATERIAL, OTHER THAN TREES, SHALL CONFORM TO GRADING, TYPE, ETC. AS SET FORTH IN THE <u>AMERICAN STANDARD FOR NURSERY STOCK</u> BY THE AMERICAN ASSOCIATION OF NURSERYMEN. ALL TREES SHALL CONFORM TO THE CURRENT <u>ARIZONA NURSERY ASSOCIATION TREE</u> <u>SPECIFICATIONS</u> AND MAG SPEC 795.7. SHOULD ANY CONFLICTS IN THE SPECIFICATIONS OCCUR, THE ARIZONA NURSERY ASSOCIATION'S SPECIFICATIONS SHALL PREVAIL.

8. CITY RESERVES THE RIGHT TO INSPECT SHRUBS AND CONTAINERED TREES FOR CONDITION OF ROOT BALLS. FOR ANY SUCH INSPECTIONS WHICH MAY DESTROY ROOTBALL, CONTRACTOR SHALL SUPPLY ADDITIONAL PLANT AT NO COST TO CITY.

 PLANT PITS SHALL BE INSPECTED BY CITY PRIOR TO PLANTING BY THE CONTRACTOR BY REQUESTING AN INSPECTION 48 HOURS IN ADVANCE.
 ROUGH AND FINE GRADING TO ESTABLISH UNIFORM SMOOTH GRADE IS INCLUDED IN THIS

PROJECT. 11. SOIL TEST FOR FERTILITY AND ADDITIVE RECOMMENDATIONS (FOR TURF AND ORNAMENTALS) SHALL BE COMPLETED BY CONTRACTOR TO DETERMINE IF ADDITIVES ARE REQUIRED. CONTRACTOR SHALL PROVIDE COPY OF SOIL TEST RESULTS FOR REVIEW AND APPROVAL TO ENGINEERING INSPECTOR AT LEAST SEVEN (7) DAYS PRIOR TO ANTICIPATED PLANTING. AFTER APPROVAL BY THE CITY, THE CONTRACTOR SHALL PROVIDE AND INCORPORATE ANY ADDITIVES REQUIRED PRIOR TO OR AT TIME OF PLANTING.

 PLANT PIT SOIL MIXTURE SHALL CONSIST OF FOUR AND ONE-HALF PARTS NATURAL FERTILE, FRIABLE SOIL AND ONE PART HUMUS BY VOLUME, THOROUGHLY MIXED PRIOR TO BACKFILLING IN PITS. BACKFILLING SHALL BE IN 6" LIFTS WITH EACH LIFT WATER SETTLED WITHOUT PUDDLING.
 CONTRACTOR SHALL STAKE TREE AND SHRUB LOCATIONS FOR 5-GALLON PLANTS AND LARGER. STAKES SHALL BE MARKED WITH PLANT NAME OR PLANT LEGEND ITEM NUMBER FROM PLANS.
 ALL EXISTING (GAS, ELECTRIC, WATER, ETC.) COVERS AND BOXES SHALL REMAIN UNCOVERED. CONTRACTOR TO ADJUST TO FINAL GRADE AS NECESSARY. NON-PAY ITEM (NPI) UNLESS OTHERWISE 3 NOTED.

15. THE CONTRACTOR SHALL BE RESPONSIBLE FOR LOCATING THE UNDERGROUND SPRINKLER SYSTEMS IN ADVANCE OF CONSTRUCTION. THE SPRINKLER SYSTEM LOCATIONS NOTED ON PLANS ARE FOR REFERENCE ONLY.

16. CONTRACTOR TO VERIFY DEPTH OF ALL INLET STRUCTURES AND SPRINKLER SYSTEMS PRIOR TO TRENCHING FOR LOW-FLOW CHANNEL.

CONTRACTOR TO PROVIDE PUMPING WITHIN FIVE (5) DAYS AFTER THE NOTICE TO PROCEED IS
 GIVEN AS REQUIRED TO DRY THE AREA SUFFICIENTLY TO BEGIN CONSTRUCTION.
 CONTRACTOR SHALL ARRANGE FOR SPRINKLER SYSTEM SHUTDOWN DURING CONSTRUCTION BY

CONTACTING THE ENGINEERING INSPECTOR. 19. NO ROCKS LARGER THAN 1" IN DIAMETER SHALL BE ALLOWED IN THE TOP SIX (6) INCHES OF

TOPSOIL WHERE TURF ESTABLISHMENT IS SPECIFIED. ROCK REMOVAL AS NECESSARY IS A NON-PAY (NPI) ITEM UNLESS OTHERWISE NOTED.

20. WHERE CALICHE IS ENCOUNTERED IN PLANT PITS, DEPTH AND WIDTH OF PIT SHALL BE INCREASED BY ONE-THIRD (1/3) OVER SPECIFICATION, AND A LIQUID PENETRATOR, "AL-KALICHE" OR EQUAL, SHALL BE INCORPORATED FOR EACH PIT PER MANUFACTURER'S RECOMMENDATIONS.

21. CONTRACTOR SHALL INSTALL DECOMPOSED GRANITE TO A ROLLED DEPTH PER THE APPROVED PLANS AND SPECIFICATIONS. DECOMPOSED GRANITE SHALL BE PER THE APPROVED PLANS AND SPECIFICATIONS WITH THE COLOR AS SPECIFIED ON THE PLANS. PRE-EMERGENT HERBICIDE SHALL BE APPLIED BEFORE AND AFTER PLACEMENT OF DECOMPOSED GRANITE PER THE MANUFACTURER'S RECOMMENDATIONS. PRE-EMERGENT HERBICIDE SHALL BE SURFLAN, DACTHAL, OR APPROVED EQUAL. SAMPLE TO BE PROVIDED FOR CITY REVIEW AND APPROVAL. CONTRACTOR SHALL WASH OFF ROCK MULCH ONCE FINAL PLACEMENT HAS OCCURRED.

22. RESTORE ALL EXISTING LANDSCAPE IRRIGATION SYSTEMS, COMPONENTS AND LANDSCAPE AREAS IMPACTED BY ANY WORK UNDER THIS CONTRACT. RESTORE ALL EXISTING IRRIGATION AND LANDSCAPE IN ACCORDANCE WITH THE LANDSCAPE RESTORATION NOTES INDICATED WITHIN THESE DOCUMENTS. AT A MINIMUM, ALL RESTORATION SHALL BE IN ACCORDANCE WITH M.A.G.

SPECIFICATION 107.9 - PROTECTION AND RESTORATION OF PROPERTY AND LANDSCAPE. ALL RESTORATION WORK SHALL BE COMPLETED TO THE SATISFACTION OF THE CITY OF MESA ENGINEER.

23. ALL RESTORATION WORK SHALL BE COMPLETED IN ACCORDANCE WITH THE REFERENCED DETAILS AND ANY ADDITIONAL DETAILS PROVIDED.


24. REFER TO LANDSCAPE PLANTING SHEETS AND ENGINEERING DRAWINGS FOR ADDITIONAL RESTORATION NOTES AND REQUIRED COORDINATION.

		TREE LEGEN	D	
Code	Botanical Name	Cultivar	Common Name	Size
AC SM 24	Acacia smallii		Sweet Acacia	24" BOX
AC SM 36	Acacia smallii		Sweet Acacia	36" BOX
CA CA 15	Caesalpinia cacalaco	'Smoothie'	Thornless Cascalote	15 GAL.
CA CA 24	Caesalpinia cacalaco	'Smoothie'	Thornless Cascalote	24" BOX
CE ME 15	Cercis mexicana		Mexican Redbud	15 GAL.
CE ME 24	Cercis mexicana		Mexican Redbud	24" BOX
CH LI 24	Chilopsis Linearis		Desert Willow	24" BOX
CH LI 36	Chilopsis Linearis		Desert Willow	36" BOX
EU TO 24	Eucalyptus torquata		Coral Gum	24" BOX
EU TO 36	Eucalyptus torquata		Coral Gum	36" BOX
PA MI 24	Parkinsonia microphylla		Foothill Palo Verde	24" BOX
PI PU	Pinus cembroides		Mexican Pinon Pine	15 GAL.

Code	Botanical Name	Cultivar	Common Name	Size
ch me 1	Chrysactinia mexicana Chrysactinia mexicana		Damianita Daisy	1 Gal
ch me 5	Chrysactinia mexicana Chrysactinia mexicana		Damianita Daisy	5 Gal.
en fa 1	Encelia farinosa		Brittlebush	1 Gal
en fa 5	Encelia farinosa		Brittlebush	5 Gal.
eu ri 1	euphorbia rigida		Gopher Plant	1 Gal
eu ri 5	euphorbia rigida		Gopher Plant	5 Gal.
ha pa 1	Hamelia patens	'Sierra Red'	Fire Bush	1 Gal
ha pa 5	Hamelia patens	'Sierra Red'	Fire Bush	5 Gal.
ju sp 1	Justicia spicigera		Mexican Honeysuckle	1 Gal
ju sp 5	Justicia spicigera		Mexican Honeysuckle	5 Gal.
pe pa 1	Penstemon parryi		Parry's Penstemon	1 Gal
pe pa 5	Penstemon parryi		Parry's Penstemon	5 Gal.
te st 1	Tecoma stans	'Gold Star'	Yellow Bells	1 Gal
te st 5	Tecoma stans	'Gold Star'	Yellow Bells	5 Gal.
ve ri 1	verbena rigida		Sandpaper Verbena	1 Gal
ve ri 5	verbena rigida		Sandpaper Verbena	5 Gal.

NOTE: NUMBER IN PLANT CODE INDICATED PLANT SIZE, NOT QUANTITY.

CLAYCO THE ART & SCIENCE OF BUILDING	2199 INNERBELT BUSINESS CENTER DRIVE ST. LOUIS, MISSOURI 63114 Ph 314.429.5100 Fx 314.429.3137
	ohnson ative 7 SINESS CENTER DRIVE DUIS, MISSOURI 63114 Ph 314.429.1010
TOAT MATTH MARANZ MARANZ	E NO E NO E W CANA
	RU, IMESA, AZ (
MES.	
DESCRIPTION DESIGN REVIEW	DATE 04/25/2022
DRAWING TITLE PLANTING PLA	N - AREA B
DRAWING NO. L7.1 Job # 20.0058	-

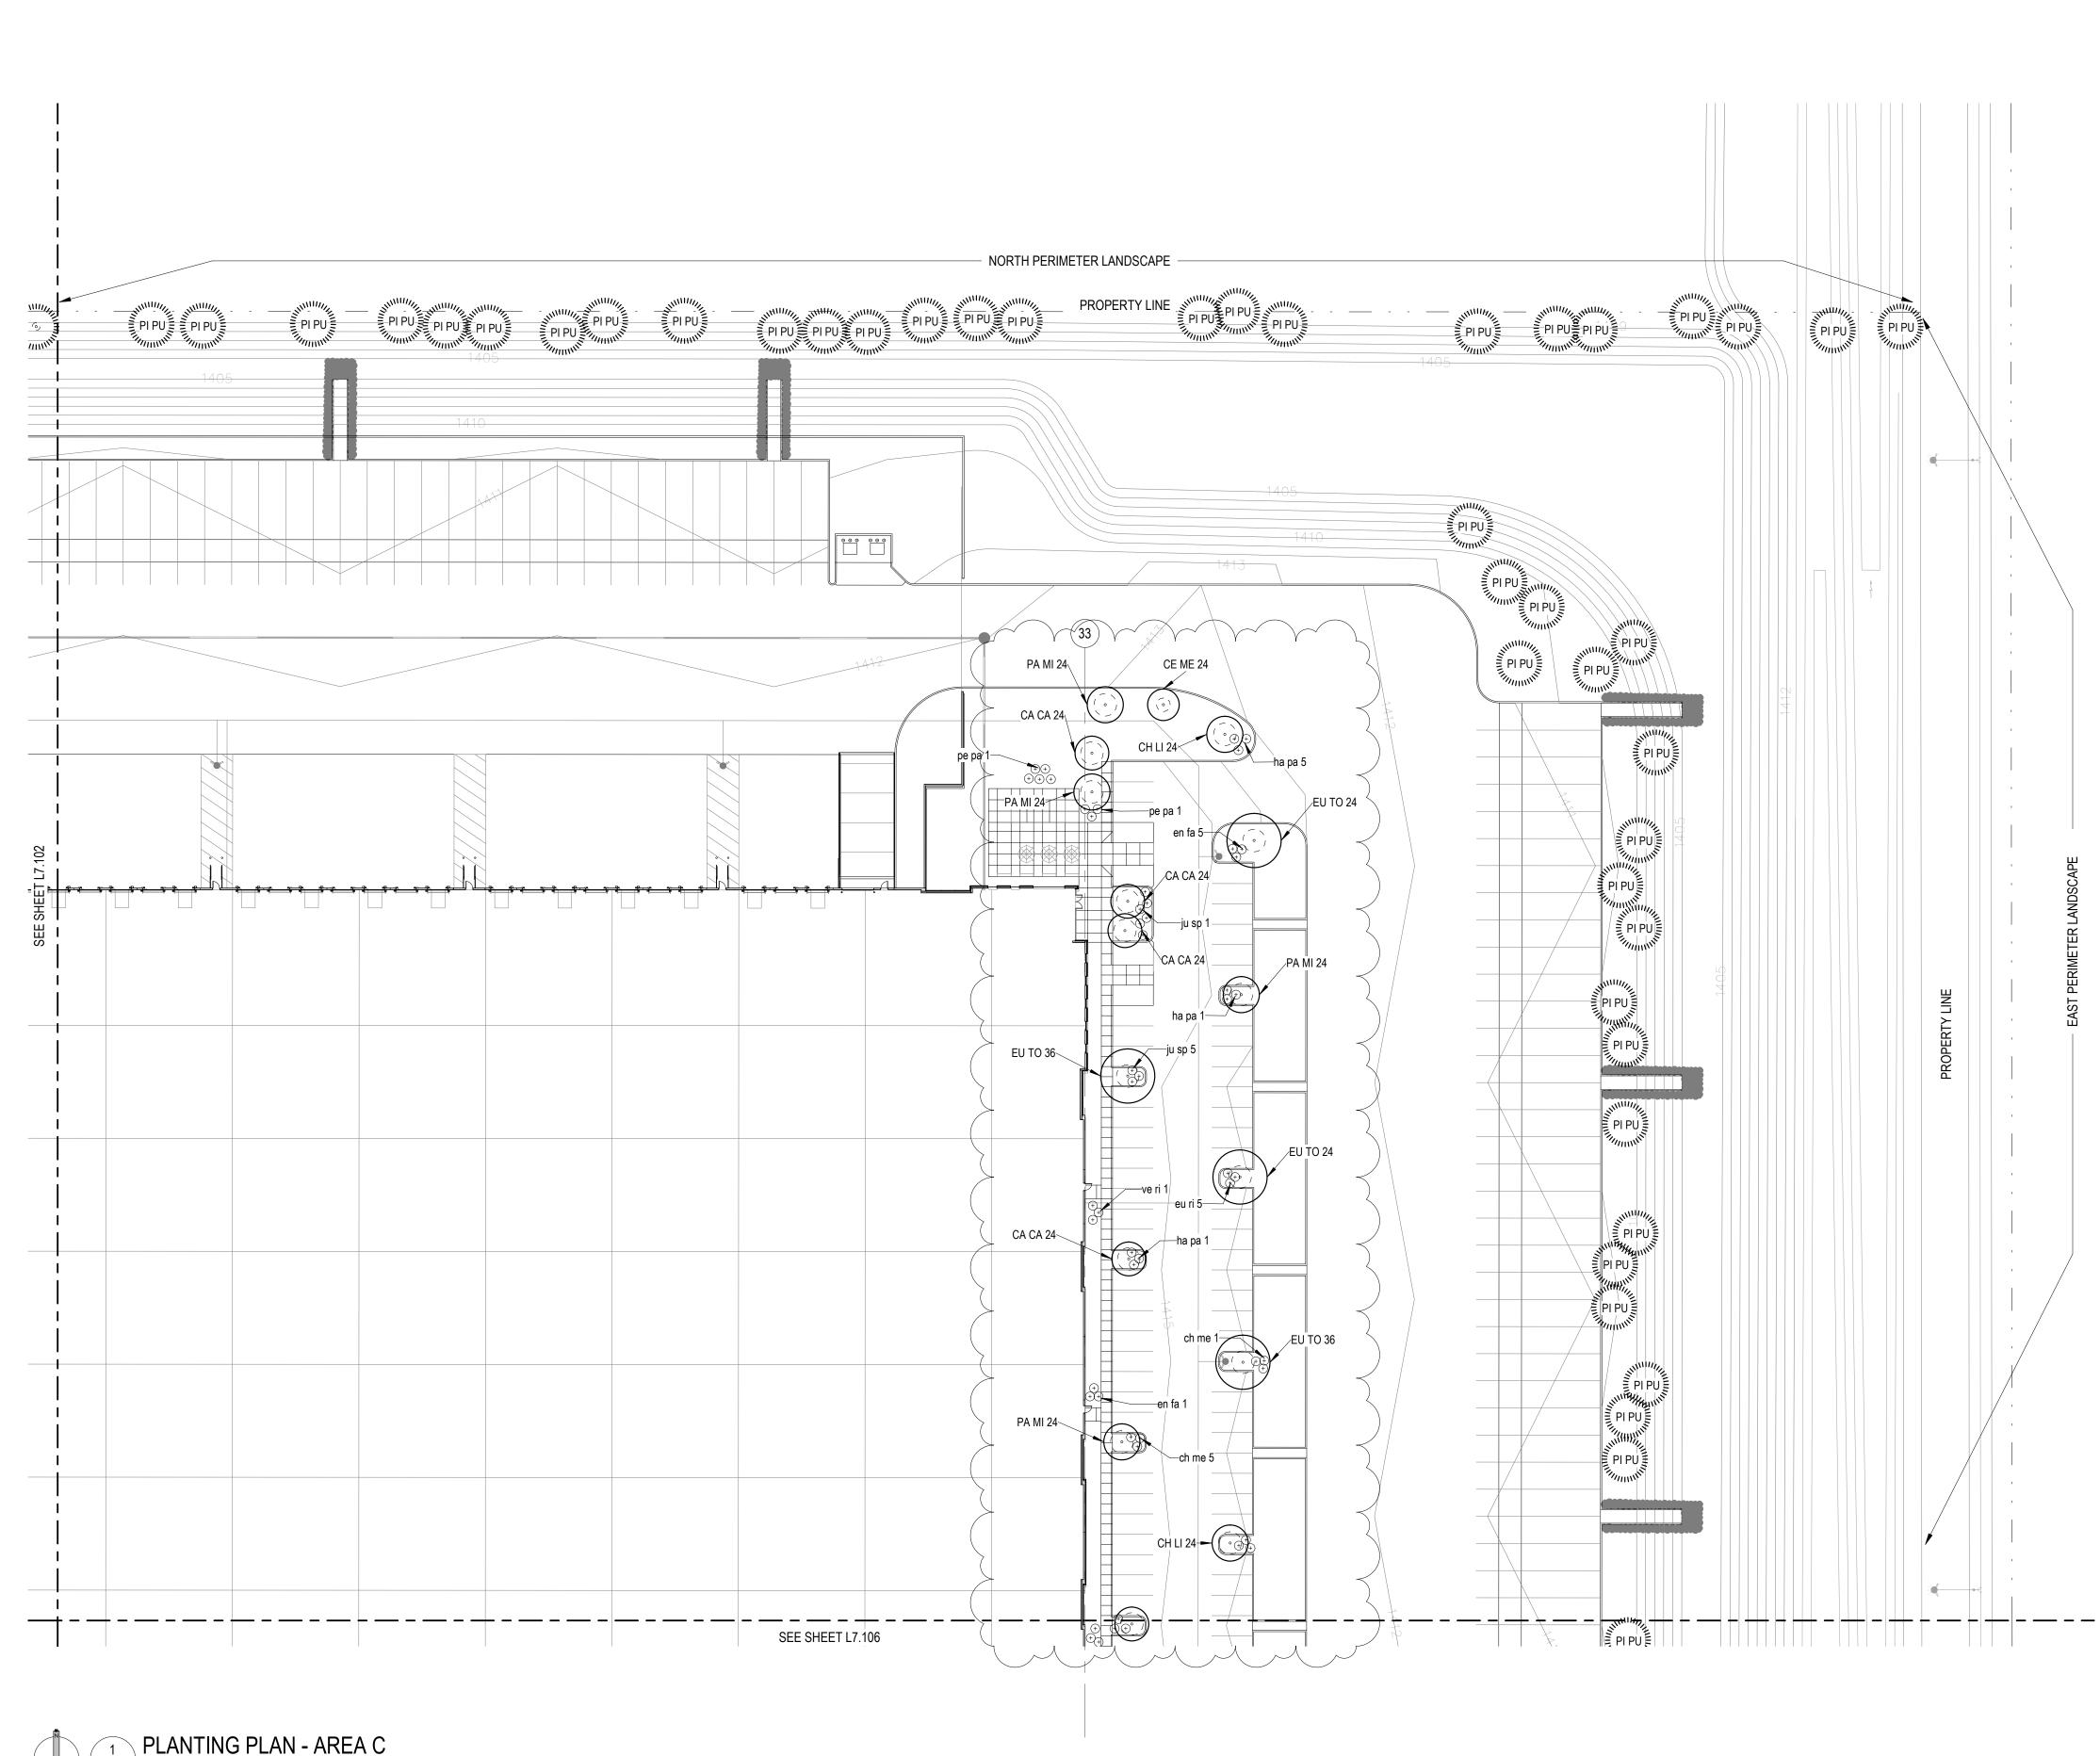

L7.103 1" = 40'-0"

2022 12:20:17 PM

CITY OF MESA GENERAL NOTES FOR LANDSCAPE PLAN

- 1. LANDSCAPE CONTRACTOR SHALL CONFIRM LOCATION OF ALL UNDERGROUND UTILITIES PRIOR TO
- ANY EXCAVATION AND SHALL BE RESPONSIBLE FOR THE FOLLOWING: 2. DAMAGES TO SUCH UTILITIES CAUSED AS A RESULT OF THE CONTRACTOR'S ACTIVITIES.
- 3. DAMAGES TO EXISTING WALKS, WALLS, DRIVES, CURBS, ETC.
- 4. INSPECTING THE SITE IN ORDER TO BE FULLY AWARE OF EXISTING CONDITIONS PRIOR TO SUBMITTING A BID.
- INSTALLATION OF ALL LANDSCAPE AND IRRIGATION MATERIALS SHALL COMPLY WITH SECTIONS 424, 425, 757, AND 795 OF THE MAG STANDARD SPECIFICATIONS.
 CONTRACTOR SHALL REPAIR ANY DAMAGE MADE TO THE EXISTING SPRINKLER SYSTEM TO THE
- SATISFACTION OF THE CITY AT NO ADDITIONAL COST TO THE CITY. 4. LANDSCAPE REMOVAL IS A NON-PAY ITEM UNLESS OTHERWISE NOTED.

5. ALL EXISTING VEGETATION, WEEDS, DEBRIS, ETC. NOTED TO BE REMOVED ON THE PLANS AND SPECIFICATIONS SHALL BE REMOVED FROM PROJECT AREA AND DISPOSED OF PROPERLY OFF THE SITE AT THE CONTRACTOR'S EXPENSE (SCARIFY EXISTING SUBGRADE, MINIMUM SIX (6) INCHES DEPTH).

6. DAMAGE TO TURF SHALL BE REPAIRED BY CONTRACTOR, I.E., RUTS FILLED WITH CLEAN SOIL, COMPACTED TO MATCH SURROUNDING GRADES, EXCESS SOIL, ROCK, ETC. SHALL BE REMOVED TO LEAVE THE SITE CLEAN.

7. ALL PLANT MATERIAL, OTHER THAN TREES, SHALL CONFORM TO GRADING, TYPE, ETC. AS SET FORTH IN THE <u>AMERICAN STANDARD FOR NURSERY STOCK</u> BY THE AMERICAN ASSOCIATION OF NURSERYMEN. ALL TREES SHALL CONFORM TO THE CURRENT <u>ARIZONA NURSERY ASSOCIATION TREE</u> <u>SPECIFICATIONS</u> AND MAG SPEC 795.7. SHOULD ANY CONFLICTS IN THE SPECIFICATIONS OCCUR, THE ARIZONA NURSERY ASSOCIATION'S SPECIFICATIONS SHALL PREVAIL.

8. CITY RESERVES THE RIGHT TO INSPECT SHRUBS AND CONTAINERED TREES FOR CONDITION OF ROOT BALLS. FOR ANY SUCH INSPECTIONS WHICH MAY DESTROY ROOTBALL, CONTRACTOR SHALL SUPPLY ADDITIONAL PLANT AT NO COST TO CITY.

 PLANT PITS SHALL BE INSPECTED BY CITY PRIOR TO PLANTING BY THE CONTRACTOR BY REQUESTING AN INSPECTION 48 HOURS IN ADVANCE.
 ROUGH AND FINE GRADING TO ESTABLISH UNIFORM SMOOTH GRADE IS INCLUDED IN THIS PROJECT.

11. SOIL TEST FOR FERTILITY AND ADDITIVE RECOMMENDATIONS (FOR TURF AND ORNAMENTALS) SHALL BE COMPLETED BY CONTRACTOR TO DETERMINE IF ADDITIVES ARE REQUIRED. CONTRACTOR SHALL PROVIDE COPY OF SOIL TEST RESULTS FOR REVIEW AND APPROVAL TO ENGINEERING INSPECTOR AT LEAST SEVEN (7) DAYS PRIOR TO ANTICIPATED PLANTING. AFTER APPROVAL BY THE CITY, THE CONTRACTOR SHALL PROVIDE AND INCORPORATE ANY ADDITIVES REQUIRED PRIOR TO OR AT TIME OF PLANTING.

 PLANT PIT SOIL MIXTURE SHALL CONSIST OF FOUR AND ONE-HALF PARTS NATURAL FERTILE, FRIABLE SOIL AND ONE PART HUMUS BY VOLUME, THOROUGHLY MIXED PRIOR TO BACKFILLING IN PITS. BACKFILLING SHALL BE IN 6" LIFTS WITH EACH LIFT WATER SETTLED WITHOUT PUDDLING.
 CONTRACTOR SHALL STAKE TREE AND SHRUB LOCATIONS FOR 5-GALLON PLANTS AND LARGER. STAKES SHALL BE MARKED WITH PLANT NAME OR PLANT LEGEND ITEM NUMBER FROM PLANS.
 ALL EXISTING (GAS, ELECTRIC, WATER, ETC.) COVERS AND BOXES SHALL REMAIN UNCOVERED. CONTRACTOR TO ADJUST TO FINAL GRADE AS NECESSARY. NON-PAY ITEM (NPI) UNLESS OTHERWISE NOTED.

15. THE CONTRACTOR SHALL BE RESPONSIBLE FOR LOCATING THE UNDERGROUND SPRINKLER SYSTEMS IN ADVANCE OF CONSTRUCTION. THE SPRINKLER SYSTEM LOCATIONS NOTED ON PLANS ARE FOR REFERENCE ONLY.

16. CONTRACTOR TO VERIFY DEPTH OF ALL INLET STRUCTURES AND SPRINKLER SYSTEMS PRIOR TO TRENCHING FOR LOW-FLOW CHANNEL.

 17. CONTRACTOR TO PROVIDE PUMPING WITHIN FIVE (5) DAYS AFTER THE NOTICE TO PROCEED IS GIVEN AS REQUIRED TO DRY THE AREA SUFFICIENTLY TO BEGIN CONSTRUCTION.
 18. CONTRACTOR SHALL ARRANGE FOR SPRINKLER SYSTEM SHUTDOWN DURING CONSTRUCTION BY

CONTACTING THE ENGINEERING INSPECTOR. 19. NO ROCKS LARGER THAN 1" IN DIAMETER SHALL BE ALLOWED IN THE TOP SIX (6) INCHES OF

TOPSOIL WHERE TURF ESTABLISHMENT IS SPECIFIED. ROCK REMOVAL AS NECESSÁRY IS A NON-PAY (NPI) ITEM UNLESS OTHERWISE NOTED.

20. WHERE CALICHE IS ENCOUNTERED IN PLANT PITS, DEPTH AND WIDTH OF PIT SHALL BE INCREASED BY ONE-THIRD (1/3) OVER SPECIFICATION, AND A LIQUID PENETRATOR, "AL-KALICHE" OR EQUAL, SHALL BE INCORPORATED FOR EACH PIT PER MANUFACTURER'S RECOMMENDATIONS.

21. CONTRACTOR SHALL INSTALL DECOMPOSED GRANITE TO A ROLLED DEPTH PER THE APPROVED PLANS AND SPECIFICATIONS. DECOMPOSED GRANITE SHALL BE PER THE APPROVED PLANS AND SPECIFICATIONS WITH THE COLOR AS SPECIFIED ON THE PLANS. PRE-EMERGENT HERBICIDE SHALL BE APPLIED BEFORE AND AFTER PLACEMENT OF DECOMPOSED GRANITE PER THE MANUFACTURER'S RECOMMENDATIONS. PRE-EMERGENT HERBICIDE SHALL BE SURFLAN, DACTHAL, OR APPROVED EQUAL. SAMPLE TO BE PROVIDED FOR CITY REVIEW AND APPROVAL. CONTRACTOR SHALL WASH OFF ROCK MULCH ONCE FINAL PLACEMENT HAS OCCURRED.

22. RESTORE ALL EXISTING LANDSCAPE IRRIGATION SYSTEMS, COMPONENTS AND LANDSCAPE AREAS IMPACTED BY ANY WORK UNDER THIS CONTRACT. RESTORE ALL EXISTING IRRIGATION AND LANDSCAPE IN ACCORDANCE WITH THE LANDSCAPE RESTORATION NOTES INDICATED WITHIN THESE DOCUMENTS. AT A MINIMUM, ALL RESTORATION SHALL BE IN ACCORDANCE WITH M.A.G.

SPECIFICATION 107.9 - PROTECTION AND RESTORATION OF PROPERTY AND LANDSCAPE. ALL RESTORATION WORK SHALL BE COMPLETED TO THE SATISFACTION OF THE CITY OF MESA ENGINEER.

23. ALL RESTORATION WORK SHALL BE COMPLETED IN ACCORDANCE WITH THE REFERENCED
 DETAILS AND ANY ADDITIONAL DETAILS PROVIDED.
 24. REFER TO LANDSCAPE PLANTING SHEETS AND ENGINEERING DRAWINGS FOR ADDITIONAL


RESTORATION NOTES AND REQUIRED COORDINATION.

		TREE LEGEN	ID	
Code	Botanical Name	Cultivar	Common Name	Size
AC SM 24	Acacia smallii		Sweet Acacia	24" BOX
AC SM 36	Acacia smallii		Sweet Acacia	36" BOX
CA CA 15	Caesalpinia cacalaco	'Smoothie'	Thornless Cascalote	15 GAL.
CA CA 24	Caesalpinia cacalaco	'Smoothie'	Thornless Cascalote	24" BOX
CE ME 15	Cercis mexicana		Mexican Redbud	15 GAL.
CE ME 24	Cercis mexicana		Mexican Redbud	24" BOX
CH LI 24	Chilopsis Linearis		Desert Willow	24" BOX
CH LI 36	Chilopsis Linearis		Desert Willow	36" BOX
EU TO 24	Eucalyptus torquata		Coral Gum	24" BOX
EU TO 36	Eucalyptus torquata		Coral Gum	36" BOX
PA MI 24	Parkinsonia microphylla		Foothill Palo Verde	24" BOX
PI PU	Pinus cembroides		Mexican Pinon Pine	15 GAL.

Cada	Detenied Name	Cultiver	Common Nomo	Cine
Code	Botanical Name	Cultivar	Common Name	Size
ala 199 a 1	Ohn so stinia maviana		Domionito Doinu	1.0-1
ch me 1	Chrysactinia mexicana Chrysactinia mexicana		Damianita Daisy	1 Gal
ch me 5	Chrysactinia mexicana Chrysactinia mexicana		Damianita Daisy	5 Gal.
en fa 1	Encelia farinosa		Brittlebush	1 Gal
en fa 5	Encelia farinosa		Brittlebush	5 Gal.
eu ri 1	euphorbia rigida		Gopher Plant	1 Gal
eu ri 5	euphorbia rigida		Gopher Plant	5 Gal.
ha pa 1	Hamelia patens	'Sierra Red'	Fire Bush	1 Gal
ha pa 5	Hamelia patens	'Sierra Red'	Fire Bush	5 Gal.
ju sp 1	Justicia spicigera		Mexican Honeysuckle	1 Gal
ju sp 5	Justicia spicigera		Mexican Honeysuckle	5 Gal.
pe pa 1	Penstemon parryi		Parry's Penstemon	1 Gal
pe pa 5	Penstemon parryi		Parry's Penstemon	5 Gal.
te st 1	Tecoma stans	'Gold Star'	Yellow Bells	1 Gal
te st 5	Tecoma stans	'Gold Star'	Yellow Bells	5 Gal.
ve ri 1	verbena rigida		Sandpaper Verbena	1 Gal
ve ri 5	verbena rigida		Sandpaper Verbena	5 Gal.

NOTE: NUMBER IN PLANT CODE INDICATED PLANT SIZE, NOT QUANTITY.



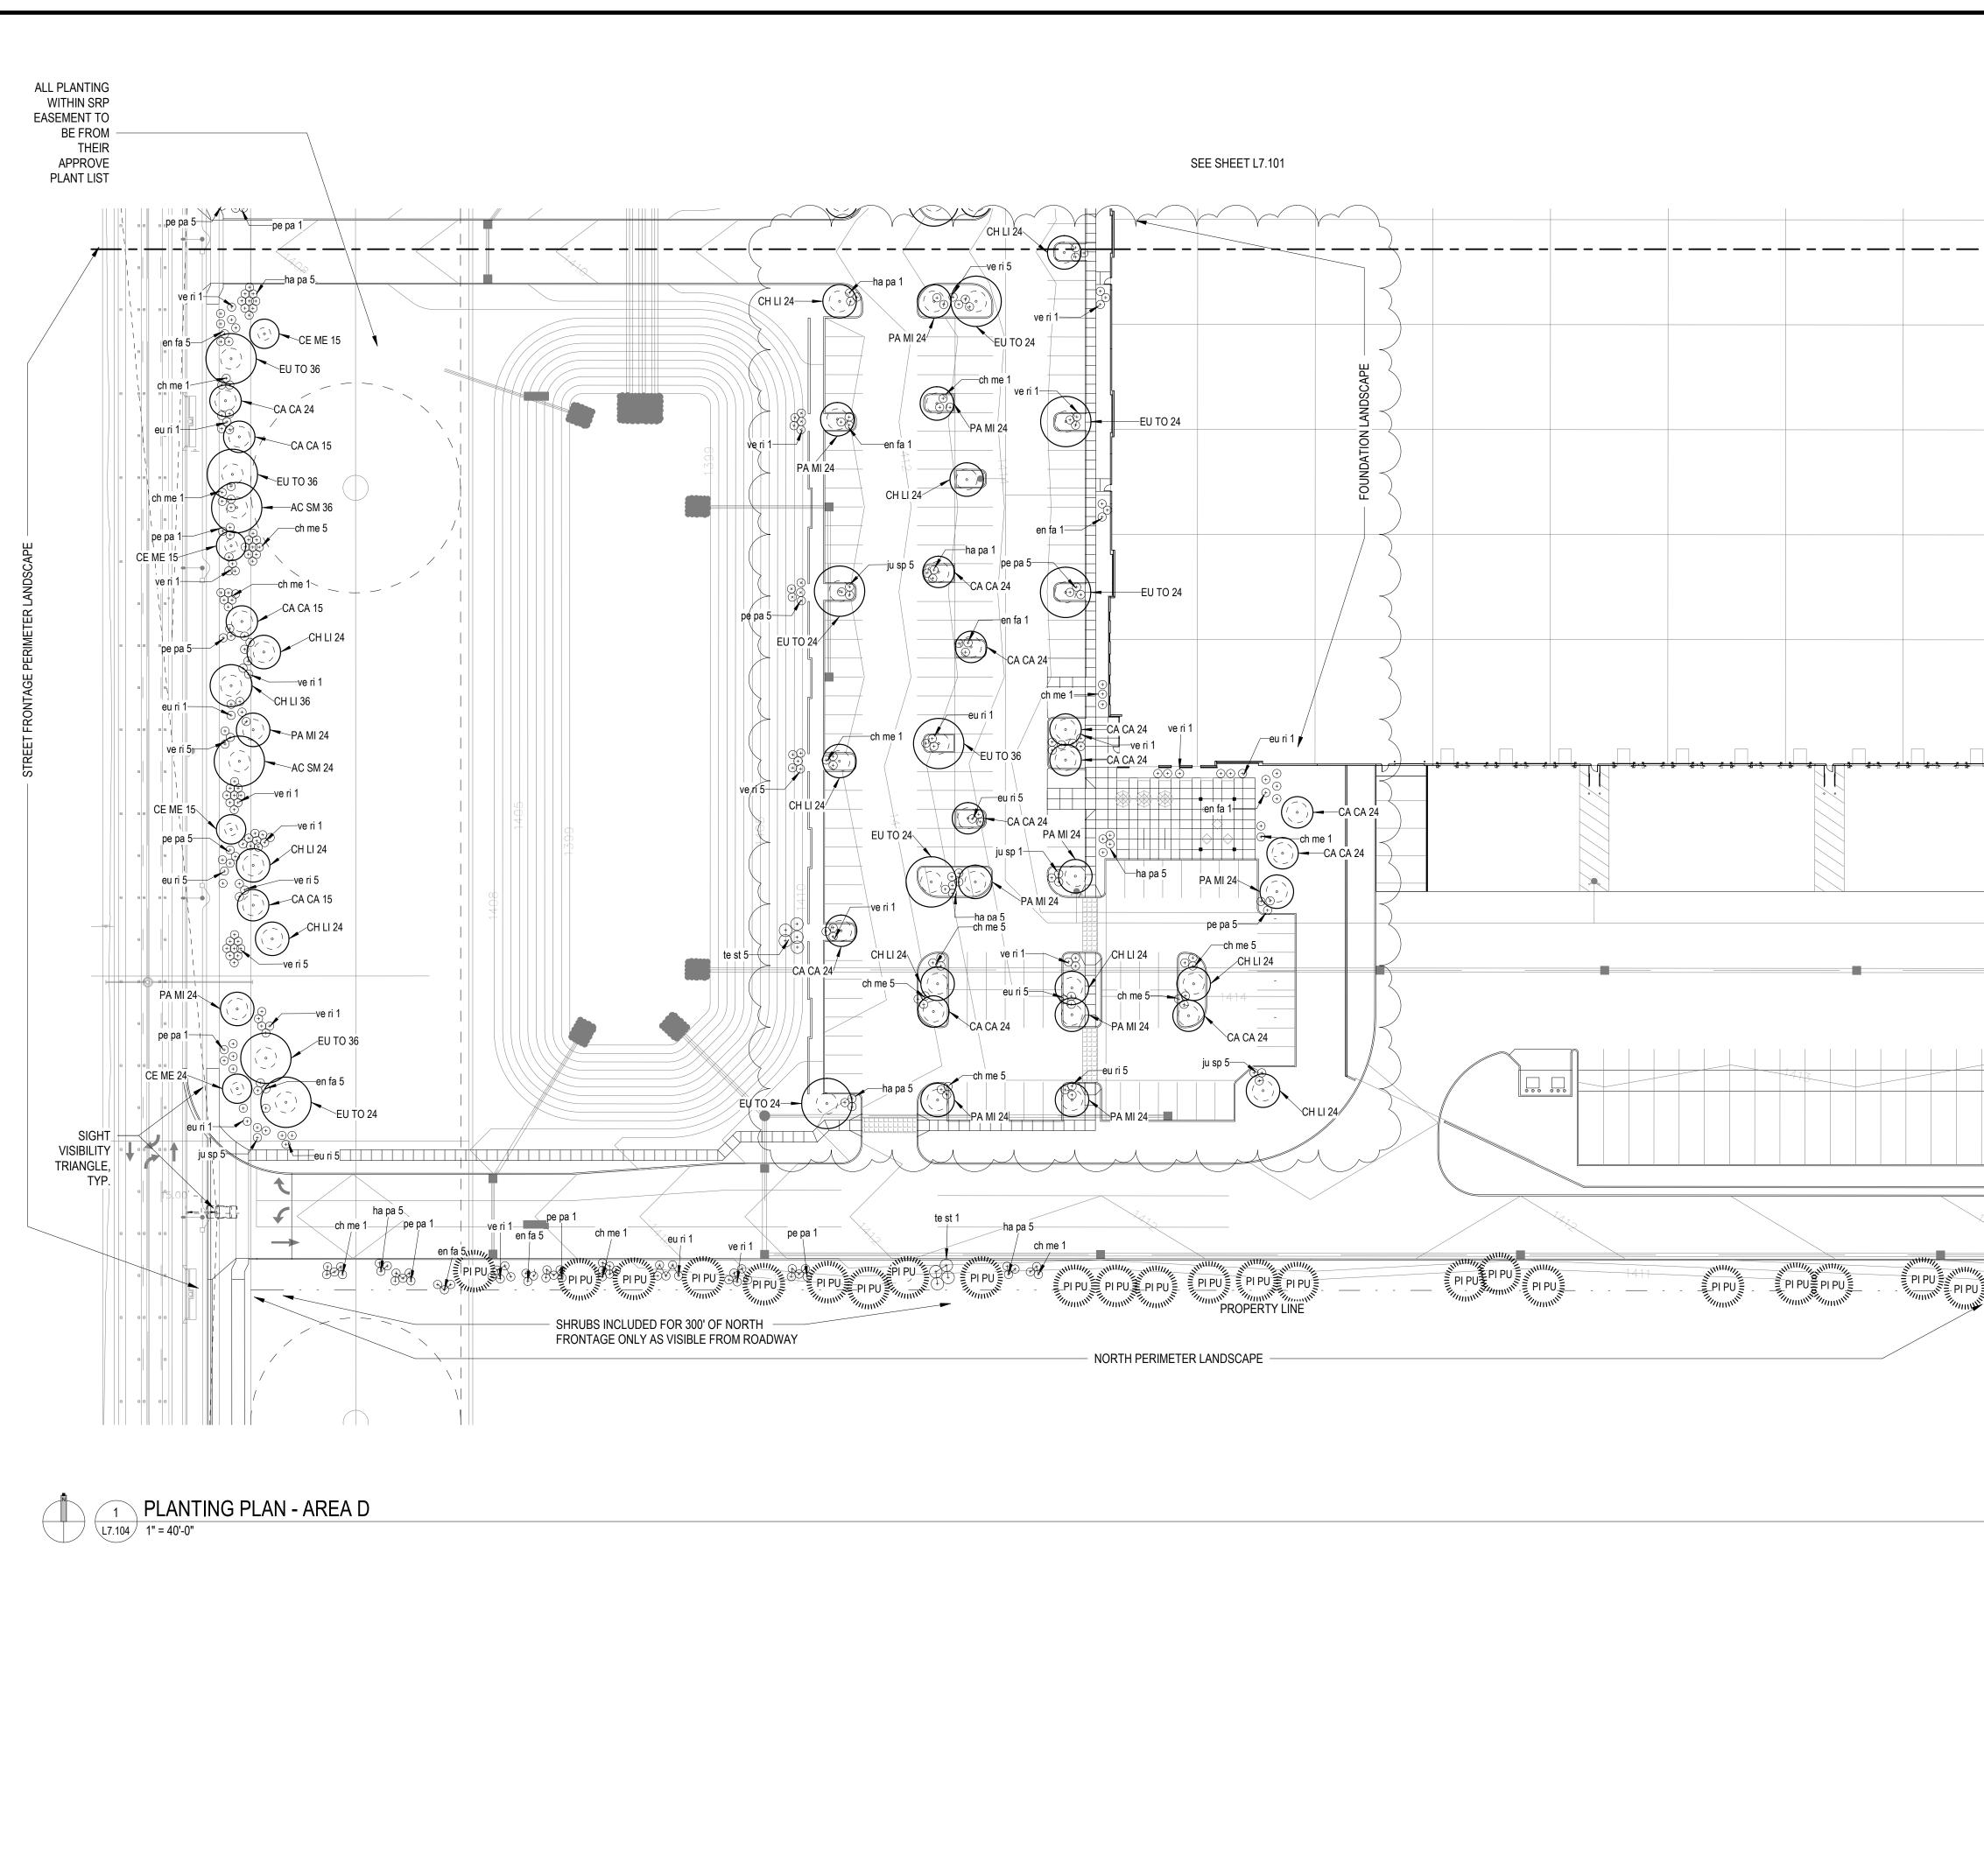

CITY OF MESA GENERAL NOTES FOR LANDSCAPE PLAN

- 1. LANDSCAPE CONTRACTOR SHALL CONFIRM LOCATION OF ALL UNDERGROUND UTILITIES PRIOR TO ANY EXCAVATION AND SHALL BE RESPONSIBLE FOR THE FOLLOWING:
- 2. DAMAGES TO SUCH UTILITIES CAUSED AS A RESULT OF THE CONTRACTOR'S ACTIVITIES.
- 3. DAMAGES TO EXISTING WALKS, WALLS, DRIVES, CURBS, ETC.
- 4. INSPECTING THE SITE IN ORDER TO BE FULLY AWARE OF EXISTING CONDITIONS PRIOR TO SUBMITTING A BID.

2. INSTALLATION OF ALL LANDSCAPE AND IRRIGATION MATERIALS SHALL COMPLY WITH SECTIONS 424, 425, 757, AND 795 OF THE MAG STANDARD SPECIFICATIONS. 3. CONTRACTOR SHALL REPAIR ANY DAMAGE MADE TO THE EXISTING SPRINKLER SYSTEM TO THE SATISFACTION OF THE CITY AT NO ADDITIONAL COST TO THE CITY.

4. LANDSCAPE REMOVAL IS A NON-PAY ITEM UNLESS OTHERWISE NOTED 5. ALL EXISTING VEGETATION, WEEDS, DEBRIS, ETC. NOTED TO BE REMOVED ON THE PLANS AND SPECIFICATIONS SHALL BE REMOVED FROM PROJECT AREA AND DISPOSED OF PROPERLY OFF THE SITE AT THE CONTRACTOR'S EXPENSE (SCARIFY EXISTING SUBGRADE, MINIMUM SIX (6) INCHES

DEPTH). 6. DAMAGE TO TURF SHALL BE REPAIRED BY CONTRACTOR, I.E., RUTS FILLED WITH CLEAN SOIL, COMPACTED TO MATCH SURROUNDING GRADES, EXCESS SOIL, ROCK, ETC. SHALL BE REMOVED TO LEAVE THE SITE CLEAN.

7. ALL PLANT MATERIAL, OTHER THAN TREES, SHALL CONFORM TO GRADING, TYPE, ETC. AS SET FORTH IN THE AMERICAN STANDARD FOR NURSERY STOCK BY THE AMERICAN ASSOCIATION OF NURSERYMEN. ALL TREES SHALL CONFORM TO THE CURRENT ARIZONA NURSERY ASSOCIATION TREE SPECIFICATIONS AND MAG SPEC 795.7. SHOULD ANY CONFLICTS IN THE SPECIFICATIONS OCCUR, THE ARIZONA NURSERY ASSOCIATION'S SPECIFICATIONS SHALL PREVAIL

8. CITY RESERVES THE RIGHT TO INSPECT SHRUBS AND CONTAINERED TREES FOR CONDITION OF ROOT BALLS. FOR ANY SUCH INSPECTIONS WHICH MAY DESTROY ROOTBALL, CONTRACTOR SHALL SUPPLY ADDITIONAL PLANT AT NO COST TO CITY. 9. PLANT PITS SHALL BE INSPECTED BY CITY PRIOR TO PLANTING BY THE CONTRACTOR BY

REQUESTING AN INSPECTION 48 HOURS IN ADVANCE. 10. ROUGH AND FINE GRADING TO ESTABLISH UNIFORM SMOOTH GRADE IS INCLUDED IN THIS PROJECT.

11. SOIL TEST FOR FERTILITY AND ADDITIVE RECOMMENDATIONS (FOR TURF AND ORNAMENTALS) SHALL BE COMPLETED BY CONTRACTOR TO DETERMINE IF ADDITIVES ARE REQUIRED. CONTRACTOR SHALL PROVIDE COPY OF SOIL TEST RESULTS FOR REVIEW AND APPROVAL TO ENGINEERING INSPECTOR AT LEAST SEVEN (7) DAYS PRIOR TO ANTICIPATED PLANTING. AFTER APPROVAL BY THE CITY, THE CONTRACTOR SHALL PROVIDE AND INCORPORATE ANY ADDITIVES REQUIRED PRIOR TO OR AT TIME OF PLANTING.

12. PLANT PIT SOIL MIXTURE SHALL CONSIST OF FOUR AND ONE-HALF PARTS NATURAL FERTILE, FRIABLE SOIL AND ONE PART HUMUS BY VOLUME, THOROUGHLY MIXED PRIOR TO BACKFILLING IN PITS. BACKFILLING SHALL BE IN 6" LIFTS WITH EACH LIFT WATER SETTLED WITHOUT PUDDLING. 13. CONTRACTOR SHALL STAKE TREE AND SHRUB LOCATIONS FOR 5-GALLON PLANTS AND LARGER. STAKES SHALL BE MARKED WITH PLANT NAME OR PLANT LEGEND ITEM NUMBER FROM PLANS. 14. ALL EXISTING (GAS, ELECTRIC, WATER, ETC.) COVERS AND BOXES SHALL REMAIN UNCOVERED CONTRACTOR TO ADJUST TO FINAL GRADE AS NECESSARY. NON-PAY ITEM (NPI) UNLESS OTHERWISE NOTED.

15. THE CONTRACTOR SHALL BE RESPONSIBLE FOR LOCATING THE UNDERGROUND SPRINKLER SYSTEMS IN ADVANCE OF CONSTRUCTION. THE SPRINKLER SYSTEM LOCATIONS NOTED ON PLANS ARE FOR REFERENCE ONLY.

16. CONTRACTOR TO VERIFY DEPTH OF ALL INLET STRUCTURES AND SPRINKLER SYSTEMS PRIOR TO TRENCHING FOR LOW-FLOW CHANNEL.

17. CONTRACTOR TO PROVIDE PUMPING WITHIN FIVE (5) DAYS AFTER THE NOTICE TO PROCEED IS GIVEN AS REQUIRED TO DRY THE AREA SUFFICIENTLY TO BEGIN CONSTRUCTION. 18. CONTRACTOR SHALL ARRANGE FOR SPRINKLER SYSTEM SHUTDOWN DURING CONSTRUCTION BY

CONTACTING THE ENGINEERING INSPECTOR. 19. NO ROCKS LARGER THAN 1" IN DIAMETER SHALL BE ALLOWED IN THE TOP SIX (6) INCHES OF

TOPSOIL WHERE TURF ESTABLISHMENT IS SPECIFIED. ROCK REMOVAL AS NECESSARY IS A NON-PAY (NPI) ITEM UNLESS OTHERWISE NOTED.

20. WHERE CALICHE IS ENCOUNTERED IN PLANT PITS, DEPTH AND WIDTH OF PIT SHALL BE INCREASED BY ONE-THIRD (1/3) OVER SPECIFICATION, AND A LIQUID PENETRATOR, "AL-KALICHE" OR EQUAL, SHALL BE INCORPORATED FOR EACH PIT PER MANUFACTURER'S RECOMMENDATIONS.

21. CONTRACTOR SHALL INSTALL DECOMPOSED GRANITE TO A ROLLED DEPTH PER THE APPROVED PLANS AND SPECIFICATIONS. DECOMPOSED GRANITE SHALL BE PER THE APPROVED PLANS AND SPECIFICATIONS WITH THE COLOR AS SPECIFIED ON THE PLANS. PRE-EMERGENT HERBICIDE SHALL BE APPLIED BEFORE AND AFTER PLACEMENT OF DECOMPOSED GRANITE PER THE MANUFACTURER'S RECOMMENDATIONS. PRE-EMERGENT HERBICIDE SHALL BE SURFLAN, DACTHAL, OR APPROVED EQUAL. SAMPLE TO BE PROVIDED FOR CITY REVIEW AND APPROVAL. CONTRACTOR SHALL WASH OFF ROCK MULCH ONCE FINAL PLACEMENT HAS OCCURRED.

22. RESTORE ALL EXISTING LANDSCAPE IRRIGATION SYSTEMS, COMPONENTS AND LANDSCAPE AREAS IMPACTED BY ANY WORK UNDER THIS CONTRACT. RESTORE ALL EXISTING IRRIGATION AND LANDSCAPE IN ACCORDANCE WITH THE LANDSCAPE RESTORATION NOTES INDICATED WITHIN THESE DOCUMENTS, AT A MINIMUM, ALL RESTORATION SHALL BE IN ACCORDANCE WITH M.A.G.

SPECIFICATION 107.9 - PROTECTION AND RESTORATION OF PROPERTY AND LANDSCAPE. ALL RESTORATION WORK SHALL BE COMPLETED TO THE SATISFACTION OF THE CITY OF MESA ENGINEER. 23. ALL RESTORATION WORK SHALL BE COMPLETED IN ACCORDANCE WITH THE REFERENCED


DETAILS AND ANY ADDITIONAL DETAILS PROVIDED. 24. REFER TO LANDSCAPE PLANTING SHEETS AND ENGINEERING DRAWINGS FOR ADDITIONAL RESTORATION NOTES AND REQUIRED COORDINATION.

		TREE LEGEN	D	
Code	Botanical Name	Cultivar	Common Name	Size
		1	1	
AC SM 24	Acacia smallii		Sweet Acacia	24" BOX
AC SM 36	Acacia smallii		Sweet Acacia	36" BOX
CA CA 15	Caesalpinia cacalaco	'Smoothie'	Thornless Cascalote	15 GAL.
CA CA 24	Caesalpinia cacalaco	'Smoothie'	Thornless Cascalote	24" BOX
CE ME 15	Cercis mexicana		Mexican Redbud	15 GAL.
CE ME 24	Cercis mexicana		Mexican Redbud	24" BOX
CH LI 24	Chilopsis Linearis		Desert Willow	24" BOX
CH LI 36	Chilopsis Linearis		Desert Willow	36" BOX
EU TO 24	Eucalyptus torquata		Coral Gum	24" BOX
EU TO 36	Eucalyptus torquata		Coral Gum	36" BOX
PA MI 24	Parkinsonia microphylla		Foothill Palo Verde	24" BOX
PI PU	Pinus cembroides		Mexican Pinon Pine	15 GAL.

		SHRUB LEGEN	ND	
Code	Botanical Name	Cultivar	Common Name	Size
ch me 1	Chrysactinia mexicana Chrysactinia mexicana		Damianita Daisy	1 Gal
ch me 5	Chrysactinia mexicana Chrysactinia mexicana		Damianita Daisy	5 Gal.
en fa 1	Encelia farinosa		Brittlebush	1 Gal
en fa 5	Encelia farinosa		Brittlebush	5 Gal.
eu ri 1	euphorbia rigida		Gopher Plant	1 Gal
eu ri 5	euphorbia rigida		Gopher Plant	5 Gal.
ha pa 1	Hamelia patens	'Sierra Red'	Fire Bush	1 Gal
ha pa 5	Hamelia patens	'Sierra Red'	Fire Bush	5 Gal.
ju sp 1	Justicia spicigera		Mexican Honeysuckle	1 Gal
ju sp 5	Justicia spicigera		Mexican Honeysuckle	5 Gal.
pe pa 1	Penstemon parryi		Parry's Penstemon	1 Gal
pe pa 5	Penstemon parryi		Parry's Penstemon	5 Gal.
te st 1	Tecoma stans	'Gold Star'	Yellow Bells	1 Gal
te st 5	Tecoma stans	'Gold Star'	Yellow Bells	5 Gal.
ve ri 1	verbena rigida		Sandpaper Verbena	1 Gal
ve ri 5	verbena rigida		Sandpaper Verbena	5 Gal.

NOTE: NUMBER IN PLANT CODE INDICATED PLANT SIZE, NOT QUANTITY.



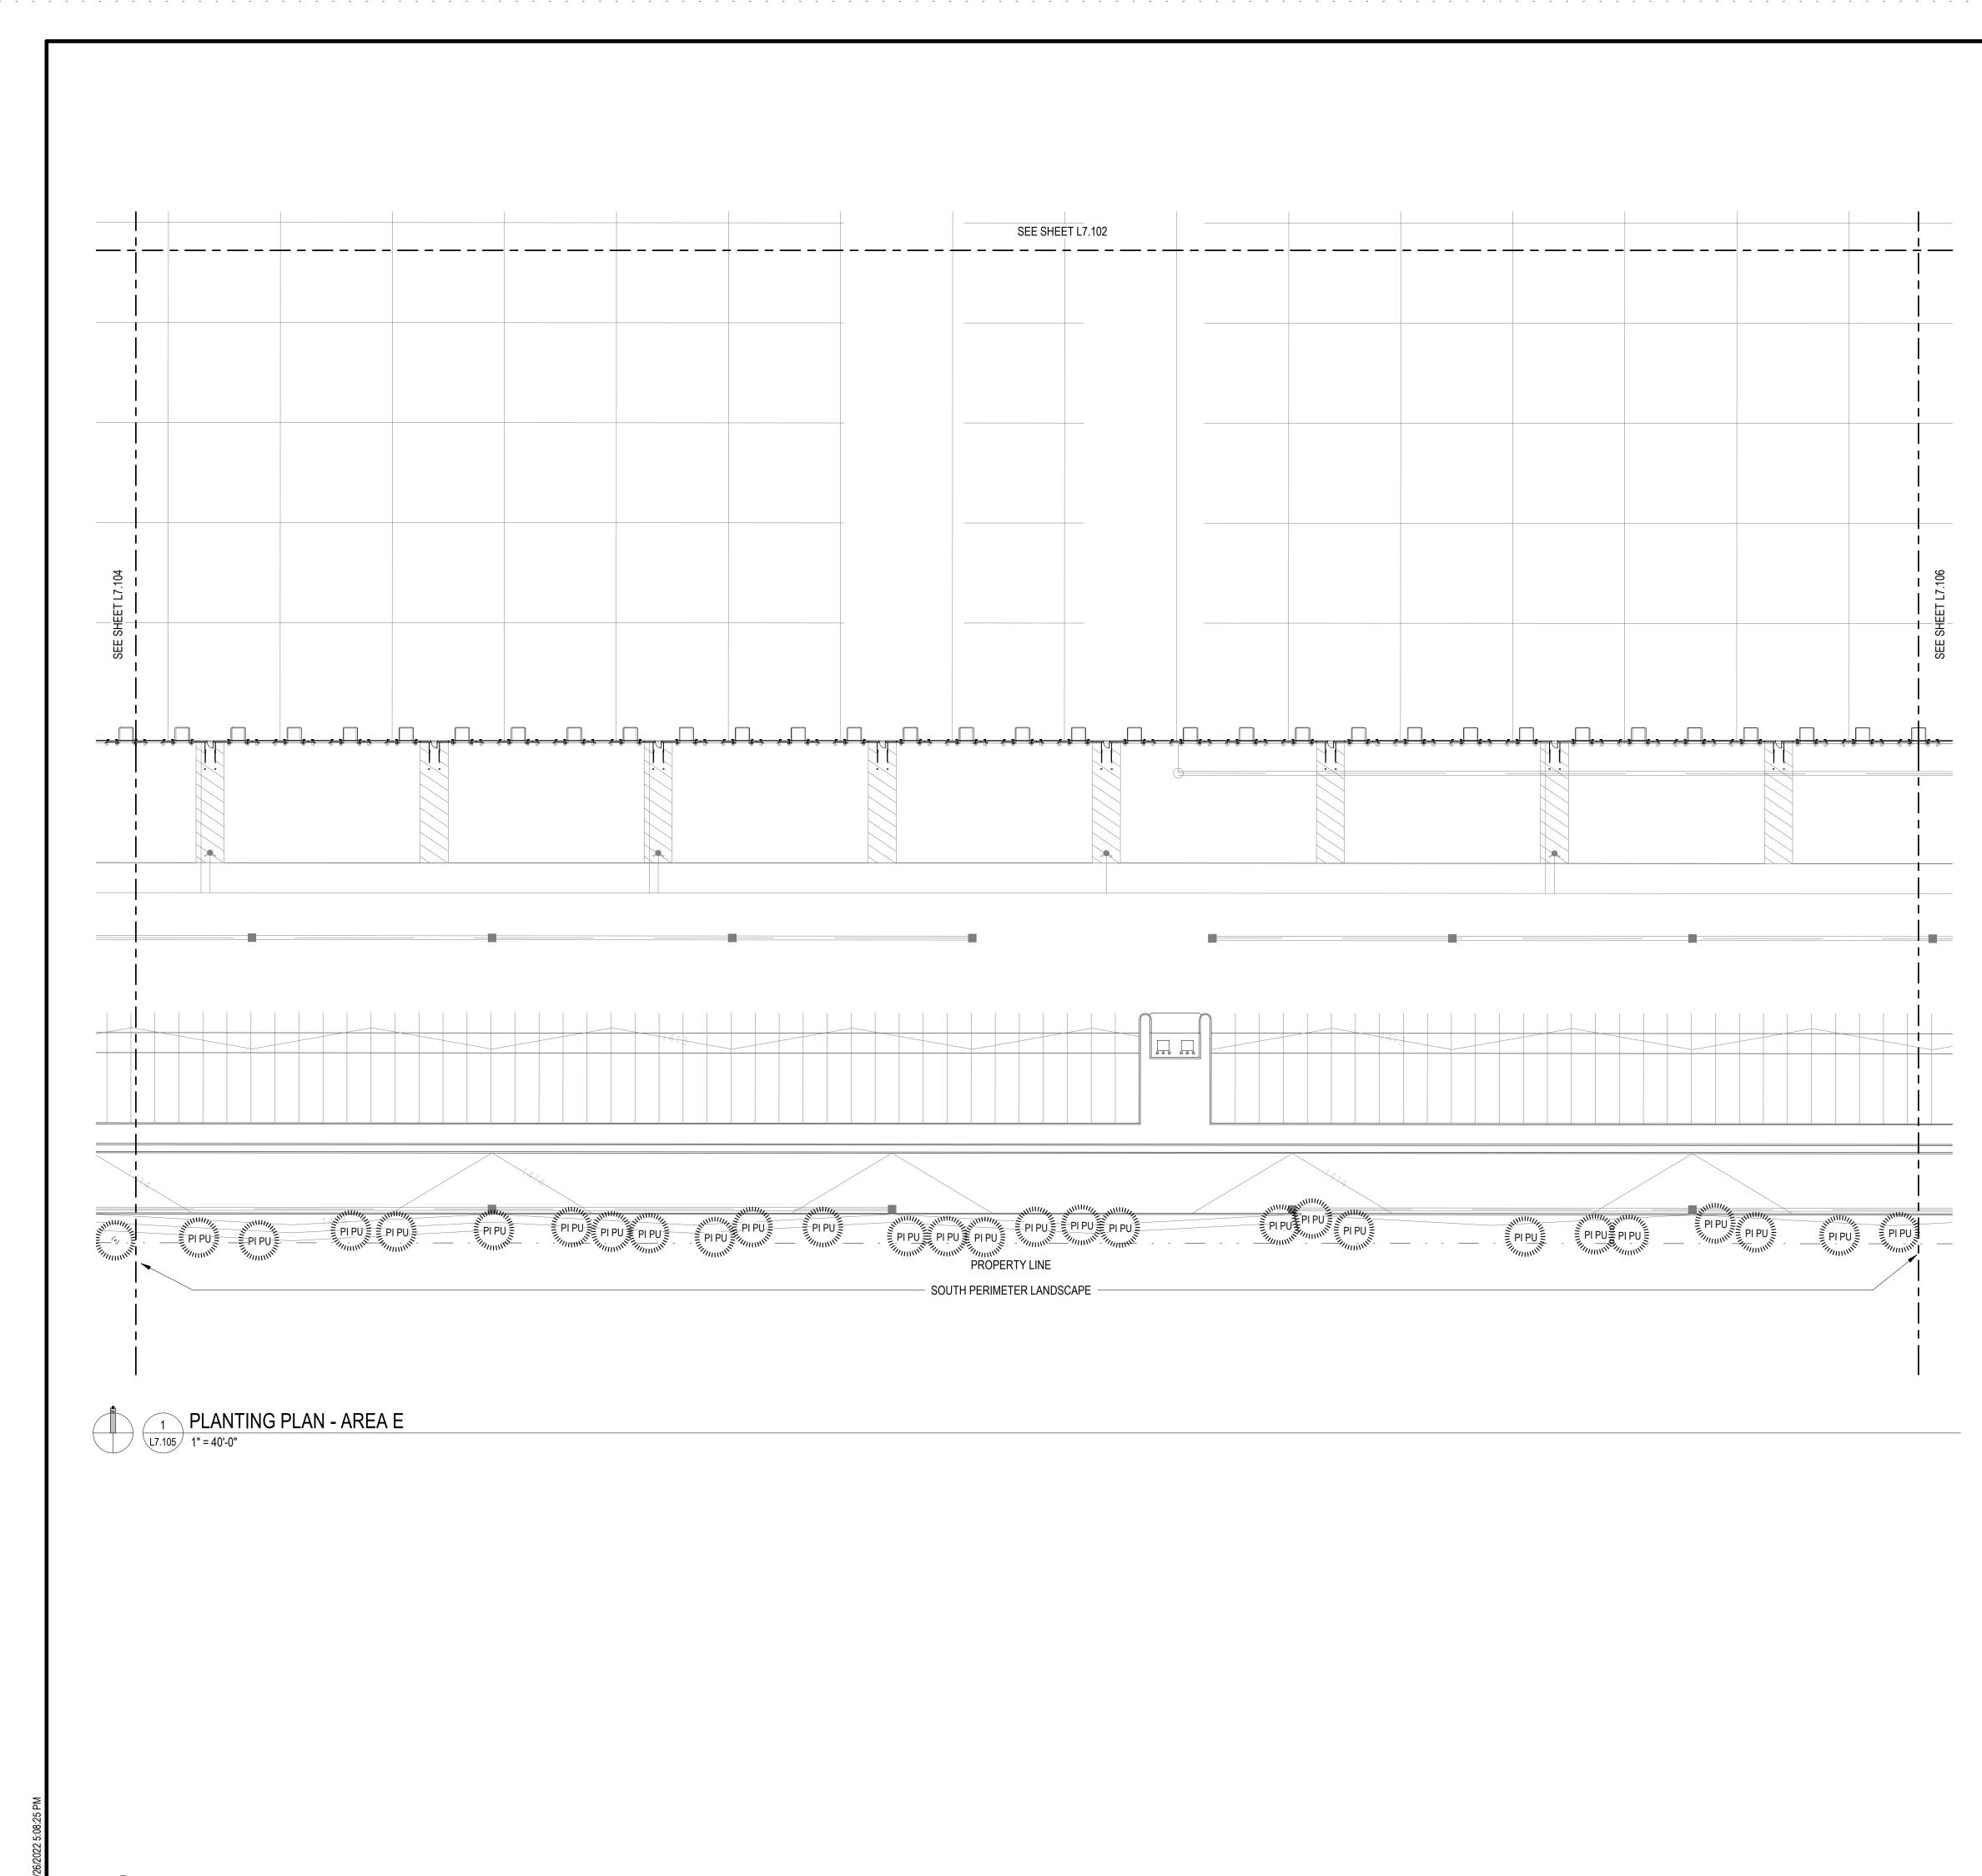

CITY OF MESA GENERAL NOTES FOR LANDSCAPE PLAN

- 1. LANDSCAPE CONTRACTOR SHALL CONFIRM LOCATION OF ALL UNDERGROUND UTILITIES PRIOR TO ANY EXCAVATION AND SHALL BE RESPONSIBLE FOR THE FOLLOWING:
- 2. DAMAGES TO SUCH UTILITIES CAUSED AS A RESULT OF THE CONTRACTOR'S ACTIVITIES.
- DAMAGES TO EXISTING WALKS, WALLS, DRIVES, CURBS, ETC.
 INSPECTING THE SITE IN ORDER TO BE FULLY AWARE OF EXISTING CONDITIONS PRIOR TO
- SUBMITTING A BID. 2. INSTALLATION OF ALL LANDSCAPE AND IRRIGATION MATERIALS SHALL COMPLY WITH SECTIONS

424, 425, 757, AND 795 OF THE MAG STANDARD SPECIFICATIONS.3. CONTRACTOR SHALL REPAIR ANY DAMAGE MADE TO THE EXISTING SPRINKLER SYSTEM TO THE SATISFACTION OF THE CITY AT NO ADDITIONAL COST TO THE CITY.

 LANDSCAPE REMOVAL IS A NON-PAY ITEM UNLESS OTHERWISE NOTED.
 ALL EXISTING VEGETATION, WEEDS, DEBRIS, ETC. NOTED TO BE REMOVED ON THE PLANS AND SPECIFICATIONS SHALL BE REMOVED FROM PROJECT AREA AND DISPOSED OF PROPERLY OFF THE SITE AT THE CONTRACTOR'S EXPENSE (SCARIFY EXISTING SUBGRADE, MINIMUM SIX (6) INCHES DEPTH).

6. DAMAGE TO TURF SHALL BE REPAIRED BY CONTRACTOR, I.E., RUTS FILLED WITH CLEAN SOIL, COMPACTED TO MATCH SURROUNDING GRADES, EXCESS SOIL, ROCK, ETC. SHALL BE REMOVED TO LEAVE THE SITE CLEAN.

7. ALL PLANT MATERIAL, OTHER THAN TREES, SHALL CONFORM TO GRADING, TYPE, ETC. AS SET FORTH IN THE <u>AMERICAN STANDARD FOR NURSERY STOCK</u> BY THE AMERICAN ASSOCIATION OF NURSERYMEN. ALL TREES SHALL CONFORM TO THE CURRENT <u>ARIZONA NURSERY ASSOCIATION TREE</u> <u>SPECIFICATIONS</u> AND MAG SPEC 795.7. SHOULD ANY CONFLICTS IN THE SPECIFICATIONS OCCUR, THE ARIZONA NURSERY ASSOCIATION'S SPECIFICATIONS SHALL PREVAIL.

8. CITY RESERVES THE RIGHT TO INSPECT SHRUBS AND CONTAINERED TREES FOR CONDITION OF ROOT BALLS. FOR ANY SUCH INSPECTIONS WHICH MAY DESTROY ROOTBALL, CONTRACTOR SHALL SUPPLY ADDITIONAL PLANT AT NO COST TO CITY.

 PLANT PITS SHALL BE INSPECTED BY CITY PRIOR TO PLANTING BY THE CONTRACTOR BY REQUESTING AN INSPECTION 48 HOURS IN ADVANCE.
 ROUGH AND FINE GRADING TO ESTABLISH UNIFORM SMOOTH GRADE IS INCLUDED IN THIS

PROJECT. 11. SOIL TEST FOR FERTILITY AND ADDITIVE RECOMMENDATIONS (FOR TURF AND ORNAMENTALS) SHALL BE COMPLETED BY CONTRACTOR TO DETERMINE IF ADDITIVES ARE REQUIRED. CONTRACTOR SHALL PROVIDE COPY OF SOIL TEST RESULTS FOR REVIEW AND APPROVAL TO ENGINEERING INSPECTOR AT LEAST SEVEN (7) DAYS PRIOR TO ANTICIPATED PLANTING. AFTER APPROVAL BY THE CITY, THE CONTRACTOR SHALL PROVIDE AND INCORPORATE ANY ADDITIVES REQUIRED PRIOR TO OR AT TIME OF PLANTING.

 PLANT PIT SOIL MIXTURE SHALL CONSIST OF FOUR AND ONE-HALF PARTS NATURAL FERTILE, FRIABLE SOIL AND ONE PART HUMUS BY VOLUME, THOROUGHLY MIXED PRIOR TO BACKFILLING IN PITS. BACKFILLING SHALL BE IN 6" LIFTS WITH EACH LIFT WATER SETTLED WITHOUT PUDDLING.
 CONTRACTOR SHALL STAKE TREE AND SHRUB LOCATIONS FOR 5-GALLON PLANTS AND LARGER. STAKES SHALL BE MARKED WITH PLANT NAME OR PLANT LEGEND ITEM NUMBER FROM PLANS.
 ALL EXISTING (GAS, ELECTRIC, WATER, ETC.) COVERS AND BOXES SHALL REMAIN UNCOVERED. CONTRACTOR TO ADJUST TO FINAL GRADE AS NECESSARY. NON-PAY ITEM (NPI) UNLESS OTHERWISE NOTED.

15. THE CONTRACTOR SHALL BE RESPONSIBLE FOR LOCATING THE UNDERGROUND SPRINKLER SYSTEMS IN ADVANCE OF CONSTRUCTION. THE SPRINKLER SYSTEM LOCATIONS NOTED ON PLANS ARE FOR REFERENCE ONLY.

16. CONTRACTOR TO VERIFY DEPTH OF ALL INLET STRUCTURES AND SPRINKLER SYSTEMS PRIOR TO TRENCHING FOR LOW-FLOW CHANNEL.

 CONTRACTOR TO PROVIDE PUMPING WITHIN FIVE (5) DAYS AFTER THE NOTICE TO PROCEED IS GIVEN AS REQUIRED TO DRY THE AREA SUFFICIENTLY TO BEGIN CONSTRUCTION.
 CONTRACTOR SHALL ARRANGE FOR SPRINKLER SYSTEM SHUTDOWN DURING CONSTRUCTION BY

CONTACTING THE ENGINEERING INSPECTOR. 19. NO ROCKS LARGER THAN 1" IN DIAMETER SHALL BE ALLOWED IN THE TOP SIX (6) INCHES OF TOPSOIL WHERE TURF ESTABLISHMENT IS SPECIFIED. ROCK REMOVAL AS NECESSARY IS A NON-PAY

(NPI) ITEM UNLESS OTHERWISE NOTED.20. WHERE CALICHE IS ENCOUNTERED IN PLANT PITS, DEPTH AND WIDTH OF PIT SHALL BE INCREASED

BY ONE-THIRD (1/3) OVER SPECIFICATION, AND A LIQUID PENETRATOR, "AL-KALICHE" OR EQUAL, SHALL BE INCORPORATED FOR EACH PIT PER MANUFACTURER'S RECOMMENDATIONS.

21. CONTRACTOR SHALL INSTALL DECOMPOSED GRANITE TO A ROLLED DEPTH PER THE APPROVED PLANS AND SPECIFICATIONS. DECOMPOSED GRANITE SHALL BE PER THE APPROVED PLANS AND SPECIFICATIONS WITH THE COLOR AS SPECIFIED ON THE PLANS. PRE-EMERGENT HERBICIDE SHALL BE APPLIED BEFORE AND AFTER PLACEMENT OF DECOMPOSED GRANITE PER THE MANUFACTURER'S RECOMMENDATIONS. PRE-EMERGENT HERBICIDE SHALL BE SURFLAN, DACTHAL, OR APPROVED EQUAL. SAMPLE TO BE PROVIDED FOR CITY REVIEW AND APPROVAL. CONTRACTOR SHALL WASH OFF ROCK MULCH ONCE FINAL PLACEMENT HAS OCCURRED.

22. RESTORE ALL EXISTING LANDSCAPE IRRIGATION SYSTEMS, COMPONENTS AND LANDSCAPE AREAS IMPACTED BY ANY WORK UNDER THIS CONTRACT. RESTORE ALL EXISTING IRRIGATION AND LANDSCAPE IN ACCORDANCE WITH THE LANDSCAPE RESTORATION NOTES INDICATED WITHIN THESE DOCUMENTS. AT A MINIMUM, ALL RESTORATION SHALL BE IN ACCORDANCE WITH M.A.G.

SPECIFICATION 107.9 - PROTECTION AND RESTORATION OF PROPERTY AND LANDSCAPE. ALL RESTORATION WORK SHALL BE COMPLETED TO THE SATISFACTION OF THE CITY OF MESA ENGINEER.

23. ALL RESTORATION WORK SHALL BE COMPLETED IN ACCORDANCE WITH THE REFERENCED DETAILS AND ANY ADDITIONAL DETAILS PROVIDED.

24. REFER TO LANDSCAPE PLANTING SHEETS AND ENGINEERING DRAWINGS FOR ADDITIONAL RESTORATION NOTES AND REQUIRED COORDINATION.


		TREE LEGENI	C	
Code	Botanical Name	Cultivar	Common Name	Size
		1	1	
AC SM 24	Acacia smallii		Sweet Acacia	24" BOX
AC SM 36	Acacia smallii		Sweet Acacia	36" BOX
CA CA 15	Caesalpinia cacalaco	'Smoothie'	Thornless Cascalote	15 GAL.
CA CA 24	Caesalpinia cacalaco	'Smoothie'	Thornless Cascalote	24" BOX
CE ME 15	Cercis mexicana		Mexican Redbud	15 GAL.
CE ME 24	Cercis mexicana		Mexican Redbud	24" BOX
CH LI 24	Chilopsis Linearis		Desert Willow	24" BOX
CH LI 36	Chilopsis Linearis		Desert Willow	36" BOX
EU TO 24	Eucalyptus torquata		Coral Gum	24" BOX
EU TO 36	Eucalyptus torquata		Coral Gum	36" BOX
PA MI 24	Parkinsonia microphylla		Foothill Palo Verde	24" BOX
PI PU	Pinus cembroides		Mexican Pinon Pine	15 GAL.

		SHRUB LEGEN		
Code	Botanical Name	Cultivar	Common Name	Size
ah 1999 1	Ohn an atinin marries an		Demionite Deinu	1.0-1
ch me 1	Chrysactinia mexicana Chrysactinia mexicana		Damianita Daisy	1 Gal
ch me 5	Chrysactinia mexicana Chrysactinia mexicana		Damianita Daisy	5 Gal.
en fa 1	Encelia farinosa		Brittlebush	1 Gal
en fa 5	Encelia farinosa		Brittlebush	5 Gal.
eu ri 1	euphorbia rigida		Gopher Plant	1 Gal
eu ri 5	euphorbia rigida		Gopher Plant	5 Gal.
ha pa 1	Hamelia patens	'Sierra Red'	Fire Bush	1 Gal
ha pa 5	Hamelia patens	'Sierra Red'	Fire Bush	5 Gal.
ju sp 1	Justicia spicigera		Mexican Honeysuckle	1 Gal
ju sp 5	Justicia spicigera		Mexican Honeysuckle	5 Gal.
pe pa 1	Penstemon parryi		Parry's Penstemon	1 Gal
pe pa 5	Penstemon parryi		Parry's Penstemon	5 Gal.
te st 1	Tecoma stans	'Gold Star'	Yellow Bells	1 Gal
te st 5	Tecoma stans	'Gold Star'	Yellow Bells	5 Gal.
ve ri 1	verbena rigida		Sandpaper Verbena	1 Gal
ve ri 5	verbena rigida		Sandpaper Verbena	5 Gal.

NOTE: NUMBER IN PLANT CODE INDICATED PLANT SIZE, NOT QUANTITY.



A

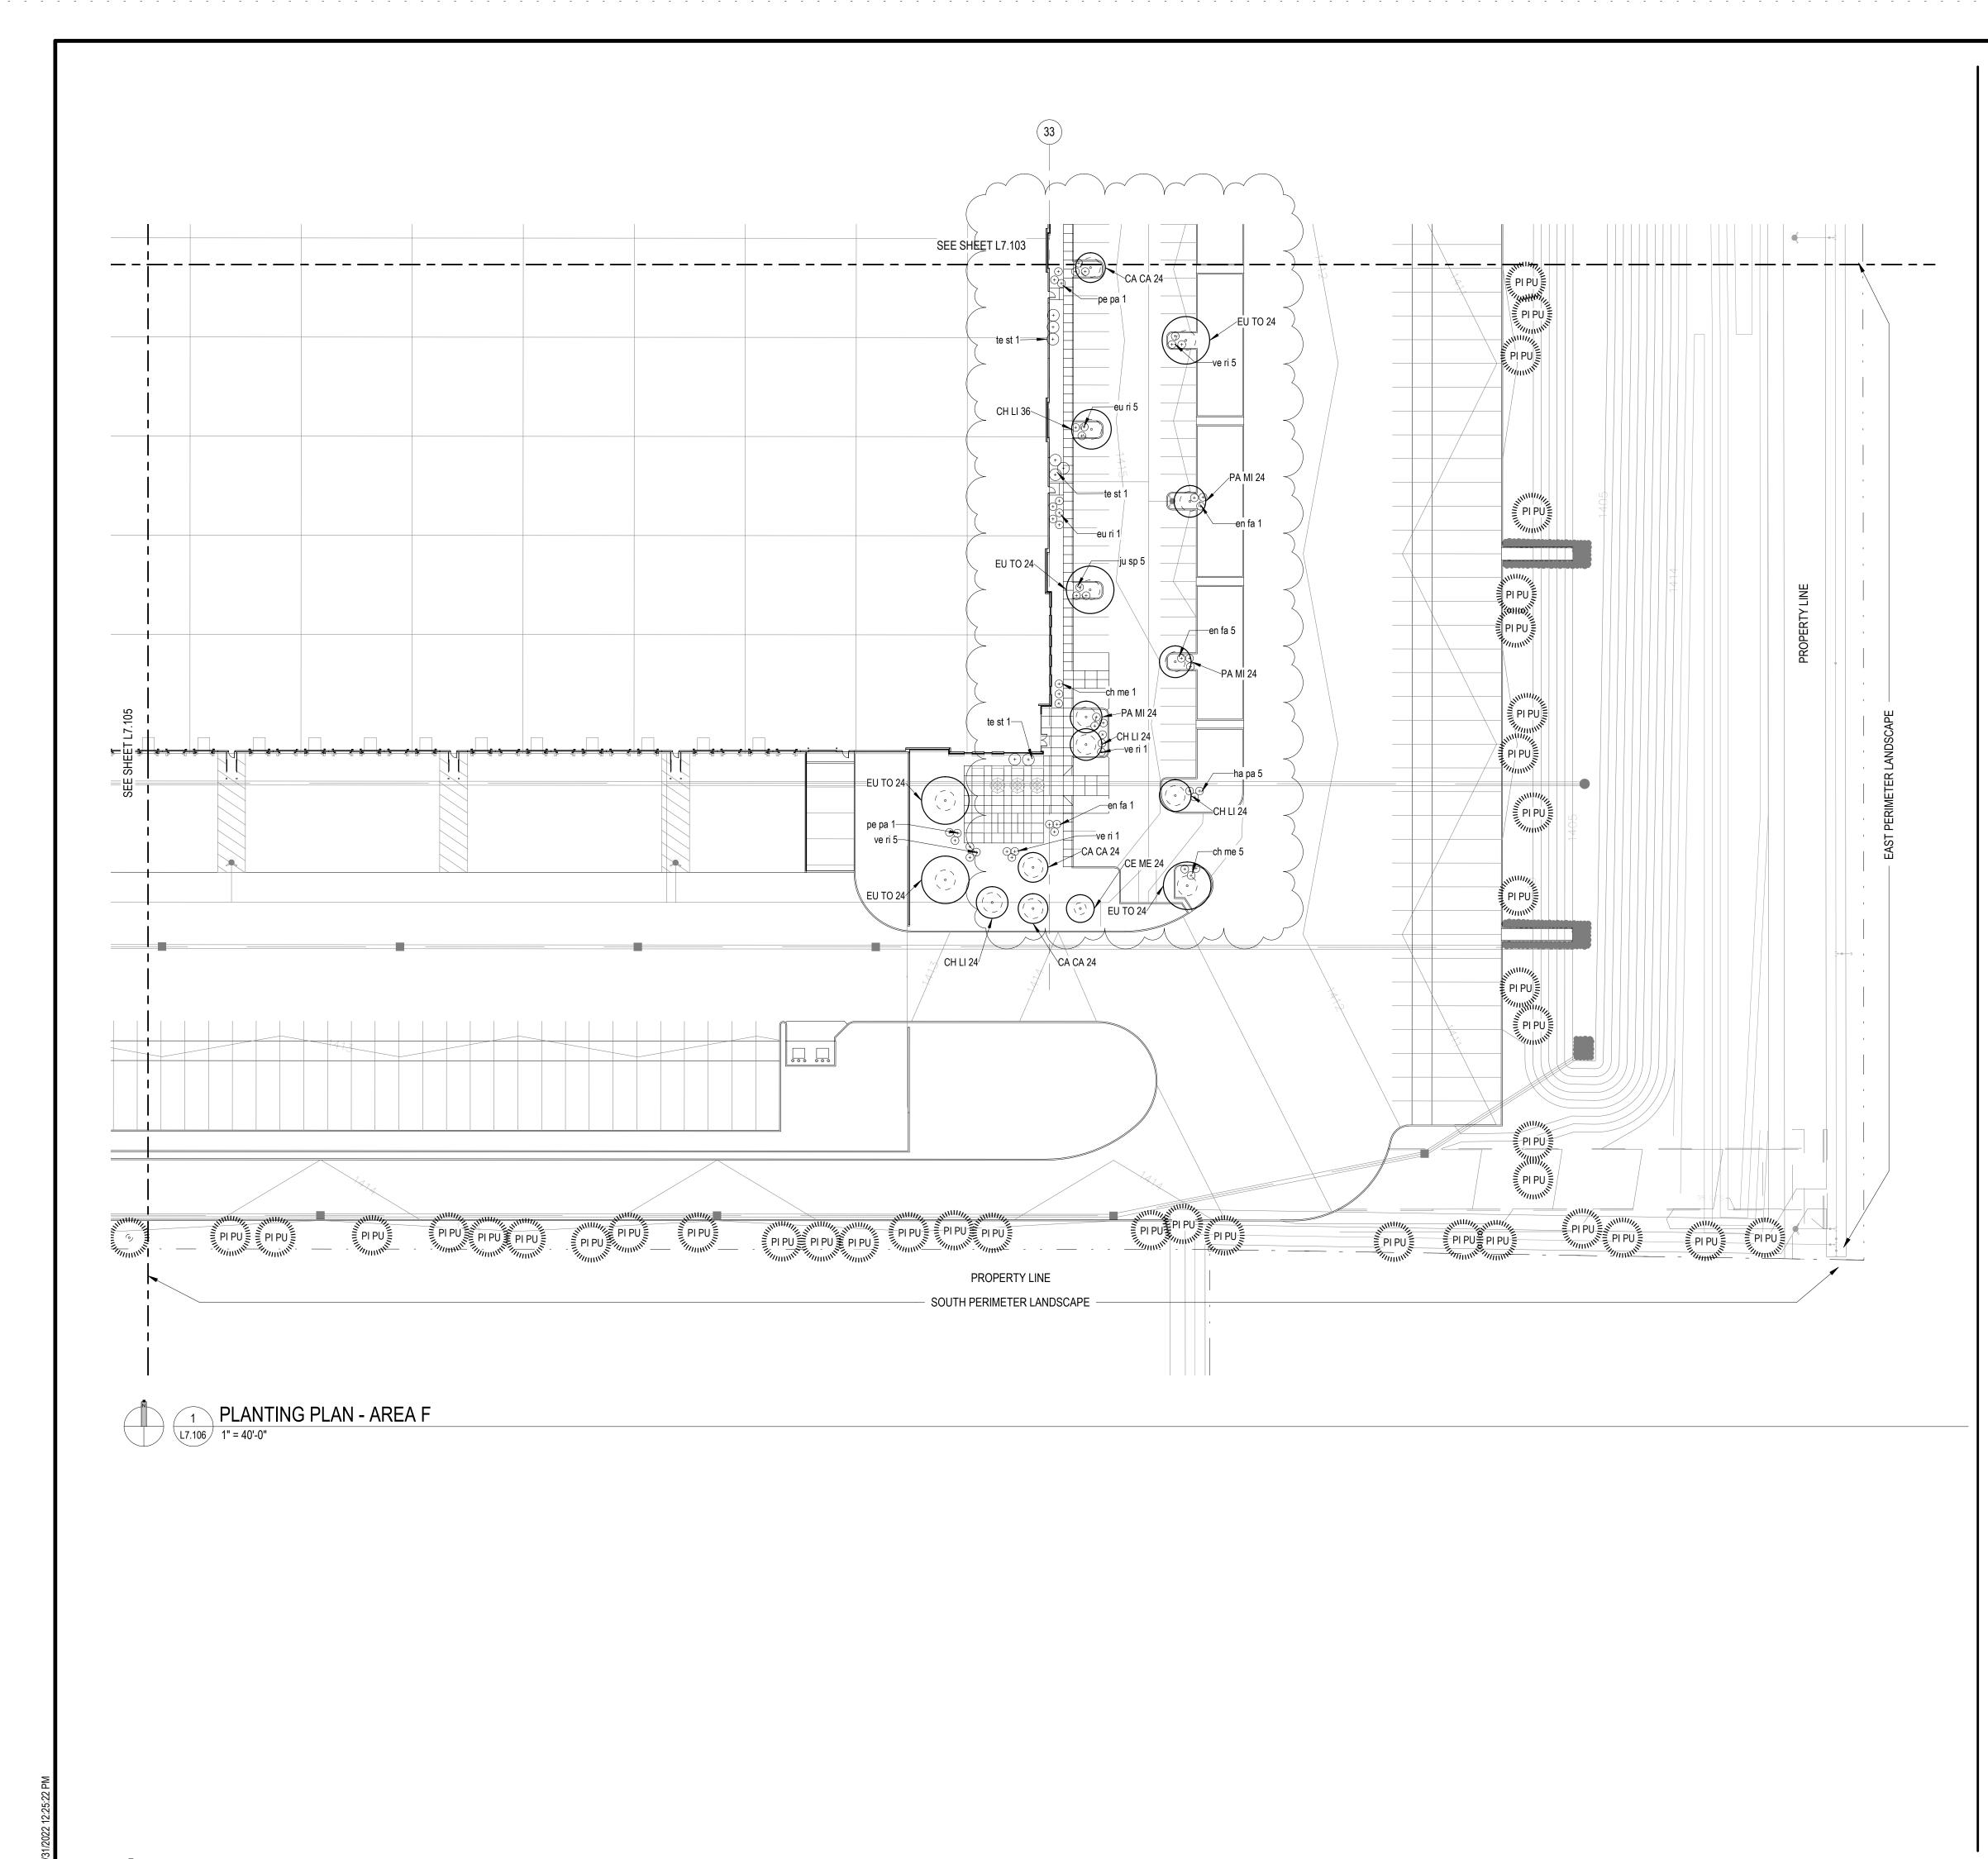

CITY OF MESA GENERAL NOTES FOR LANDSCAPE PLAN

- 1. LANDSCAPE CONTRACTOR SHALL CONFIRM LOCATION OF ALL UNDERGROUND UTILITIES PRIOR TO
- ANY EXCAVATION AND SHALL BE RESPONSIBLE FOR THE FOLLOWING: 2. DAMAGES TO SUCH UTILITIES CAUSED AS A RESULT OF THE CONTRACTOR'S ACTIVITIES.
- 3. DAMAGES TO EXISTING WALKS, WALLS, DRIVES, CURBS, ETC.
- INSPECTING THE SITE IN ORDER TO BE FULLY AWARE OF EXISTING CONDITIONS PRIOR TO SUBMITTING A BID.

 INSTALLATION OF ALL LANDSCAPE AND IRRIGATION MATERIALS SHALL COMPLY WITH SECTIONS 424, 425, 757, AND 795 OF THE MAG STANDARD SPECIFICATIONS.
 CONTRACTOR SHALL REPAIR ANY DAMAGE MADE TO THE EXISTING SPRINKLER SYSTEM TO THE

SATISFACTION OF THE CITY AT NO ADDITIONAL COST TO THE CITY.

 LANDSCAPE REMOVAL IS A NON-PAY ITEM UNLESS OTHERWISE NOTED.
 ALL EXISTING VEGETATION, WEEDS, DEBRIS, ETC. NOTED TO BE REMOVED ON THE PLANS AND SPECIFICATIONS SHALL BE REMOVED FROM PROJECT AREA AND DISPOSED OF PROPERLY OFF THE SITE AT THE CONTRACTOR'S EXPENSE (SCARIFY EXISTING SUBGRADE, MINIMUM SIX (6) INCHES DEPTH).

6. DAMAGE TO TURF SHALL BE REPAIRED BY CONTRACTOR, I.E., RUTS FILLED WITH CLEAN SOIL, COMPACTED TO MATCH SURROUNDING GRADES, EXCESS SOIL, ROCK, ETC. SHALL BE REMOVED TO LEAVE THE SITE CLEAN.

7. ALL PLANT MATERIAL, OTHER THAN TREES, SHALL CONFORM TO GRADING, TYPE, ETC. AS SET FORTH IN THE <u>AMERICAN STANDARD FOR NURSERY STOCK</u> BY THE AMERICAN ASSOCIATION OF NURSERYMEN. ALL TREES SHALL CONFORM TO THE CURRENT <u>ARIZONA NURSERY ASSOCIATION TREE</u> <u>SPECIFICATIONS</u> AND MAG SPEC 795.7. SHOULD ANY CONFLICTS IN THE SPECIFICATIONS OCCUR, THE ARIZONA NURSERY ASSOCIATION'S SPECIFICATIONS SHALL PREVAIL.

 CITY RESERVES THE RIGHT TO INSPECT SHRUBS AND CONTAINERED TREES FOR CONDITION OF ROOT BALLS. FOR ANY SUCH INSPECTIONS WHICH MAY DESTROY ROOTBALL, CONTRACTOR SHALL SUPPLY ADDITIONAL PLANT AT NO COST TO CITY.
 PLANT PITS SHALL BE INSPECTED BY CITY PRIOR TO PLANTING BY THE CONTRACTOR BY

REQUESTING AN INSPECTION 48 HOURS IN ADVANCE. 10. ROUGH AND FINE GRADING TO ESTABLISH UNIFORM SMOOTH GRADE IS INCLUDED IN THIS PROJECT.

11. SOIL TEST FOR FERTILITY AND ADDITIVE RECOMMENDATIONS (FOR TURF AND ORNAMENTALS) SHALL BE COMPLETED BY CONTRACTOR TO DETERMINE IF ADDITIVES ARE REQUIRED. CONTRACTOR SHALL PROVIDE COPY OF SOIL TEST RESULTS FOR REVIEW AND APPROVAL TO ENGINEERING INSPECTOR AT LEAST SEVEN (7) DAYS PRIOR TO ANTICIPATED PLANTING. AFTER APPROVAL BY THE CITY, THE CONTRACTOR SHALL PROVIDE AND INCORPORATE ANY ADDITIVES REQUIRED PRIOR TO OR AT TIME OF PLANTING.

 PLANT PIT SOIL MIXTURE SHALL CONSIST OF FOUR AND ONE-HALF PARTS NATURAL FERTILE, FRIABLE SOIL AND ONE PART HUMUS BY VOLUME, THOROUGHLY MIXED PRIOR TO BACKFILLING IN PITS. BACKFILLING SHALL BE IN 6" LIFTS WITH EACH LIFT WATER SETTLED WITHOUT PUDDLING.
 CONTRACTOR SHALL STAKE TREE AND SHRUB LOCATIONS FOR 5-GALLON PLANTS AND LARGER. STAKES SHALL BE MARKED WITH PLANT NAME OR PLANT LEGEND ITEM NUMBER FROM PLANS.
 ALL EXISTING (GAS, ELECTRIC, WATER, ETC.) COVERS AND BOXES SHALL REMAIN UNCOVERED. CONTRACTOR TO ADJUST TO FINAL GRADE AS NECESSARY. NON-PAY ITEM (NPI) UNLESS OTHERWISE NOTED.

15. THE CONTRACTOR SHALL BE RESPONSIBLE FOR LOCATING THE UNDERGROUND SPRINKLER SYSTEMS IN ADVANCE OF CONSTRUCTION. THE SPRINKLER SYSTEM LOCATIONS NOTED ON PLANS ARE FOR REFERENCE ONLY.

16. CONTRACTOR TO VERIFY DEPTH OF ALL INLET STRUCTURES AND SPRINKLER SYSTEMS PRIOR TO TRENCHING FOR LOW-FLOW CHANNEL.

 17. CONTRACTOR TO PROVIDE PUMPING WITHIN FIVE (5) DAYS AFTER THE NOTICE TO PROCEED IS GIVEN AS REQUIRED TO DRY THE AREA SUFFICIENTLY TO BEGIN CONSTRUCTION.
 18. CONTRACTOR SHALL ARRANGE FOR SPRINKLER SYSTEM SHUTDOWN DURING CONSTRUCTION BY

CONTACTING THE ENGINEERING INSPECTOR. 19. NO ROCKS LARGER THAN 1" IN DIAMETER SHALL BE ALLOWED IN THE TOP SIX (6) INCHES OF

TOPSOIL WHERE TURF ESTABLISHMENT IS SPECIFIED. ROCK REMOVAL AS NECESSARY IS A NON-PAY (NPI) ITEM UNLESS OTHERWISE NOTED.

20. WHERE CALICHE IS ENCOUNTERED IN PLANT PITS, DEPTH AND WIDTH OF PIT SHALL BE INCREASED BY ONE-THIRD (1/3) OVER SPECIFICATION, AND A LIQUID PENETRATOR, "AL-KALICHE" OR EQUAL, SHALL BE INCORPORATED FOR EACH PIT PER MANUFACTURER'S RECOMMENDATIONS.

21. CONTRACTOR SHALL INSTALL DECOMPOSED GRANITE TO A ROLLED DEPTH PER THE APPROVED PLANS AND SPECIFICATIONS. DECOMPOSED GRANITE SHALL BE PER THE APPROVED PLANS AND SPECIFICATIONS WITH THE COLOR AS SPECIFIED ON THE PLANS. PRE-EMERGENT HERBICIDE SHALL BE APPLIED BEFORE AND AFTER PLACEMENT OF DECOMPOSED GRANITE PER THE MANUFACTURER'S RECOMMENDATIONS. PRE-EMERGENT HERBICIDE SHALL BE SURFLAN, DACTHAL, OR APPROVED EQUAL. SAMPLE TO BE PROVIDED FOR CITY REVIEW AND APPROVAL. CONTRACTOR SHALL WASH OFF ROCK MULCH ONCE FINAL PLACEMENT HAS OCCURRED.

22. RESTORE ALL EXISTING LANDSCAPE IRRIGATION SYSTEMS, COMPONENTS AND LANDSCAPE AREAS IMPACTED BY ANY WORK UNDER THIS CONTRACT. RESTORE ALL EXISTING IRRIGATION AND LANDSCAPE IN ACCORDANCE WITH THE LANDSCAPE RESTORATION NOTES INDICATED WITHIN THESE DOCUMENTS, AT A MINIMUM, ALL RESTORATION SHALL BE IN ACCORDANCE WITH M.A.G.

SPECIFICATION 107.9 - PROTECTION AND RESTORATION OF PROPERTY AND LANDSCAPE. ALL RESTORATION WORK SHALL BE COMPLETED TO THE SATISFACTION OF THE CITY OF MESA ENGINEER.

 ALL RESTORATION WORK SHALL BE COMPLETED IN ACCORDANCE WITH THE REFERENCED DETAILS AND ANY ADDITIONAL DETAILS PROVIDED.
 REFER TO LANDSCAPE PLANTING SHEETS AND ENGINEERING DRAWINGS FOR ADDITIONAL


RESTORATION NOTES AND REQUIRED COORDINATION.

		TREE LEGEN	D	
Code	Botanical Name	Cultivar	Common Name	Size
AC SM 24	Acacia smallii		Sweet Acacia	24" BOX
AC SM 36	Acacia smallii		Sweet Acacia	36" BOX
CA CA 15	Caesalpinia cacalaco	'Smoothie'	Thornless Cascalote	15 GAL.
CA CA 24	Caesalpinia cacalaco	'Smoothie'	Thornless Cascalote	24" BOX
CE ME 15	Cercis mexicana		Mexican Redbud	15 GAL.
CE ME 24	Cercis mexicana		Mexican Redbud	24" BOX
CH LI 24	Chilopsis Linearis		Desert Willow	24" BOX
CH LI 36	Chilopsis Linearis		Desert Willow	36" BOX
EU TO 24	Eucalyptus torquata		Coral Gum	24" BOX
EU TO 36	Eucalyptus torquata		Coral Gum	36" BOX
PA MI 24	Parkinsonia microphylla		Foothill Palo Verde	24" BOX
PI PU	Pinus cembroides		Mexican Pinon Pine	15 GAL.

SHRUB LEGEND				
Code	Botanical Name	Cultivar	Common Name	Size
ch me 1	Chrysactinia mexicana		Damianita Daisy	1 Gal
	Chrysactinia mexicana		Darmanita Daisy	
ch me 5	Chrysactinia mexicana Chrysactinia mexicana		Damianita Daisy	5 Gal.
en fa 1	Encelia farinosa		Brittlebush	1 Gal
en fa 5	Encelia farinosa		Brittlebush	5 Gal.
eu ri 1	euphorbia rigida		Gopher Plant	1 Gal
eu ri 5	euphorbia rigida		Gopher Plant	5 Gal.
ha pa 1	Hamelia patens	'Sierra Red'	Fire Bush	1 Gal
ha pa 5	Hamelia patens	'Sierra Red'	Fire Bush	5 Gal.
ju sp 1	Justicia spicigera		Mexican Honeysuckle	1 Gal
ju sp 5	Justicia spicigera		Mexican Honeysuckle	5 Gal.
pe pa 1	Penstemon parryi		Parry's Penstemon	1 Gal
pe pa 5	Penstemon parryi		Parry's Penstemon	5 Gal.
te st 1	Tecoma stans	'Gold Star'	Yellow Bells	1 Gal
te st 5	Tecoma stans	'Gold Star'	Yellow Bells	5 Gal.
ve ri 1	verbena rigida		Sandpaper Verbena	1 Gal
ve ri 5	verbena rigida		Sandpaper Verbena	5 Gal.

NOTE: NUMBER IN PLANT CODE INDICATED PLANT SIZE, NOT QUANTITY.



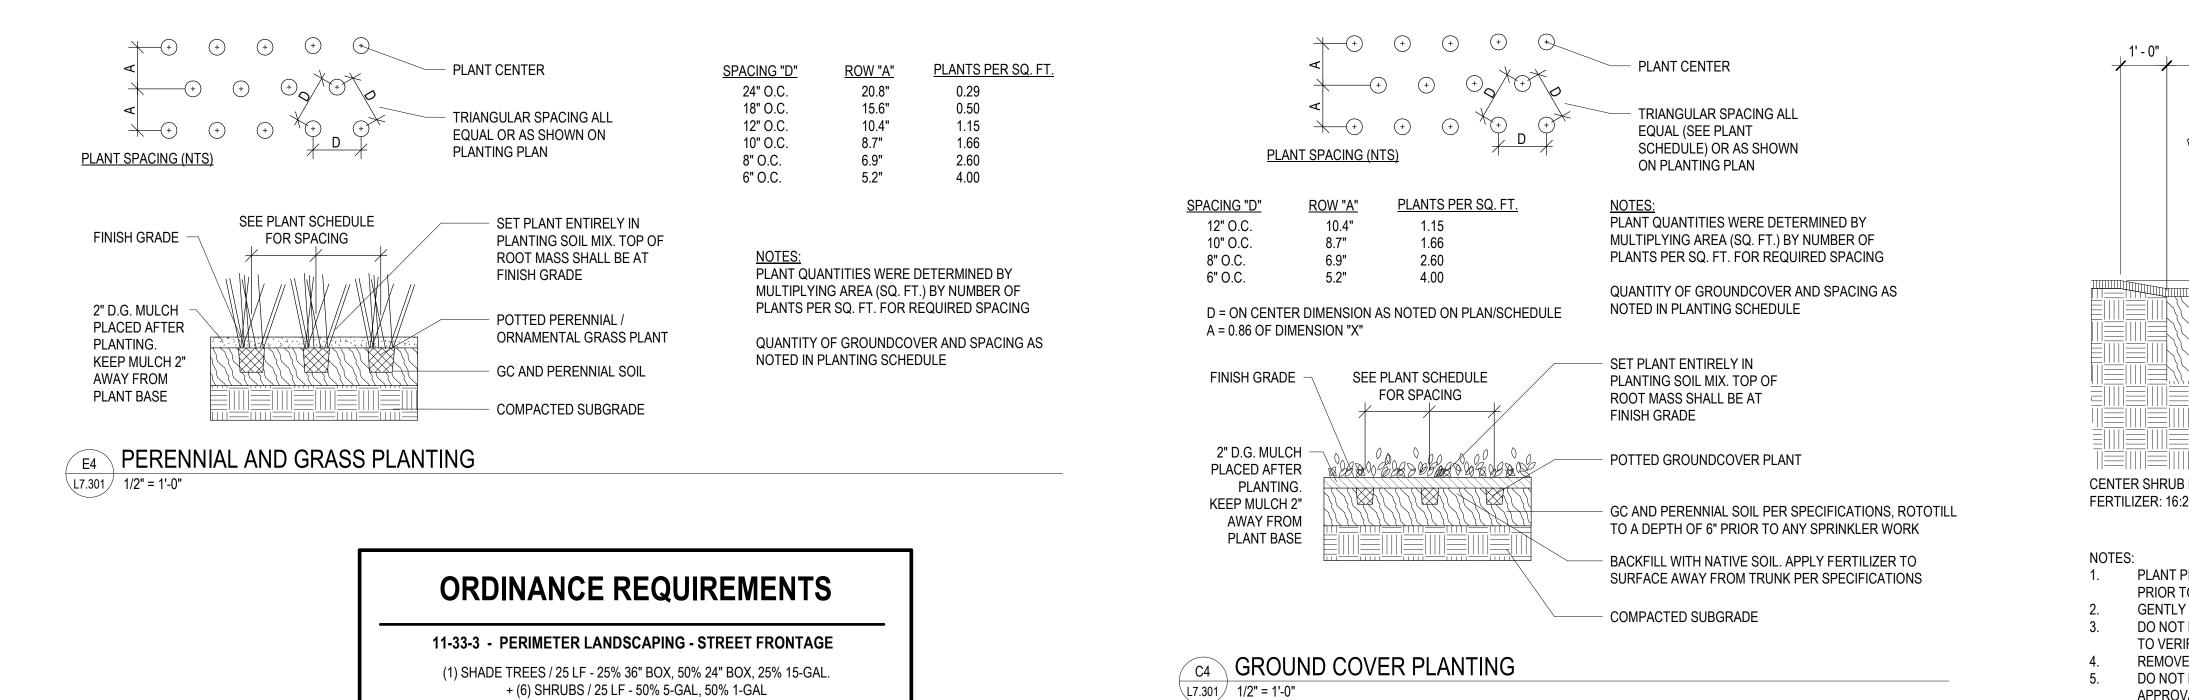

(1) SHADE TREES	ETER LANDSCAPING - ST S / 25 LF - 25% 36" BOX, 50% 24 HRUBS / 25 LF - 50% 5-GAL, 50	" BOX, 25% 15-GAL.
STREET FRONTAGE 1077'	REQUIRED TREES 44	REQUIRED SHRUBS 259
	PROPOSED TREES (11) 36" BOX (22) 24" BOX (11) 15-GAL.	PROPOSED SHRUBS (129) 5-GAL. (130) 1-GAL.
11-33-3 - PI	ERIMETER LANDSCAPING	- SIDE YARD
()	IS TREES / 100 LF - 100% 15-G F WHEN VISIBLE FROM PARKI	
FRONTAGE - EAST 1080'	REQUIRED TREES 33	REQUIRED SHRUBS 0 - NOT VISIBLE FROM ROAD
	PROPOSED TREES (33) 15-GAL.	PROPOSED SHRUBS (0) 1-GAL.
FRONTAGE - SOUTH 2482'	REQUIRED TREES 75	REQUIRED SHRUBS 60 - ASSUMES 300' VISIBLE FROM ROAL
	PROPOSED TREES (75) 15-GAL.	PROPOSED SHRUBS (60) 1-GAL.
FRONTAGE - NORTH 2482'	REQUIRED TREES 75	REQUIRED SHRUBS 60 - ASSUMES 300' VISIBLE FROM ROAI
	PROPOSED TREES (75) 15-GAL.	PROPOSED SHRUBS (60) 1-GAL.
(1) SHADE 1	ITERIOR PARKING LOT LA TREES / ISLAND - 10% 36" BOX IRUBS / ISLAND - 50% 5-GAL, 5	, 90% 24" BOX
PARKING ISLANDS 73	REQUIRED TREES 73	REQUIRED SHRUBS 219
	PROPOSED TREES (8) 36" BOX (65) 24" BOX	PROPOSED SHRUBS (108) 1-GAL. (111) 5-GAL.
(1) SHADE TREES / 50	5 - FOUNDATION LANDSO 0 LF OF EXTERIOR WALL - 10% 5 FOR 33% OF WALL LENGTH -	6 36" BOX, 90% 24" BOX
BUILDING LENGTH 1144'	REQUIRED TREES 23	REQUIRED SHRUBS 127 ASSUMES 3' PER SHRUB = 380 LF
	PROPOSED TREES (16) IN ADJACENT PARKING ISLANDS (7) 24" BOX	PROPOSED SHRUBS (48) IN ADJACENT PARKING ISLANDS (79) 1-GAL.
34 FT BASE = 27 FT BASE =	& WEST FOUNDATION BASE 572 LF FRONTAGE EACH 48LF = 8.4% OF FRONTAGE X 54LF = 9.4% OF FRONTAGE X 70LF = 82.2% OF FRONTAGE X	34FT = 2.86 FT 27LF = 2.54 FT

PLANT SCHEDULE

TREES							
Type Mark	Count	Botanical Name	Cultivar	Common Name	Method	Size	Landscape Comments
AC SM 24	16	Acacia smallii		Sweet Acacia	Container	24" BOX	
AC SM 36	4	Acacia smallii		Sweet Acacia	Container	36" BOX	
CA CA 15	6	Caesalpinia cacalaco	'Smoothie'	Thornless Cascalote	Container	15 GAL.	
CA CA 24	26	Caesalpinia cacalaco	'Smoothie'	Thornless Cascalote	Container	24" BOX	
CE ME 15	5	Cercis mexicana		Mexican Redbud	Container	15 GAL.	
CE ME 24	16	Cercis mexicana		Mexican Redbud	Container	24" BOX	
CH LI 24	21	Chilopsis Linearis		Desert Willow	Container	24" BOX	
CH LI 36	4	Chilopsis Linearis		Desert Willow	Container	36" BOX	
EU TO 24	13	Eucalyptus torquata		Coral Gum	Container	24" BOX	
EU TO 36	10	Eucalyptus torquata		Coral Gum	Container	36" BOX	
PA MI 24	16	Parkinsonia microphylla		Foothill Palo Verde	Container	24" BOX	
PI PU	183	Pinus cembroides		Mexican Pinon Pine	Container	15 GAL.	NON-DECIDUOUS

SHRUBS							
Code	Count	Botanical Name	Cultivar	Common Name	Method	Size	Landscape Comments
ch me 1	79	Chrysactinia mexicana Chrysactinia mexicana		Damianita Daisy	Container	1 Gal	
ch me 5	52	Chrysactinia mexicana Chrysactinia mexicana		Damianita Daisy	Container	5 Gal.	
en fa 1	46	Encelia farinosa		Brittlebush	Container	1 Gal	
en fa 5	33	Encelia farinosa		Brittlebush	Container	5 Gal.	
eu ri 1	66	euphorbia rigida		Gopher Plant	Container	1 Gal	
eu ri 5	21	euphorbia rigida		Gopher Plant	Container	5 Gal.	
ha pa 1	18	Hamelia patens	'Sierra Red'	Fire Bush	Container	1 Gal	
ha pa 5	49	Hamelia patens	'Sierra Red'	Fire Bush	Container	5 Gal.	
ju sp 1	15	Justicia spicigera		Mexican Honeysuckle	Container	1 Gal	
ju sp 5	18	Justicia spicigera		Mexican Honeysuckle	Container	5 Gal.	
pe pa 1	74	Penstemon parryi		Parry's Penstemon	Container	1 Gal	
pe pa 5	42	Penstemon parryi		Parry's Penstemon	Container	5 Gal.	
te st 1	24	Tecoma stans	'Gold Star'	Yellow Bells	Container	1 Gal	
te st 5	5	Tecoma stans	'Gold Star'	Yellow Bells	Container	5 Gal.	
ve ri 1	118	verbena rigida		Sandpaper Verbena	Container	1 Gal	
ve ri 5	43	verbena rigida		Sandpaper Verbena	Container	5 Gal.	

NOTE: NUMBER IN PLANT CODE INDICATED PLANT SIZE, NOT QUANTITY.

PLANTING NOTES

1. CONTRACTOR IS RESPONSIBLE FOR ALL RELATED EXISTING CONDITIONS, PIPES AND STRUCTURES, ETC. PRIOR TO BIDDING AND CONSTRUCTION.

- 2. REF. SPECIFICATIONS AND DETAILS FOR PLANTING METHODS, REQUIREMENTS, SOIL TESTING, MATERIALS, EXECUTION AND PLAN PROTECTION.
- 3. PLANT NAMES MAY BE ABBREVIATED ON DRAWINGS. REFER TO PLANTING SCHEDULE AND LEGENDS FOR SYMBOLS, ABBREVIATIONS, BOTANICAL AND COMMON NAMES, SIZES, ESTIMATED QUANTITIES AND OTHER REMARKS.

4. WHERE PROVIDED, AREA TAKEOFFS AND PLANT QUANTITY ESTIMATES IN PLANTING SCHEDULE ARE FOR INFORMATION ONLY. CONTRACTOR IS RESPONSIBLE TO DO THEIR OWN QUANTITY TAKEOFFS FOR ALL PLANT MATERIAL AND SIZES SHOWN ON THE DRAWINGS. IN CASE OF DISCREPANCIES TO THE ATTENTION OF THE LANDSCAPE ARCHITECT FOR CLARIFICATION.

5. CONTRACTOR IS RESPONSIBLE TO 'RESTORE' ALL AREAS OF THE SITE, OR ADJACENT AREAS, WHERE DISTURBED TO A CONDITION THAT MEETS OR EXCEEDS THE CONDITIONS PRIOR TO THE DISTURBANCE.

6. ALL PLANTS SHALL BE GUARANTEED FOR ONE FULL YEAR FROM THE SUBSTANTIAL COMPLETION OF THE LANDSCAPE CONTRACT AT FULL REPLACEMENT VALUE INCLUDING LABOR TO REPLACE PLANT MATERIALS. 7. ALL PLANT MATERIAL SHALL BE OF SPECIMEN QUALITY AND OF THE SIZE AND TYPE SPECIFIED IN THE PLANT SCHEDULE.

8. THE SITE SHALL BE FINISH GRADED BY THE LANDSCAPE CONTRACTOR. THE LANDSCAPE CONTRACTOR SHALL BE RESPONSIBLE TO MAINTAIN FINISHED GRADES AND RE-GRADE ANY AREAS DISTURBED BY LANDSCAPE OPERATIONS.


9. ANY CLEAN, EXCESS SOIL FROM LANDSCAPE OPERATIONS SHALL BE WASTED ON SITE AT THE DISCRETION OF THE CONTRACTOR OR DISPOSED OF OFF SITE. ALL CONSTRUCTION DEBRIS FROM LANDSCAPE OPERATIONS SHALL BE DISPOSED OF OFF SITE.

- 10. ALL PLANTING AREAS MUST BE FREE OF ALL WEEDS AND DEBRIS BEFORE PLANTING, SODDING, AND/OR SEEDING.
- 11. ALL LANDSCAPE MATERIALS INSTALLED SHALL BE MAINTAINED BY OWNER OR LEASEE IN ACCORDANCE WITH THE APPROVED LANDSCAPE PLAN.
- 12. ALL NON-PAVED AREAS WITHIN SITE BOUNDARIES SHALL BE COVERED IN 1/2" DECOMPOSED GRANITE, AT 2" DEPTH PER ZONING ORDINANCE. A PRE-EMERGENT HERBICIDE SHALL BE APLIED TO THE GROUND PRIOR TO PLACEMENT OF DECOMPOSED GRANITE TO PREVENT WEED GROWTH.
- 13. SIGHT TRIANGLES AT INTERSECTIONS TO BE KEPT CLEAR OF TREES AND TALL SHRUBS.
- 14. NO SHRUBS WITH A MATURE HEIGHT OF 3' OR GREATER TO BE INSTALLED WITHIN 10' OF CURB ON R.O.W.
- 15. ALL TREES SHALL COMPLY WITH LATEST AMENDED EDITION OF THE A.N.A. RECOMMENDED TREE SPECIFICATIONS. 16. SEE CIVIL FOR SIGNAGE

<u>PLANT</u>	ING NOTE
1.	SIDES C
2.	EXCAVA
3.	THE WI
4.	GENTLY
5.	CENTER
6.	INSPEC
7.	REMOV
8.	NEW TR
9.	FORM S
10.	REMOV

AKIN	<u>G NOTES:</u>
	USE 2-2"
	DRIVE ST
	PLACE S
	HEIGHT (
	PLACE T
	HALFWA
	ALWAYS

<u>MISC.</u>	NOTES:
1.	REMOVE
	TREES A
2.	BACKFILI
	NOT D.G.
3.	SWALE S
4.	SWALE S
5.	PROVIDE
	REQUIRE
^	

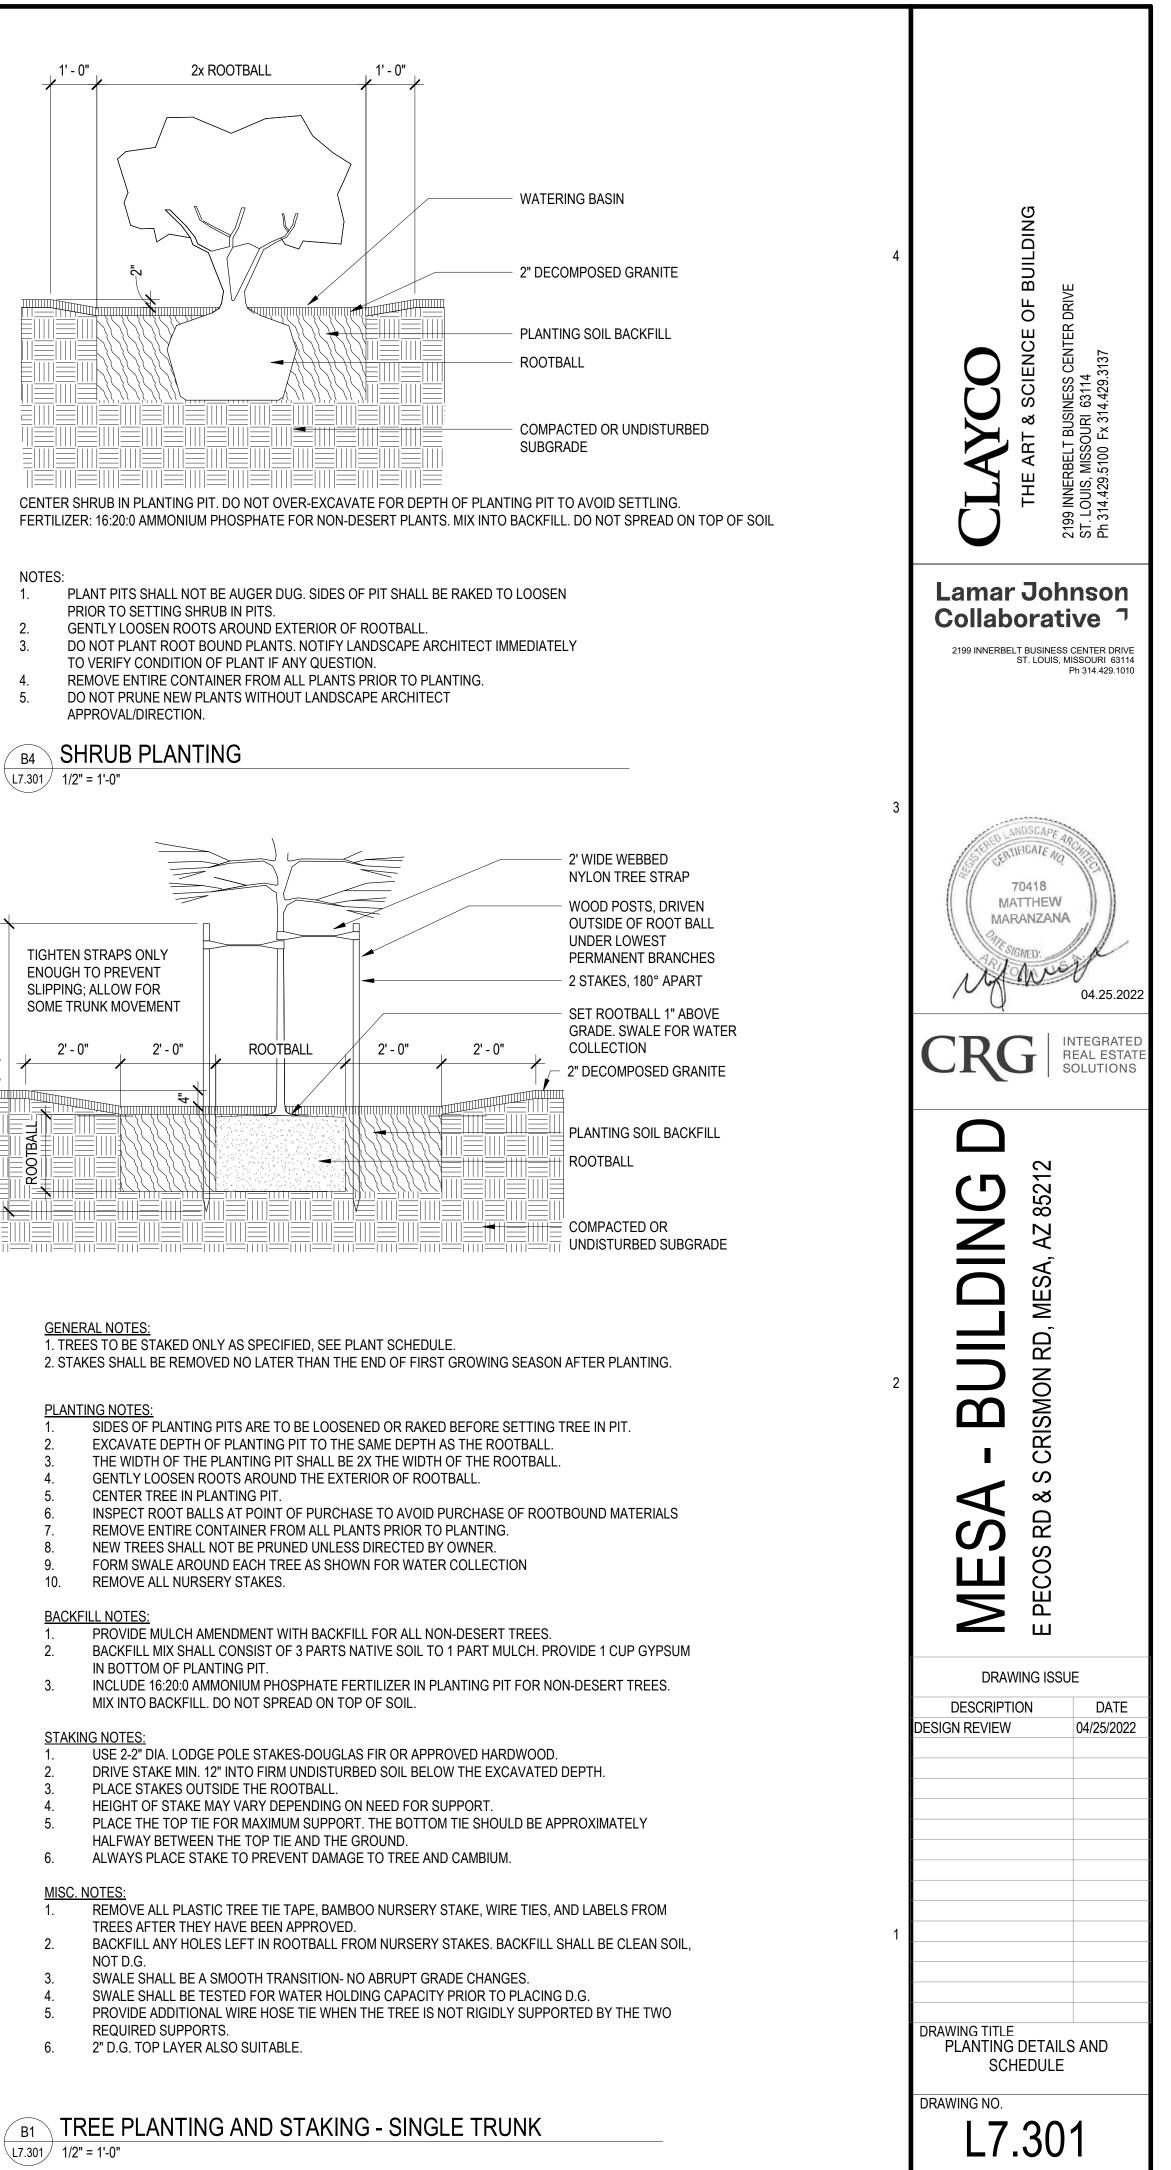

С

Α