


## OUTDOOR STRENGTH STATION SCALE: N.T.S.

#### DETAIL NOTES

- 1. VERTICAL REINFORCING ("V") PER SCHEDULE 2. 8" CMU FENCE WALL - SOLID GROUT, W / STONE
- 3. PORTION OF WALL BELOW GRADE
- 4. #9 GAGE HORIZONTAL LADDER REINFORCING AT 16" O.C.
- VERTICALLY
- 5. DOWELS MATCH VERTICAL REINFORCING AND LAP PER THE G.SN.
- 6. PAVERS OVER SAND BED
- 7. FINISHED GRADE
- 8. CONCRETE FOOTING PER SCHEDULE
- 9. #4 CONTINUOUS HORZ. AT 12" O.C.
- 10. ALTERNATE BENDS 11. (1) #4 CONTINUOUS IN 8" DEEP GROUTED
- BOND BEAM.

DETAIL SCHEDULE				
MAX, WALL HEIGHT ("H")	VERTICAL REINFORC. ("Y")	FOOTING WIDTH("W")	FOOTING THICKNESS ("T")	
4'-0"	#4 AT 48"O.C.	1'-4"	0'-10"	
6'-0"	#5 AT 48"O.C.	1'-10"	0'-10"	

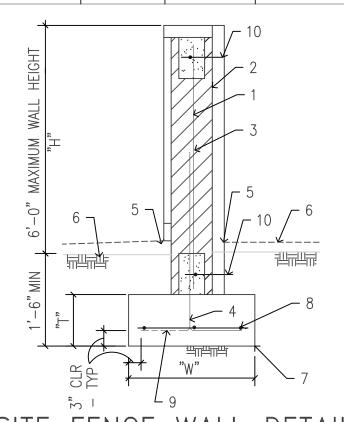

SITE FENCE WALL DETAIL

# ----N89°58'00"W (C&R) 20'-0**"** APARTMENTS

HOLMES AVENUE

SITE PLAN

SCALE: 1"=20"

= 24 SPACES

= 25 SPACES

= 5 SPACES

94'-0" W. PROY'D

= 3 SPACES

= 4,800 SF

= 5,000 SF

1 SPACE

1 SPACE



# PROJECT DATA

OWNER:	RWI PROPERTIES, INC.	
PROJECT ADDRESS:	455 W. HOLMES AVE	
PARCEL NUMBER:	134-22-211A	
LOT *:	3	
ZONING: L	C (RE-ZONE TO RM-4 PAD)	
GROSS SITE AREA:	.713 ACRES (33,665 S.F.)	
CONSTRUCTION TYPE:	TYPE V-B	
BUILDING SF AREA:	10,048 SF	
BUILDING FOOTPRINT AREA:	5,024 SF	
BUILDING LOT COVERAGE:	14.92% (55% ALLOWED)	
REQUIRED BUILDING SETBACKS:  FRONT: SIDES: REAR: 25'- 22'- 23'-		
BUILDING HEIGHT REQUIREMENTS:  ALLOWABLE:  PROVIDED:  30'-6 31'-1		

REQUIRED LANDSCAPE SETBACKS: FRONT: SIDES: REAR:

TYPICAL COVERED PARKING

OCCUPANCY CONTENT: R-4 (RESIDENTIAL)

10'-0"

4'-0"

20'-0"

RWI MULTI-FAMILY COMPLEX: 10,048 SF OCCUPANCY LOAD: 16-STUDIO UNITS = 16 OCCUPANTS 8-1 BR UNITS= 8 OCCUPANTS TOTAL: 24 OCCUPANTS PATIOS/BALCONIES: 12 AT 50 SF/UNIT 8 AT 60 SF/UNIT 4 AT 75 SF/UNIT EXITING REQUIRED: AS PER UNIT

PARKING DATA: PARKING REQUIRED: MULTI-FAMILY: RESIDENTIAL - 24 UNITS @1 SPACE/UNIT: ACCESSIBLE SPACE:

PARKING PROVIDED: REGULAR RESIDENT SPACES (COVERED): GUEST SPACES (COVERED): ACCESSIBLE SPACE (COVERED):

PARKING PER SECTION 11-5-5 OF MZO: (FRONTAGE CALCULATION) BICYCLE PARKING: OPEN SPACE REQUIRED: RESIDENTIAL - 24 UNITS @ 200 SF/UNIT:

RESIDENTIAL - 24 UNITS @ 208 SF/UNIT:

OPEN SPACE PROVIDED:

CALL TWO WORKING DAYS BEFORE YOU DIG


### SITE PLAN NOTES

- DEVELOPMENT AND USE OF THIS SITE WILL CONFORM WITH ALL
- APPLICABLE CODES AND ORDINANCES." "THIS PROJECT IS LOCATED IN THE CITY OF MESA WATER SERVICE AREA
- AND HAS BEEN DESIGNATED AS HAVING AN ASSURED WATER SUPPLY." "ALL NEW OR RELOCATED UTILITIES WILL BE PLACED UNDERGROUND." "ALL SIGNAGE REQUIRES SEPARATE APPROVALS AND PERMITS."

"ANY LIGHTING WILL BE PLACED SO AS TO DIRECT LIGHT AWAY FROM

- THE ADJACENT RESIDENTIAL DISTRICTS AND WILL NOT EXCEED ONE FOOT CANDLE AT THE PROPERTY LINE. NO NOISE, ODOR OR VIBRATION WILL BE EMITTED SO THAT IT EXCEEDS THE GENERAL LEVEL OF NOISE, ODOR OR VIBRATION EMITTED BY USES OUTSIDE OF THE SITE."
- "OWNERS OF PROPERTY ADJACENT TO PUBLIC RIGHT-OF-WAY WILL HAVE THE RESPONSIBILITY FOR MAINTAINING ALL LANDSCAPING WITHIN THE RIGHTS-OF-WAY IN ACCORDANCE WITH APPROVED PLANS."
- PRETENTION IS REQUIRED, 50% DRAIN TO STREET.

#### VICINITY MAP

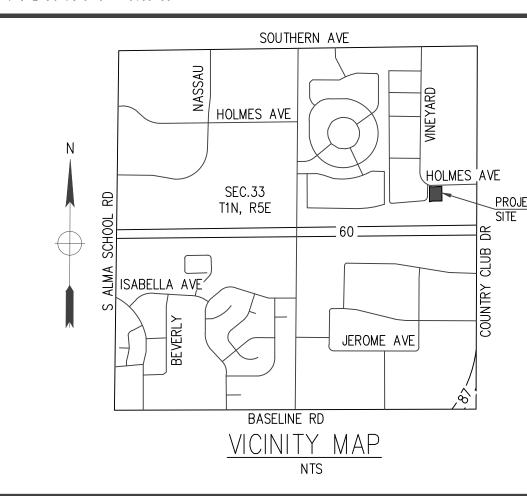

# KEY NOTES


- PROPERTY LINE.
- 2) LINE OF BUILDING SETBACK.
- ACCESSIBLE EXIT TO HAVE 1/2" MINIMUM THRESHOLDS AT DOOR AND LANDING PAD TO ASPHALT PAYING.
- IRRIGATION CONTROL, REFER TO LANDSCAPE, PROVIDE DRIP LINES AS REQUIRED TO PLANTINGS AT ENTRY AND LANDSCAPE ISLANDS, PROVIDE WALL MOUNTED TIMER AT INTERIOR.
- 4" T. CONCRETE SIDEWALK OR EQUIPMENT PAD OVER 4" COMPACTED A.B.C., NATURAL GRAY, WIDTH AS SHOWN. (CONTROL JOINTS @ 5'-0" O.C., EXPANSION JOINTS @ 20'-0" O.C.) (PER ICC AIIT.I, SECTION 403.3, AT SIDEWALKS, ACCESSIBLE ROUTE SLOPE COMPLIANCE OF 5% MAXIMUM RUNNING SLOPES AND A MAXIMUM
- OF 2% FOR CROSS SLOPES). 6) CONCRETE CURBING, REFER TO CIVIL DRAWINGS FOR MORE INFO.
- 5" T. CONCRETE APRON OVER 4" COMPACTED A.B.C., NATURAL GRAY.
- ACCESSIBILITY RAMP PER DETAIL 3/CØ2 (PER ICC AIIT.I, SECTION 4Ø5 FOR AT SIDEWALK RAMPS & SECTION 406 FOR AT CURB RAMPS).
- PROVIDE HORN/STROBE DEVICE, MOUNTED AT THE EXTERIOR OF THE BUILDING SO EASILY RECOGNIZABLE FROM THE STREET FRONTAGE (INCLUDE AS PART OF FIRE ALARM AND SPRINKLER DEFERRED SUBMITTAL PACKAGE.
- TRASH ENCLOSURE WITH GATES AND CONCRETE SLAB, REFER TO ENLARGED DETAILS, TO COMPLY WITH COM SOLID WASTE DETAIL M-62.01 THRU M-62.04.2. ENCLOSURE TO BE COMPATIBLE WITH COLORS AND MATERIALS WITH NEW BUILDING BEING CONSTRUCTED.
- 11) 3" AC OVER 5" ABC, REFER TO CIVIL DRAWINGS FOR MORE INFO.
- 12) 4" WIDE WHITE PAVEMENT MARKINGS, TYP.
- REGULAR PARKING STALL, 9'-0" W. × 20'-0" L., TYP.
- ACCESSIBLE PARKING STALL, 11'-0" W. imes 20'-0" L. WITH 5'-0" W. imes 20'-0" L. ACCESS LOADING ZONE.
- INTERNATIONAL ACCESSIBILITY SYMBOL PAVEMENT MARKING, REFER TO DETAIL
- ACCESSIBLE PARKING SIGN, PER GOVERNING AGENCY REQUIREMENTS. REFER T DETAIL 9/AØ.2.
- HOSE BIB, REFER TO PLUMBING ENGINEERING DRAWINGS FOR MORE INFO.
- ELECTRICAL SES/SWITCH GEAR AND TRANSFORMER LOCATION ON CONCRETE SLAB, REFER TO ELECTRICAL ENGINEERING DRAWINGS FOR MORE INFO.
- WATER METER W/ TAP FROM METER TO MAIN, REFER TO PLUMBING AND CIVIL DRAWINGS FOR MORE INFO.
- (20) OPEN SPACE REQUIREMENTS (BBQ/GAZEBO/ORCHID).
- FIRE DEPARTMENT SIAMESE CONNECTION AND BUILDING MOUNTED DC SIGMA. TH ROUTE FROM THE HYDRANT TO THE DC IS MEASURED AS THE SUPPLY HOSE WOULD BE LAID OUT BY A FIRE APPARATUS ON APPROVED ACCESS DRIVES, (PER IC 912).
- FIRE DEPARTMENT KNOX BOX LOCATION (RECESSED WALL MNTD-TYP OF 2), PROY'D 3FT X 3FT ACCESS/WORK CLEAR SPACE.
- (23) FIRE TRUCK APPARATUS TURNING RADIUS (35 FT INSIDE/55 FT OUTSIDE).
- FIRE LANE MARKED BY CURB PAINTED RED AND LABELED "FIRE LANE NO PARKING" PER REGULATION FIRE LANES.
- (25) FIRE LANE "NO PARKING" SIGN, WALL MOUNT WHEN APPLICABLE.

REFER TO LANDSCAPE DESIGN FOR MORE INFO DIMENSIONS).

- STARTING POINT FOR NEW BUILDING LAYOUT, (SEE FLOOR PLAN, SHEET A2.0 FOR BUILDING AS PER CITY OF APACHE JUNCTION DEVELOPMENT STANDARDS,
- NATIVE LANDSCAPING.
- (28) EXISTING AJWD FIRE HYDRANT DISTANCE 200 FT.
- PARKING LOT LIGHT POLES W/ CONCRETE BASE, PER DETAIL 4/AO.2, REFER TO
- ELECTRICAL ENGINEERING FOR MORE INFO... (30) 6'-0" HIGH-MASONRY SITE FENCE WALL.
- RETENTION LOCATION, REFER TO CIVIL DRAWINGS FOR MORE INFO.
- $^{(32)}$  10'-0" imes 20'-0" SITE VIABILITY TRIANGLES.
- (33) EXST'G SITE SCREEN WALL TO REMAIN, PROY'D NEW PAINT.

SEMI-CANTILEYER COVERED PARKING STRUCTURE W/ LIGHTS AT UNDERSIDE.


- BICYCLE PARKING, 3 SPACES PROVIDED.
  - OUTDOOR STRENGTH AND CONDITIONING EQUIPMENT, 4 STATIONS, BY FITCORE OF EQUAL.

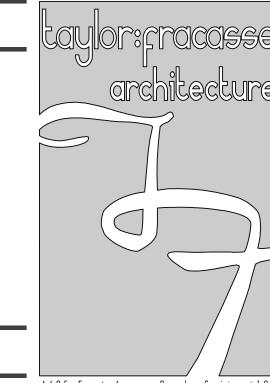

4425 East Agave Road, Suite #120 Phoenix, Arizona 85044 Tel: 480.659.6745 www.taylorfracasse.com

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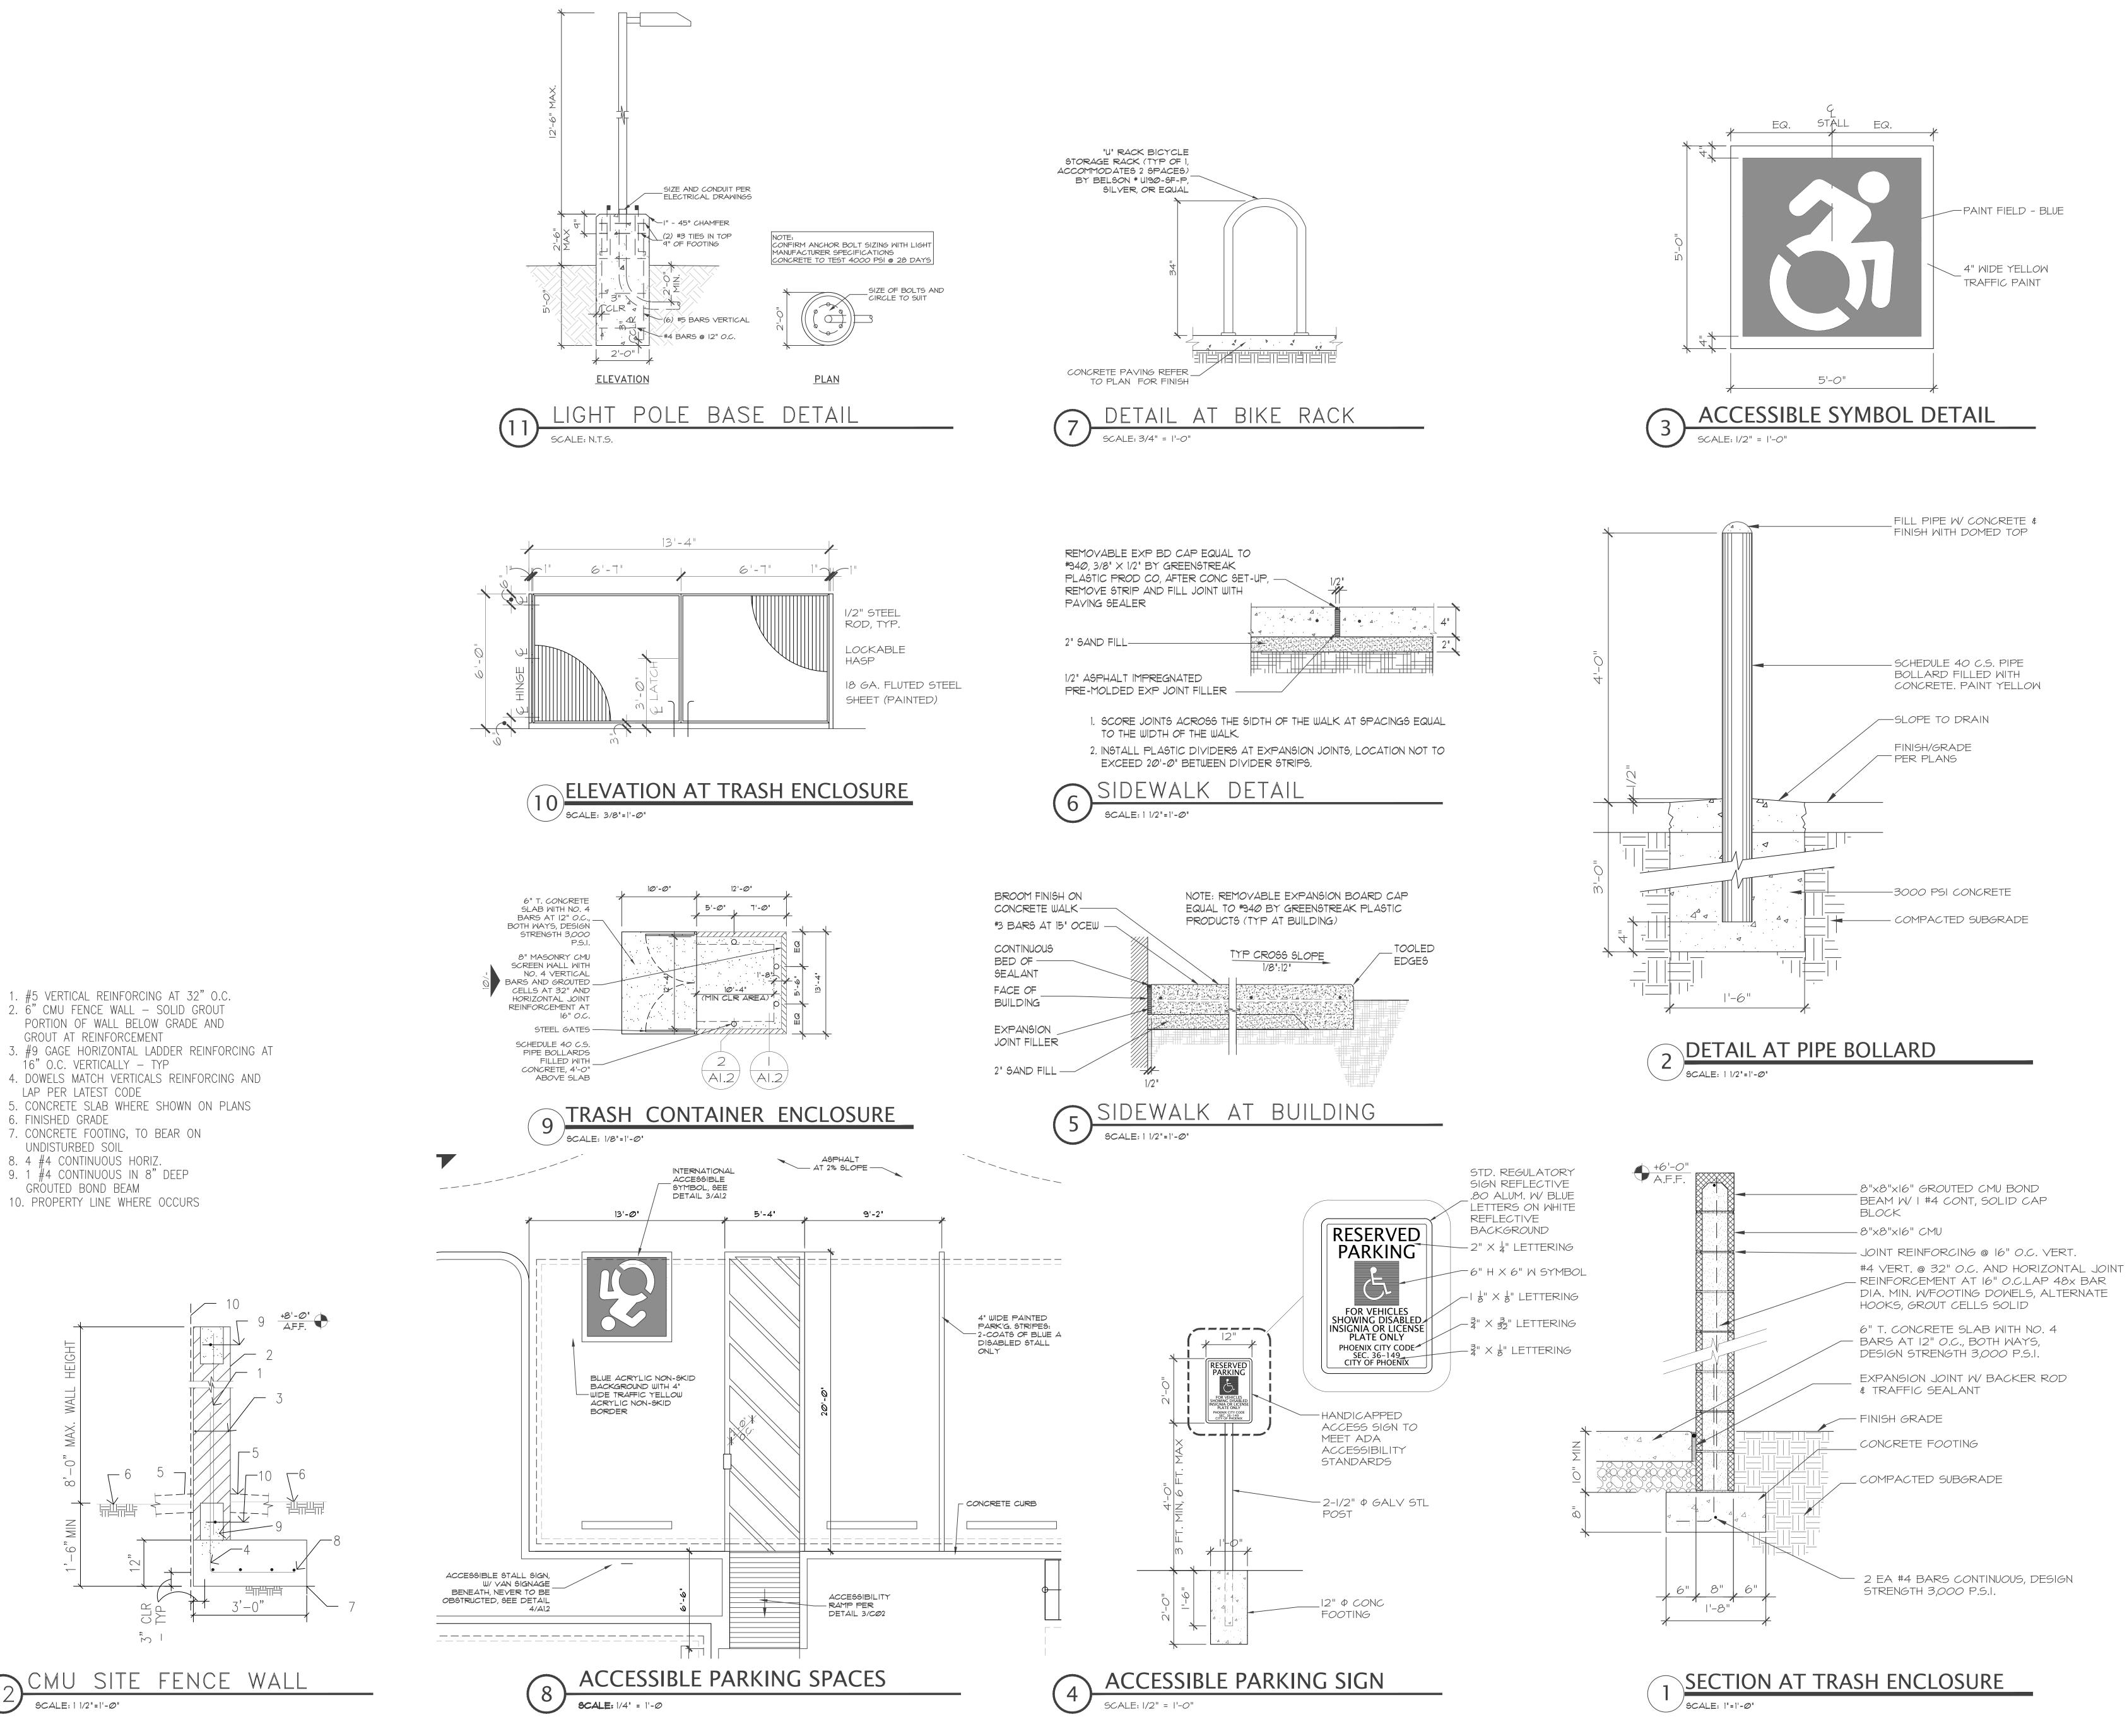
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05.17.22 21-025

JOB NUMBER SCALE AS NOTED DRAWN CHECKED:

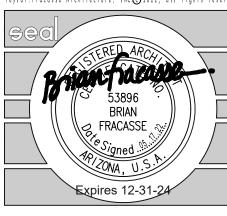TITLE: SITE PLAN

ISSUED FOR REVIEW



LAP PER LATEST CODE

UNDISTURBED SOIL

8. 4 #4 CONTINUOUS HORIZ.

GROUTED BOND BEAM

6. FINISHED GRADE

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ISSUE DATE:	05.17.22
JOB NUMBER:	21-025
SCALE:	AS NOTED
DRAWN:	B F
CHECKED:	B F

TITLE: SITE DETAILS

& ELEVATIONS

ISSUED FOR REVIEW