1. THE CONTRACTOR SHALL PERFORM THE WORK IN ACCORDANCE WITH ALL LAWS, CODE, ORDINANCES, RULES AND REGULATIONS OF ALL GOVERNING AGENCIES. OCCUPANTS ADJACENT TO THE E PROJECT AREA BOUNDARIES SHALL CONTINUE UNINTERRUPTED OCCUPANCY DURING CONSTRUCTION OF THE PROJECT

2. IT IS THE SOLE RESPONSIBILITY OF THE CONTRACTOR TO NOTIFY THE LANDSCAPE ARCHITECT OF ANY AND ALL CONFLICTS WITH WORK RELATED TO THE HARDSCAPE AND LANDSCAPE FEATURES PRIOR TO INSTALLATION OF THE UTILITIES IN ORDER TO MAINTAIN THE HIGHEST LEVEL OF DESIGN INTENT OF THE HARDSCAPE AND LANDSCAPE FEATURES

3. THE CONTRACTOR SHALL PERFORM NO PORTION OF THE WORK AT ANY TIME WITHOUT CONTRACT DOCUMENTS OR, WHERE REQUIRED, APPROVED SHOP DRAWINGS, PRODUCT DATA, OR SAMPLES FOR SUCH PORTIONS OF THE WORK.

4. COORDINATE THE WORK WITH ALL REQUIREMENTS INDICATED IN THE PROJECT DOCUMENTS.

5. THE CONTRACTOR SHALL PROVIDE COMPLETE PROJECT SYSTEMS AND COMPONENTS AND COMPLY WITH ALL REQUIREMENTS INDICATED ON THE PROJECT DOCUMENTS.

6. THE CONTRACTOR SHALL COORDINATE THE WORK WITH EQUIPMENT, FURNISHINGS AND SYSTEMS PRESENT OR PROVIDED BY THE OWNER.

7. VERIFY LOCATIONS OF ALL BUILDINGS, WALLS, EXISTING STRUCTURES, PIPES, ELECTRICAL AND ALL ELEMENTS AFFECTING LANDSCAPE SCOPE OF WORK WITH ARCHITECTURAL AND ENGINEERING DRAWINGS. INFORMATION IN LANDSCAPE ARCHITECTURE PACKAGE IS TO BE READ IN CONJUNCTION WITH ALL RELEVANT ARCHITECTURAL AND ENGINEERING INFORMATION. ADDITIONAL UTILITIES AND SITE ELEMENTS MAY EXIST WHICH ARE NOT SHOWN HEREIN.

8. VERIFY LOCATION OF ALL ADJACENT AND BELOW-GRADE ELECTRICAL, PLUMBING, DATA, CONDUIT, PIPING, DRAINAGE STRUCTURES AND OTHER UTILITY CONNECTIONS WITH THE APPROPRIATE AS-BUILT OR ENGINEERING DRAWINGS. THE CONTRACTOR IS RESPONSIBLE FOR THIS VERIFICATION AND THE PROTECTION OF THESE ELEMENTS. THE CONTRACTOR IS RESPONSIBLE FOR REPAIR OF ANY DAMAGE INCURRED DURING THE EXECUTION OF THE WORK.

9. THE CONTRACTOR SHALL HAVE ALL BELOW-GRADE UTILITY AND SLEEVING WORK INSPECTED AND APPROVED PRIOR TO BEGINNING HARDSCAPE LAYOUT/MARKING/STAKING AND CONSTRUCTION.

10. IT IS THE SOLE RESPONSIBILITY OF THE GENERAL CONTRACTOR AND ANY SUBCONTRACTORS TO COORDINATE SERVICE ROUTING OF ALL UTILITIES INCLUDING BUT NOT LIMITED TO WATER, GAS, TELEPHONE, ELECTRICAL, STORM, SEWER, AND IRRIGATION WITH THE OWNER AND TO AVOID CONFLICTS WITH HARDSCAPE AND LANDSCAPE FEATURES. ALL CONSTRUCTION MUST COMPLY WITH THE PROJECT SPECIFICATIONS AND NOT INTERFERE WITH BUILDING ELEMENTS TO BE PRESERVED.

11. ALL MATERIAL SHALL BE NEW, UNUSED AND TO THE HIGHEST QUALITY IN EVERY RESPECT UNLESS OTHERWISE NOTED.

12. PERFORM THE WORK AT THE PROJECT SITE DURING HOURS SPECIFIED BY THE OWNER.

13. ANY DAMAGE INCURRED DURING THE EXECUTION OF CONSTRUCTION TO EXISTING TREES OR STRUCTURES IS THE SOLE RESPONSIBILITY OF THE CONTRACTOR.

14. THE CONTRACTOR WILL BE RESPONSIBLE FOR CLEANING ALL WALLS, PAVEMENTS, AND OTHER SURFACES PRIOR TO FINAL INSPECTION.

15. REFERENCE TO SCALE IS FOR FULL-SIZE DRAWINGS. DIMENSIONS SHOWN ON DRAWINGS TAKE PRECEDENCE OVER SCALED DIMENSIONS. DO NOT SCALE FROM

16. THE CONTRACTOR IS RESPONSIBLE FOR ACCURATE HORIZONTAL AND VERTICAL ALIGNMENT AND PREPARATION OF LAYOUT/MARKING/STAKING. THE CONTRACTOR IS REQUIRED TO PERFORM CONSTRUCTION LAYOUT/MARKING/STAKING AND SET ELEVATIONS FOR THE FORM WORK PRIOR TO INSPECTION BY THE ARCHITECT FOR APPROVAL.

17. ALL BUILDINGS, WALLS, COLUMNS, STRUCTURES, AND ANY VERTICAL ELEMENTS THAT ABUT CONCRETE PAVING ARE TO HAVE EXPANSION JOINT AS DETAILED HEREWITH.

18. ALL FORM WORK SHALL BE APPROVED FOR GEOMETRY AND GRADES BY THE ARCHITECT PRIOR TO INSTALLATION OF PAVEMENT, PLANTERS OR WALLS.

19. ALL ANGLES TO BE 90 DEGREES AND ALL LINES OF PAVING TO BE PARALLEL UNLESS OTHERWISE NOTED. MAINTAIN HORIZONTAL ALIGNMENT OF ADJACENT ELEMENTS AS NOTED ON THE DRAWINGS.

20. "TYPICAL" OR "TYP" INDICATES IDENTICAL COMPLETE SYSTEM SHALL BE PROVIDED FOR EACH OCCURRENCE OF THE CONDITION NOTES.

21. "SIMILAR" OR "SIM" INDICATES COMPLETE SYSTEM AND COMPONENTS SHALL BE PROVIDED COMPARABLE TO THE CHARACTERISTICS FOR THE CONDITION NOTED.

22. "AS REQUIRED" INDICATES COMPONENTS REQUIRED TO COMPLETE THE E NOTED SYSTEM AS INDICATED IN THE PROJECT DOCUMENTS SHALL BE PROVIDED.

23. "ALIGN" INDICATES ACCURATELY PROVIDE FINISH OF FACES OF MATERIALS IN STRAIGHT, TRUE, AND PLUMB RELATION TO ADJACENT MATERIALS.

24. TAKE ALL DIMENSIONS FROM FACE OF FIXED OBJECTS, WALL, OR BUILDING OR TO CENTERLINE OF COLUMNS UNLESS OTHERWISE NOTED. ALL DIMENSIONS CALLED OUT AS "EQUAL" ARE EQUIDISTANT MEASUREMENTS TO DESIGNATED CENTERLINE(S).

25. ALL LANDSCAPE DIMENSIONS TAKEN TO CENTERLINE OF BUILDING COLUMN SHALL MEAN THE FIRST ROW OF COLUMNS CLOSEST TO THE FACE OF THE BUILDING. SEE ARCHITECTURAL AND AS-BUILT DRAWINGS FOR CORRESPONDING COLUMN LINES.

26. TAKE ALL DIMENSIONS PERPENDICULAR TO ANY REFERENCE LINE, WORK LIKE, FACE OF BUILDING, FACE OF WALL, OR CENTERLINE.

27. WHERE NOT SHOWN ON LANDSCAPE DRAWINGS, SEE ENGINEERING AND AS-BUILT DRAWINGS FOR COLUMN GRID, CENTERLINES, BUILDING FACES, AND BENCHMARKS.

28. SEE DRAWINGS FOR DIMENSION OF SITE ELEMENTS. NOTES AND DETAILS ON SPECIFIC DRAWINGS TAKE PRECEDENCE OVER GENERAL NOTES AND TYPICAL DETAILS.

29. IF DIMENSIONS VARY BY 1" OR MORE, CONTACT THE ARCHITECT FOR REVIEW AND CONFIRMATION PRIOR TO PROCEEDING WITH CONSTRUCTION.

30. FINISH ELEVATIONS ARE INDICATED TO THE FACE OF PAVEMENT OR FINISHED GRADE OF SOIL AS APPLICABLE, UNLESS OTHERWISE NOTED.

L1.000

GENERAL SITE NOTES

Lamar Johnson Collaborative 7

ST. LOUIS, MISSOURI 63114 Ph 314.429.1010



DRAWING ISSUE

DESCRIPTION

03.21.2022 DESIGN REVIEW 1st REVIEW COMMENTS 04/22/2022

DATE

DRAWING TITLE
SITE REFERENCE PLAN


DRAWING NO.


L1.000 1" = 80'-0"

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SITE REFERENCE PLAN

Job# 20.005838



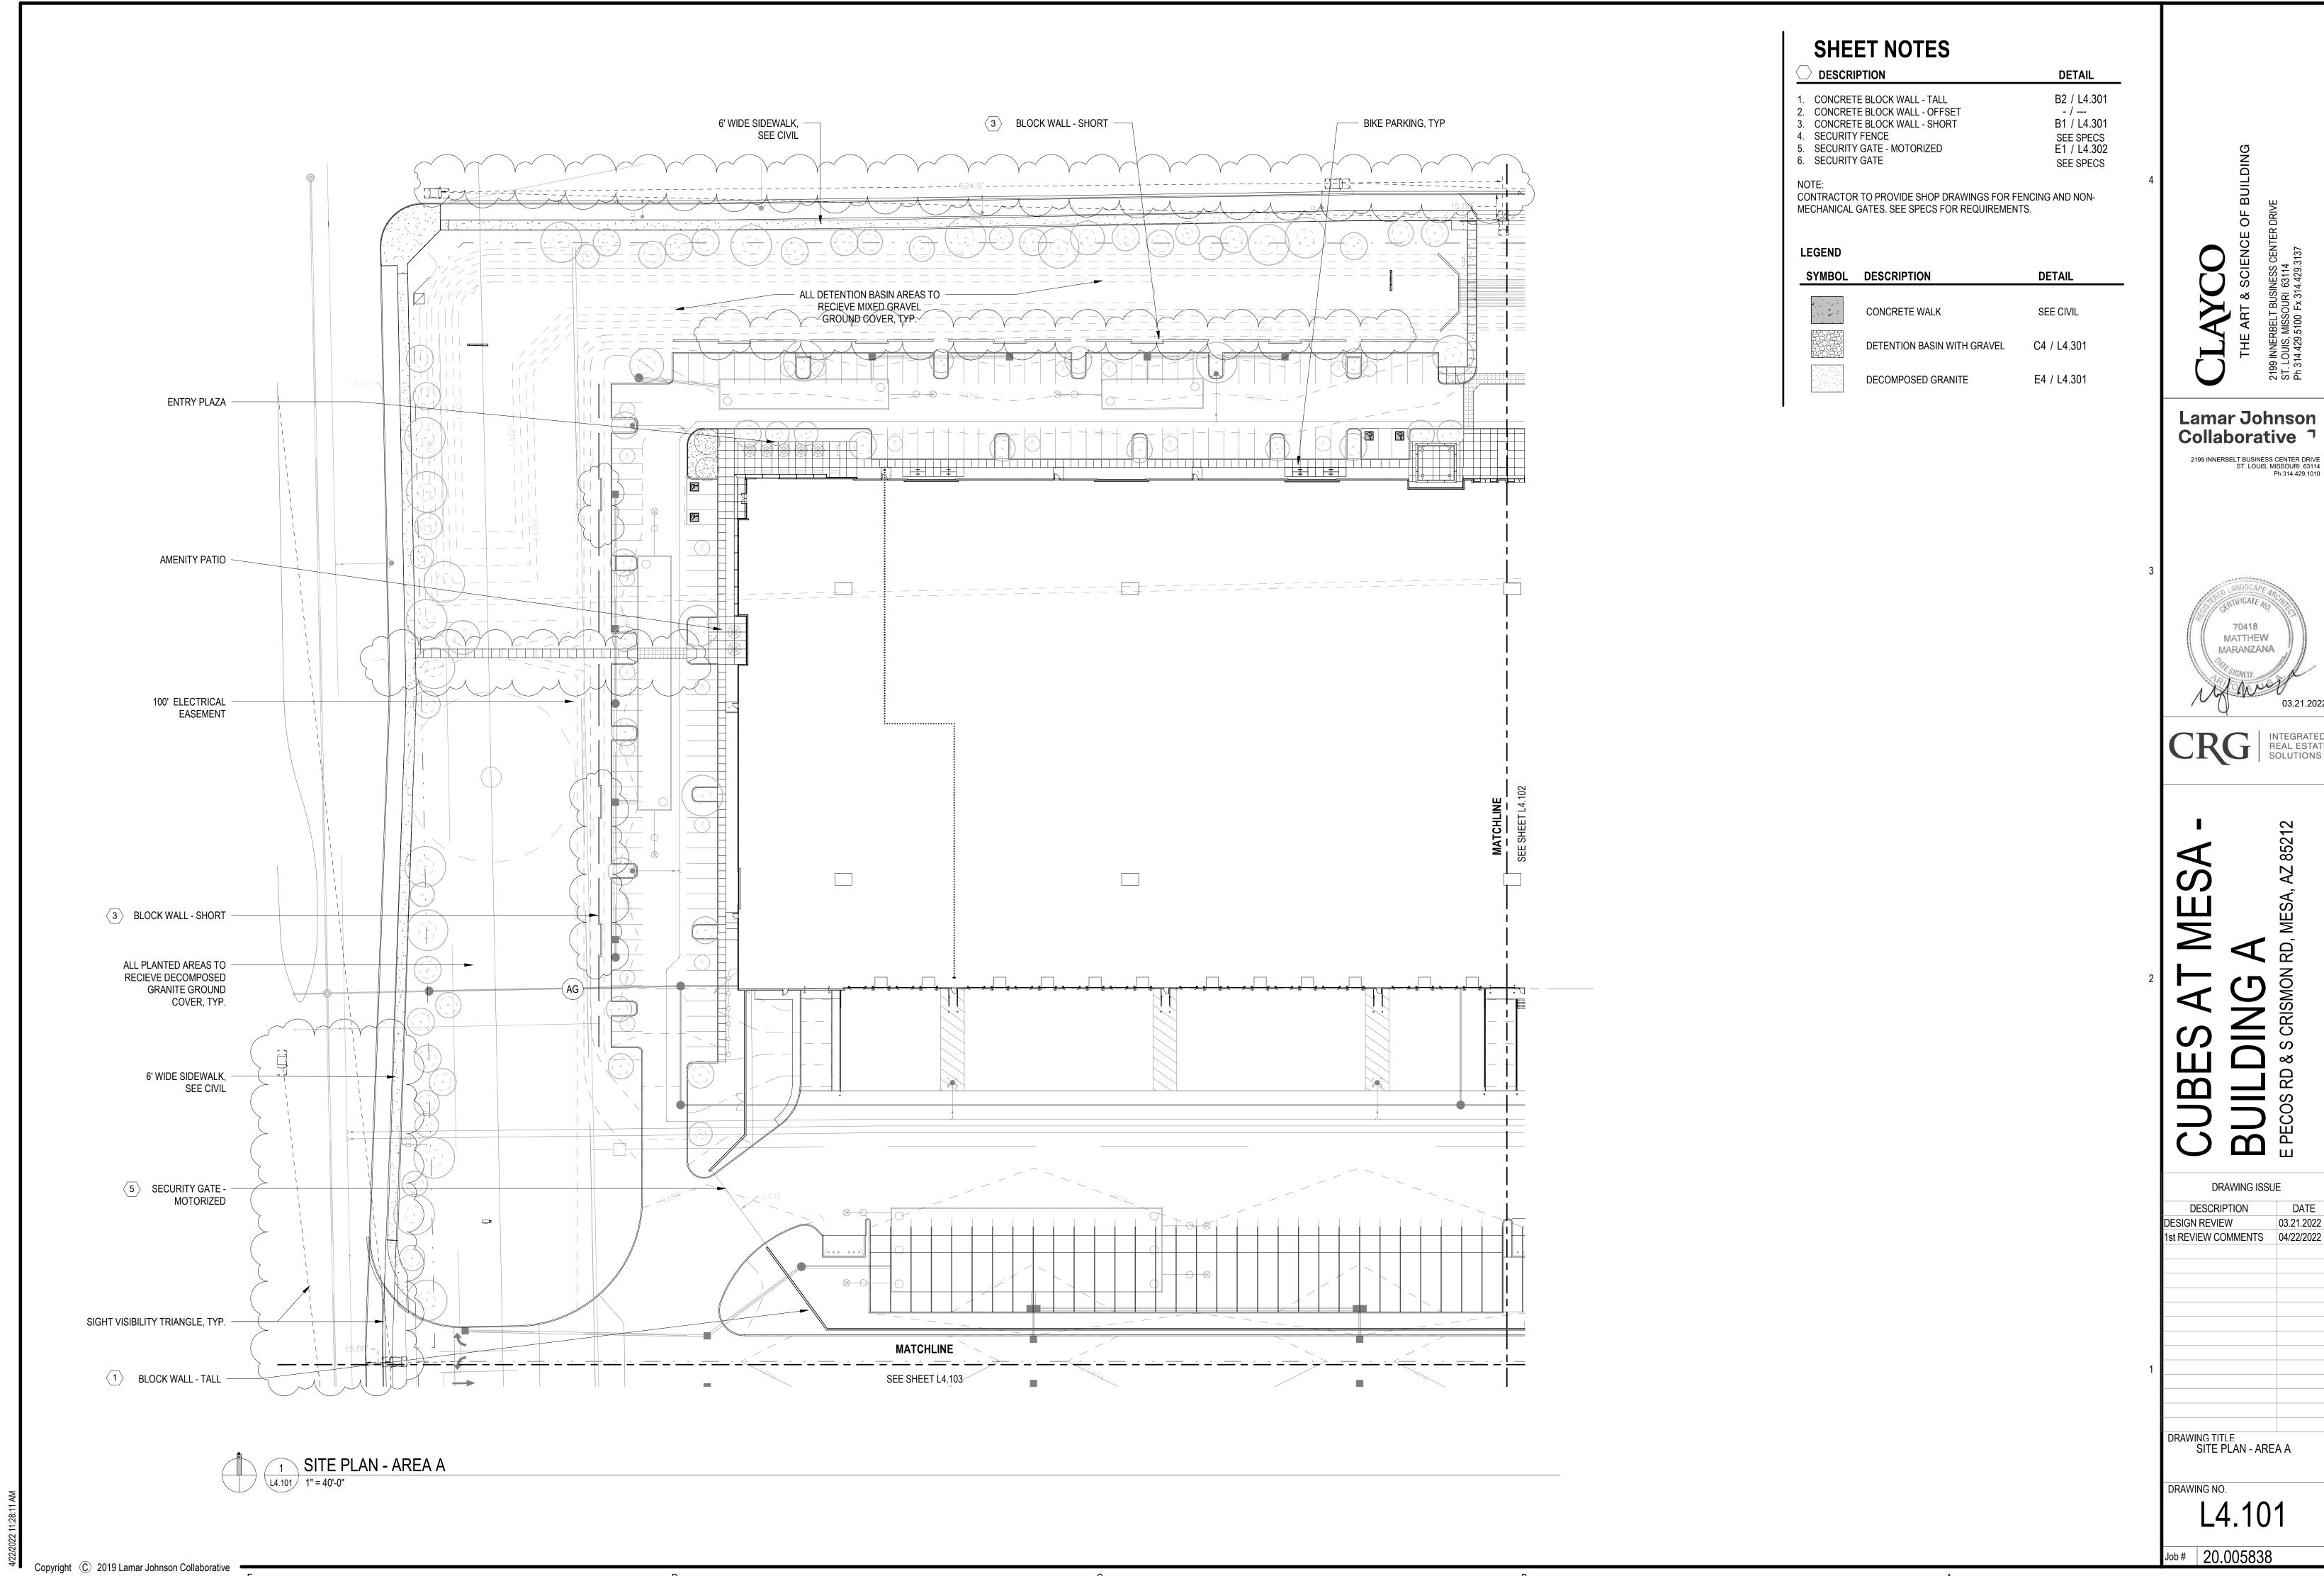

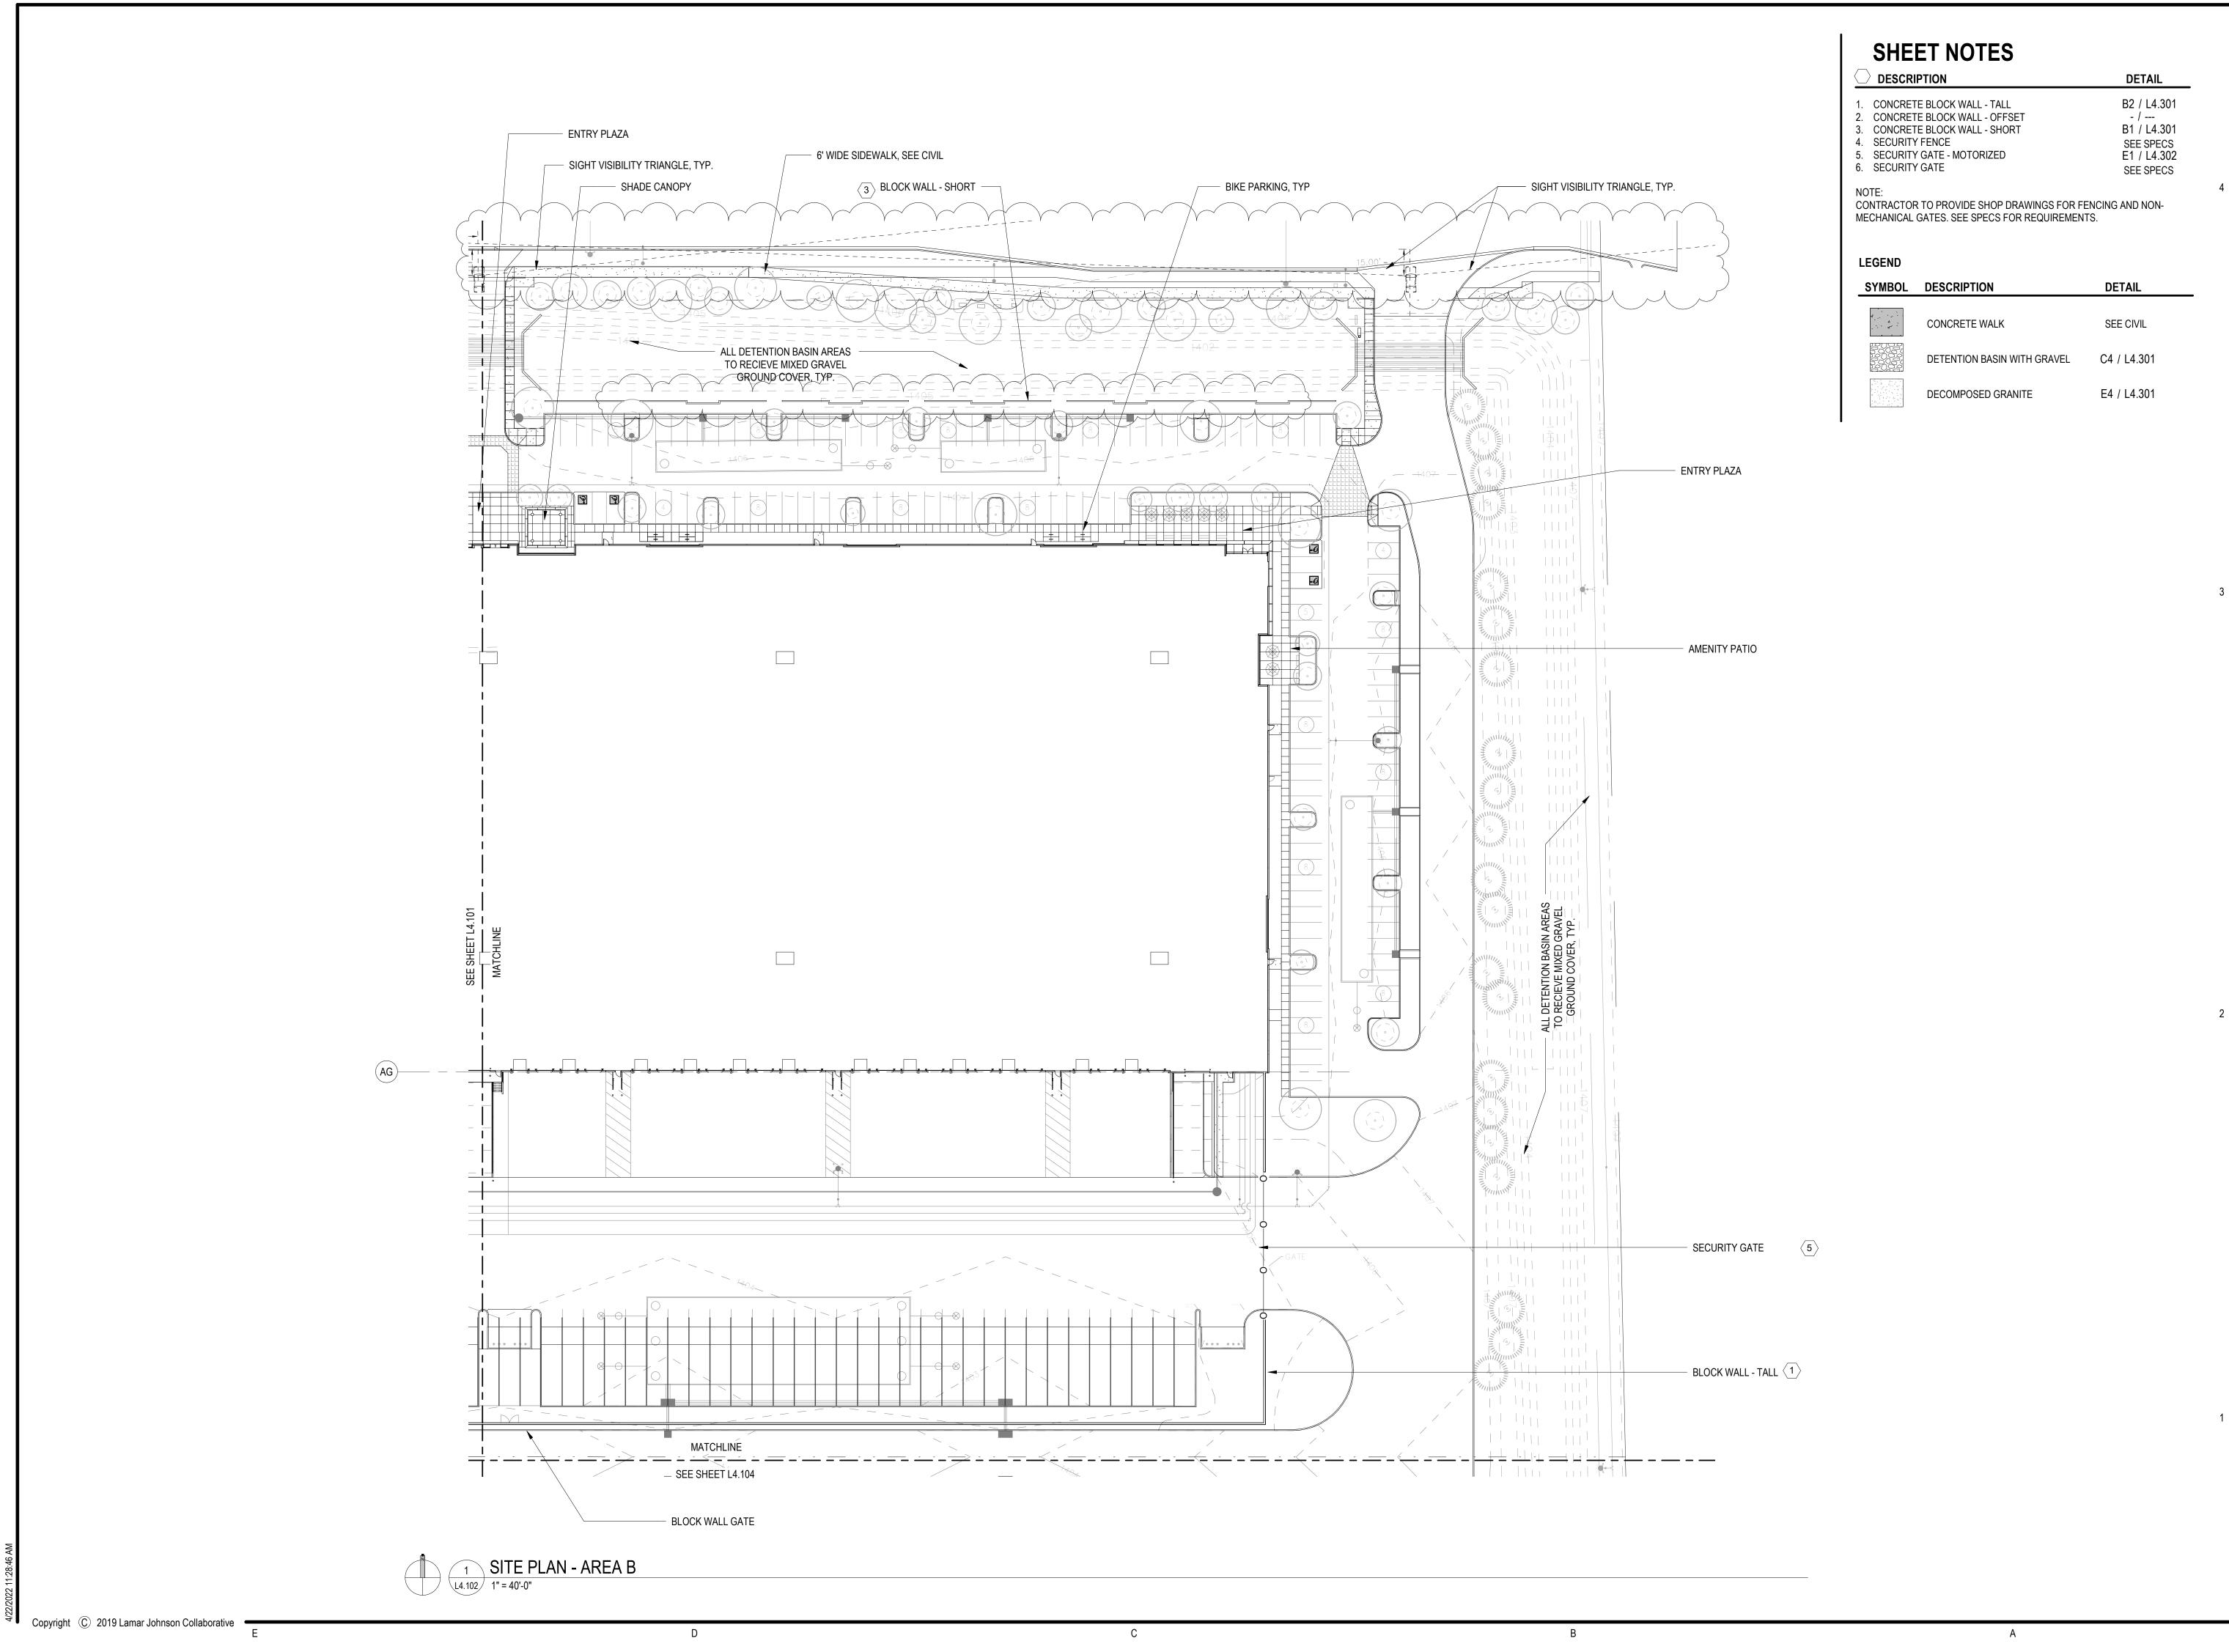Lamar Johnson

Collaborative 7

2199 INNERBELT BUSINESS CENTER DRIVE
ST. LOUIS, MISSOURI 63114
Ph 314.429.1010

SEREO LANOSCAPE ARCHITECTURE NO.



CRG

INTEGR REAL E SOLUTI

SMON RD, MESA, AZ 85212

BUILDING A
E PECOS RD & S CRISMON RD, ME

DRAWING ISSUE

DESCRIPTION DATE


DESIGN REVIEW 03.21.2022

1st REVIEW COMMENTS 04/22/2022

DRAWING TITLE SITE PLAN - AREA B

L4.102

Job# 20.005838

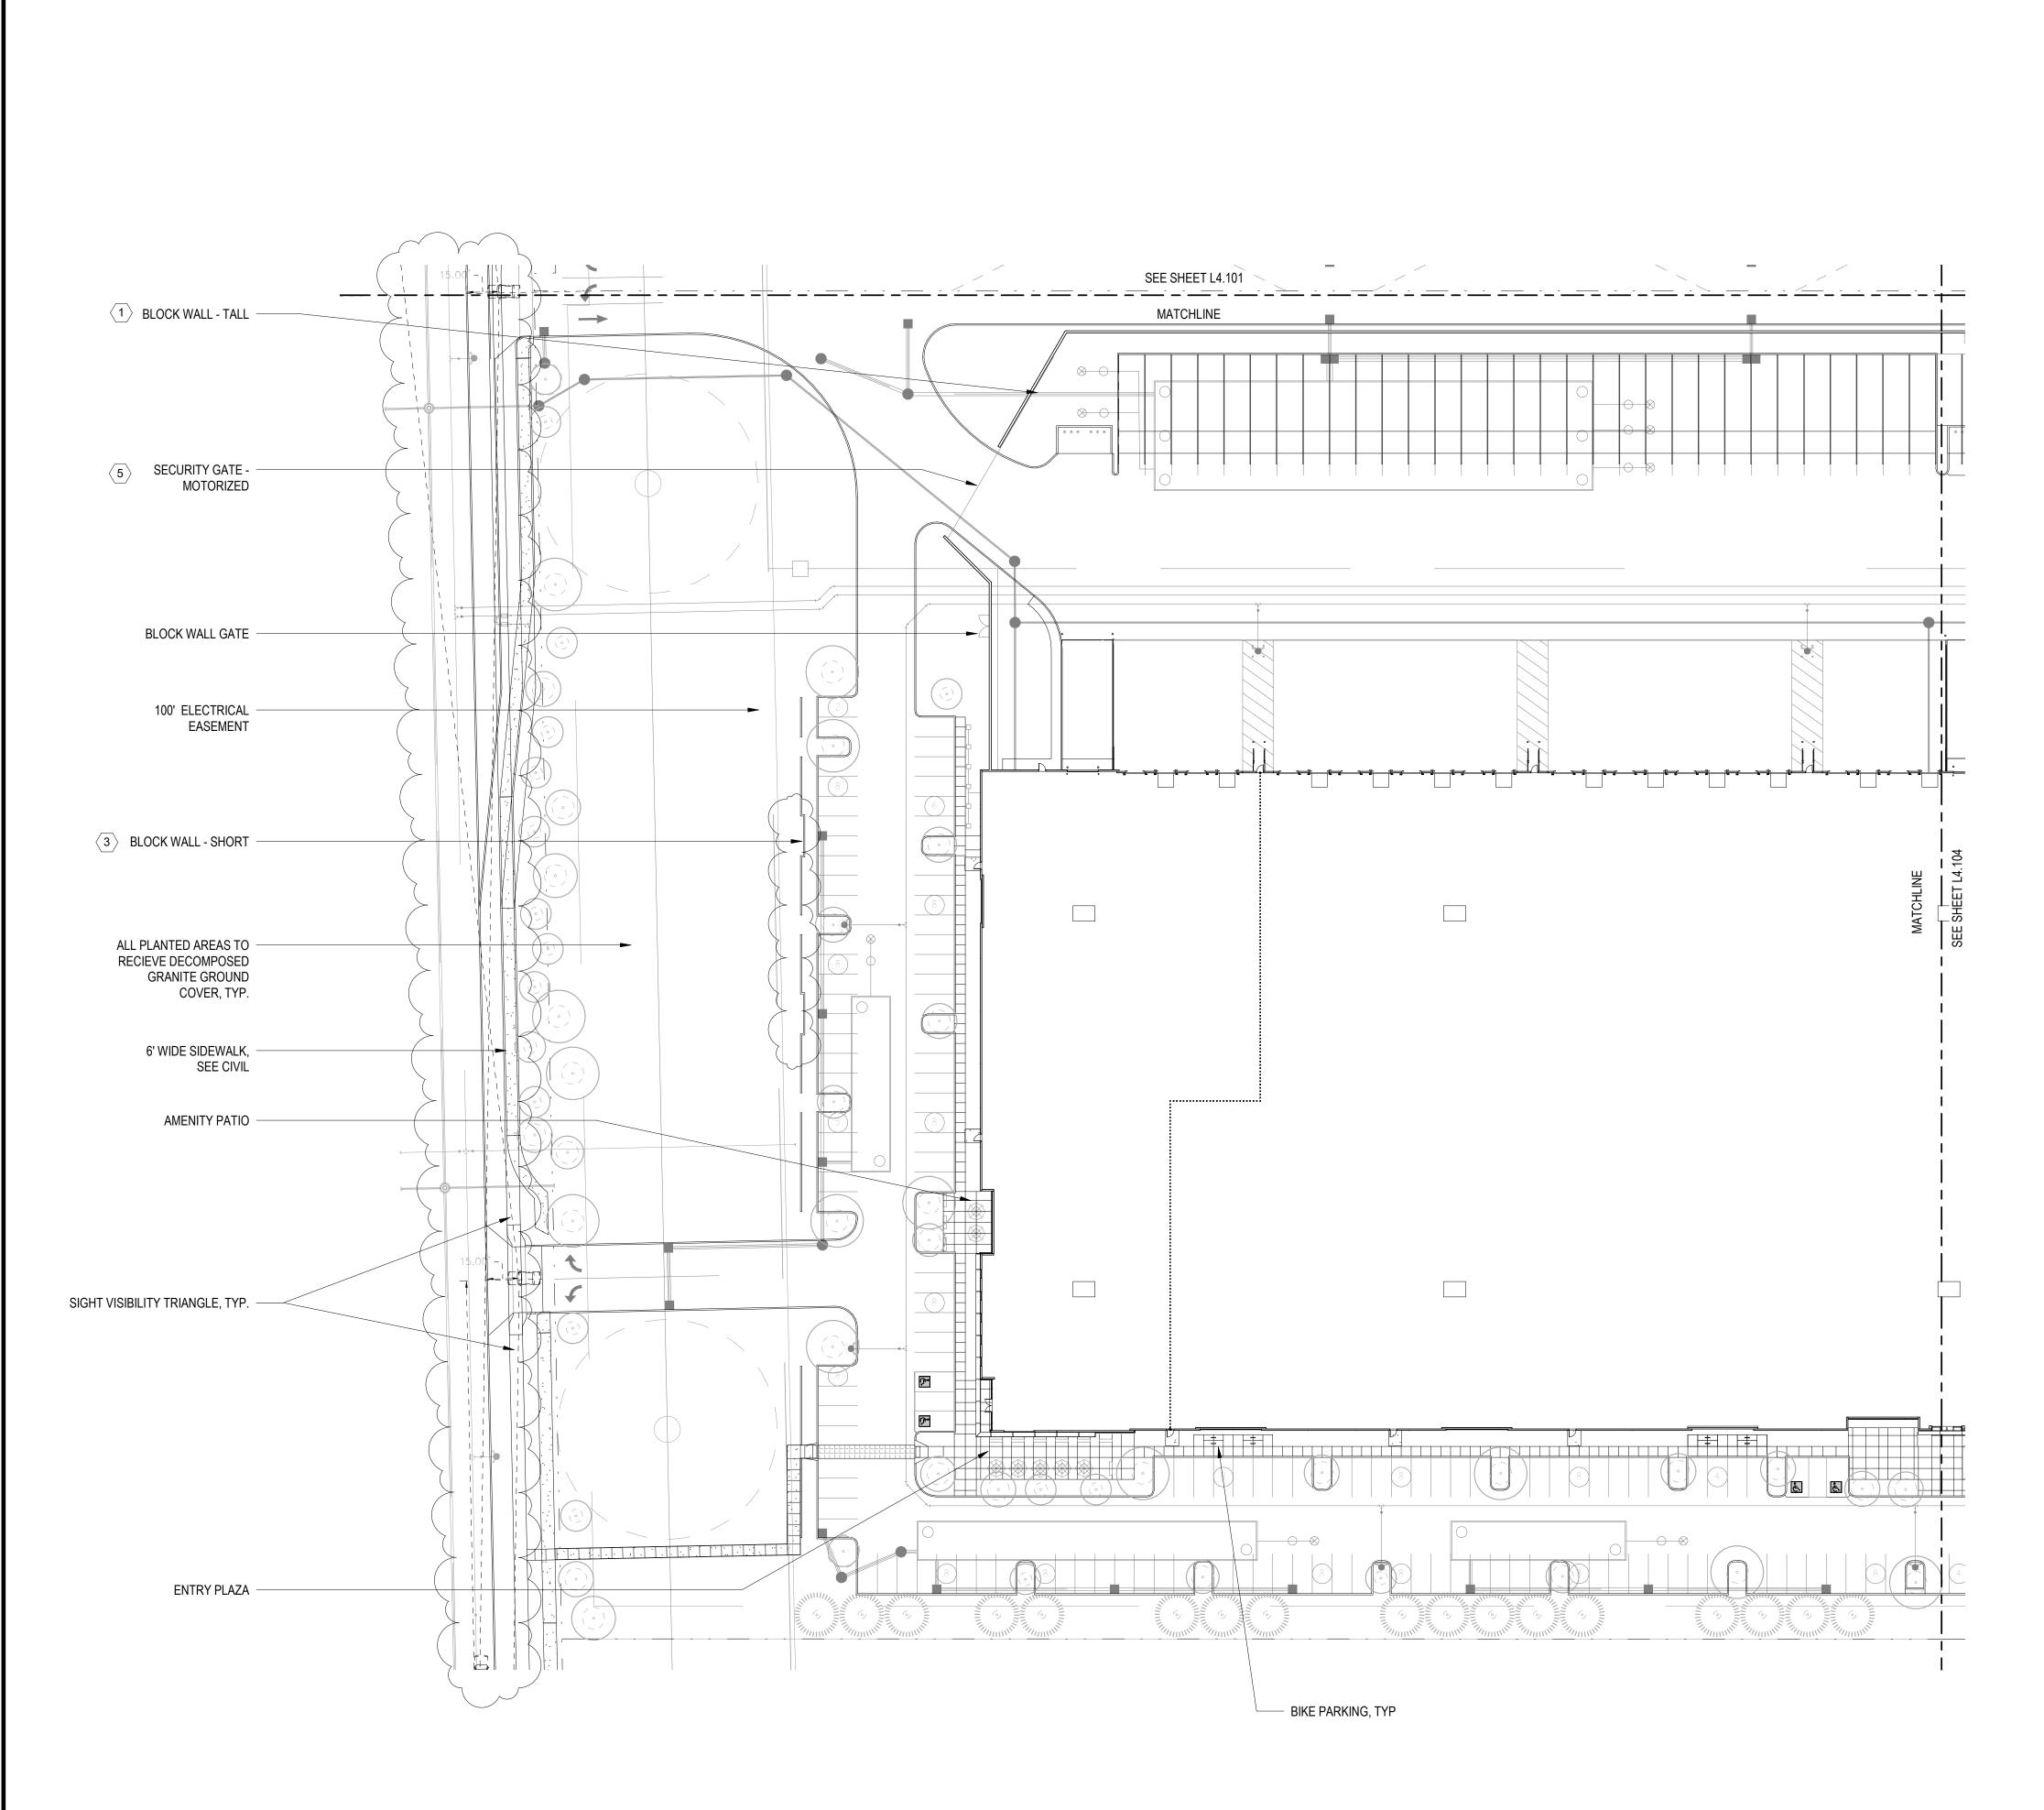

SHEET NOTES

DESCRIPTION

DETAIL

1. CONCRETE BLOCK WALL - TALL
2. CONCRETE BLOCK WALL - OFFSET
3. CONCRETE BLOCK WALL - SHORT
4. SECURITY FENCE
5. SECURITY GATE - MOTORIZED
6. SECURITY GATE

DETAIL

B2 / L4.301
- / --SECURITY GATE - MOTORIZED

E1 / L4.302
SEE SPECS

CONTRACTOR TO PROVIDE SHOP DRAWINGS FOR FENCING AND NON-MECHANICAL GATES. SEE SPECS FOR REQUIREMENTS.

LEGEND

SYMBOL	DESCRIPTION	DETAIL
4	CONCRETE WALK	SEE CIVIL
5005 5005 5005 9006	DETENTION BASIN WITH GRAVEL	C4 / L4.301
	DECOMPOSED GRANITE	E4 / L4.301

) ICE OF BUILDII

THE ART & SCIENCE OF 2199 INNERBELT BUSINESS CENTER DRIV

Lamar Johnson Collaborative

2199 INNERBELT BUSINESS CENTER DRIVE ST. LOUIS, MISSOURI 63114 Ph 314.429.1010



CRG

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5 B ION RD, MESA, AZ 85212

BUILDING
E PECOS RD & S CRISN

DRAWING ISSUE

DESCRIPTION DATE
DESIGN REVIEW 03.21.2022
1st REVIEW COMMENTS 04/22/2022


DRAWING TITLE SITE PLAN - AREA C

DRAWING NO.

L4.103

Job# 20.005838

1 SITE PLAN - AREA C
L4.103 1" = 40'-0"

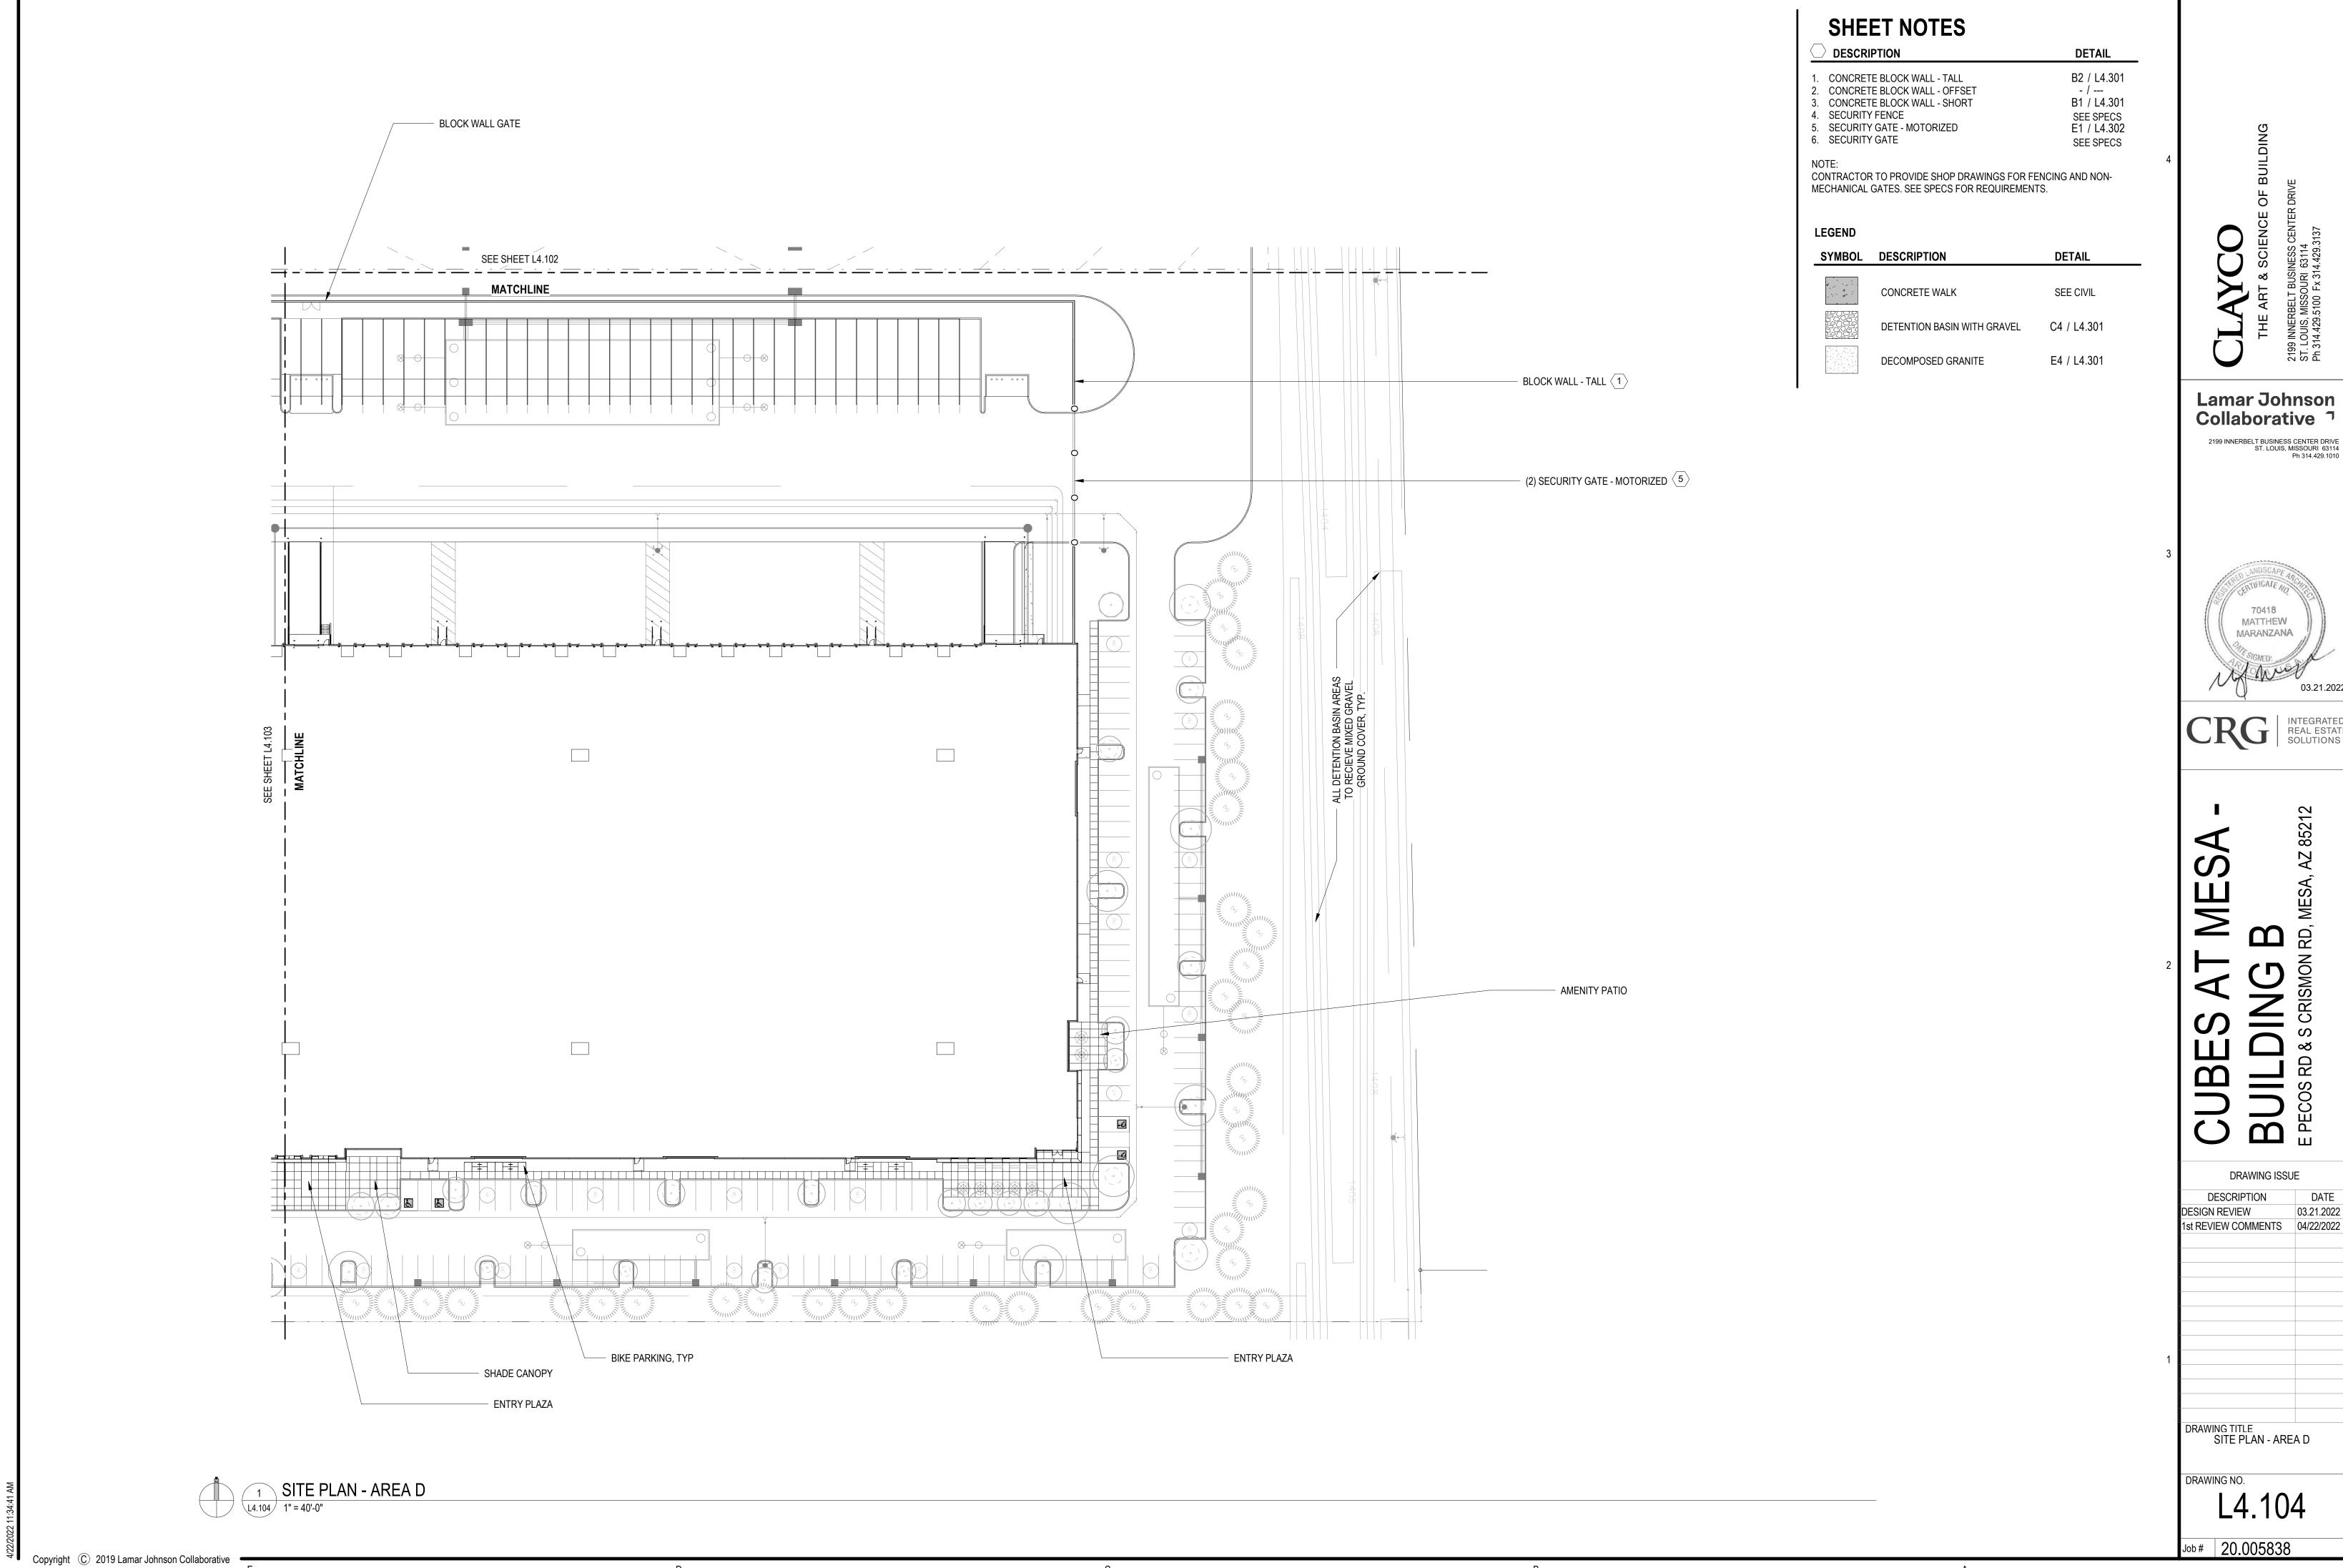



Lamar Johnson




DATE 03.21.2022 1st REVIEW COMMENTS 04/22/2022

L4.104

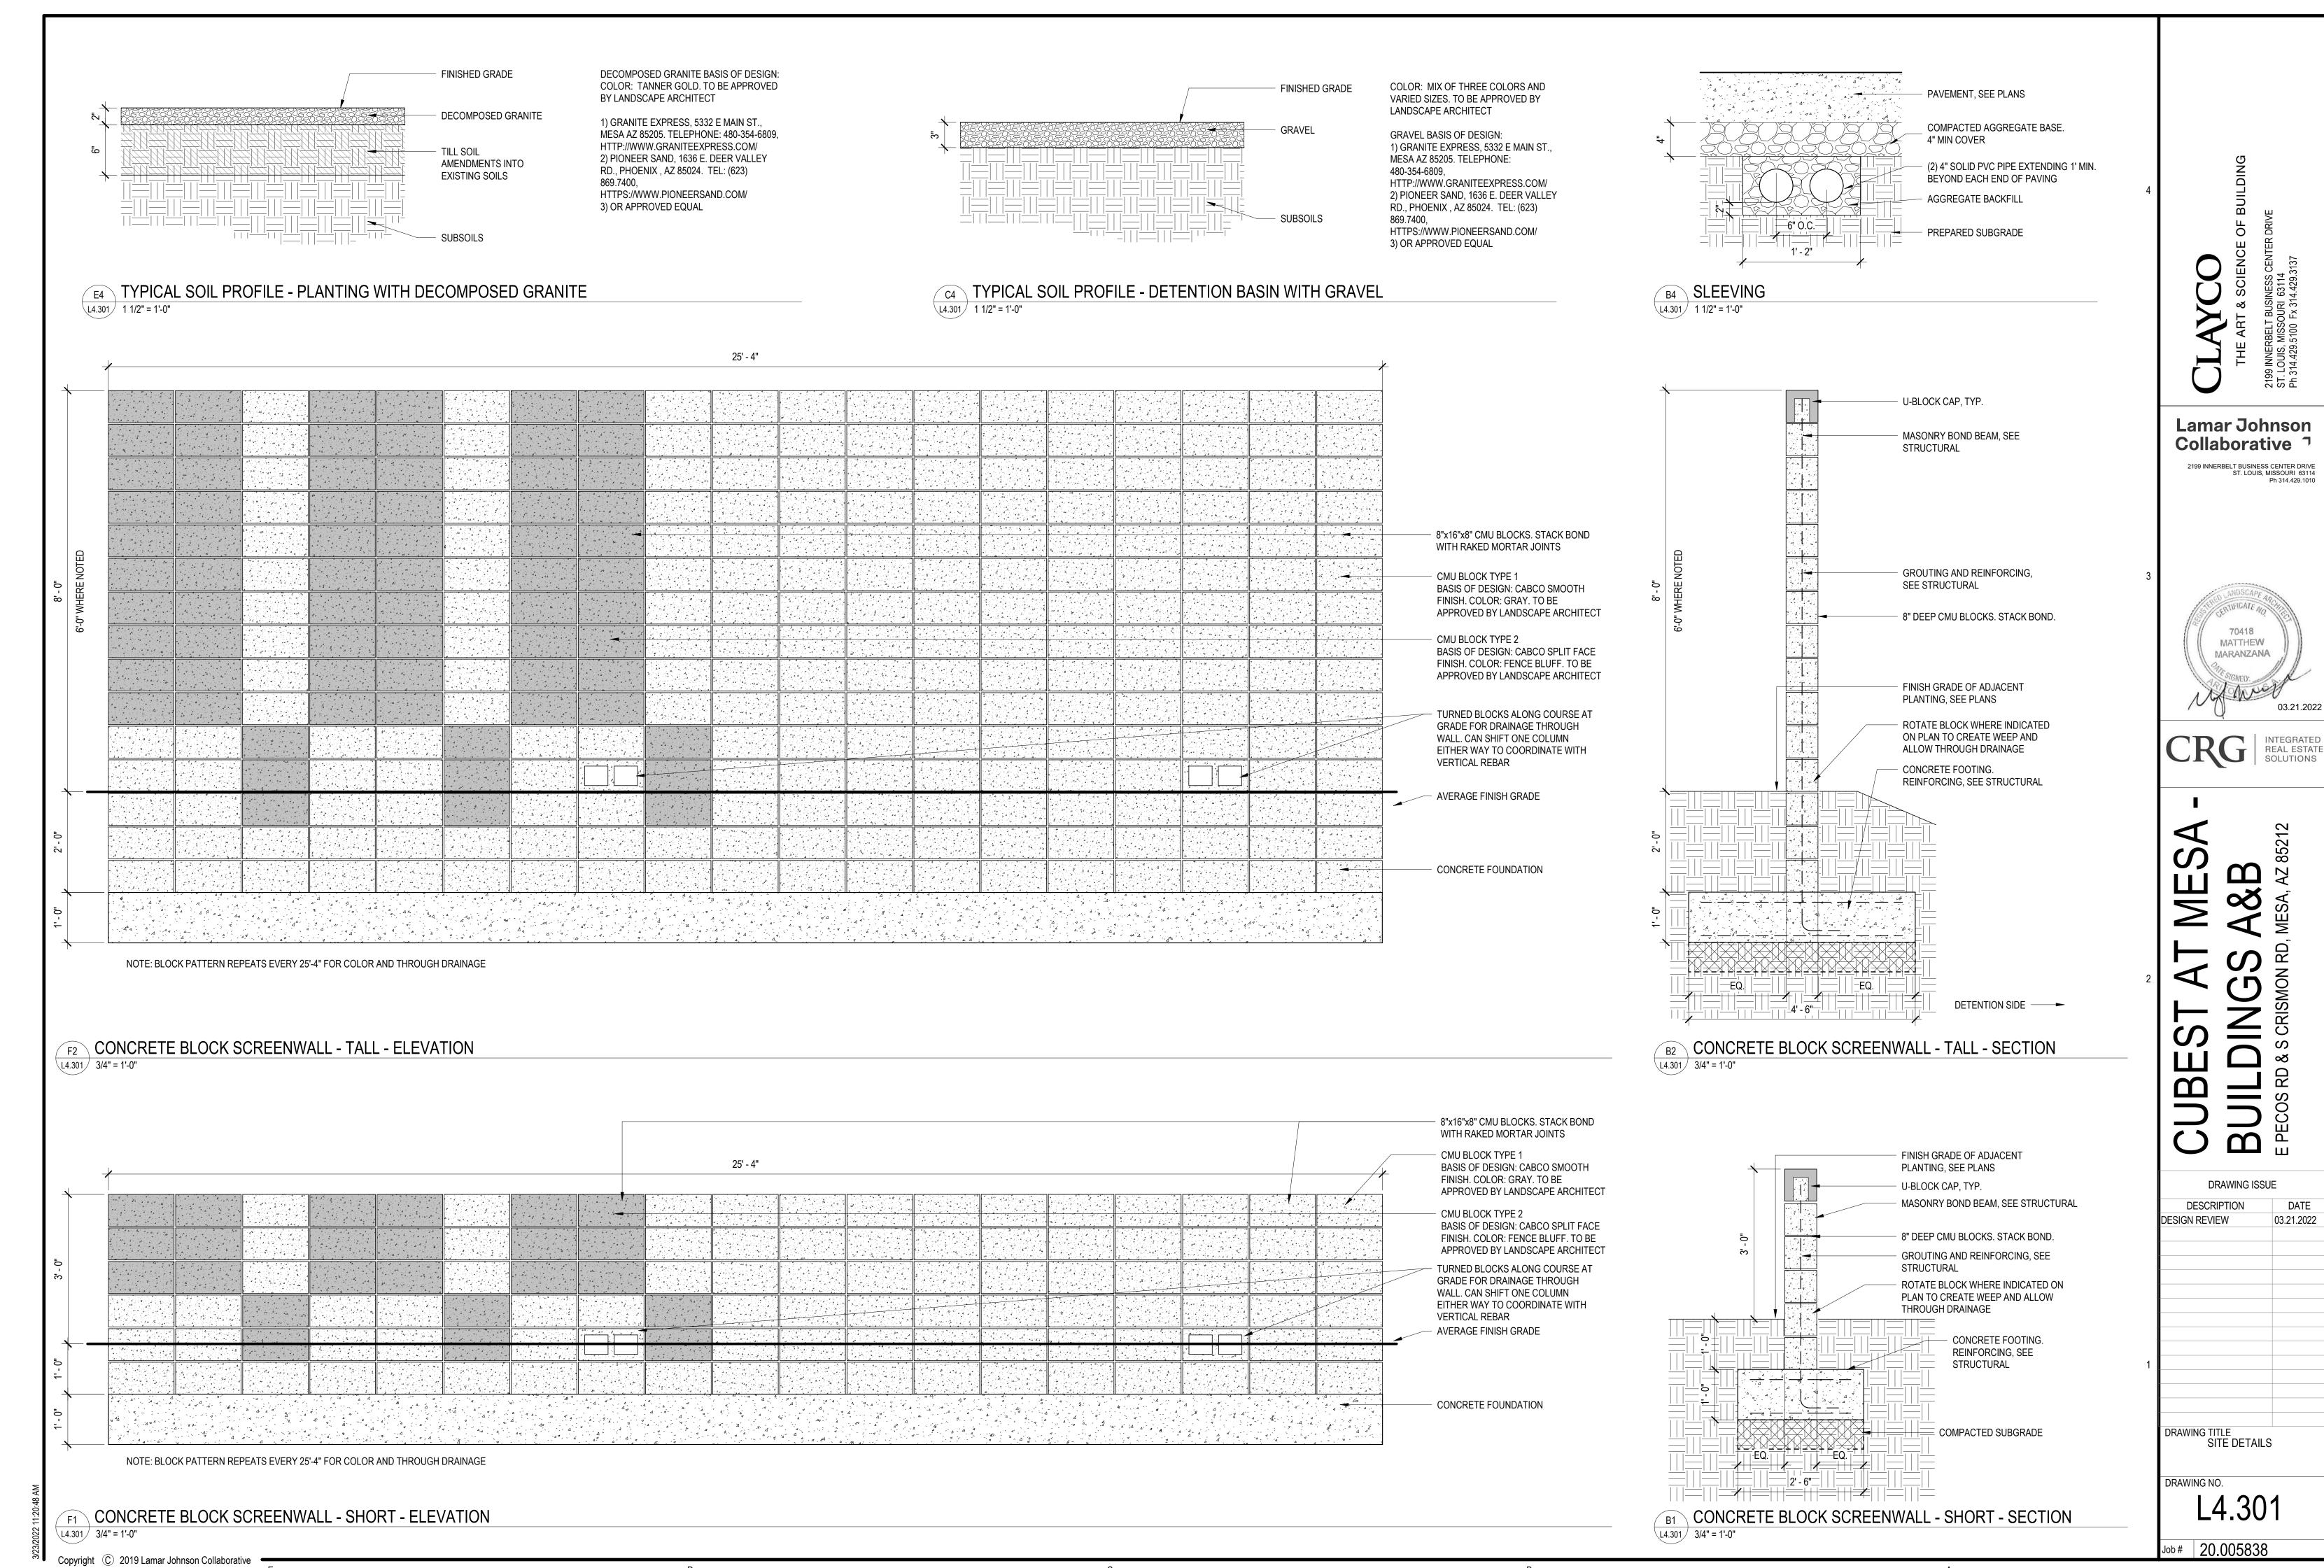

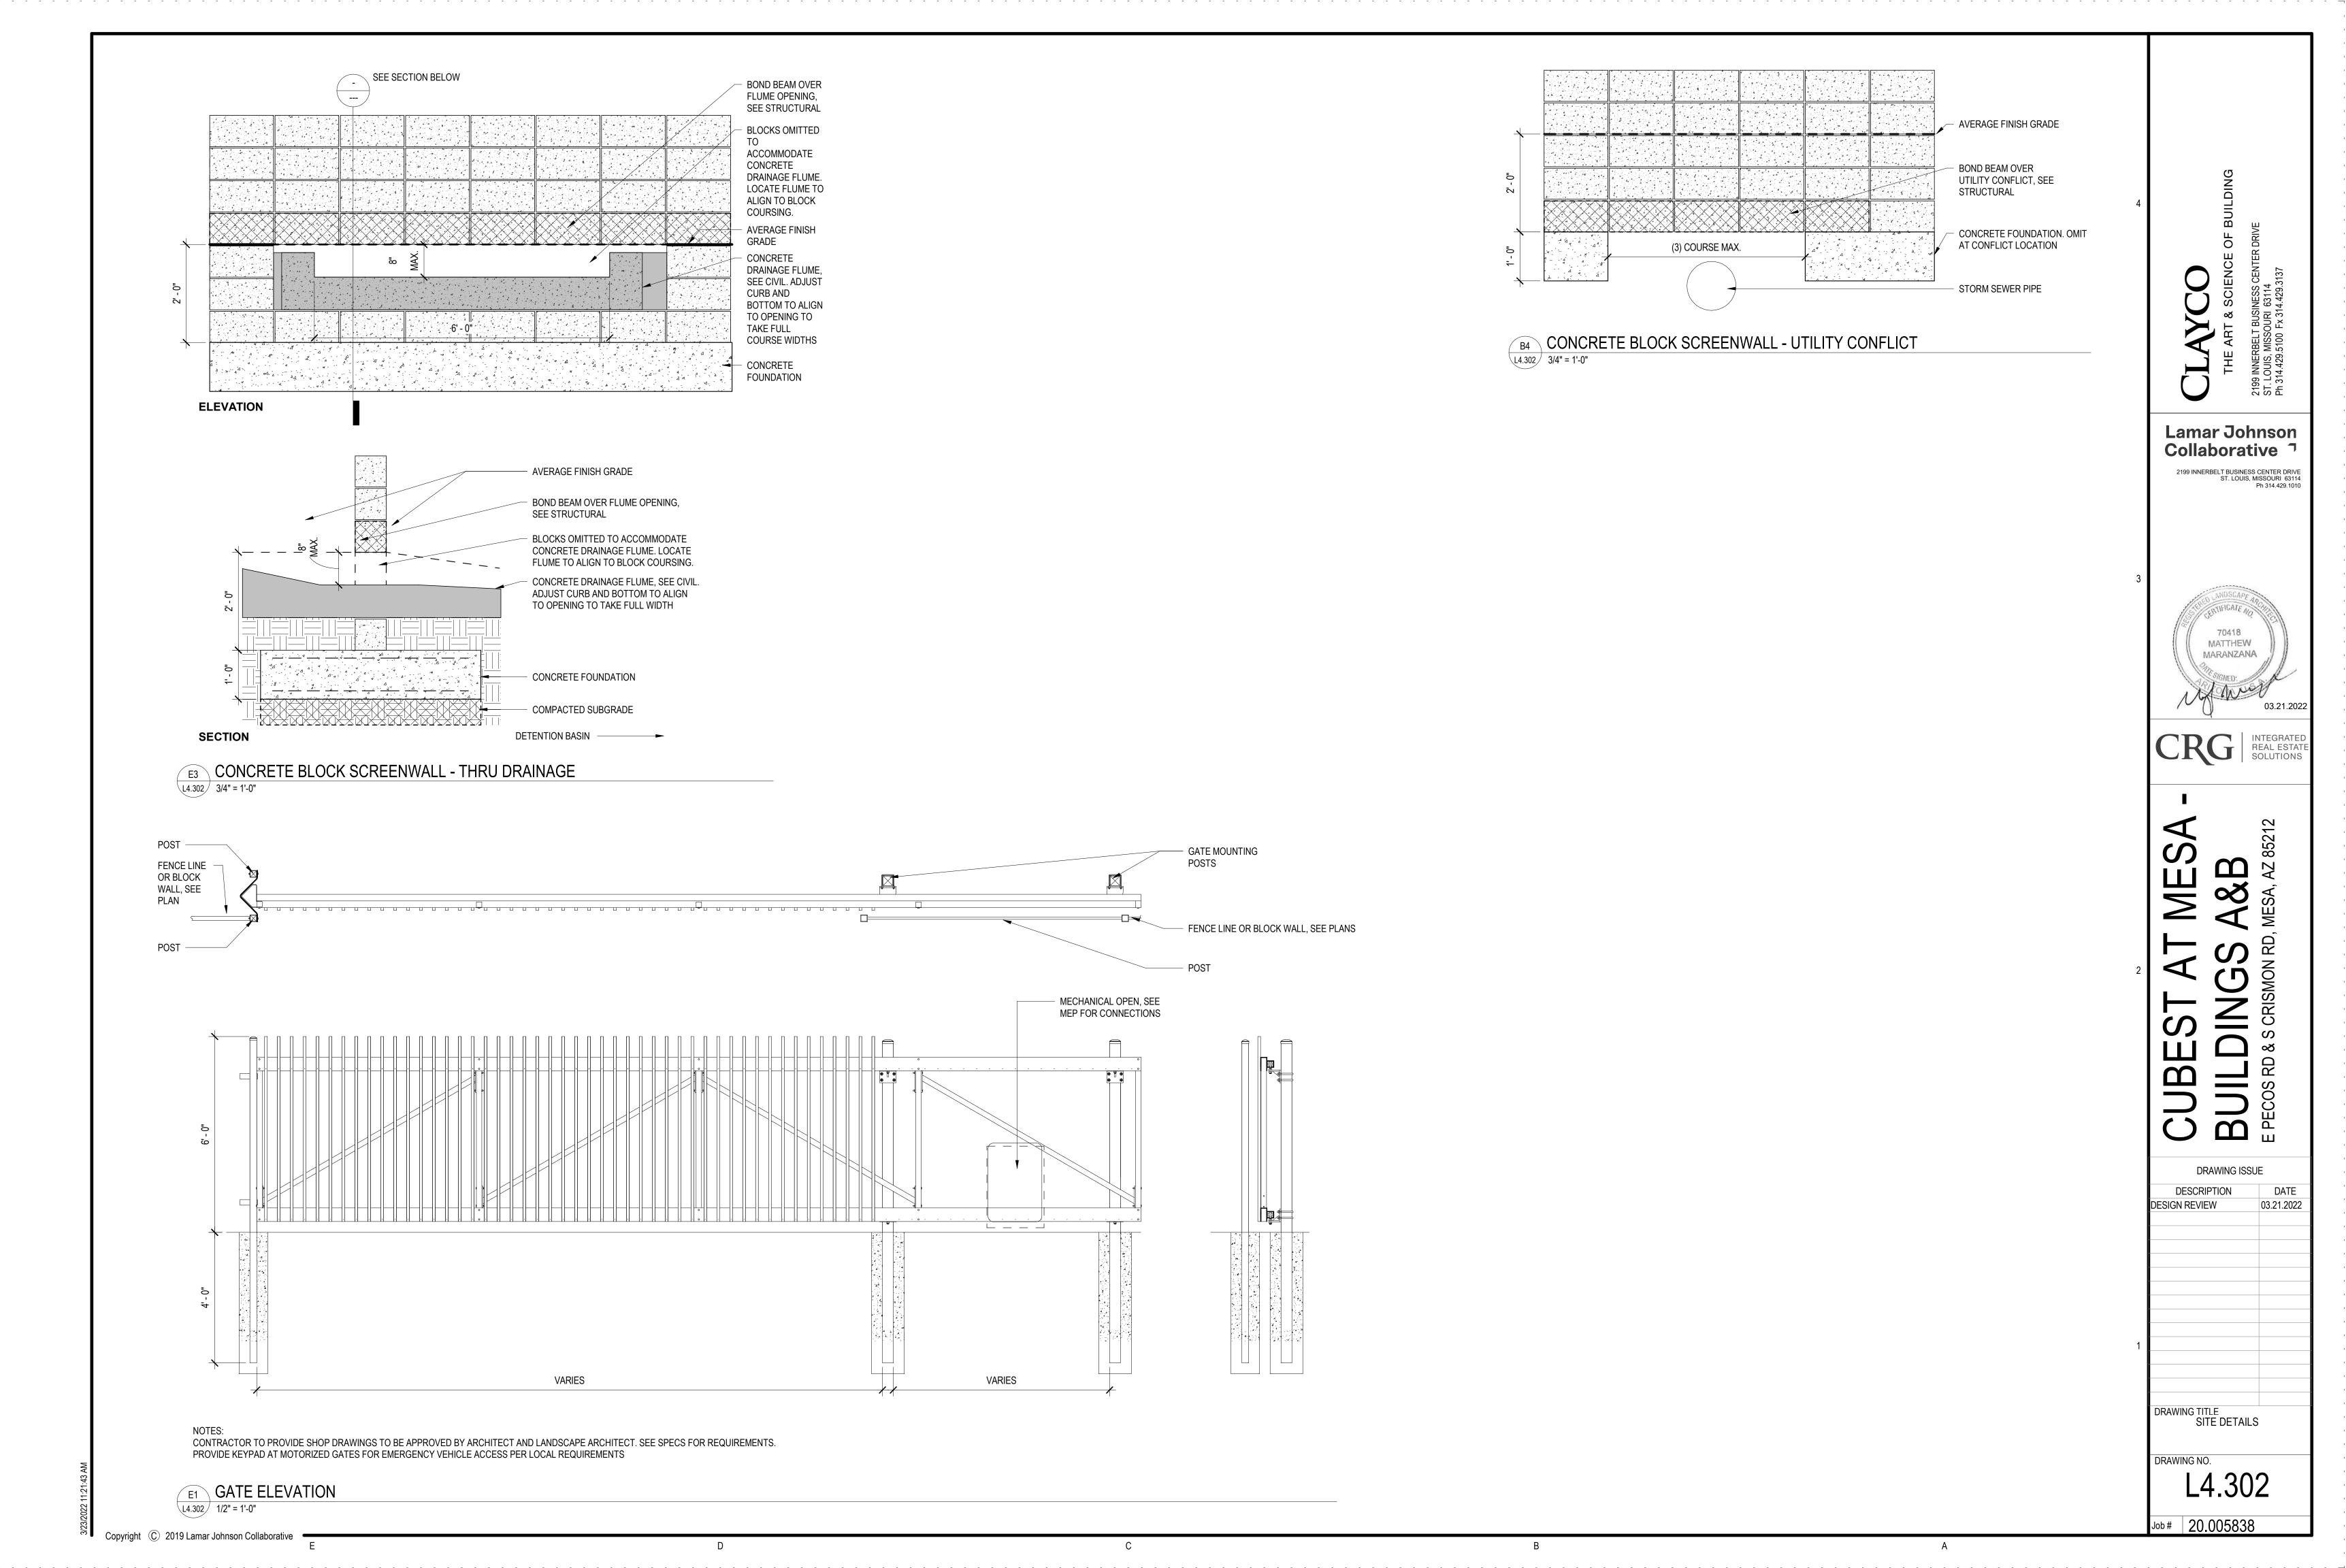

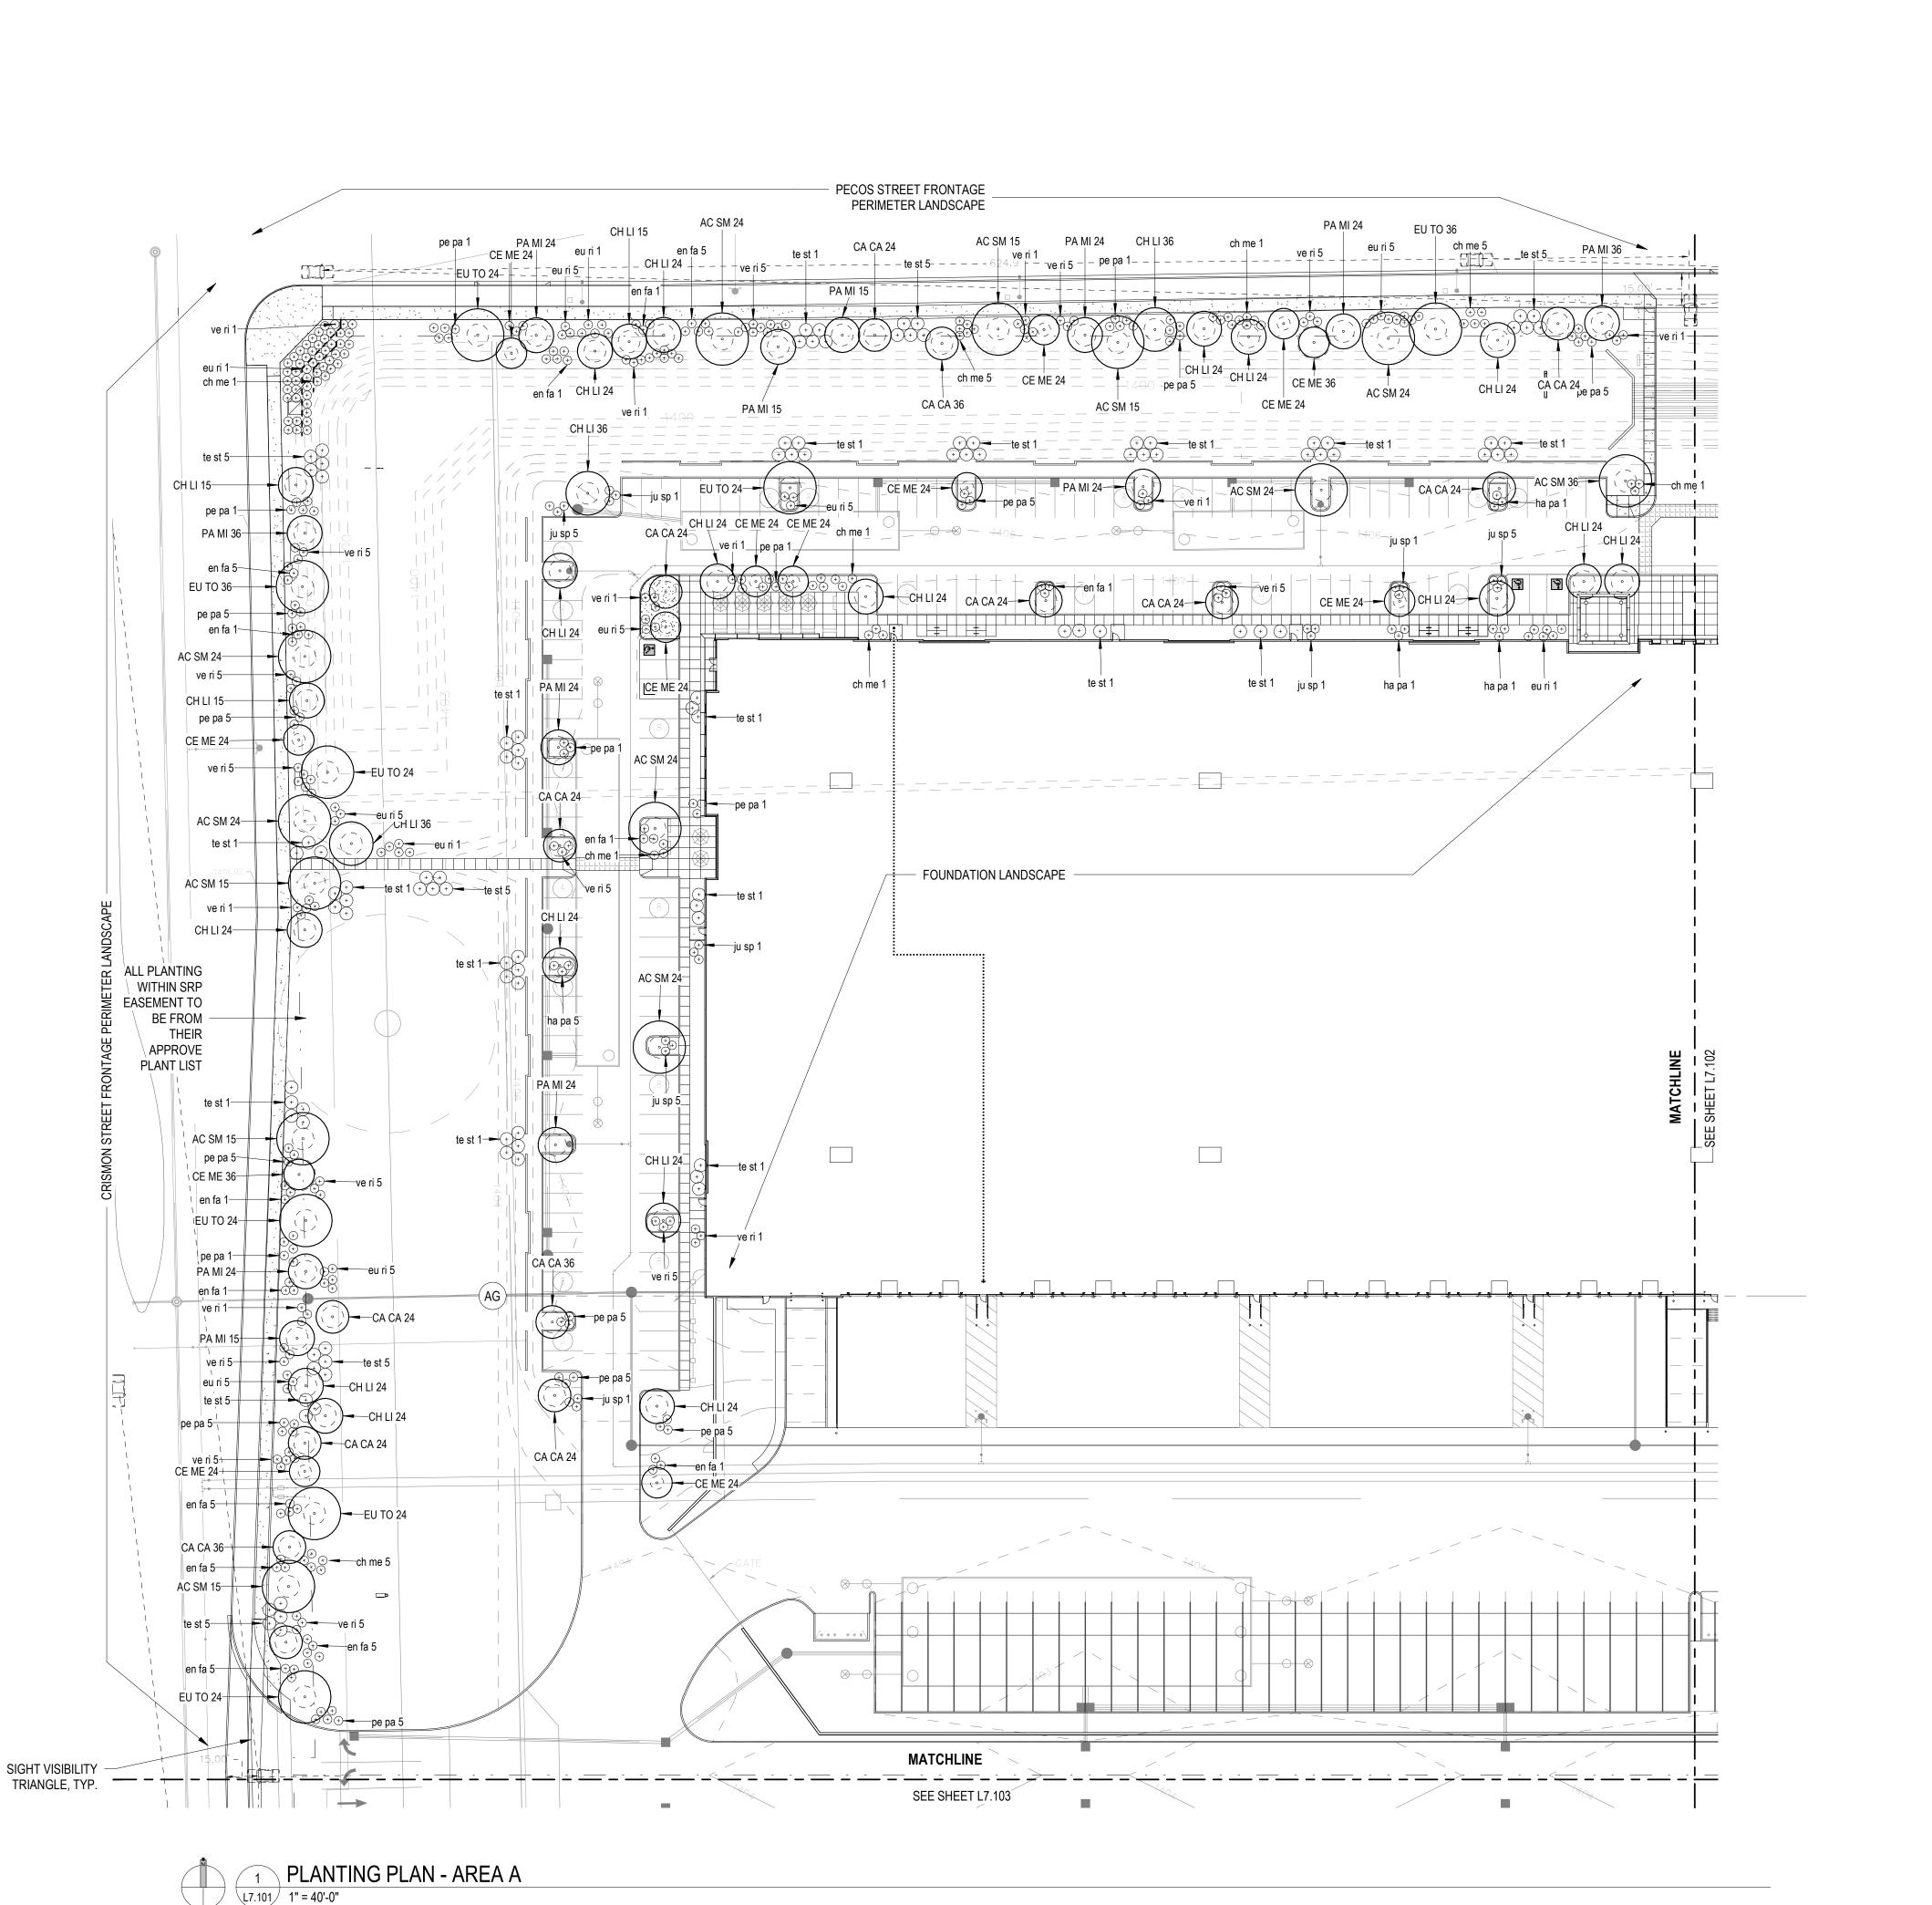

CITY OF MESA GENERAL NOTES FOR LANDSCAPE PLAN

- 1. LANDSCAPE CONTRACTOR SHALL CONFIRM LOCATION OF ALL UNDERGROUND UTILITIES PRIOR TO
- ANY EXCAVATION AND SHALL BE RESPONSIBLE FOR THE FOLLOWING: 2. DAMAGES TO SUCH UTILITIES CAUSED AS A RESULT OF THE CONTRACTOR'S ACTIVITIES.
- 3. DAMAGES TO EXISTING WALKS, WALLS, DRIVES, CURBS, ETC.
- 4. INSPECTING THE SITE IN ORDER TO BE FULLY AWARE OF EXISTING CONDITIONS PRIOR TO SUBMITTING A BID.
- 2. INSTALLATION OF ALL LANDSCAPE AND IRRIGATION MATERIALS SHALL COMPLY WITH SECTIONS 424, 425, 757, AND 795 OF THE MAG STANDARD SPECIFICATIONS.
- 3. CONTRACTOR SHALL REPAIR ANY DAMAGE MADE TO THE EXISTING SPRINKLER SYSTEM TO THE
- SATISFACTION OF THE CITY AT NO ADDITIONAL COST TO THE CITY. 4. LANDSCAPE REMOVAL IS A NON-PAY ITEM UNLESS OTHERWISE NOTED.
- 5. ALL EXISTING VEGETATION, WEEDS, DEBRIS, ETC. NOTED TO BE REMOVED ON THE PLANS AND SPECIFICATIONS SHALL BE REMOVED FROM PROJECT AREA AND DISPOSED OF PROPERLY OFF THE SITE AT THE CONTRACTOR'S EXPENSE (SCARIFY EXISTING SUBGRADE, MINIMUM SIX (6) INCHES DEPTH). 6. DAMAGE TO TURF SHALL BE REPAIRED BY CONTRACTOR, I.E., RUTS FILLED WITH CLEAN SOIL,
- COMPACTED TO MATCH SURROUNDING GRADES, EXCESS SOIL, ROCK, ETC. SHALL BE REMOVED TO LEAVE THE SITE CLEAN. 7. ALL PLANT MATERIAL, OTHER THAN TREES, SHALL CONFORM TO GRADING, TYPE, ETC. AS SET FORTH
- IN THE AMERICAN STANDARD FOR NURSERY STOCK BY THE AMERICAN ASSOCIATION OF NURSERYMEN. ALL TREES SHALL CONFORM TO THE CURRENT ARIZONA NURSERY ASSOCIATION TREE SPECIFICATIONS AND MAG SPEC 795.7. SHOULD ANY CONFLICTS IN THE SPECIFICATIONS OCCUR, THE ARIZONA NURSERY ASSOCIATION'S SPECIFICATIONS SHALL PREVAIL.
- 8. CITY RESERVES THE RIGHT TO INSPECT SHRUBS AND CONTAINERED TREES FOR CONDITION OF ROOT BALLS. FOR ANY SUCH INSPECTIONS WHICH MAY DESTROY ROOTBALL, CONTRACTOR SHALL SUPPLY
- ADDITIONAL PLANT AT NO COST TO CITY. 9. PLANT PITS SHALL BE INSPECTED BY CITY PRIOR TO PLANTING BY THE CONTRACTOR BY REQUESTING AN INSPECTION 48 HOURS IN ADVANCE.
- 10. ROUGH AND FINE GRADING TO ESTABLISH UNIFORM SMOOTH GRADE IS INCLUDED IN THIS PROJECT. 11. SOIL TEST FOR FERTILITY AND ADDITIVE RECOMMENDATIONS (FOR TURF AND ORNAMENTALS) SHALL BE COMPLETED BY CONTRACTOR TO DETERMINE IF ADDITIVES ARE REQUIRED. CONTRACTOR SHALL PROVIDE COPY OF SOIL TEST RESULTS FOR REVIEW AND APPROVAL TO ENGINEERING INSPECTOR AT LEAST SEVEN (7) DAYS PRIOR TO ANTICIPATED PLANTING. AFTER APPROVAL BY THE CITY, THE CONTRACTOR SHALL PROVIDE AND INCORPORATE ANY ADDITIVES REQUIRED PRIOR TO OR AT TIME OF
- 12. PLANT PIT SOIL MIXTURE SHALL CONSIST OF FOUR AND ONE-HALF PARTS NATURAL FERTILE, FRIABLE SOIL AND ONE PART HUMUS BY VOLUME, THOROUGHLY MIXED PRIOR TO BACKFILLING IN PITS. BACKFILLING SHALL BE IN 6" LIFTS WITH EACH LIFT WATER SETTLED WITHOUT PUDDLING. 13. CONTRACTOR SHALL STAKE TREE AND SHRUB LOCATIONS FOR 5-GALLON PLANTS AND LARGER. STAKES SHALL BE MARKED WITH PLANT NAME OR PLANT LEGEND ITEM NUMBER FROM PLANS. 14. ALL EXISTING (GAS, ELECTRIC, WATER, ETC.) COVERS AND BOXES SHALL REMAIN UNCOVERED. CONTRACTOR TO ADJUST TO FINAL GRADE AS NECESSARY. NON-PAY ITEM (NPI) UNLESS OTHERWISE
- 15. THE CONTRACTOR SHALL BE RESPONSIBLE FOR LOCATING THE UNDERGROUND SPRINKLER SYSTEMS 3 IN ADVANCE OF CONSTRUCTION. THE SPRINKLER SYSTEM LOCATIONS NOTED ON PLANS ARE FOR
- REFERENCE ONLY. 16. CONTRACTOR TO VERIFY DEPTH OF ALL INLET STRUCTURES AND SPRINKLER SYSTEMS PRIOR TO
- TRENCHING FOR LOW-FLOW CHANNEL 17. CONTRACTOR TO PROVIDE PUMPING WITHIN FIVE (5) DAYS AFTER THE NOTICE TO PROCEED IS GIVEN
- AS REQUIRED TO DRY THE AREA SUFFICIENTLY TO BEGIN CONSTRUCTION. 18. CONTRACTOR SHALL ARRANGE FOR SPRINKLER SYSTEM SHUTDOWN DURING CONSTRUCTION BY
- CONTACTING THE ENGINEERING INSPECTOR. 19. NO ROCKS LARGER THAN 1" IN DIAMETER SHALL BE ALLOWED IN THE TOP SIX (6) INCHES OF TOPSOIL
- WHERE TURF ESTABLISHMENT IS SPECIFIED. ROCK REMOVAL AS NECESSARY IS A NON-PAY (NPI) ITEM UNLESS OTHERWISE NOTED.
- 20. WHERE CALICHE IS ENCOUNTERED IN PLANT PITS, DEPTH AND WIDTH OF PIT SHALL BE INCREASED BY ONE-THIRD (1/3) OVER SPECIFICATION, AND A LIQUID PENETRATOR, "AL-KALICHE" OR EQUAL, SHALL BE INCORPORATED FOR EACH PIT PER MANUFACTURER'S RECOMMENDATIONS.
- 21. CONTRACTOR SHALL INSTALL DECOMPOSED GRANITE TO A ROLLED DEPTH PER THE APPROVED PLANS AND SPECIFICATIONS. DECOMPOSED GRANITE SHALL BE PER THE APPROVED PLANS AND SPECIFICATIONS WITH THE COLOR AS SPECIFIED ON THE PLANS. PRE-EMERGENT HERBICIDE SHALL BE APPLIED BEFORE AND AFTER PLACEMENT OF DECOMPOSED GRANITE PER THE MANUFACTURER'S RECOMMENDATIONS. PRE-EMERGENT HERBICIDE SHALL BE SURFLAN, DACTHAL, OR APPROVED EQUAL SAMPLE TO BE PROVIDED FOR CITY REVIEW AND APPROVAL. CONTRACTOR SHALL WASH OFF ROCK
- MULCH ONCE FINAL PLACEMENT HAS OCCURRED. 22. RESTORE ALL EXISTING LANDSCAPE IRRIGATION SYSTEMS, COMPONENTS AND LANDSCAPE AREAS IMPACTED BY ANY WORK UNDER THIS CONTRACT. RESTORE ALL EXISTING IRRIGATION AND LANDSCAPE IN ACCORDANCE WITH THE LANDSCAPE RESTORATION NOTES INDICATED WITHIN THESE DOCUMENTS. AT A MINIMUM, ALL RESTORATION SHALL BE IN ACCORDANCE WITH M.A.G. SPECIFICATION 107.9 - PROTECTION AND RESTORATION OF PROPERTY AND LANDSCAPE. ALL RESTORATION WORK SHALL BE COMPLETED TO THE SATISFACTION OF THE CITY OF MESA ENGINEER.
- 23. ALL RESTORATION WORK SHALL BE COMPLETED IN ACCORDANCE WITH THE REFERENCED DETAILS AND ANY ADDITIONAL DETAILS PROVIDED.
- 24. REFER TO LANDSCAPE PLANTING SHEETS AND ENGINEERING DRAWINGS FOR ADDITIONAL RESTORATION NOTES AND REQUIRED COORDINATION.

TREE LEGEND				
Code	Botanical Name	Cultivar	Common Name	Size
AC SM 15	Acacia smallii		Sweet Acacia	15 GAL.
AC SM 24	Acacia smallii		Sweet Acacia	24" BOX
AC SM 36	Acacia smallii		Sweet Acacia	36" BOX
CA CA 24	Caesalpinia cacalaco	'Smoothie'	Thornless Cascalote	24" BOX
CA CA 36	Caesalpinia cacalaco	'Smoothie'	Thornless Cascalote	36" BOX
CE ME 24	Cercis mexicana		Mexican Redbud	24" BOX
CE ME 36	Cercis mexicana		Mexican Redbud	36" BOX
0 11114 -				4-041

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CE ME 36	Cercis mexicana		Mexican Redbud	36" BOX
CH LI 15	Chilopsis Linearis		Desert Willow	15 GAL
CH LI 24	Chilopsis Linearis		Desert Willow	24" BOX
CH LI 36	Chilopsis Linearis		Desert Willow	36" BOX
EU TO 24	Eucalyptus torquata		Coral Gum	24" BOX
EU TO 36	Eucalyptus torquata		Coral Gum	36" BO
PA MI 15	Parkinsonia microphylla		Foothill Palo Verde	15 GAL
PA MI 24	Parkinsonia microphylla		Foothill Palo Verde	24" BOX
PA MI 36	Parkinsonia microphylla		Foothill Palo Verde	36" BO
PI PU	Pinus cembroides		Mexican Pinon Pine	15 GAL
SHRUB LEGEND				

SHRUB LEGEND					
Code	Botanical Name	Cultivar	Common Name	Size	
`		•			

Code	Botanicai Name	Cullivar	Common Name	Size
ch me 1	Chrysactinia mexicana Chrysactinia mexicana		Damianita Daisy	1 Gal
ch me 5	Chrysactinia mexicana Chrysactinia mexicana		Damianita Daisy	5 Gal.
en fa 1	Encelia farinosa		Brittlebush	1 Gal
en fa 5	Encelia farinosa		Brittlebush	5 Gal.
eu ri 1	euphorbia rigida		Gopher Plant	1 Gal
eu ri 5	euphorbia rigida		Gopher Plant	5 Gal.
ha pa 1	Hamelia patens	'Sierra Red'	Fire Bush	1 Gal
ha pa 5	Hamelia patens	'Sierra Red'	Fire Bush	5 Gal.
ju sp 1	Justicia spicigera		Mexican Honeysuckle	1 Gal
ju sp 5	Justicia spicigera		Mexican Honeysuckle	5 Gal.
pe pa 1	Penstemon parryi		Parry's Penstemon	1 Gal
pe pa 5	Penstemon parryi		Parry's Penstemon	5 Gal.
te st 1	Tecoma stans	'Gold Star'	Yellow Bells	1 Gal
te st 5	Tecoma stans	'Gold Star'	Yellow Bells	5 Gal.
ve ri 1	verbena rigida		Sandpaper Verbena	1 Gal
ve ri 5	verbena rigida		Sandpaper Verbena	5 Gal.

NOTE: NUMBER IN PLANT CODE INDICATED PLANT SIZE, **NOT QUANTITY**

Lamar Johnson Collaborative 7

2199 INNERBELT BUSINESS CENTER DRIVE ST. LOUIS, MISSOURI 63114 Ph 314.429.1010



REAL ESTAT SOLUTIONS


 $\mathbf{\Omega}$ DRAWING ISSUE

DESCRIPTION DATE DESIGN REVIEW 03.21.2022 1st REVIEW COMMENTS 04/22/2022

DRAWING TITLE PLANTING PLAN - AREA A

DRAWING NO. L7.101

Job# 20.005838

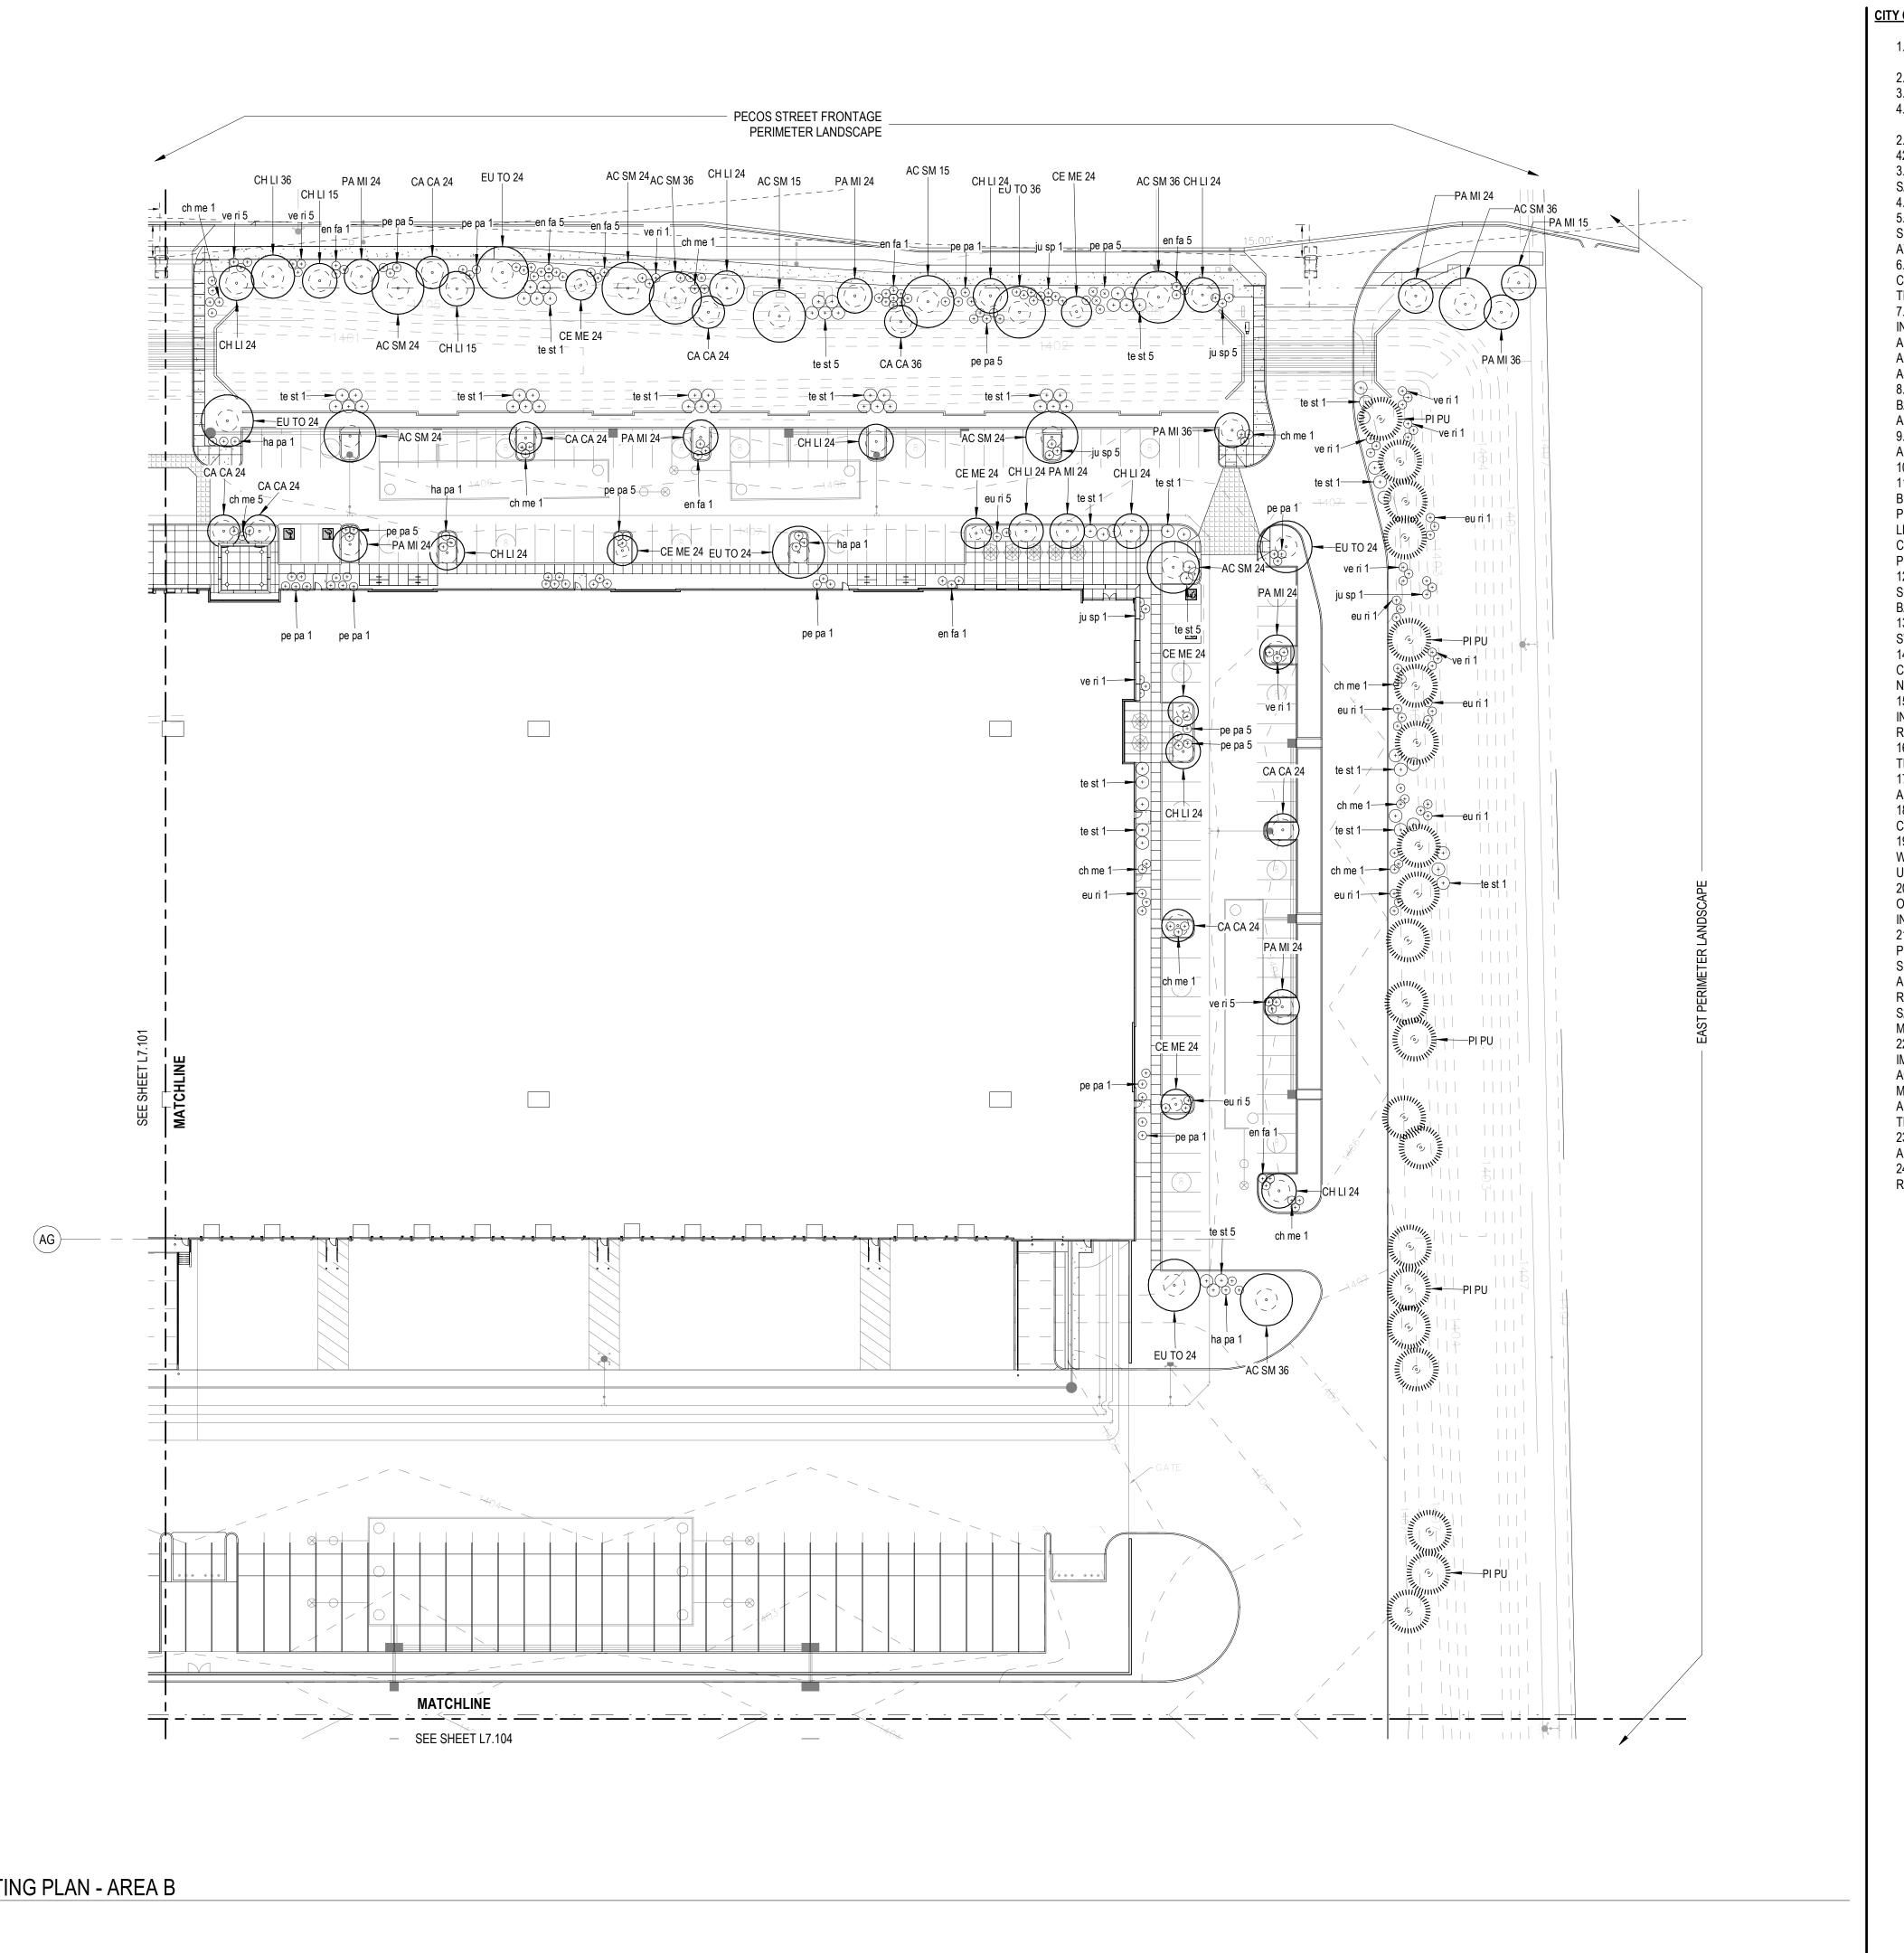

CITY OF MESA GENERAL NOTES FOR LANDSCAPE PLAN

- 1. LANDSCAPE CONTRACTOR SHALL CONFIRM LOCATION OF ALL UNDERGROUND UTILITIES PRIOR TO ANY EXCAVATION AND SHALL BE RESPONSIBLE FOR THE FOLLOWING:
- 2. DAMAGES TO SUCH UTILITIES CAUSED AS A RESULT OF THE CONTRACTOR'S ACTIVITIES.
- 3. DAMAGES TO EXISTING WALKS, WALLS, DRIVES, CURBS, ETC.
- 4. INSPECTING THE SITE IN ORDER TO BE FULLY AWARE OF EXISTING CONDITIONS PRIOR TO SUBMITTING A BID.
- 2. INSTALLATION OF ALL LANDSCAPE AND IRRIGATION MATERIALS SHALL COMPLY WITH SECTIONS 424,
- 425, 757, AND 795 OF THE MAG STANDARD SPECIFICATIONS. 3. CONTRACTOR SHALL REPAIR ANY DAMAGE MADE TO THE EXISTING SPRINKLER SYSTEM TO THE
- SATISFACTION OF THE CITY AT NO ADDITIONAL COST TO THE CITY.
- 4. LANDSCAPE REMOVAL IS A NON-PAY ITEM UNLESS OTHERWISE NOTED. 5. ALL EXISTING VEGETATION, WEEDS, DEBRIS, ETC. NOTED TO BE REMOVED ON THE PLANS AND SPECIFICATIONS SHALL BE REMOVED FROM PROJECT AREA AND DISPOSED OF PROPERLY OFF THE SITE AT THE CONTRACTOR'S EXPENSE (SCARIFY EXISTING SUBGRADE, MINIMUM SIX (6) INCHES DEPTH).
- 6. DAMAGE TO TURF SHALL BE REPAIRED BY CONTRACTOR, I.E., RUTS FILLED WITH CLEAN SOIL, COMPACTED TO MATCH SURROUNDING GRADES, EXCESS SOIL, ROCK, ETC. SHALL BE REMOVED TO LEAVE THE SITE CLEAN.
- 7. ALL PLANT MATERIAL, OTHER THAN TREES, SHALL CONFORM TO GRADING, TYPE, ETC. AS SET FORTH IN THE <u>AMERICAN STANDARD FOR NURSERY STOCK</u> BY THE AMERICAN ASSOCIATION OF NURSERYMEN. ALL TREES SHALL CONFORM TO THE CURRENT <u>ARIZONA NURSERY ASSOCIATION TREE SPECIFICATIONS</u> AND MAG SPEC 795.7. SHOULD ANY CONFLICTS IN THE SPECIFICATIONS OCCUR, THE ARIZONA NURSERY ASSOCIATION'S SPECIFICATIONS SHALL PREVAIL.
- 8. CITY RESERVES THE RIGHT TO INSPECT SHRUBS AND CONTAINERED TREES FOR CONDITION OF ROOT BALLS. FOR ANY SUCH INSPECTIONS WHICH MAY DESTROY ROOTBALL, CONTRACTOR SHALL SUPPLY
- ADDITIONAL PLANT AT NO COST TO CITY. 9. PLANT PITS SHALL BE INSPECTED BY CITY PRIOR TO PLANTING BY THE CONTRACTOR BY REQUESTING
- AN INSPECTION 48 HOURS IN ADVANCE. 10. ROUGH AND FINE GRADING TO ESTABLISH UNIFORM SMOOTH GRADE IS INCLUDED IN THIS PROJECT. 11. SOIL TEST FOR FERTILITY AND ADDITIVE RECOMMENDATIONS (FOR TURF AND ORNAMENTALS) SHALL BE COMPLETED BY CONTRACTOR TO DETERMINE IF ADDITIVES ARE REQUIRED. CONTRACTOR SHALL PROVIDE COPY OF SOIL TEST RESULTS FOR REVIEW AND APPROVAL TO ENGINEERING INSPECTOR AT LEAST SEVEN (7) DAYS PRIOR TO ANTICIPATED PLANTING. AFTER APPROVAL BY THE CITY, THE CONTRACTOR SHALL PROVIDE AND INCORPORATE ANY ADDITIVES REQUIRED PRIOR TO OR AT TIME OF
- 12. PLANT PIT SOIL MIXTURE SHALL CONSIST OF FOUR AND ONE-HALF PARTS NATURAL FERTILE, FRIABLE SOIL AND ONE PART HUMUS BY VOLUME, THOROUGHLY MIXED PRIOR TO BACKFILLING IN PITS. BACKFILLING SHALL BE IN 6" LIFTS WITH EACH LIFT WATER SETTLED WITHOUT PUDDLING. 13. CONTRACTOR SHALL STAKE TREE AND SHRUB LOCATIONS FOR 5-GALLON PLANTS AND LARGER. STAKES SHALL BE MARKED WITH PLANT NAME OR PLANT LEGEND ITEM NUMBER FROM PLANS. 14. ALL EXISTING (GAS, ELECTRIC, WATER, ETC.) COVERS AND BOXES SHALL REMAIN UNCOVERED. CONTRACTOR TO ADJUST TO FINAL GRADE AS NECESSARY. NON-PAY ITEM (NPI) UNLESS OTHERWISE
- 15. THE CONTRACTOR SHALL BE RESPONSIBLE FOR LOCATING THE UNDERGROUND SPRINKLER SYSTEMS 3 IN ADVANCE OF CONSTRUCTION. THE SPRINKLER SYSTEM LOCATIONS NOTED ON PLANS ARE FOR
- REFERENCE ONLY. 16. CONTRACTOR TO VERIFY DEPTH OF ALL INLET STRUCTURES AND SPRINKLER SYSTEMS PRIOR TO
- TRENCHING FOR LOW-FLOW CHANNEL. 17. CONTRACTOR TO PROVIDE PUMPING WITHIN FIVE (5) DAYS AFTER THE NOTICE TO PROCEED IS GIVEN
- AS REQUIRED TO DRY THE AREA SUFFICIENTLY TO BEGIN CONSTRUCTION. 18. CONTRACTOR SHALL ARRANGE FOR SPRINKLER SYSTEM SHUTDOWN DURING CONSTRUCTION BY
- CONTACTING THE ENGINEERING INSPECTOR. 19. NO ROCKS LARGER THAN 1" IN DIAMETER SHALL BE ALLOWED IN THE TOP SIX (6) INCHES OF TOPSOIL
- WHERE TURF ESTABLISHMENT IS SPECIFIED. ROCK REMOVAL AS NECESSARY IS A NON-PAY (NPI) ITEM UNLESS OTHERWISE NOTED.
- 20. WHERE CALICHE IS ENCOUNTERED IN PLANT PITS, DEPTH AND WIDTH OF PIT SHALL BE INCREASED BY ONE-THIRD (1/3) OVER SPECIFICATION, AND A LIQUID PENETRATOR, "AL-KALICHE" OR EQUAL, SHALL BE INCORPORATED FOR EACH PIT PER MANUFACTURER'S RECOMMENDATIONS.
- 21. CONTRACTOR SHALL INSTALL DECOMPOSED GRANITE TO A ROLLED DEPTH PER THE APPROVED PLANS AND SPECIFICATIONS. DECOMPOSED GRANITE SHALL BE PER THE APPROVED PLANS AND SPECIFICATIONS WITH THE COLOR AS SPECIFIED ON THE PLANS. PRE-EMERGENT HERBICIDE SHALL BE APPLIED BEFORE AND AFTER PLACEMENT OF DECOMPOSED GRANITE PER THE MANUFACTURER'S RECOMMENDATIONS. PRE-EMERGENT HERBICIDE SHALL BE SURFLAN, DACTHAL, OR APPROVED EQUAL. SAMPLE TO BE PROVIDED FOR CITY REVIEW AND APPROVAL. CONTRACTOR SHALL WASH OFF ROCK
- MULCH ONCE FINAL PLACEMENT HAS OCCURRED. 22. RESTORE ALL EXISTING LANDSCAPE IRRIGATION SYSTEMS, COMPONENTS AND LANDSCAPE AREAS AND RESTORATION OF PROPERTY AND LANDSCAPE. ALL RESTORATION WORK SHALL BE COMPLETED TO THE SATISFACTION OF THE CITY OF MESA ENGINEER.
- 23. ALL RESTORATION WORK SHALL BE COMPLETED IN ACCORDANCE WITH THE REFERENCED DETAILS AND ANY ADDITIONAL DETAILS PROVIDED.
- 24. REFER TO LANDSCAPE PLANTING SHEETS AND ENGINEERING DRAWINGS FOR ADDITIONAL RESTORATION NOTES AND REQUIRED COORDINATION.

	TREE LEGEND						
Code	Botanical Name	Cultivar	Common Name	Size			
AC SM 15	Acacia smallii		Sweet Acacia	15 GAL.			
AC SM 24	Acacia smallii		Sweet Acacia	24" BOX			
AC SM 36	Acacia smallii		Sweet Acacia	36" BOX			
CA CA 24	Caesalpinia cacalaco	'Smoothie'	Thornless Cascalote	24" BOX			
CA CA 36	Caesalpinia cacalaco	'Smoothie'	Thornless Cascalote	36" BOX			
CE ME 24	Cercis mexicana		Mexican Redbud	24" BOX			
CE ME 36	Cercis mexicana		Mexican Redbud	36" BOX			
CH LI 15	Chilopsis Linearis		Desert Willow	15 GAL.			
CH LI 24	Chilopsis Linearis		Desert Willow	24" BOX			
CH LI 36	Chilopsis Linearis		Desert Willow	36" BOX			
EU TO 24	Eucalyptus torquata		Coral Gum	24" BOX			
EU TO 36	Eucalyptus torquata		Coral Gum	36" BOX			
PA MI 15	Parkinsonia microphylla		Foothill Palo Verde	15 GAL.			
PA MI 24	Parkinsonia microphylla		Foothill Palo Verde	24" BOX			
PA MI 36	Parkinsonia microphylla		Foothill Palo Verde	36" BOX			

PI PU	Pinus cembroides		Mexican Pinon Pine	15 GAL.		
SHRUB LEGEND						
Code	Botanical Name	Cultivar	Common Name	Size		
ah ma 1	Chrysostinia mavisana		Demicrita Daiou	1 Cal		

0000				0.20
ch me 1	Chrysactinia mexicana Chrysactinia mexicana		Damianita Daisy	1 Gal
ch me 5	Chrysactinia mexicana Chrysactinia mexicana		Damianita Daisy	5 Gal.
en fa 1	Encelia farinosa		Brittlebush	1 Gal
en fa 5	Encelia farinosa		Brittlebush	5 Gal.
eu ri 1	euphorbia rigida		Gopher Plant	1 Gal
eu ri 5	euphorbia rigida		Gopher Plant	5 Gal.
ha pa 1	Hamelia patens	'Sierra Red'	Fire Bush	1 Gal
ha pa 5	Hamelia patens	'Sierra Red'	Fire Bush	5 Gal.
ju sp 1	Justicia spicigera		Mexican Honeysuckle	1 Gal
ju sp 5	Justicia spicigera		Mexican Honeysuckle	5 Gal.
pe pa 1	Penstemon parryi		Parry's Penstemon	1 Gal
pe pa 5	Penstemon parryi		Parry's Penstemon	5 Gal.
te st 1	Tecoma stans	'Gold Star'	Yellow Bells	1 Gal
te st 5	Tecoma stans	'Gold Star'	Yellow Bells	5 Gal.
ve ri 1	verbena rigida		Sandpaper Verbena	1 Gal
ve ri 5	verbena rigida		Sandpaper Verbena	5 Gal.
	-	•		•

Lamar Johnson ST. LOUIS, MISSOURI 63114 Ph 314.429.1010

Collaborative 7



REAL ESTAT SOLUTIONS


DRAWING ISSUE DESCRIPTION DESIGN REVIEW 03.21.2022 1st REVIEW COMMENTS 04/22/2022

NOTE: NUMBER IN PLANT CODE INDICATED PLANT SIZE, **NOT QUANTITY**

> DRAWING TITLE PLANTING PLAN - AREA B

DRAWING NO.

Job# 20.005838

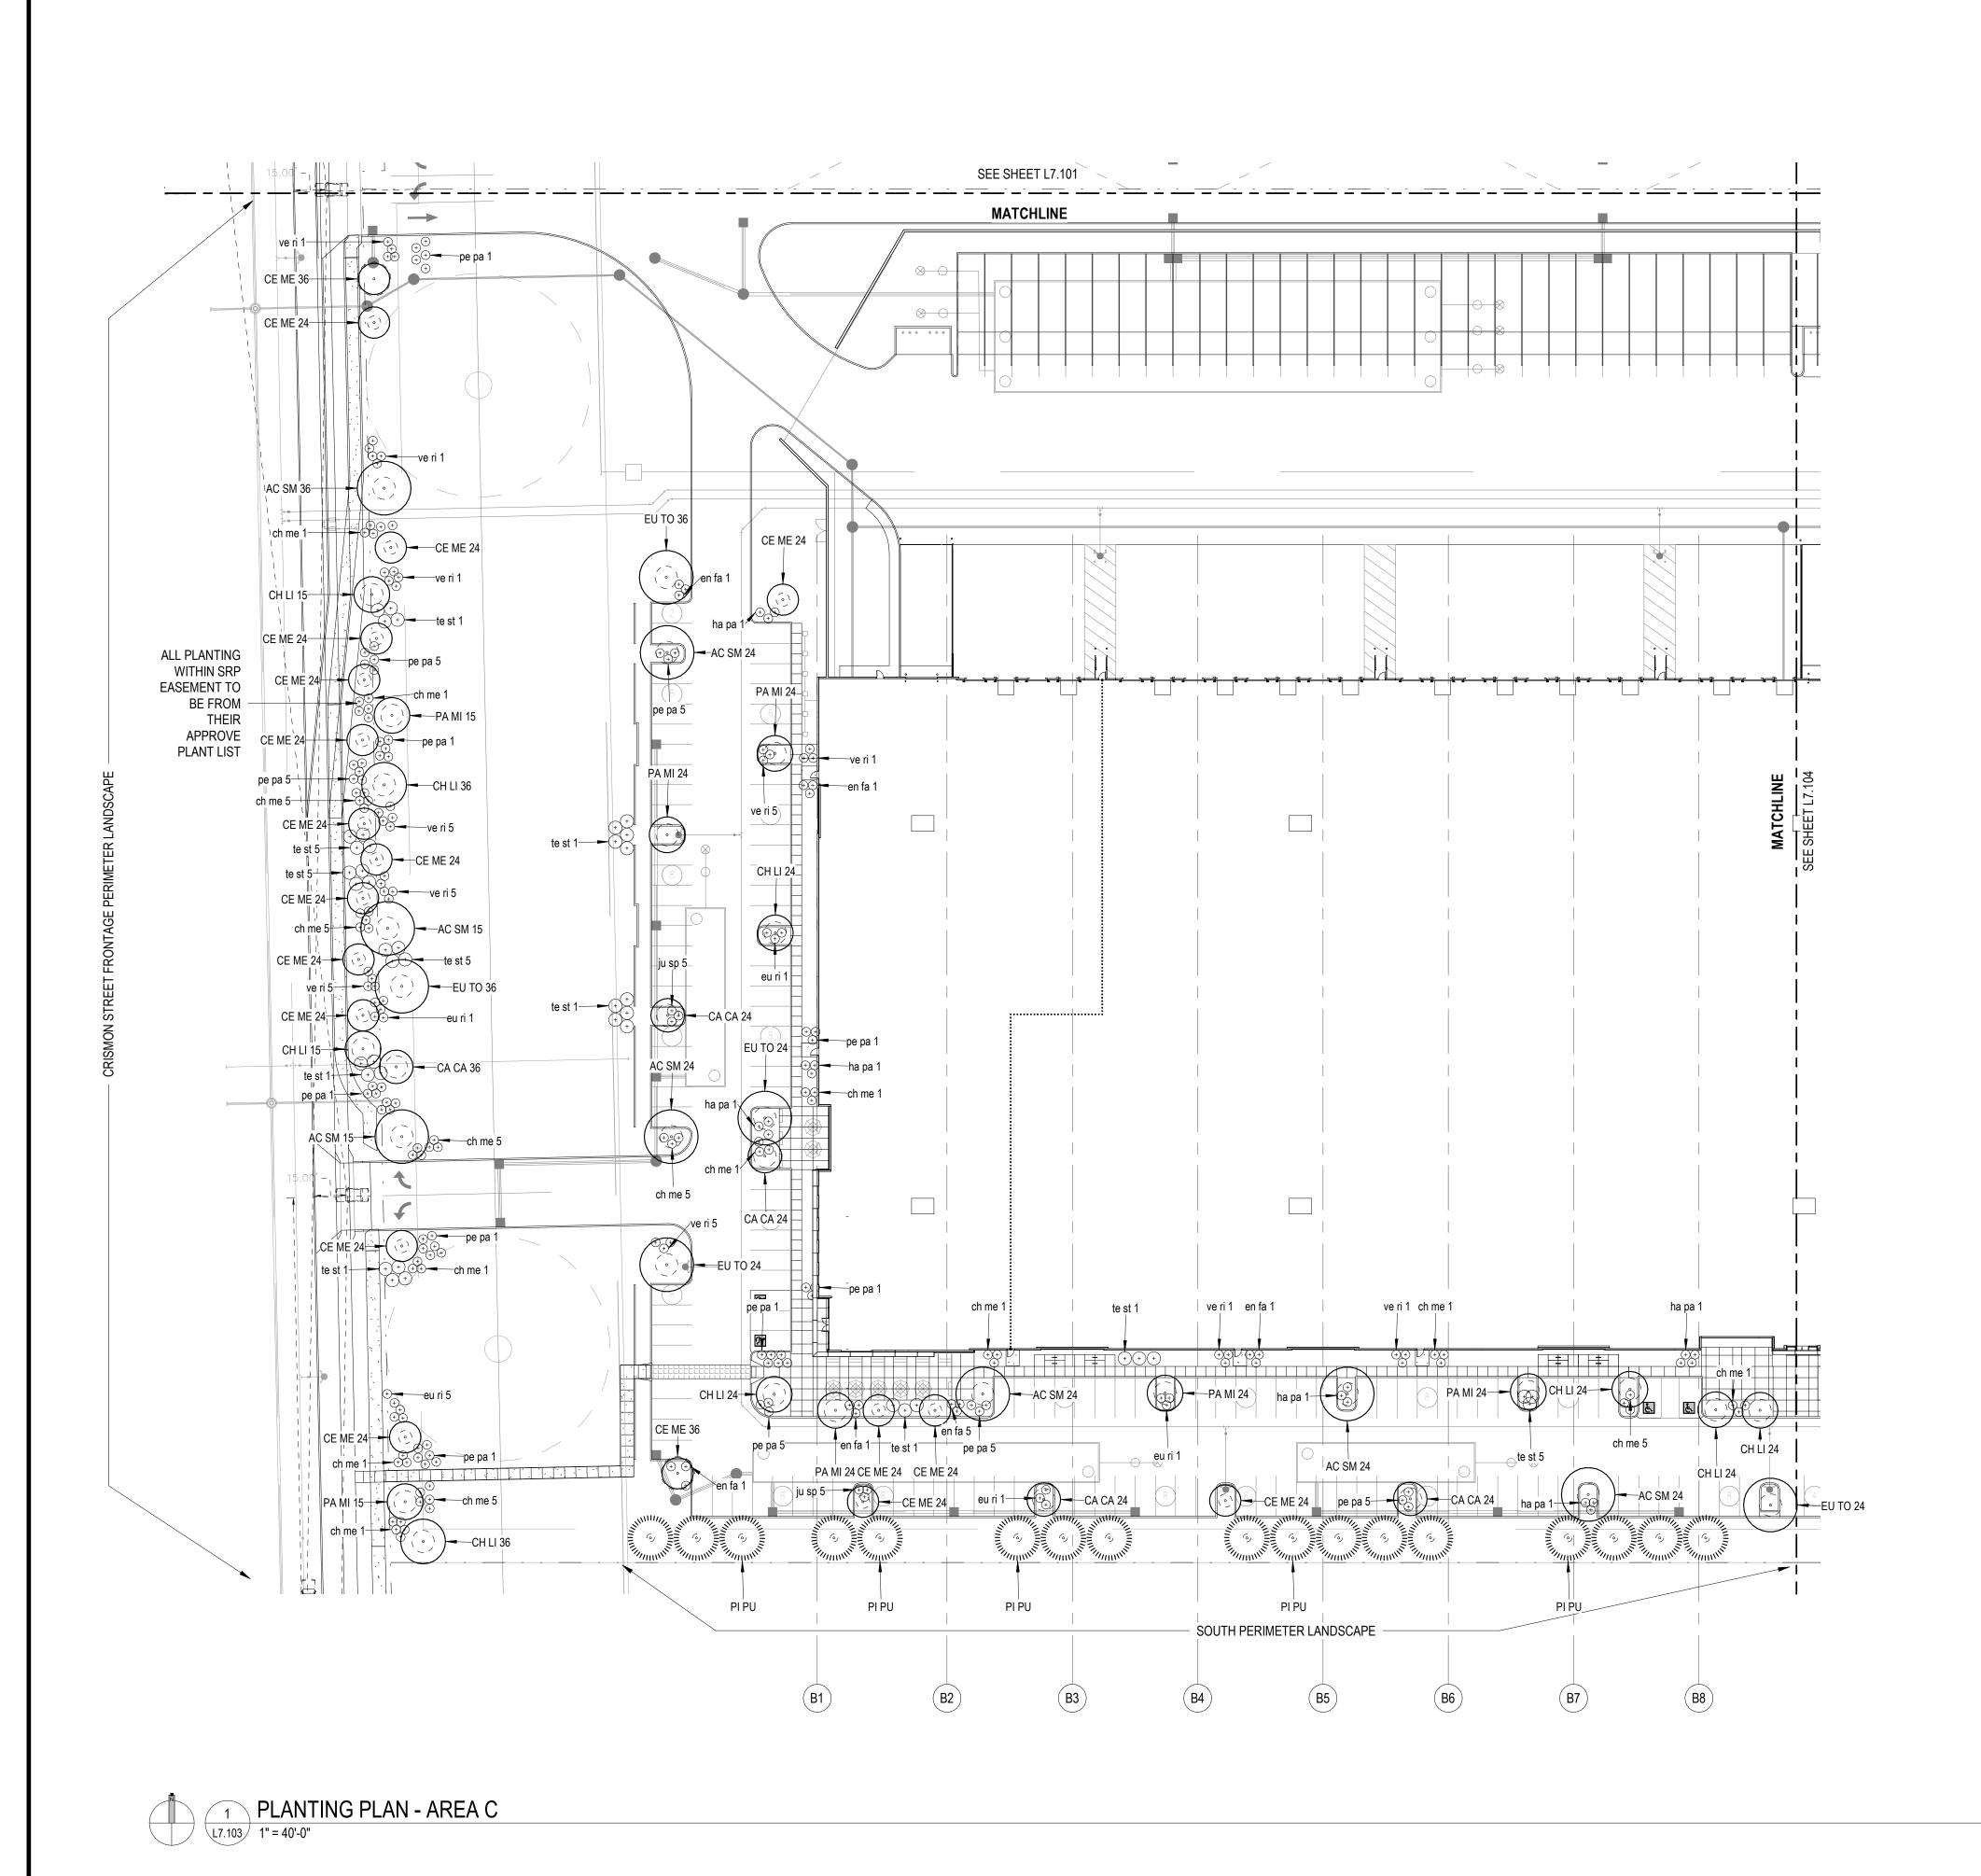

<u>CITY OF MESA GENERAL NOTES FOR LANDSCAPE PLAN</u>

AN INSPECTION 48 HOURS IN ADVANCE.

- 1. LANDSCAPE CONTRACTOR SHALL CONFIRM LOCATION OF ALL UNDERGROUND UTILITIES PRIOR TO
- ANY EXCAVATION AND SHALL BE RESPONSIBLE FOR THE FOLLOWING:
- 2. DAMAGES TO SUCH UTILITIES CAUSED AS A RESULT OF THE CONTRACTOR'S ACTIVITIES. 3. DAMAGES TO EXISTING WALKS, WALLS, DRIVES, CURBS, ETC.
- 4. INSPECTING THE SITE IN ORDER TO BE FULLY AWARE OF EXISTING CONDITIONS PRIOR TO SUBMITTING A BID.
- 2. INSTALLATION OF ALL LANDSCAPE AND IRRIGATION MATERIALS SHALL COMPLY WITH SECTIONS 424, 425, 757, AND 795 OF THE MAG STANDARD SPECIFICATIONS.
- 3. CONTRACTOR SHALL REPAIR ANY DAMAGE MADE TO THE EXISTING SPRINKLER SYSTEM TO THE
- SATISFACTION OF THE CITY AT NO ADDITIONAL COST TO THE CITY. 4. LANDSCAPE REMOVAL IS A NON-PAY ITEM UNLESS OTHERWISE NOTED.
- 5. ALL EXISTING VEGETATION, WEEDS, DEBRIS, ETC. NOTED TO BE REMOVED ON THE PLANS AND SPECIFICATIONS SHALL BE REMOVED FROM PROJECT AREA AND DISPOSED OF PROPERLY OFF THE SITE AT THE CONTRACTOR'S EXPENSE (SCARIFY EXISTING SUBGRADE, MINIMUM SIX (6) INCHES DEPTH).
- 6. DAMAGE TO TURF SHALL BE REPAIRED BY CONTRACTOR, I.E., RUTS FILLED WITH CLEAN SOIL, COMPACTED TO MATCH SURROUNDING GRADES, EXCESS SOIL, ROCK, ETC. SHALL BE REMOVED TO LEAVE THE SITE CLEAN.
- 7. ALL PLANT MATERIAL, OTHER THAN TREES, SHALL CONFORM TO GRADING, TYPE, ETC. AS SET FORTH IN THE <u>AMERICAN STANDARD FOR NURSERY STOCK</u> BY THE AMERICAN ASSOCIATION OF NURSERYMEN. ALL TREES SHALL CONFORM TO THE CURRENT <u>ARIZONA NURSERY ASSOCIATION TREE SPECIFICATIONS</u> AND MAG SPEC 795.7. SHOULD ANY CONFLICTS IN THE SPECIFICATIONS OCCUR, THE ARIZONA NURSERY ASSOCIATION'S SPECIFICATIONS SHALL PREVAIL.
- 8. CITY RESERVES THE RIGHT TO INSPECT SHRUBS AND CONTAINERED TREES FOR CONDITION OF ROOT BALLS. FOR ANY SUCH INSPECTIONS WHICH MAY DESTROY ROOTBALL, CONTRACTOR SHALL SUPPLY
- ADDITIONAL PLANT AT NO COST TO CITY. 9. PLANT PITS SHALL BE INSPECTED BY CITY PRIOR TO PLANTING BY THE CONTRACTOR BY REQUESTING
- 10. ROUGH AND FINE GRADING TO ESTABLISH UNIFORM SMOOTH GRADE IS INCLUDED IN THIS PROJECT. 11. SOIL TEST FOR FERTILITY AND ADDITIVE RECOMMENDATIONS (FOR TURF AND ORNAMENTALS) SHALL BE COMPLETED BY CONTRACTOR TO DETERMINE IF ADDITIVES ARE REQUIRED. CONTRACTOR SHALL PROVIDE COPY OF SOIL TEST RESULTS FOR REVIEW AND APPROVAL TO ENGINEERING INSPECTOR AT LEAST SEVEN (7) DAYS PRIOR TO ANTICIPATED PLANTING. AFTER APPROVAL BY THE CITY, THE CONTRACTOR SHALL PROVIDE AND INCORPORATE ANY ADDITIVES REQUIRED PRIOR TO OR AT TIME OF
- 12. PLANT PIT SOIL MIXTURE SHALL CONSIST OF FOUR AND ONE-HALF PARTS NATURAL FERTILE, FRIABLE SOIL AND ONE PART HUMUS BY VOLUME, THOROUGHLY MIXED PRIOR TO BACKFILLING IN PITS. BACKFILLING SHALL BE IN 6" LIFTS WITH EACH LIFT WATER SETTLED WITHOUT PUDDLING. 13. CONTRACTOR SHALL STAKE TREE AND SHRUB LOCATIONS FOR 5-GALLON PLANTS AND LARGER. STAKES SHALL BE MARKED WITH PLANT NAME OR PLANT LEGEND ITEM NUMBER FROM PLANS. 14. ALL EXISTING (GAS, ELECTRIC, WATER, ETC.) COVERS AND BOXES SHALL REMAIN UNCOVERED. CONTRACTOR TO ADJUST TO FINAL GRADE AS NECESSARY. NON-PAY ITEM (NPI) UNLESS OTHERWISE
- 15. THE CONTRACTOR SHALL BE RESPONSIBLE FOR LOCATING THE UNDERGROUND SPRINKLER SYSTEMS 3 IN ADVANCE OF CONSTRUCTION. THE SPRINKLER SYSTEM LOCATIONS NOTED ON PLANS ARE FOR
- REFERENCE ONLY. 16. CONTRACTOR TO VERIFY DEPTH OF ALL INLET STRUCTURES AND SPRINKLER SYSTEMS PRIOR TO
- TRENCHING FOR LOW-FLOW CHANNEL. 17. CONTRACTOR TO PROVIDE PUMPING WITHIN FIVE (5) DAYS AFTER THE NOTICE TO PROCEED IS GIVEN
- AS REQUIRED TO DRY THE AREA SUFFICIENTLY TO BEGIN CONSTRUCTION.
- 18. CONTRACTOR SHALL ARRANGE FOR SPRINKLER SYSTEM SHUTDOWN DURING CONSTRUCTION BY CONTACTING THE ENGINEERING INSPECTOR.
- 19. NO ROCKS LARGER THAN 1" IN DIAMETER SHALL BE ALLOWED IN THE TOP SIX (6) INCHES OF TOPSOIL WHERE TURF ESTABLISHMENT IS SPECIFIED. ROCK REMOVAL AS NECESSARY IS A NON-PAY (NPI) ITEM UNLESS OTHERWISE NOTED.
- 20. WHERE CALICHE IS ENCOUNTERED IN PLANT PITS, DEPTH AND WIDTH OF PIT SHALL BE INCREASED BY ONE-THIRD (1/3) OVER SPECIFICATION, AND A LIQUID PENETRATOR, "AL-KALICHE" OR EQUAL, SHALL BE INCORPORATED FOR EACH PIT PER MANUFACTURER'S RECOMMENDATIONS.
- 21. CONTRACTOR SHALL INSTALL DECOMPOSED GRANITE TO A ROLLED DEPTH PER THE APPROVED PLANS AND SPECIFICATIONS. DECOMPOSED GRANITE SHALL BE PER THE APPROVED PLANS AND SPECIFICATIONS WITH THE COLOR AS SPECIFIED ON THE PLANS. PRE-EMERGENT HERBICIDE SHALL BE APPLIED BEFORE AND AFTER PLACEMENT OF DECOMPOSED GRANITE PER THE MANUFACTURER'S RECOMMENDATIONS. PRE-EMERGENT HERBICIDE SHALL BE SURFLAN, DACTHAL, OR APPROVED EQUAL. SAMPLE TO BE PROVIDED FOR CITY REVIEW AND APPROVAL. CONTRACTOR SHALL WASH OFF ROCK
- MULCH ONCE FINAL PLACEMENT HAS OCCURRED. 22. RESTORE ALL EXISTING LANDSCAPE IRRIGATION SYSTEMS, COMPONENTS AND LANDSCAPE AREAS IMPACTED BY ANY WORK UNDER THIS CONTRACT. RESTORE ALL EXISTING IRRIGATION AND LANDSCAPE IN ACCORDANCE WITH THE LANDSCAPE RESTORATION NOTES INDICATED WITHIN THESE DOCUMENTS. AT A MINIMUM, ALL RESTORATION SHALL BE IN ACCORDANCE WITH M.A.G. SPECIFICATION 107.9 - PROTECTION AND RESTORATION OF PROPERTY AND LANDSCAPE. ALL RESTORATION WORK SHALL BE COMPLETED TO THE SATISFACTION OF THE CITY OF MESA ENGINEER.
- 23. ALL RESTORATION WORK SHALL BE COMPLETED IN ACCORDANCE WITH THE REFERENCED DETAILS AND ANY ADDITIONAL DETAILS PROVIDED.
- 24. REFER TO LANDSCAPE PLANTING SHEETS AND ENGINEERING DRAWINGS FOR ADDITIONAL RESTORATION NOTES AND REQUIRED COORDINATION.

		TREE LEGEN	ID	
Code	Botanical Name	Cultivar	Common Name	,
AC SM 15	Acacia smallii		Sweet Acacia	15 0
AC SM 24	Acacia smallii		Sweet Acacia	24" E
AC SM 36	Acacia smallii		Sweet Acacia	36" I
CA CA 24	Caesalpinia cacalaco	'Smoothie'	Thornless Cascalote	24" I
CA CA 36	Caesalpinia cacalaco	'Smoothie'	Thornless Cascalote	36" I
CE ME 24	Cercis mexicana		Mexican Redbud	24" I
CE ME 36	Cercis mexicana		Mexican Redbud	36" I
CH LI 15	Chilopsis Linearis		Desert Willow	15 G
CH LI 24	Chilopsis Linearis		Desert Willow	24" E
CH LI 36	Chilopsis Linearis		Desert Willow	36" E
EU TO 24	Eucalyptus torquata		Coral Gum	24" E
EU TO 36	Eucalyptus torquata		Coral Gum	36" I
PA MI 15	Parkinsonia microphylla		Foothill Palo Verde	15 G
PA MI 24	Parkinsonia microphylla		Foothill Palo Verde	24" I
PA MI 36	Parkinsonia microphylla		Foothill Palo Verde	36" I
PI PU	Pinus cembroides		Mexican Pinon Pine	15 G

1110	i iildə delilbi oldes		MCXIGATT ITIOTT ITIC	TO O/ (L.	NOTE: NUM
	S	HRUB LEGENI	D		IN PLANT C
Code	Botanical Name	Cultivar	Common Name	Size	PLANT SIZE
					NOT QUANT
ch me 1	Chrysactinia mexicana Chrysactinia mexicana		Damianita Daisy	1 Gal	
ch me 5	Chrysactinia mexicana Chrysactinia mexicana		Damianita Daisy	5 Gal.	

ch me 1	Chrysactinia mexicana Chrysactinia mexicana		Damianita Daisy	1 Gal
ch me 5	Chrysactinia mexicana Chrysactinia mexicana		Damianita Daisy	5 Gal.
en fa 1	Encelia farinosa		Brittlebush	1 Gal
en fa 5	Encelia farinosa		Brittlebush	5 Gal.
eu ri 1	euphorbia rigida		Gopher Plant	1 Gal
eu ri 5	euphorbia rigida		Gopher Plant	5 Gal.
ha pa 1	Hamelia patens	'Sierra Red'	Fire Bush	1 Gal
ha pa 5	Hamelia patens	'Sierra Red'	Fire Bush	5 Gal.
ju sp 1	Justicia spicigera		Mexican Honeysuckle	1 Gal
ju sp 5	Justicia spicigera		Mexican Honeysuckle	5 Gal.
pe pa 1	Penstemon parryi		Parry's Penstemon	1 Gal
pe pa 5	Penstemon parryi		Parry's Penstemon	5 Gal.
te st 1	Tecoma stans	'Gold Star'	Yellow Bells	1 Gal
te st 5	Tecoma stans	'Gold Star'	Yellow Bells	5 Gal.
ve ri 1	verbena rigida		Sandpaper Verbena	1 Gal
ve ri 5	verbena rigida		Sandpaper Verbena	5 Gal.

Lamar Johnson

Collaborative 7 ST. LOUIS, MISSOURI 63114 Ph 314.429.1010




 $\mathbf{\Omega}$ DRAWING ISSUE

DESCRIPTION DATE 03.21.2022 DESIGN REVIEW 1st REVIEW COMMENTS 04/22/2022 DRAWING TITLE

PLANTING PLAN - AREA C

DRAWING NO. L7.103

Job# 20.005838

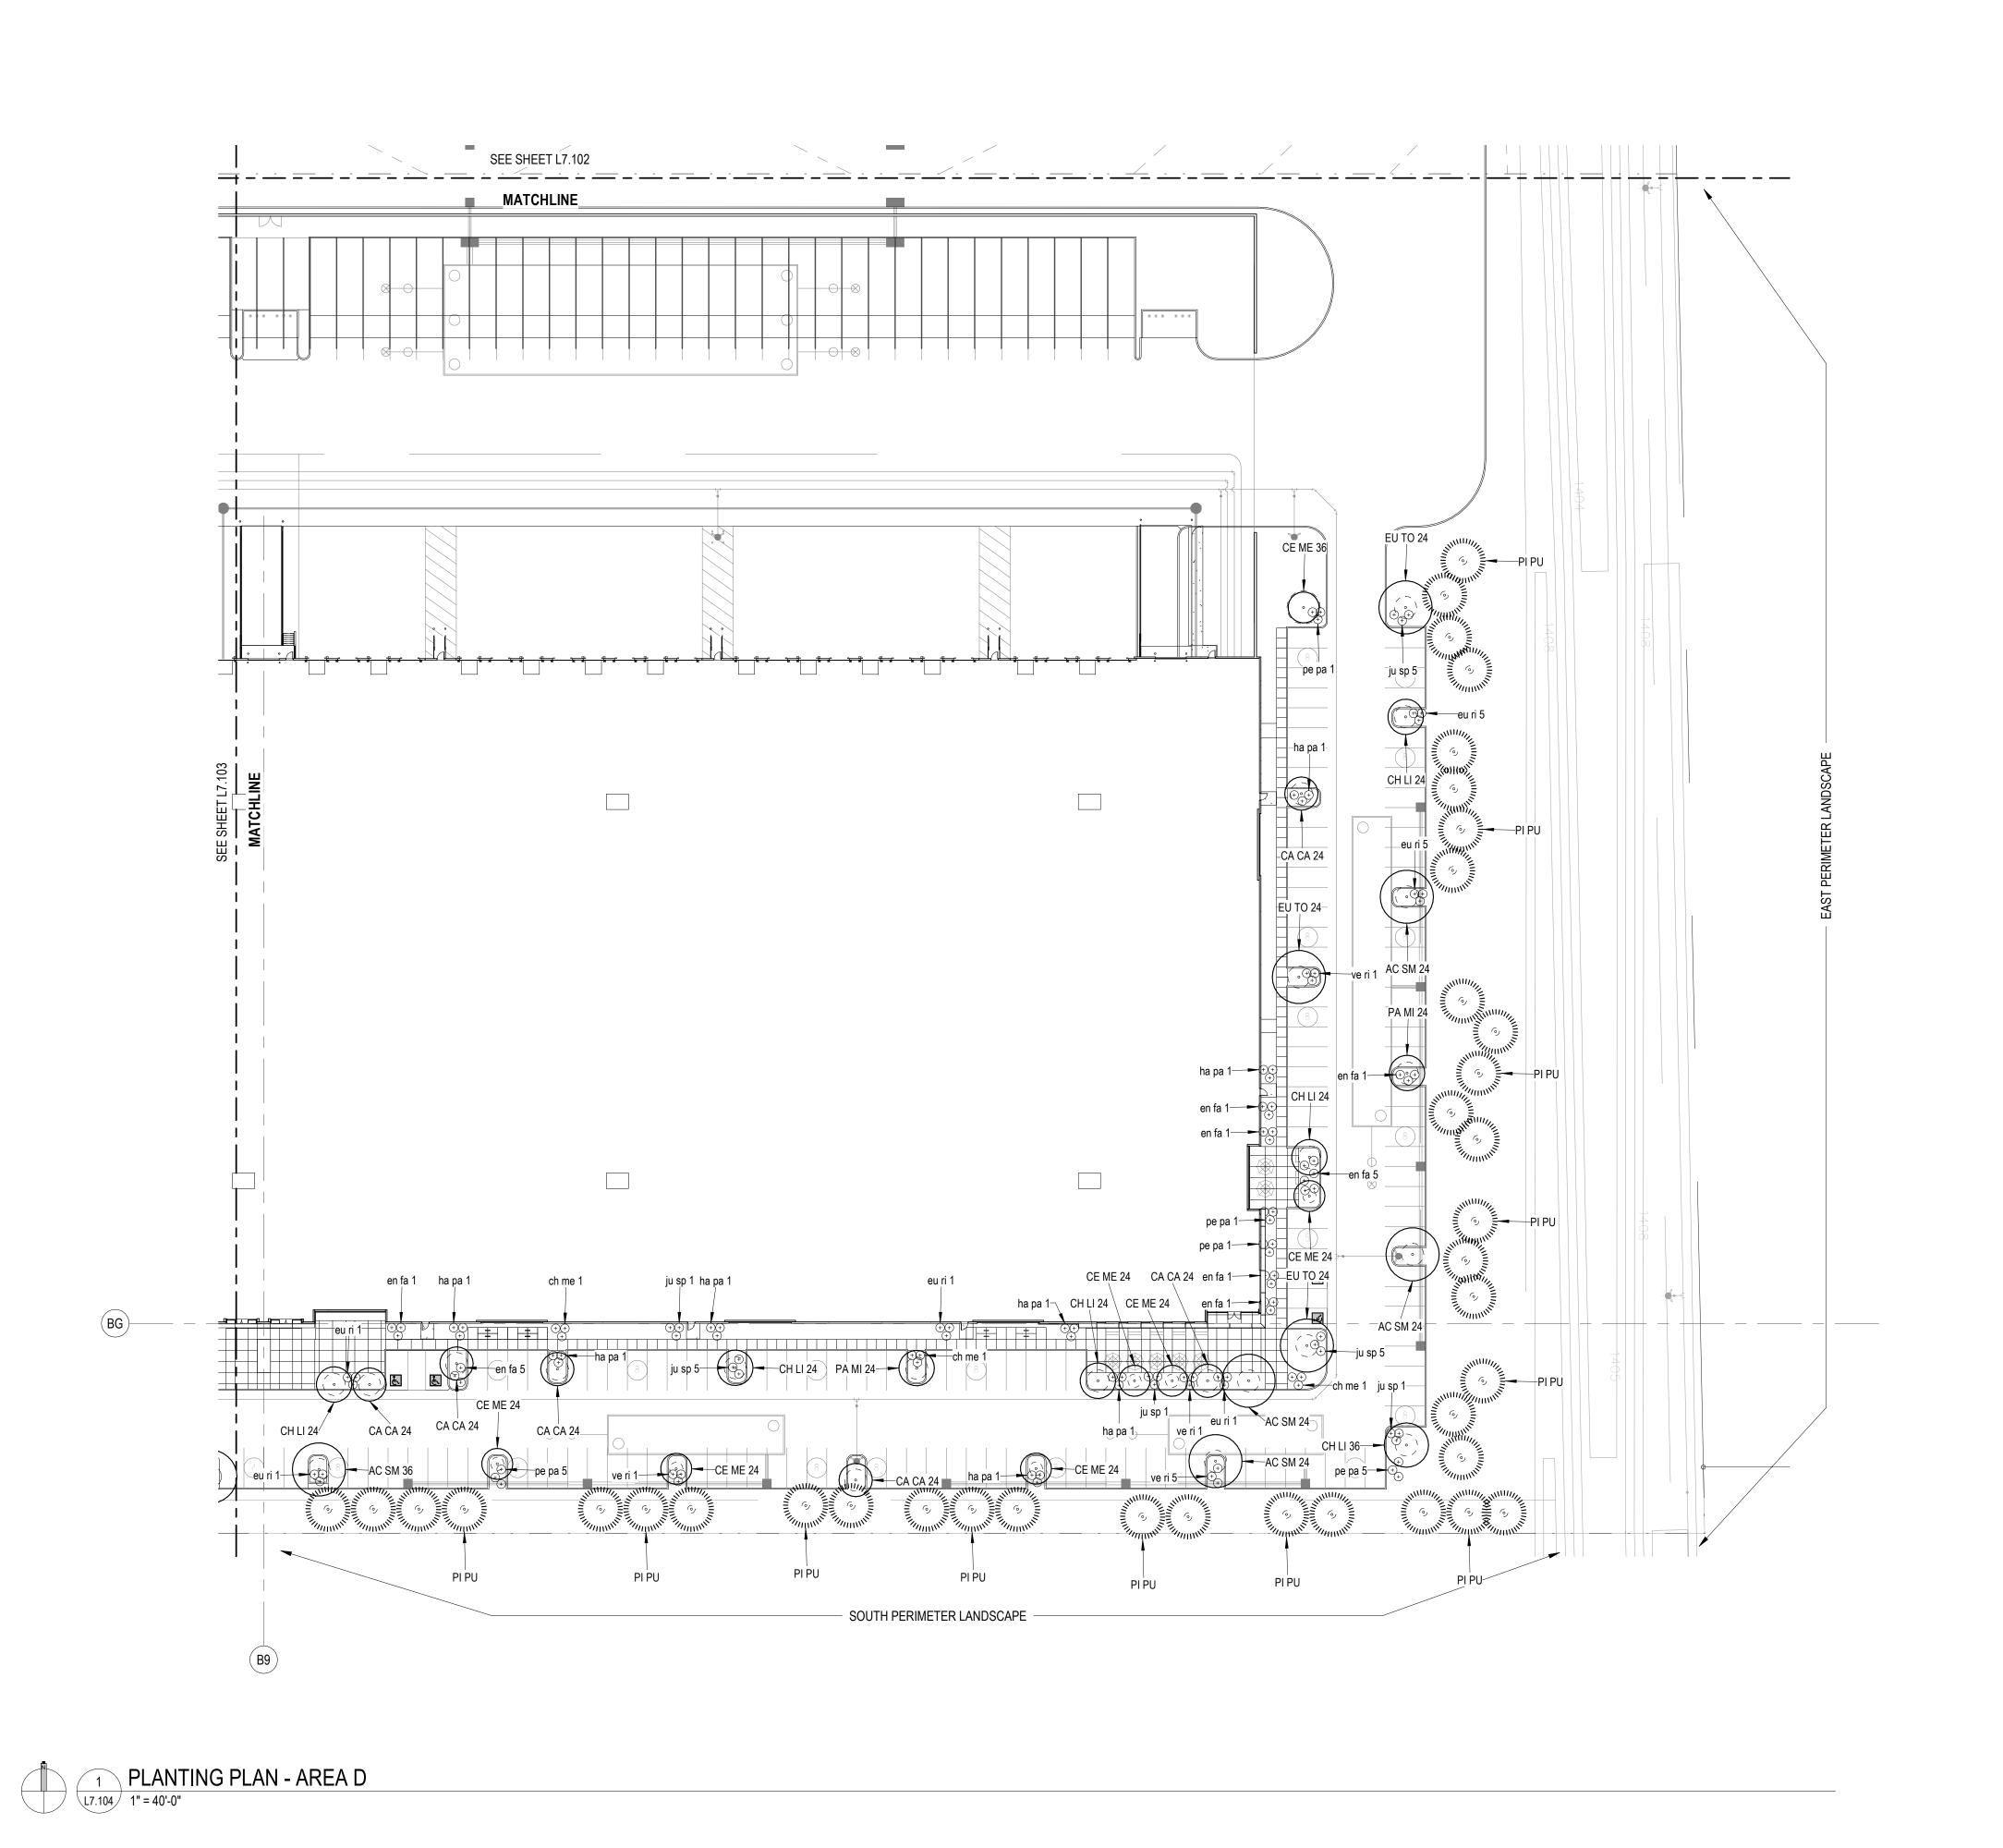

CITY OF MESA GENERAL NOTES FOR LANDSCAPE PLAN

- 1. LANDSCAPE CONTRACTOR SHALL CONFIRM LOCATION OF ALL UNDERGROUND UTILITIES PRIOR TO ANY EXCAVATION AND SHALL BE RESPONSIBLE FOR THE FOLLOWING:
- 2. DAMAGES TO SUCH UTILITIES CAUSED AS A RESULT OF THE CONTRACTOR'S ACTIVITIES.
- 3. DAMAGES TO EXISTING WALKS, WALLS, DRIVES, CURBS, ETC.
- SUBMITTING A BID. 2. INSTALLATION OF ALL LANDSCAPE AND IRRIGATION MATERIALS SHALL COMPLY WITH SECTIONS 424,

4. INSPECTING THE SITE IN ORDER TO BE FULLY AWARE OF EXISTING CONDITIONS PRIOR TO

- 425, 757, AND 795 OF THE MAG STANDARD SPECIFICATIONS.
- 3. CONTRACTOR SHALL REPAIR ANY DAMAGE MADE TO THE EXISTING SPRINKLER SYSTEM TO THE
- SATISFACTION OF THE CITY AT NO ADDITIONAL COST TO THE CITY. 4. LANDSCAPE REMOVAL IS A NON-PAY ITEM UNLESS OTHERWISE NOTED.
- 5. ALL EXISTING VEGETATION, WEEDS, DEBRIS, ETC. NOTED TO BE REMOVED ON THE PLANS AND SPECIFICATIONS SHALL BE REMOVED FROM PROJECT AREA AND DISPOSED OF PROPERLY OFF THE SITE AT THE CONTRACTOR'S EXPENSE (SCARIFY EXISTING SUBGRADE, MINIMUM SIX (6) INCHES DEPTH). 6. DAMAGE TO TURF SHALL BE REPAIRED BY CONTRACTOR, I.E., RUTS FILLED WITH CLEAN SOIL,
- COMPACTED TO MATCH SURROUNDING GRADES, EXCESS SOIL, ROCK, ETC. SHALL BE REMOVED TO LEAVE THE SITE CLEAN. 7. ALL PLANT MATERIAL, OTHER THAN TREES, SHALL CONFORM TO GRADING, TYPE, ETC. AS SET FORTH
- IN THE <u>AMERICAN STANDARD FOR NURSERY STOCK</u> BY THE AMERICAN ASSOCIATION OF NURSERYMEN. ALL TREES SHALL CONFORM TO THE CURRENT <u>ARIZONA NURSERY ASSOCIATION TREE SPECIFICATIONS</u> AND MAG SPEC 795.7. SHOULD ANY CONFLICTS IN THE SPECIFICATIONS OCCUR, THE ARIZONA NURSERY ASSOCIATION'S SPECIFICATIONS SHALL PREVAIL.
- 8. CITY RESERVES THE RIGHT TO INSPECT SHRUBS AND CONTAINERED TREES FOR CONDITION OF ROOT BALLS. FOR ANY SUCH INSPECTIONS WHICH MAY DESTROY ROOTBALL, CONTRACTOR SHALL SUPPLY ADDITIONAL PLANT AT NO COST TO CITY.
- 9. PLANT PITS SHALL BE INSPECTED BY CITY PRIOR TO PLANTING BY THE CONTRACTOR BY REQUESTING AN INSPECTION 48 HOURS IN ADVANCE.
- 10. ROUGH AND FINE GRADING TO ESTABLISH UNIFORM SMOOTH GRADE IS INCLUDED IN THIS PROJECT. 11. SOIL TEST FOR FERTILITY AND ADDITIVE RECOMMENDATIONS (FOR TURF AND ORNAMENTALS) SHALL BE COMPLETED BY CONTRACTOR TO DETERMINE IF ADDITIVES ARE REQUIRED. CONTRACTOR SHALL PROVIDE COPY OF SOIL TEST RESULTS FOR REVIEW AND APPROVAL TO ENGINEERING INSPECTOR AT LEAST SEVEN (7) DAYS PRIOR TO ANTICIPATED PLANTING. AFTER APPROVAL BY THE CITY, THE CONTRACTOR SHALL PROVIDE AND INCORPORATE ANY ADDITIVES REQUIRED PRIOR TO OR AT TIME OF
- 12. PLANT PIT SOIL MIXTURE SHALL CONSIST OF FOUR AND ONE-HALF PARTS NATURAL FERTILE, FRIABLE SOIL AND ONE PART HUMUS BY VOLUME, THOROUGHLY MIXED PRIOR TO BACKFILLING IN PITS. BACKFILLING SHALL BE IN 6" LIFTS WITH EACH LIFT WATER SETTLED WITHOUT PUDDLING. 13. CONTRACTOR SHALL STAKE TREE AND SHRUB LOCATIONS FOR 5-GALLON PLANTS AND LARGER. STAKES SHALL BE MARKED WITH PLANT NAME OR PLANT LEGEND ITEM NUMBER FROM PLANS. 14. ALL EXISTING (GAS, ELECTRIC, WATER, ETC.) COVERS AND BOXES SHALL REMAIN UNCOVERED. CONTRACTOR TO ADJUST TO FINAL GRADE AS NECESSARY. NON-PAY ITEM (NPI) UNLESS OTHERWISE
- 15. THE CONTRACTOR SHALL BE RESPONSIBLE FOR LOCATING THE UNDERGROUND SPRINKLER SYSTEMS 3 IN ADVANCE OF CONSTRUCTION. THE SPRINKLER SYSTEM LOCATIONS NOTED ON PLANS ARE FOR
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- TRENCHING FOR LOW-FLOW CHANNEL. 17. CONTRACTOR TO PROVIDE PUMPING WITHIN FIVE (5) DAYS AFTER THE NOTICE TO PROCEED IS GIVEN
- AS REQUIRED TO DRY THE AREA SUFFICIENTLY TO BEGIN CONSTRUCTION. 18. CONTRACTOR SHALL ARRANGE FOR SPRINKLER SYSTEM SHUTDOWN DURING CONSTRUCTION BY
- CONTACTING THE ENGINEERING INSPECTOR. 19. NO ROCKS LARGER THAN 1" IN DIAMETER SHALL BE ALLOWED IN THE TOP SIX (6) INCHES OF TOPSOIL
- WHERE TURF ESTABLISHMENT IS SPECIFIED. ROCK REMOVAL AS NECESSARY IS A NON-PAY (NPI) ITEM UNLESS OTHERWISE NOTED.
- 20. WHERE CALICHE IS ENCOUNTERED IN PLANT PITS, DEPTH AND WIDTH OF PIT SHALL BE INCREASED BY ONE-THIRD (1/3) OVER SPECIFICATION, AND A LIQUID PENETRATOR, "AL-KALICHE" OR EQUAL, SHALL BE INCORPORATED FOR EACH PIT PER MANUFACTURER'S RECOMMENDATIONS.
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- MULCH ONCE FINAL PLACEMENT HAS OCCURRED. 22. RESTORE ALL EXISTING LANDSCAPE IRRIGATION SYSTEMS, COMPONENTS AND LANDSCAPE AREAS THE SATISFACTION OF THE CITY OF MESA ENGINEER.
- 23. ALL RESTORATION WORK SHALL BE COMPLETED IN ACCORDANCE WITH THE REFERENCED DETAILS AND ANY ADDITIONAL DETAILS PROVIDED.

24.	REFER TO LANDSCAPE PLANTING SHEETS AND ENGINEERING DRAWINGS FOR ADI	DITIONA
RES	STORATION NOTES AND REQUIRED COORDINATION.	
	TREE LEGEND	

		IREE LEGEN	טו	
Code	Botanical Name	Cultivar	Common Name	S
AC SM 15	Acacia smallii		Sweet Acacia	15 G
AC SM 24	Acacia smallii		Sweet Acacia	24" E
AC SM 36	Acacia smallii		Sweet Acacia	36" E
CA CA 24	Caesalpinia cacalaco	'Smoothie'	Thornless Cascalote	24" E
CA CA 36	Caesalpinia cacalaco	'Smoothie'	Thornless Cascalote	36" E
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CH LI 15	Chilopsis Linearis		Desert Willow	15 G
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EU TO 24	Eucalyptus torquata		Coral Gum	24" E
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PA MI 15	Parkinsonia microphylla		Foothill Palo Verde	15 G
PA MI 24	Parkinsonia microphylla		Foothill Palo Verde	24" E
PA MI 36	Parkinsonia microphylla		Foothill Palo Verde	36" E
PI PU	Pinus cembroides		Mexican Pinon Pine	15 G

SHRUB LEGEND								
Code	Botanical Name	Cultivar	Common Name	Size				

Code	Botanicai Name	Cuitivar	Common Name	Size
ch me 1	Chrysactinia mexicana Chrysactinia mexicana		Damianita Daisy	1 Gal
ch me 5	Chrysactinia mexicana Chrysactinia mexicana		Damianita Daisy	5 Gal.
en fa 1	Encelia farinosa		Brittlebush	1 Gal
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te st 5	Tecoma stans	'Gold Star'	Yellow Bells	5 Gal.
ve ri 1	verbena rigida		Sandpaper Verbena	1 Gal
ve ri 5	verbena rigida		Sandpaper Verbena	5 Gal.

NOTE: NUMBER IN PLANT CODE INDICATED PLANT SIZE, **NOT QUANTITY**

Lamar Johnson Collaborative 7

ST. LOUIS, MISSOURI 63114 Ph 314.429.1010



DRAWING ISSUE DATE DESCRIPTION 03.21.2022 DESIGN REVIEW 1st REVIEW COMMENTS 04/22/2022

DRAWING TITLE PLANTING PLAN - AREA D

DRAWING NO.

Job# 20.005838

POTTED PERENNIAL /

ORNAMENTAL GRASS PLANT

GC AND PERENNIAL SOIL

COMPACTED SUBGRADE

QUANTITY OF GROUNDCOVER AND SPACING AS

NOTED IN PLANTING SCHEDULE

PERENNIAL AND GRASS PLANTING L7.301 / 1/2" = 1'-0"

PLACED AFTER

KEEP MULCH 2"

AWAY FROM

PLANT BASE

PLANTING.

ORDINANCE REQUIREMENTS

	BUILDING	A		BUILDING B	
	(1) SHADE TREES	11-33-3 - PERIMETER LA S / 25 LF - 25% 36" BOX, 50% 24" E	ANDSCAPING - STREET FR BOX, 25% 15-GAL. + (6) SHRUBS		AL .
STREET FRONTAGE - NORTH 1300'	REQUIRED TREES 52	REQUIRED SHRUBS 312	STREET FRONTAGE 600'	REQUIRED TREES 24	REQUIRED SHRUBS
	PROPOSED TREES (13) 36" BOX (26) 24" BOX (13) 15-GAL.	PROPOSED SHRUBS (156) 5-GAL. (156) 1-GAL.		PROPOSED TREES (6) 36" BOX (12) 24" BOX (6) 15-GAL.	PROPOSED SHRUBS (77) 5-GAL. (77) 1-GAL.
STREET FRONTAGE - WEST 650'	REQUIRED TREES 26 PROPOSED TREES (7) 36" BOX (13) 24" BOX (6) 15-GAL.	REQUIRED SHRUBS 156 PROPOSED SHRUBS (78) 5-GAL. (78) 1-GAL.			

11-33-3 - PERIMETER LANDSCAPING - SIDE YARD

FRONTAGE - EAST	REQUIRED TREES	REQUIRED SHRUBS	FRONTAGE - EAST	REQUIRED TREES	REQUIRED SHRUBS
680'	21	60 - ASSUMES 300 LF VISIBLE FROM ROAD	608'	19	0 - NOT VISIBLE FROM ROAD
	PROPOSED TREES	PROPOSED SHRUBS		PROPOSED TREES	PROPOSED SHRUBS
	(21) 15-GAL.	(60) 1-GAL.		(19) 15-GAL.	(0)
			FRONTAGE - SOUTH	REQUIRED TREES	REQUIRED SHRUBS
			1175'	36	0 - NOT VISIBLE FROM ROAD
				PROPOSED TREES	PROPOSED SHRUBS
				(36) 15-GAL.	(0)

11-33-4 - INTERIOR PARKING LOT LANDSCAPING

(1) SHADE TREES / ISLAND - 10% 36" BOX, 90% 24" BOX + (3) SHRUBS / ISLAND - 50% 5-GAL, 50% 1-GAL

PARKING ISLANDS	REQUIRED TREES	REQUIRED SHRUBS	PARKING ISLANDS
48	49	147	46
	PROPOSED TREES	PROPOSED SHRUBS	
	(5) 36" BOX (44) 24" BOX	(73) 1-GAL. (74) 5-GAL.	
			ON LANDSCAPING

(1) SHADE TREES / 50 LF OF EXTERIOR WALL - 10% 36" BOX, 90% 24" BOX + SHRUBS FOR 33% OF WALL LENGTH - 100% 1-GAL

REQUIRED TREES	REQUIRED SHRUBS	BUILDING LENGTH	REQUIRED TREES	REQUIRED SHRUBS
31	166 ASSUMES 3' PER SHRUB = 497 LF	1560' TOTAL ALONG EAST, SOUTH AND WEST FACADES	31	166 ASSUMES 3' PER SHRUB = 497 LF
PROPOSED TREES	PROPOSED SHRUBS		PROPOSED TREES	PROPOSED SHRUBS
(20) IN ADJACENT PARKING ISLANDS (11) 24" BOX	(60) IN ADJACENT PARKING ISLANDS (106) 1-GAL.		(20) IN ADJACENT PARKING ISLANDS (11) 24" BOX	(60) IN ADJACENT PARKING ISLANDS (106) 1-GAL.
	91 PROPOSED TREES (20) IN ADJACENT PARKING ISLANDS	31 166 ASSUMES 3' PER SHRUB = 497 LF PROPOSED TREES PROPOSED SHRUBS (20) IN ADJACENT PARKING ISLANDS 166 ASSUMES 3' PER SHRUB = 497 LF PROPOSED SHRUBS (60) IN ADJACENT PARKING ISLANDS	31 166 ASSUMES 3' PER SHRUB = 497 LF PROPOSED TREES PROPOSED SHRUBS (20) IN ADJACENT PARKING ISLANDS 1560' TOTAL ALONG EAST, SOUTH AND WEST FACADES (60) IN ADJACENT PARKING ISLANDS	31 166 ASSUMES 3' PER SHRUB = 497 LF PROPOSED TREES PROPOSED SHRUBS (20) IN ADJACENT PARKING ISLANDS 1560' TOTAL ALONG EAST, SOUTH AND WEST FACADES PROPOSED TREES (20) IN ADJACENT PARKING ISLANDS 1560' TOTAL ALONG EAST, SOUTH AND WEST FACADES (20) IN ADJACENT PARKING ISLANDS

WEST & EAST FOUNDATION LANDSCAPE AREAS (BOTH BUILDINGS A AND B): 330 LF FRONTAGE (INCLUDES CORNER LANDSCAPE AREA) 30 FT BASE = 75LF = 22% OF FRONTAGE X 30FT = 6.6FT

12 FT BASE = 255LF = 73% OF FRONTAGE X 12FT = 8.7 FT

FOUNDATION BASE AVERAGE DEPTH = 16.65 FT > 15 FEET MINIMUM

NORTH FOUNDATION (BUILDING A) & SOUTH FOUNDATION (BUILDING B) LANDSCAPE AREAS: *900 LF FRONTAGE* 30 FT BASE = 344LF = 32% OF FRONTAGE X 30FT = 9.6 FT 27 FT BASE = 18LF = 5% OF FRONTAGE X 27FT = 1.35 FT

27 FT BASE = 54LF = 6% OF FRONTAGE X 27LF = 1.62 FT 12 FT BASE = 556LF = 62% OF FRONTAGE X 12FT = 7.44 FT AVERAGE 11.4 + 7.44 = 18.66 FT > 15 FEET MINIMUM

REQUIRED TREES

45

PROPOSED TREES

(5) 36" BOX

(40) 24" BOX


REQUIRED SHRUBS

135

PROPOSED SHRUBS

(67) 1-GAL.

(68) 5-GAL.

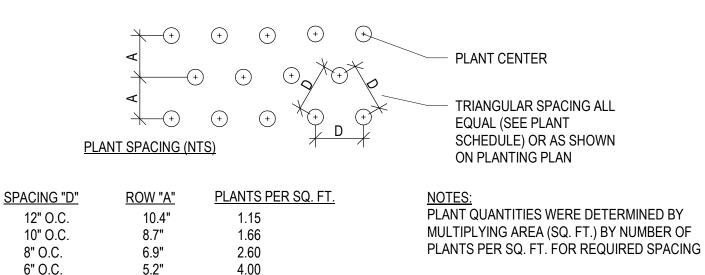

6" O.C. QUANTITY OF GROUNDCOVER AND SPACING AS NOTED IN PLANTING SCHEDULE D = ON CENTER DIMENSION AS NOTED ON PLAN/SCHEDULE A = 0.86 OF DIMENSION "X" SET PLANT ENTIRELY IN FINISH GRADE SEE PLANT SCHEDULE PLANTING SOIL MIX. TOP OF FOR SPACING ROOT MASS SHALL BE AT FINISH GRADE 2" D.G. MULCH POTTED GROUNDCOVER PLANT PLACED AFTER PLANTING. GC AND PERENNIAL SOIL PER SPECIFICATIONS, ROTOTILL **KEEP MULCH 2"** TO A DEPTH OF 6" PRIOR TO ANY SPRINKLER WORK AWAY FROM PLANT BASE BACKFILL WITH NATIVE SOIL. APPLY FERTILIZER TO

GA GROUND COVER PLANTING \L7.301\textstyle 1/2" = 1'-0"

PLANT SCHEDULE

8" O.C.

	_					_	_
Type Mark	Count	Botanical Name	Cultivar	Common Name	Method	Size	Comments
AC SM 15	9	Acacia smallii		Sweet Acacia	Container	15 GAL.	
AC SM 24	21	Acacia smallii		Sweet Acacia	Container	24" BOX	
AC SM 36	7	Acacia smallii		Sweet Acacia	Container	36" BOX	
CA CA 24	28	Caesalpinia cacalaco	'Smoothie'	Thornless Cascalote	Container	24" BOX	
CA CA 36	5	Caesalpinia cacalaco	'Smoothie'	Thornless Cascalote	Container	36" BOX	
CE ME 24	40	Cercis mexicana		Mexican Redbud	Container	24" BOX	
CE ME 36	5	Cercis mexicana		Mexican Redbud	Container	36" BOX	
CH LI 15	7	Chilopsis Linearis		Desert Willow	Container	15 GAL.	
CH LI 24	37	Chilopsis Linearis		Desert Willow	Container	24" BOX	
CH LI 36	7	Chilopsis Linearis		Desert Willow	Container	36" BOX	
EU TO 24	17	Eucalyptus torquata		Coral Gum	Container	24" BOX	
EU TO 36	5	Eucalyptus torquata		Coral Gum	Container	36" BOX	
PA MI 15	6	Parkinsonia microphylla		Foothill Palo Verde	Container	15 GAL.	
PA MI 24	21	Parkinsonia microphylla		Foothill Palo Verde	Container	24" BOX	
PA MI 36	4	Parkinsonia microphylla		Foothill Palo Verde	Container	36" BOX	
PI PU	76	Pinus cembroides		Mexican Pinon Pine	Container	15 GAL.	NON-DECIDUOU

SURFACE AWAY FROM TRUNK PER SPECIFICATIONS


COMPACTED SUBGRADE

			Sł	HRUBS			
Code	Count	Botanical Name	Cultivar	Common Name	Method	Size	Landscape Comments
ch me 1	114	Chrysactinia mexicana Chrysactinia mexicana		Damianita Daisy	Container	1 Gal	
ch me 5	46	Chrysactinia mexicana Chrysactinia mexicana		Damianita Daisy	Container	5 Gal.	
en fa 1	82	Encelia farinosa		Brittlebush	Container	1 Gal	
en fa 5	49	Encelia farinosa		Brittlebush	Container	5 Gal.	
eu ri 1	81	euphorbia rigida		Gopher Plant	Container	1 Gal	
eu ri 5	46	euphorbia rigida		Gopher Plant	Container	5 Gal.	
ha pa 1	69	Hamelia patens	'Sierra Red'	Fire Bush	Container	1 Gal	
ha pa 5	3	Hamelia patens	'Sierra Red'	Fire Bush	Container	5 Gal.	
ju sp 1	39	Justicia spicigera		Mexican Honeysuckle	Container	1 Gal	
ju sp 5	30	Justicia spicigera		Mexican Honeysuckle	Container	5 Gal.	
pe pa 1	107	Penstemon parryi		Parry's Penstemon	Container	1 Gal	
ре ра 5	98	Penstemon parryi		Parry's Penstemon	Container	5 Gal.	
te st 1	156	Tecoma stans	'Gold Star'	Yellow Bells	Container	1 Gal	
te st 5	64	Tecoma stans	'Gold Star'	Yellow Bells	Container	5 Gal.	
ve ri 1	123	verbena rigida		Sandpaper Verbena	Container	1 Gal	
ve ri 5	81	verbena rigida		Sandpaper Verbena	Container	5 Gal.	

NOTE: NUMBER IN PLANT CODE INDICATED PLANT SIZE, NOT QUANTITY.

PLANTING NOTES

- 1. CONTRACTOR IS RESPONSIBLE FOR ALL RELATED EXISTING CONDITIONS, PIPES AND STRUCTURES, ETC. PRIOR TO BIDDING AND CONSTRUCTION.
- 2. REF. SPECIFICATIONS AND DETAILS FOR PLANTING METHODS, REQUIREMENTS, SOIL TESTING, MATERIALS, EXECUTION AND PLAN PROTECTION. 3. PLANT NAMES MAY BE ABBREVIATED ON DRAWINGS. REFER TO PLANTING SCHEDULE AND LEGENDS FOR SYMBOLS, ABBREVIATIONS, BOTANICAL AND COMMON NAMES, SIZES, ESTIMATED QUANTITIES AND OTHER REMARKS.
- 4. WHERE PROVIDED, AREA TAKEOFFS AND PLANT QUANTITY ESTIMATES IN PLANTING SCHEDULE ARE FOR INFORMATION ONLY. CONTRACTOR IS RESPONSIBLE TO DO THEIR OWN QUANTITY TAKEOFFS FOR ALL PLANT MATERIAL AND SIZES SHOWN ON THE DRAWINGS. IN CASE OF DISCREPANCIES
- TO THE ATTENTION OF THE LANDSCAPE ARCHITECT FOR CLARIFICATION. 5. CONTRACTOR IS RESPONSIBLE TO 'RESTORE' ALL AREAS OF THE SITE, OR ADJACENT AREAS, WHERE DISTURBED TO A CONDITION THAT MEETS OR EXCEEDS THE CONDITIONS PRIOR TO THE DISTURBANCE.
- 6. ALL PLANTS SHALL BE GUARANTEED FOR ONE FULL YEAR FROM THE SUBSTANTIAL COMPLETION OF THE LANDSCAPE CONTRACT AT FULL
- REPLACEMENT VALUE INCLUDING LABOR TO REPLACE PLANT MATERIALS. 7. ALL PLANT MATERIAL SHALL BE OF SPECIMEN QUALITY AND OF THE SIZE AND TYPE SPECIFIED IN THE PLANT SCHEDULE.
- 8. THE SITE SHALL BE FINISH GRADED BY THE LANDSCAPE CONTRACTOR. THE LANDSCAPE CONTRACTOR SHALL BE RESPONSIBLE TO MAINTAIN
- FINISHED GRADES AND RE-GRADE ANY AREAS DISTURBED BY LANDSCAPE OPERATIONS.
- 9. ANY CLEAN, EXCESS SOIL FROM LANDSCAPE OPERATIONS SHALL BE WASTED ON SITE AT THE DISCRETION OF THE CONTRACTOR OR DISPOSED OF OFF SITE. ALL CONSTRUCTION DEBRIS FROM LANDSCAPE OPERATIONS SHALL BE DISPOSED OF OFF SITE.
- 10. ALL PLANTING AREAS MUST BE FREE OF ALL WEEDS AND DEBRIS BEFORE PLANTING, SODDING, AND/OR SEEDING.
- 11. ALL LANDSCAPE MATERIALS INSTALLED SHALL BE MAINTAINED BY OWNER OR LEASEE IN ACCORDANCE WITH THE APPROVED LANDSCAPE PLAN. 12. ALL NON-PAVED AREAS WITHIN SITE BOUNDARIES SHALL BE COVERED IN 1/2" DECOMPOSED GRANITE, AT 2" DEPTH PER ZONING ORDINANCE. A
- PRE-EMERGENT HERBICIDE SHALL BE APLIED TO THE GROUND PRIOR TO PLACEMENT OF DECOMPOSED GRANITE TO PREVENT WEED GROWTH. 13. SIGHT TRIANGLES AT INTERSECTIONS TO BE KEPT CLEAR OF TREES AND TALL SHRUBS.
- 14. NO SHRUBS WITH A MATURE HEIGHT OF 3' OR GREATER TO BE INSTALLED WITHIN 10' OF CURB ON R.O.W. 15. ALL TREES SHALL COMPLY WITH LATEST AMENDED EDITION OF THE A.N.A. RECOMMENDED TREE SPECIFICATIONS.
- 16. SEE CIVIL FOR SIGNAGE

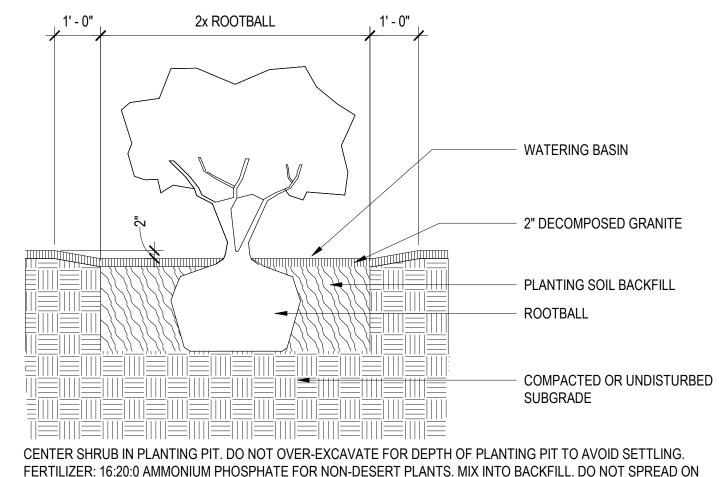


TOP OF SOIL

- PLANT PITS SHALL NOT BE AUGER DUG. SIDES OF PIT SHALL BE RAKED TO LOOSEN PRIOR TO SETTING SHRUB IN PITS.
- GENTLY LOOSEN ROOTS AROUND EXTERIOR OF ROOTBALL.
- DO NOT PLANT ROOT BOUND PLANTS. NOTIFY LANDSCAPE ARCHITECT IMMEDIATELY TO VERIFY CONDITION OF PLANT IF ANY QUESTION.
- REMOVE ENTIRE CONTAINER FROM ALL PLANTS PRIOR TO PLANTING.
- DO NOT PRUNE NEW PLANTS WITHOUT LANDSCAPE ARCHITECT APPROVAL/DIRECTION.

B4 SHRUB PLANTING

L7.301 1/2" = 1'-0"

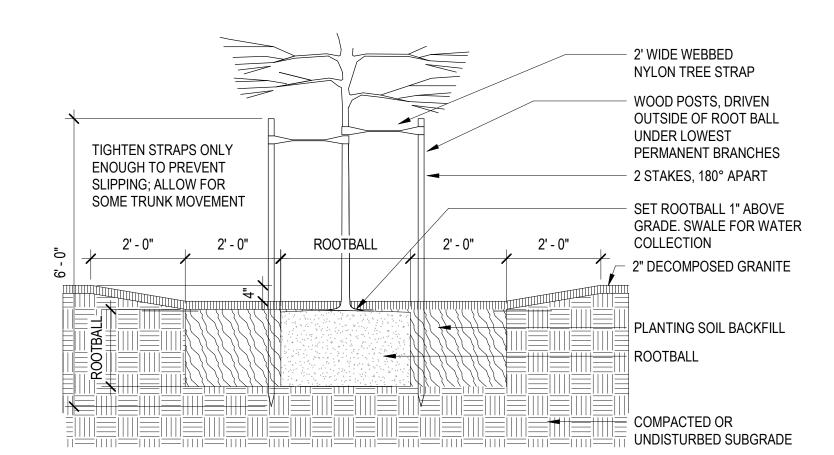

1. TREES TO BE STAKED ONLY AS SPECIFIED. SEE PLANT SCHEDULE.

2. STAKES SHALL BE REMOVED NO LATER THAN THE END OF FIRST GROWING SEASON AFTER PLANTING.

- SIDES OF PLANTING PITS ARE TO BE LOOSENED OR RAKED BEFORE SETTING TREE IN PIT. EXCAVATE DEPTH OF PLANTING PIT TO THE SAME DEPTH AS THE ROOTBALL.
- THE WIDTH OF THE PLANTING PIT SHALL BE 2X THE WIDTH OF THE ROOTBALL. GENTLY LOOSEN ROOTS AROUND THE EXTERIOR OF ROOTBALL. CENTER TREE IN PLANTING PIT.
- INSPECT ROOT BALLS AT POINT OF PURCHASE TO AVOID PURCHASE OF ROOTBOUND MATERIALS REMOVE ENTIRE CONTAINER FROM ALL PLANTS PRIOR TO PLANTING.
- NEW TREES SHALL NOT BE PRUNED UNLESS DIRECTED BY OWNER.
- FORM SWALE AROUND EACH TREE AS SHOWN FOR WATER COLLECTION REMOVE ALL NURSERY STAKES.

BACKFILL NOTES:

- PROVIDE MULCH AMENDMENT WITH BACKFILL FOR ALL NON-DESERT TREES.
- BACKFILL MIX SHALL CONSIST OF 3 PARTS NATIVE SOIL TO 1 PART MULCH. PROVIDE 1 CUP GYPSUM IN BOTTOM OF PLANTING PIT.
- INCLUDE 16:20:0 AMMONIUM PHOSPHATE FERTILIZER IN PLANTING PIT FOR NON-DESERT TREES. MIX INTO BACKFILL. DO NOT SPREAD ON TOP OF SOIL.

- USE 2-2" DIA. LODGE POLE STAKES-DOUGLAS FIR OR APPROVED HARDWOOD.
- DRIVE STAKE MIN. 12" INTO FIRM UNDISTURBED SOIL BELOW THE EXCAVATED DEPTH. PLACE STAKES OUTSIDE THE ROOTBALL
- HEIGHT OF STAKE MAY VARY DEPENDING ON NEED FOR SUPPORT.
- PLACE THE TOP TIE FOR MAXIMUM SUPPORT. THE BOTTOM TIE SHOULD BE APPROXIMATELY
- HALFWAY BETWEEN THE TOP TIE AND THE GROUND.
- ALWAYS PLACE STAKE TO PREVENT DAMAGE TO TREE AND CAMBIUM.

- REMOVE ALL PLASTIC TREE TIE TAPE, BAMBOO NURSERY STAKE, WIRE TIES, AND LABELS FROM TREES AFTER THEY HAVE BEEN APPROVED.
- BACKFILL ANY HOLES LEFT IN ROOTBALL FROM NURSERY STAKES. BACKFILL SHALL BE CLEAN SOIL,
- SWALE SHALL BE A SMOOTH TRANSITION- NO ABRUPT GRADE CHANGES. SWALE SHALL BE TESTED FOR WATER HOLDING CAPACITY PRIOR TO PLACING D.G.
- PROVIDE ADDITIONAL WIRE HOSE TIE WHEN THE TREE IS NOT RIGIDLY SUPPORTED BY THE TWO
- REQUIRED SUPPORTS.
- 2" D.G. TOP LAYER ALSO SUITABLE.

B1 TREE PLANTING AND STAKING - SINGLE TRUNK

Lamar Johnson Collaborative 1

2199 INNERBELT BUSINESS CENTER DRIVE ST. LOUIS, MISSOURI 63114 Ph 314.429.1010



DRAWING ISSUE

DESCRIPTION DESIGN REVIEW 03.21.2022 1st REVIEW COMMENTS 04/22/2022

DRAWING TITLE PLANTING DETAILS AND

SCHEDULE

DRAWING NO.

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