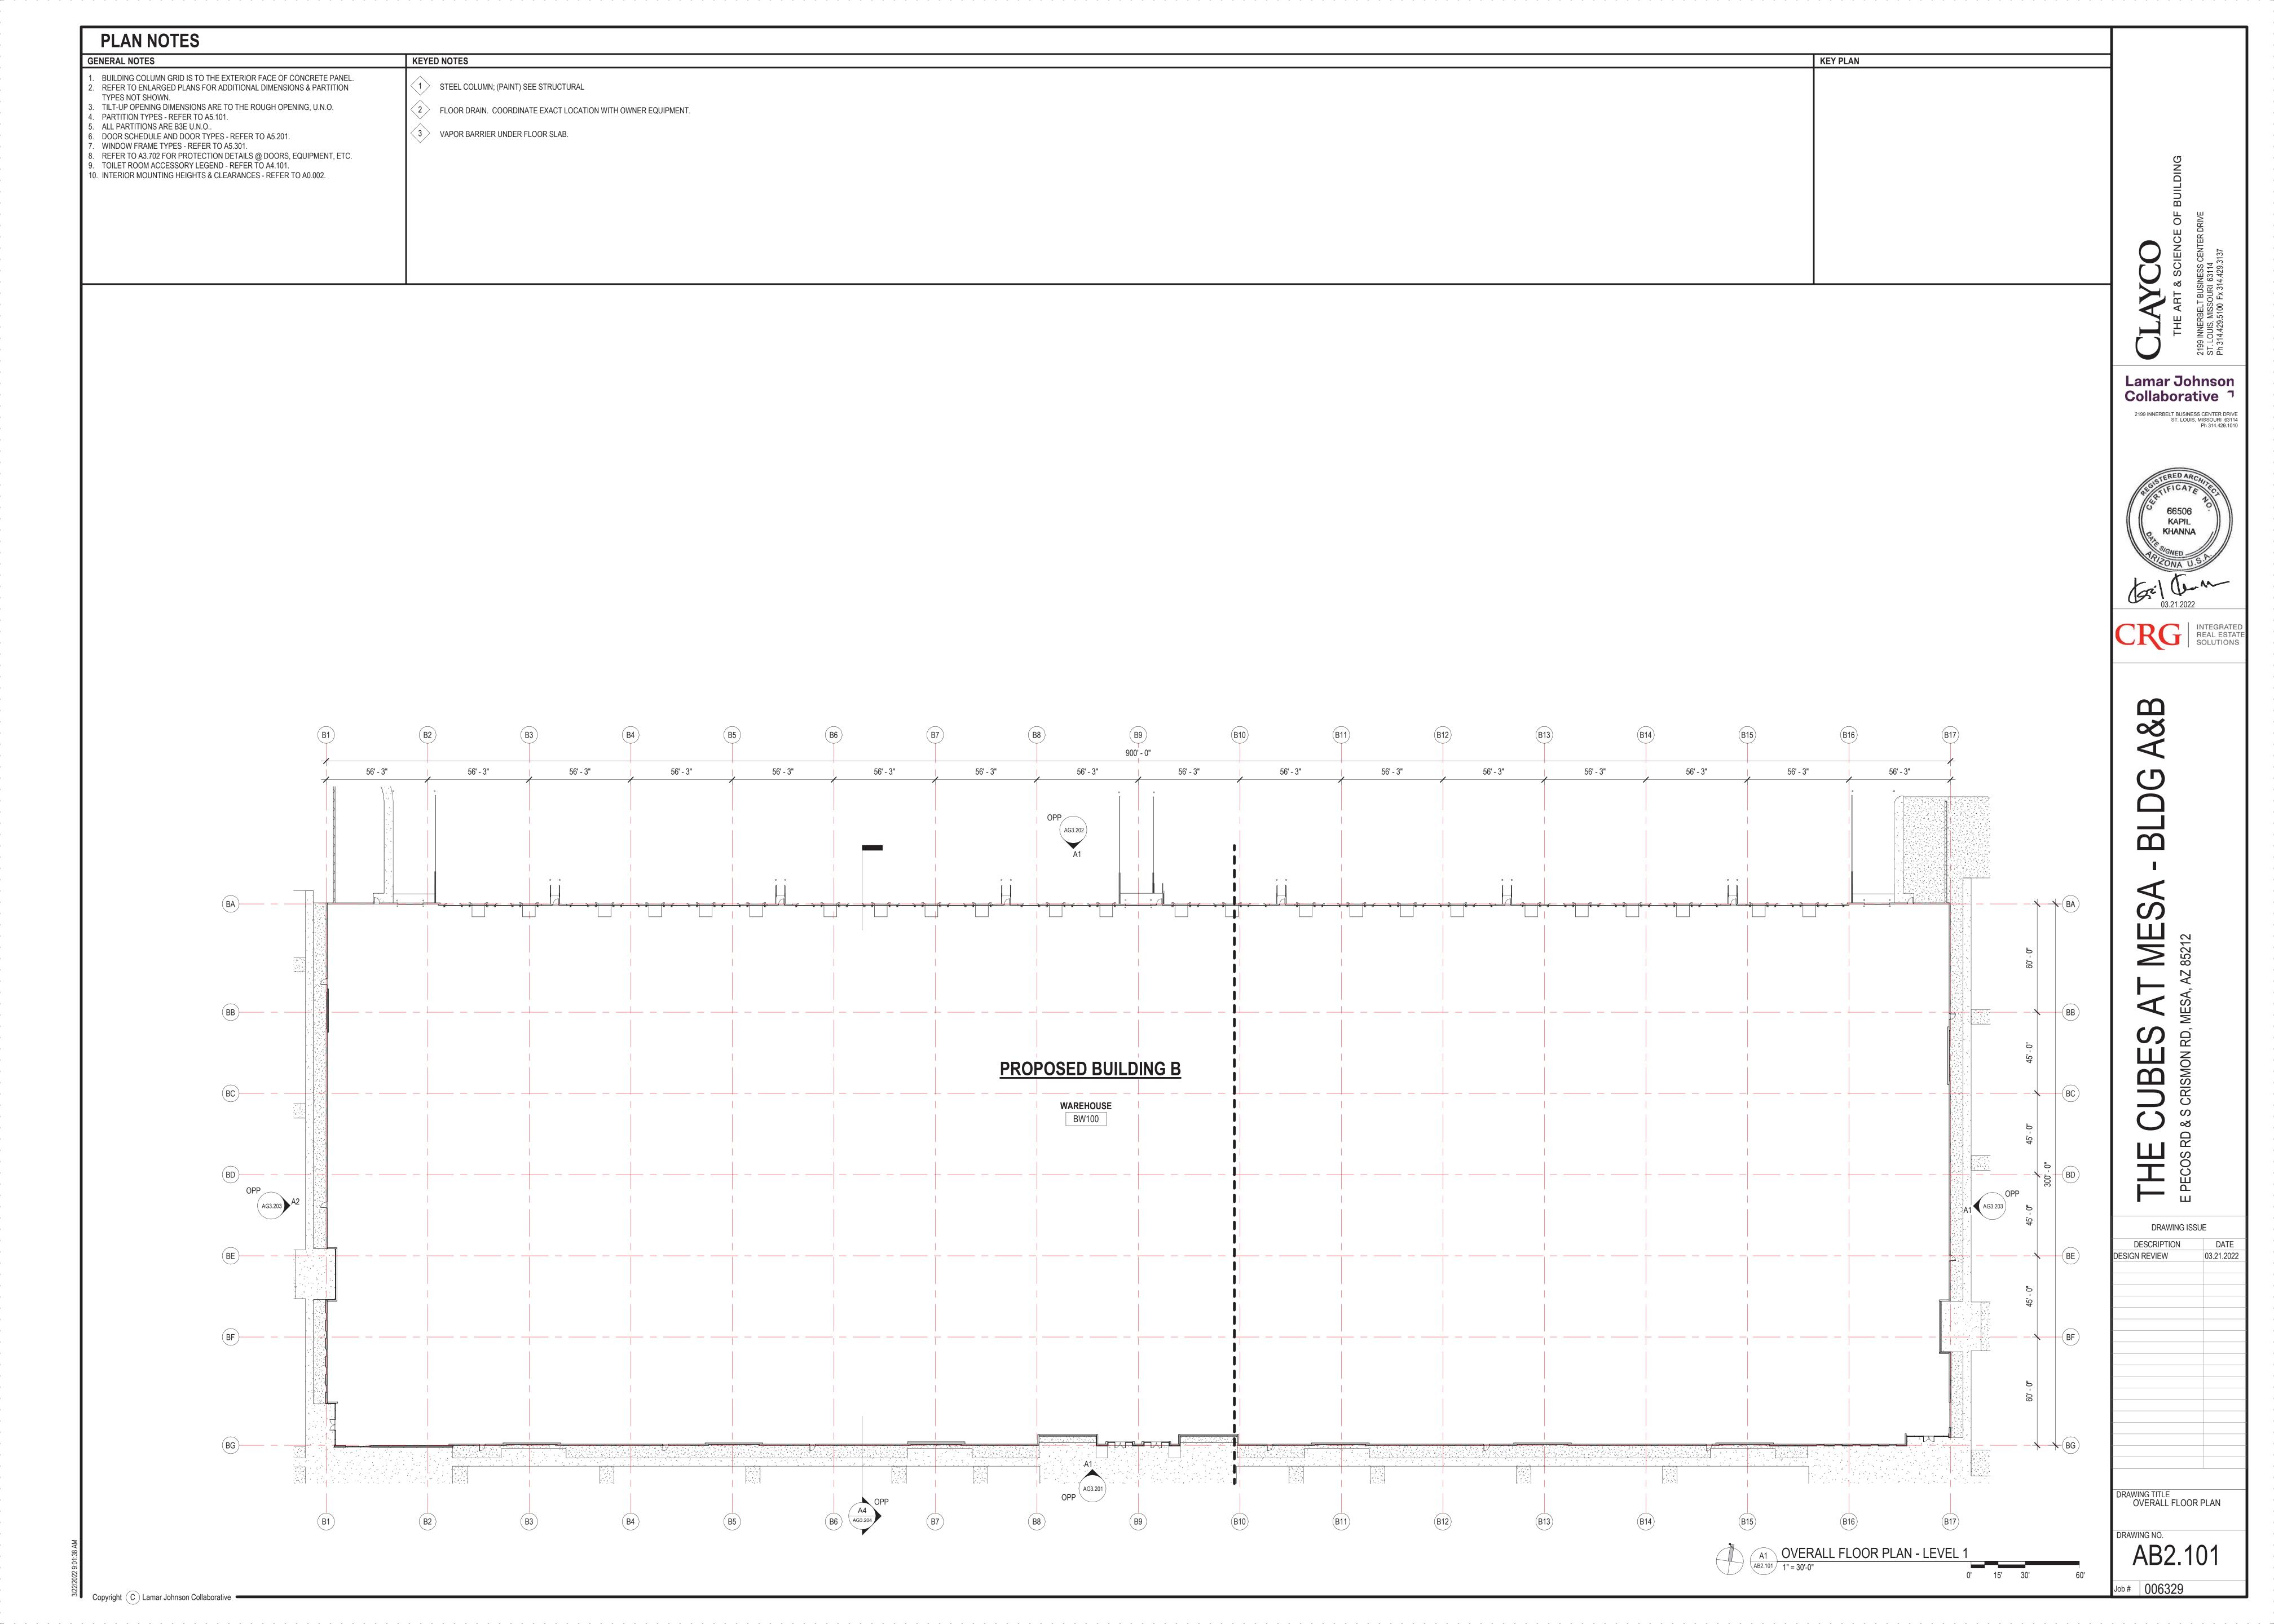
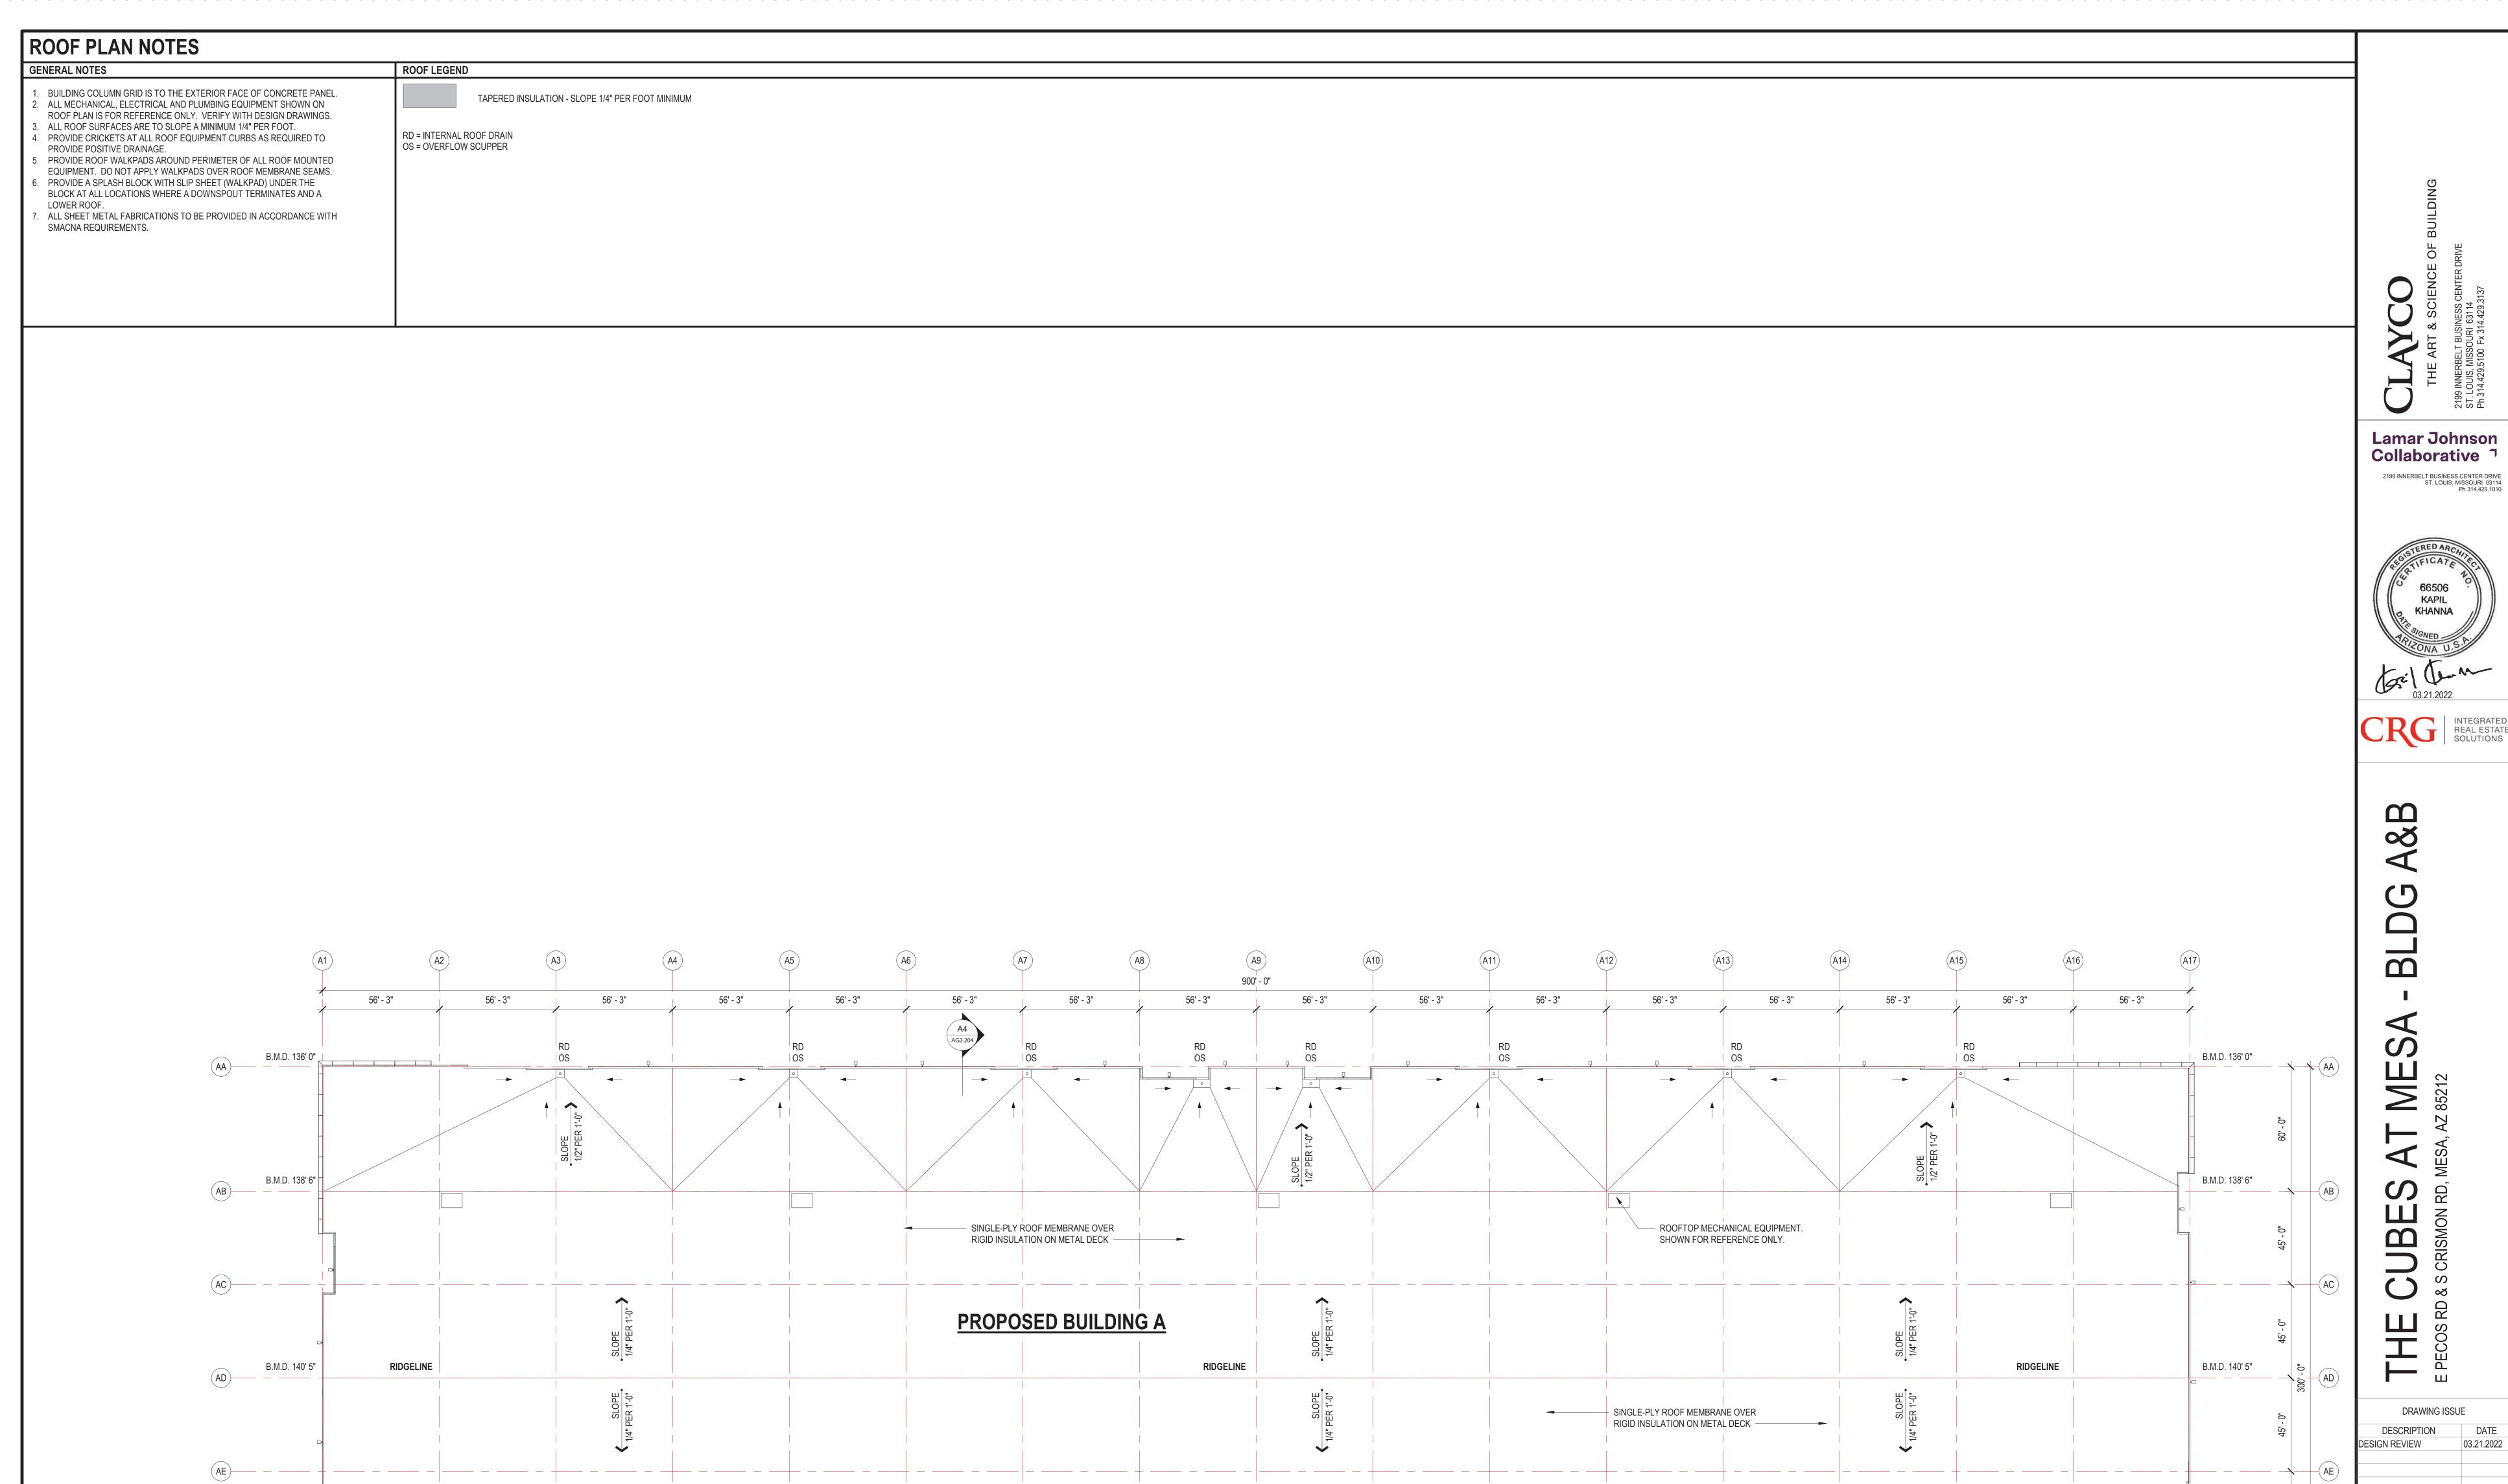


DATE 03.21.2022

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(A12)

A14

A15)

ROOFTOP MECHANICAL EQUIPMENT.
 SHOWN FOR REFERENCE ONLY.

A5

DRAWING ISSUE DESCRIPTION ESIGN REVIEW 03.21.2022 DRAWING TITLE OVERALL ROOF PLAN DRAWING NO. AA2.203

B.M.D. 136' 0"

0' 15' 30'

A1 OVERALL ROOF PLAN

AA2.203 1" = 30'-0"

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B.M.D. 138' 6"

B.M.D. 136' 0"

(A2)

AG B.M.D. 136'

ROOF PLAN NOTES ROOF LEGEND **GENERAL NOTES** . BUILDING COLUMN GRID IS TO THE EXTERIOR FACE OF CONCRETE PANEL. TAPERED INSULATION - SLOPE 1/4" PER FOOT MINIMUM 2. ALL MECHANICAL, ELECTRICAL AND PLUMBING EQUIPMENT SHOWN ON ROOF PLAN IS FOR REFERENCE ONLY. VERIFY WITH DESIGN DRAWINGS. 3. ALL ROOF SURFACES ARE TO SLOPE A MINIMUM 1/4" PER FOOT. RD = INTERNAL ROOF DRAIN 4. PROVIDE CRICKETS AT ALL ROOF EQUIPMENT CURBS AS REQUIRED TO OS = OVERFLOW SCUPPER PROVIDE POSITIVE DRAINAGE. 5. PROVIDE ROOF WALKPADS AROUND PERIMETER OF ALL ROOF MOUNTED EQUIPMENT. DO NOT APPLY WALKPADS OVER ROOF MEMBRANE SEAMS. 6. PROVIDE A SPLASH BLOCK WITH SLIP SHEET (WALKPAD) UNDER THE BLOCK AT ALL LOCATIONS WHERE A DOWNSPOUT TERMINATES AND A 7. ALL SHEET METAL FABRICATIONS TO BE PROVIDED IN ACCORDANCE WITH SMACNA REQUIREMENTS. **Lamar Johnson** Collaborative 7 2199 INNERBELT BUSINESS CENTER DRIVE ST. LOUIS, MISSOURI 63114 Ph 314.429.1010 56' - 3" 56' - 3" 56' - 3" 56' - 3" 56' - 3" 56' - 3" 56' - 3" 56' - 3" 56' - 3" 56' - 3" 56' - 3" 56' - 3" 56' - 3" 56' - 3" 56' - 3" 56' - 3" BA B.M.D. 136' 0" B.M.D. 136' 0" BB B.M.D. 138' 6" B.M.D. 138' 6" SINGLE-PLY ROOF MEMBRANE OVER ROOFTOP MECHANICAL EQUIPMENT. RIGID INSULATION ON METAL DECK $\,-\,$ SHOWN FOR REFERENCE ONLY. PROPOSED BUILDING B B.M.D. 140' 5" **RIDGELINE RIDGELINE** B.M.D. 140' 5" SINGLE-PLY ROOF MEMBRANE OVER RIGID INSULATION ON METAL DECK ROOFTOP MECHANICAL EQUIPMENT. SHOWN FOR REFERENCE ONLY. B.M.D. 138' 6" B.M.D. 138' 6"

DRAWING ISSUE DESCRIPTION DESIGN REVIEW 03.21.2022 DRAWING TITLE OVERALL ROOF PLAN DRAWING NO.

B.M.D. 136' 0"

A1 OVERALL ROOF PLAN

AB2.203 1" = 30'-0"

0'

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B.M.D. 136' 0"