

KAJIMA ASSOCIATES INC.

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KAJIMA ASSOCIATES, INC. ARCHITECT: 3490 PIEDMONT RD. NE, SUITE 900, ATLANTA, GA 30305 KIMLEY-HORN AND ASSOCIATES, INC. STRUCTURAL ENGINEER:

7740 N. 16th STREET, SUITE 300, PHOENIX, AZ 85020

PHONE: 602-944-5500 FAX: 602-944-7423

WWW.KIMLEY-HORN.COM

7740 N. 16th Street, Suite 300, Phoenix, AZ 85020 MECHANICAL / PLUMBING / FIRE PROTECTION / ELECTRICAL ENGINEER: © 2022 KIMLEY-HORN AND ASSOCIATES, INC.

SEAL: 67407 JEFFREY C. BOYD



PROJECT: JX NIPPON MINNING AND METAL 10430 E. GERMANN RD, MESA, ARIZONA 85212 PROJECT EARL

REVISIONS: DATE # REMARKS

SHEET TITLE: PRELIMINARY GRADING AND DRAINAGE PLAN

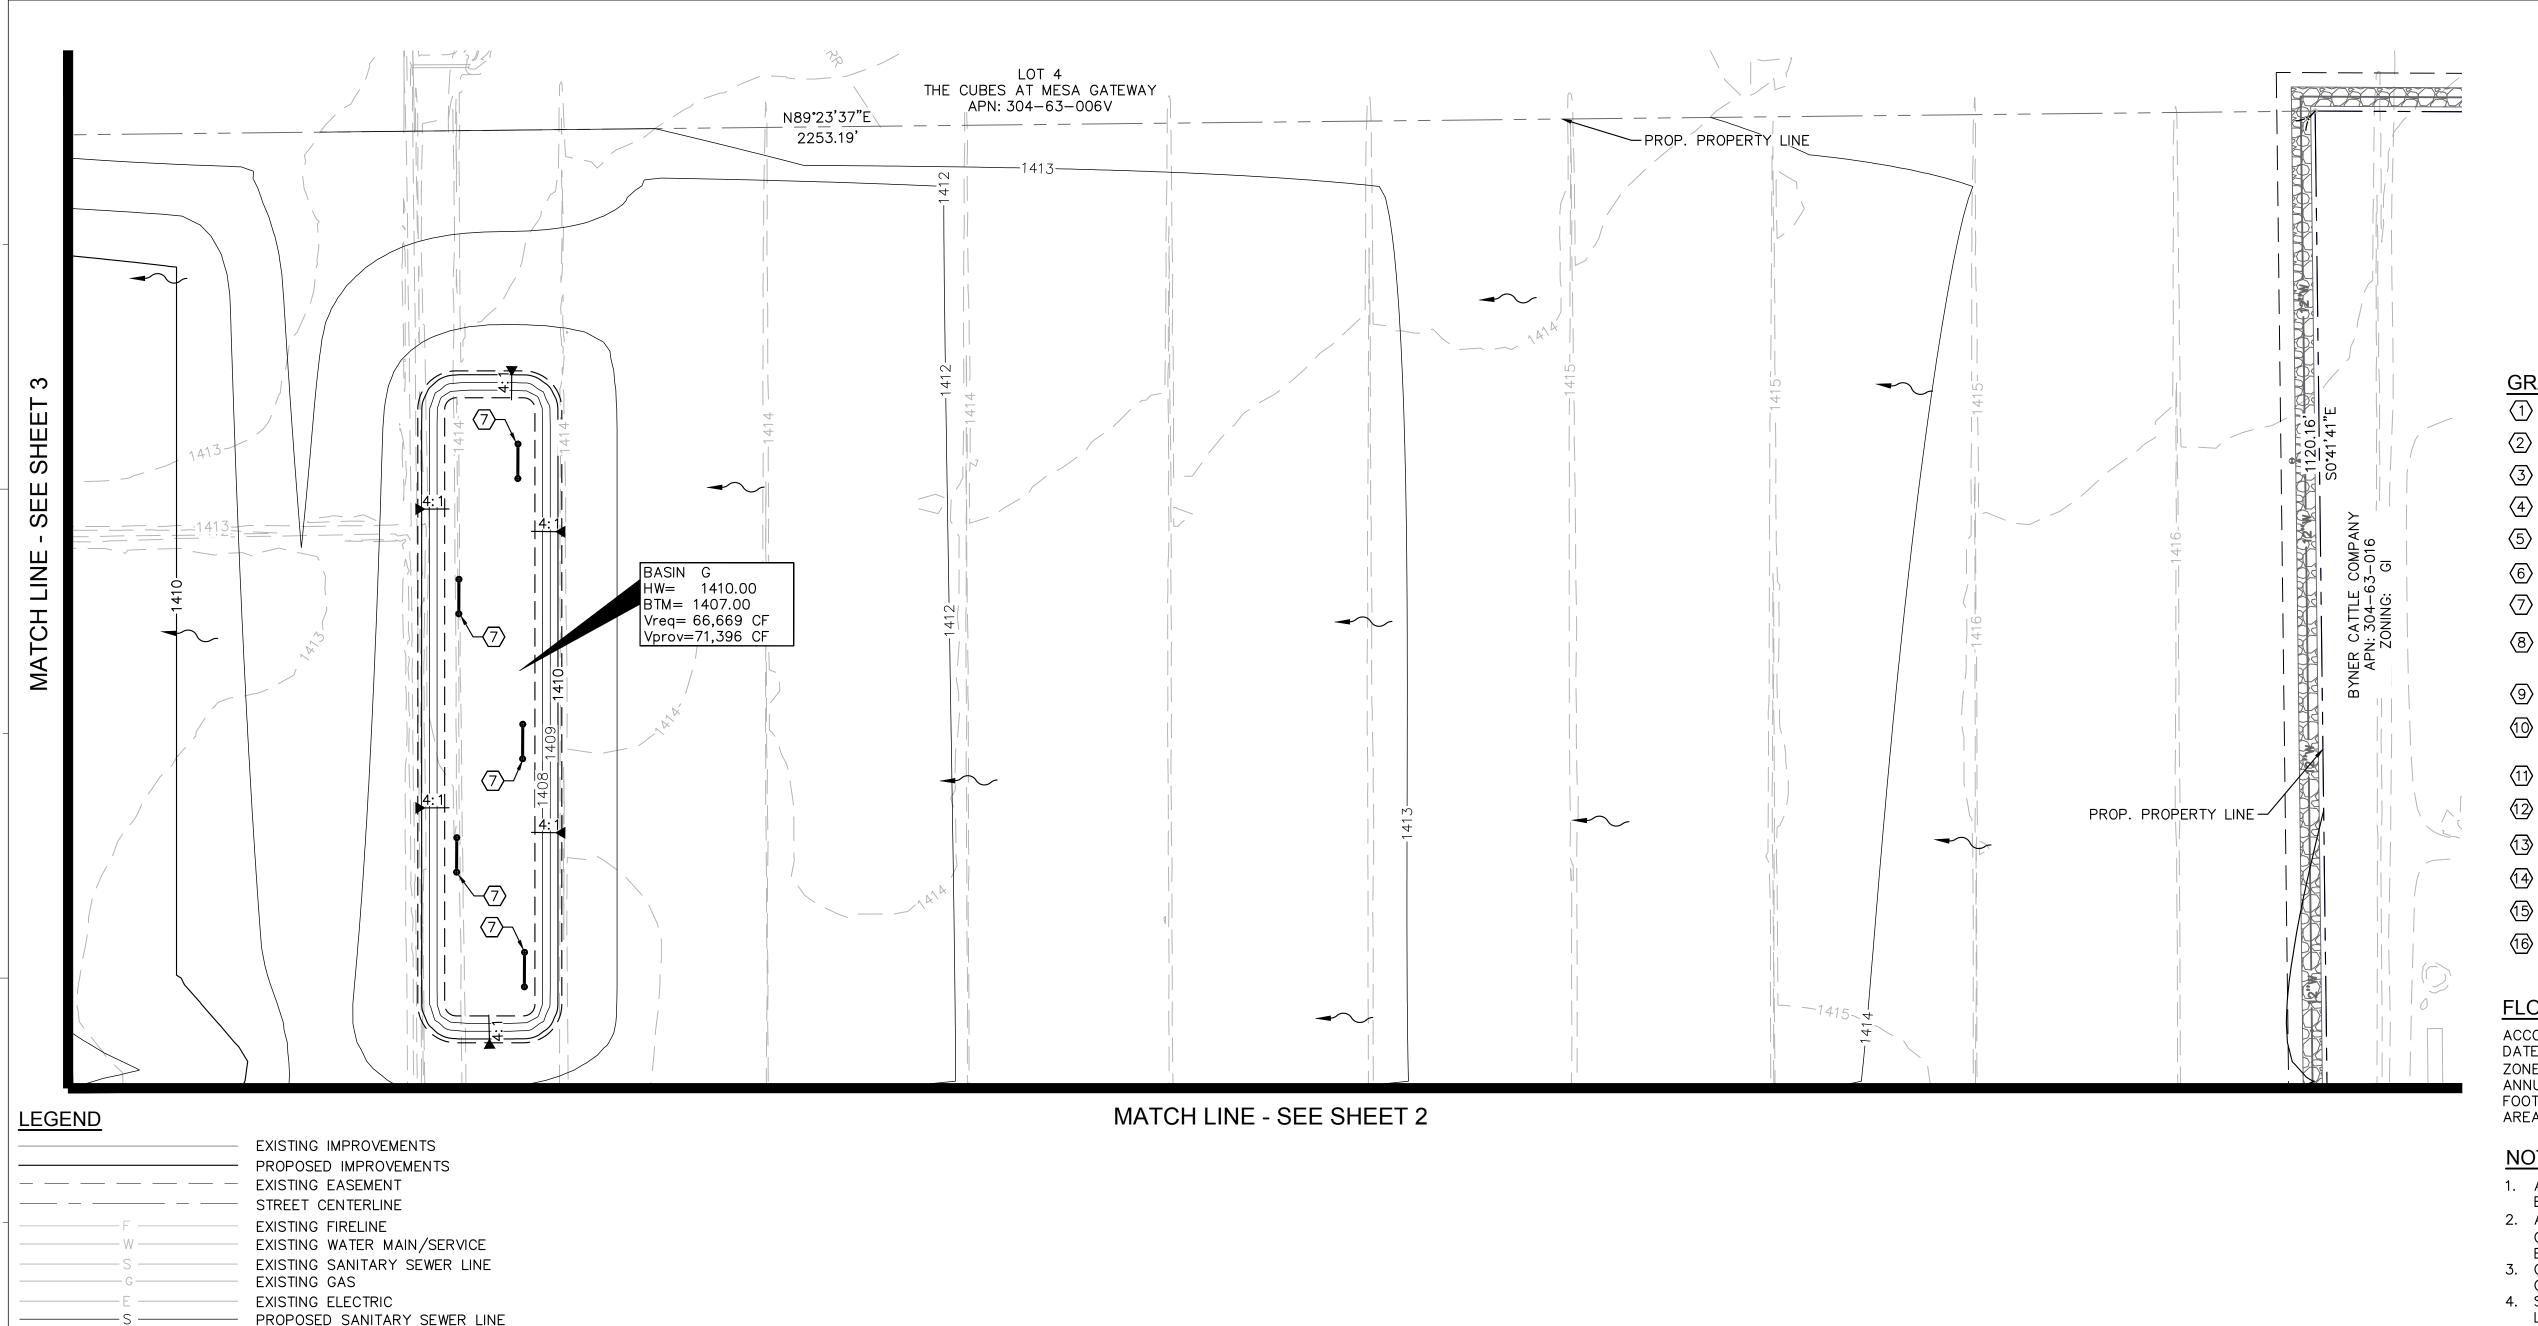
25 50

PROJECT NO.: 291550002 PROJECT MANAGER: PROJECT DESIGNER: DRAWN BY: CHECKED BY: SCALE: 1"=50'

Contact Arizona 811 at least two full AR ZONA81 Call 811 or click Arizona811.co

MKC JCB

SHEET: PRE-GD 3 3 of 5



GRADING CONSTRUCTION NOTES

- (1) PROPOSED 12" HDPE STORM DRAIN PIPE.
- 2 PROPOSED 5' DIA MANHOLE PER MAG STD DET 520 WITH SOLID LID.
- 3 PROPOSED CATCH BASIN TYPE 'G' PER MAG STD DET 537 SINGLE GRATE.

GERMANN RD

SEC.2, T.2S, R.7E

CITY OF MESA N.T.S.

- PROPOSED 10' DIA CMP RETENTION TANK.
- 5 PROPOSED STORM DRAIN CONNECTION TO UNDERGROUND RETENTION TANK.
- 6 PROPOSED UNDERGROUND RETENTION ACCESS RISER.
- 7 PROPOSED MAXWELL PLUS DUAL-CHAMBERED DRYWELL.
- 8 PROPOSED R-4990-DX 14" WIDE UNBOLTED NEENAH R-4990-DX SERIES TRENCH DRAIN (TYPE 'A' GRATE) WITH BLACK POWDER COATED FINISH.
- 9 PROPOSED 15" RCP STORM DRAIN PIPE
- PROPOSED HEADWALL WITH SAFETY RAIL TYPE 'U' PER MAG STD DET 501 AND 145. TRASH RACK PER MAG STD 502.
- 11) PROPOSED BUILDING ROOF DRAIN CONNECTION WITH TWO-WAY CLEANOUT
- 12 PROPOSED 12" SCHEDULE 40 PVC STORM DRAIN PIPE.
- (13) PROPOSED CURB INLET CATCH BASIN TYPE 'D' PER MAG STD DET 533-1.
- 14) PROPOSED 15" RCP STORM DRAIN (INSTALLED BY OTHERS) TO REMAIN.
- 15 PROPOSED EQUALIZER STORM DRAIN PIPE.
- (16) PROPOSED OPEN GRATE INLET STRUCTURE.

FLOOD ZONE

ACCORDING TO THE FLOOD INSURANCE RATE MAP #04013C2790L, DATED OCTOBER 16, 2013, THIS PROPERTY IS LOCATED IN FLOOD ZONE "X". AREAS OF 0.2% ANNUAL CHANCE FLOOD; AREAS OF 1% ANNUAL CHANCE FLOOD WITH AVERAGE DEPTHS OF LESS THAN 1 FOOT OR WITH DRAINAGE AREAS LESS THAN 1 SQUARE MILE; AND AREAS PROTECTED BY LEVEES FROM 1% ANNUAL CHANCE FLOOD.

NOTES

- 1. ADD 0.5' TO PAVEMENT (P) ELEVATIONS FOR TOP OF CURB ELEVATIONS FOR VERTICAL CURBS.
- 2. ALL SPOT ELEVATIONS ARE FINISHED GRADE PAVEMENT (P), GUTTER/GRATE (G), TOP OF CURB (TC), OR SIDEWALK (SW)
- ELEVATIONS UNLESS OTHERWISE NOTED. 3. CONTRACTOR SHALL USE SPOT ELEVATIONS, PROPOSED
- CONTOURS, AND SLOPES TO ESTABLISH GRADES. 4. SIDEWALK CROSS SLOPE SHALL NOT EXCEED 2% AND
- LONGITUDINAL SLOPE SHALL NOT EXCEED 5%.
- 5. REFER TO LANDSCAPE PLANS FOR SLOPE TREATMENT. 6. ALL FILL SLOPES SHALL BE COMPACTED TO 95% RELATIVE
- 7. REFER TO BUILDING ARCHITECTURE AND STRUCTURAL PLANS FOR EXACT BUILDING FOUNDATION THICKNESS CHANGES.

GRAPHIC SCALE IN FEET 25 50



1"=50'



KAJIMA ASSOCIATES INC.

M/E

PROPOSED FIRELINE

EXISTING IRRIGATION LINE

PROPOSED CONTOUR EXISTING CONTOURS

PROPOSED PAVEMENT ELEVATION

EXISTING PAVEMENT ELEVATION

MATCH EXISTING ELEVATION GUTTER/GRATE ELEVATION FINISH GRADE ELEVATION PAVEMENT ELEVATION TOP OF CURB ELEVATION SIDEWALK ELEVATION

FINISHED FLOOR ELEVATION

GUTTER ELEVATION

FLOW ARROW

EXISTING FENCE

— PROPOSED FENCE

EXISTING STORM DRAIN PROPOSED STORM DRAIN

> -----LP ----- PROPOSED LOW POINT

PROPOSED WATER SERVICE/SERVICE

PROPOSED OVERHEAD ELECTRICAL BY OTHERS

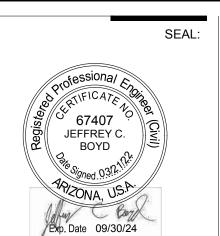
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PROJECT: JX NIPPON MINNING AND METAL 10430 E. GERMANN RD, MESA, ARIZONA 85212 PROJECT EARL

REVISIONS: DATE # REMARKS

SHEET TITLE: PRELIMINARY GRADING AND DRAINAGE PLAN

PROJECT NO.: 291550002 PROJECT MANAGER: PROJECT DESIGNER: MKC DRAWN BY: JCB CHECKED BY:

SCALE:

SHEET: PRE-GD 4 4 of 5

1.20

1.26

1.55

0.33

2.39

1.83

2.05

1.41

1.40

1.41

16.44

13.92

5.67

11.44

0.67

0.56

69.13

0.60

0.80

0.60

0.85

0.90

0.90

0.90

0.90

0.90

0.90

0.60

0.60

0.75

0.60

0.60

0.60

0.74

2.20

2.20

5,738

8,080

7,406

2,221

17,194

13,129

14,743

10,135

10,042

10,099

78,757

66,699

33,937

54,831

3,232

2,677

390,236

0.13

0.19

0.17

0.05

0.39

0.30

0.34

0.23

0.23

0.23

1.81

1.53

0.78

1.26

0.07

0.06

8.96

52,160

55,089

67,328

14,251

104,206

79,571

89,352

61,421

60,863

61,208

715,971

606,352

246,812

498,464

29,381

24,333

3,011,503

50

55

60

65

70

75

80

85

90

95

100

105

110

115

120

125

| | Drywell Summary | | | 0 | |
|----------|------------------|---------|------------------|----------------------|------------|
| Drainage | Retention Basin | Volume | Disposal Rate | Drywells Required | Drain Time |
| Area | | cf | cfs | ea | hr |
| UG-A | CMP Tank | 15,467 | 0.10 | 2 | 22 |
| UG-B | CMP Tank | 98,146 | 0.10 | 8 | 35 |
| Basin-C | CMP Tank | 54,831 | 0.10 | 5 | 31 |
| Basin-D* | Surface | 7,505 | 0.10 | 1 | 21 |
| Basin-E* | Surface | 2,450 | 0.10 | 1 | 7 |
| Basin-F | Surface | 81,433 | 0.10 | 7 | 33 |
| Basin-G | Surface | 66,699 | 0.10 | 6 | 31 |
| Basin-H | Surface | 63,705 | 0.10 | 5 | 36 |
| Total | Surface/CMP Tank | 390,236 | 0.10 | 35 | 31 |

*THE VOLUME PROVIDED FOR THESE BASINS ARE EXISTING AND TO BE PROVIDED BY OTHERS

Landscape Area

Landscape Area

Landscape Area

Pavement/Building Area

Undeveloped Desert

Undeveloped Desert

Pavement/Undeveloped Desert

Undeveloped Desert

Landscape Area

Pavement/Building Area

Industrial

UNDERGROUND RETENTION SUMMARY

| | | Underground R | | | | | |
|----|------------------|-----------------|-----------------|----------|--------------------|--------------------|---------------------|
| 90 | Drainage Area | Retention Basin | Required Volume | Diameter | Required Length | Provided Length | Provided Storage |
| | Alea | | cf | ft | lf | If CMP | cf |
| 25 | UG-A | CMP Tank | 15,467 | 10 | 197 | 197 | 15,472 |
| | UG-B | CMP Tank | 98,146 | 10 | 1250 | 1250 | 98,175 |
| 1 | Total | CMP Tank | 113,613 | 10 | 1447 | 1447 | 113,647 |

SURFACE RETENTION SUMMARY

| | Overall Surface Retention Summary | | | | |
|----------|-----------------------------------|----------|----------|--|--|
| Drainage | | Required | Provided | | |
| Area | Retention Basin | Storage | Storage | | |
| Alea | | cf | cf | | |
| Basin-C | Surface | 54,831 | 61,193 | | |
| Basin-D* | Surface | 7,505 | 10,133 | | |
| Basin-E* | Surface | 2,450 | 10,133 | | |
| Basin-F | Surface | 81,433 | 96,100 | | |
| Basin-G | Surface | 66,699 | 71,396 | | |
| Basin-H | Surface | 63,705 | 71,445 | | |
| Total | Surface | 276,623 | 320,400 | | |

*THE VOLUME PROVIDED FOR THESE BASINS ARE EXISTING AND TO BE PROVIDED BY OTHERS

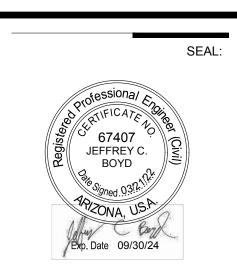
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| KAJIMA | | | |
|-------------------|--|--|--|
| ASSOCIATES | | | |
| INC. | | | |

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REVISIONS: DATE # REMARKS

PRELIMINARY GRADING AND DRAINAGE PLAN **NOTES**

| PROJECT NO.: | 291550002 |
|-----------------|-----------|
| ROJECT MANAGER: | |
| OJECT DESIGNER: | |
| DRAWN BY: | MKC |
| CHECKED BY: | JCB |
| SCALE: | NONE |

PRE-GD 5 5 of 5