RETENTION CALCULATIONS (SEE SHEET C-2 FOR DRAINAGE AREA DELINEATIONS)

MARICOPA COUNTY 100-YEAR, 2-HOUR STORM VOLUME REQUIRED = A * P/12 * C

WHERE: A = AREA (S.F.)

P = 100-YEAR, 2-HOUR RAINFALL = 2.20"

C = RUNOFF COEFFICIENT = 0.90 (COMMERCIAL)

DRAINAGE AREA A

AREA = 94.359 S.F.VOLUME REQUIRED = 94,359 * 2.20/12 * 0.90 = 15,569 C.F.VOLUME PROVIDED = 15,622 C.F. - 199 L.F. OF 10' DIAMETER PIPE DRYWELLS PROVIDED = 2

DRAINAGE AREA B

AREA = 47,077 S.F.

VOLUME REQUIRED = 47,077 * 2.20/12 * 0.90 = 7,768 C.F.VOLUME PROVIDED = 7,772 C.F. - 99 L.F. OF 10' DIAMETER PIPE DRYWELLS PROVIDED = 1

DRAINAGE AREA C

AREA = 85,859 S.F.VOLUME REQUIRED = 85,859 * 2.20/12 * 0.90 = 14,167 C.F.VOLUME PROVIDED = 14.287 C.F. - 182 L.F. OF 10' DIAMETER PIPE DRYWELLS PROVIDED = 2

DRYWELL CALCULATIONS

ASSUMED DRYWELL PERCOLATION RATE = 0.1 CFS (MINIMUM PER MCDDM SECTION 9) REQUIRED DISPOSAL TIMELINE = 36 HOURS PERCOLATION VOLUME PER DRYWELL = 0.1 * 3600 * 36 = 12,960 C.F.

DRYWELL NOTES

- 1. THIS PROJECT HAS PROPOSED DRYWELLS TO BLEED-OFF THE UNDERGROUND RETENTION SYSTEM IN THIRTY-SIX (36) HOURS AS THESE ARE NO PUBLIC STORM DRAIN SYSTEM AVAILABLE THAT ULTIMATELY CONVEY TO A REGIONAL DRAINAGE SYSTEM. THE SYSTEM OF DISPOSAL HAS RECEIVED PRIOR APPROVAL PURSUANT TO THE MASTER AND OFF-SITE DRAINAGE
- 2. ALL DRYWELLS SHOWN ON THIS PROJECT SHALL BE MAINTAINED BY THE OWNERS AND ARE TO BE REPLACED BY THE OWNERS WHEN THEY CEASE TO DRAIN THE SURFACE WATER IN A 36-HOUR PERIOD. REGULAR MAINTENANCE OF THE DRYWELL SILTING CHAMBER IS REQUIRED TO ACHIEVE THE BEST OPERATION OF THE DRYWELL.
- 3. A CONSTANT HEAD PRESSURE TEST SHALL BE PERFORMED BY THE INSTALLING CONTRACTOR, AND MUST BE PROVIDED TO THE ENGINEER OF RECORD. THE FIELD OBSERVED PERCOLATION RATE SHALL BE DIVIDED (DE-RATED) BY THE FOLLOWING VALUE BASED ON IN-SITU SOIL CONDITIONS.
 - 2 COARSE GRAINED SOILS (COBBLES, GRAVELS AND SANDS)
 - 3 FINE GRAINED SOILS (SILTS AND LOAMS)
 - 5 CLAY SOILS

THE RESULTS OF THE FIELD PERCOLATION TEST SHALL BE RECORDED ON THE AS-BUILT DRAWINGS AND CERTIFIED BY THE ENGINEER OF RECORD. THE OWNER IS RESPONSIBLE FOR INSTALLING ADDITIONAL DRYWELL(S) IF THE DE-RATED PERCOLATION RATE IS LESS THAN THE ASSUMED 0.1 CFS.

PROJECT DESCRIPTION

THIS PROJECT IS LOCATED WITHIN THE OVERALL MIXED USE GALLERY PARK DEVELOPMENT WHICH WAS ENTITLED AND APPROVED BY THE CITY OF MESA ON MAY 20TH, 2019 CASE #ZON 18-00775 & ANX 18-00502. THIS PHASE CONSIST OF PROPOSED BUILDING 15 (HOTEL) AND A FUTURE PAD ALONG WITH ONSITE GRADING/DRAINAGE, PUBLIC WATER & SEWER EXTENSIONS, ONSITE UNDERGROUND RETENTION SYSTEM AND OTHER SITE INFRASTRUCTURE TO SUPPORT THE DEVELOPMENT OF THE HOTEL. ALL DRAINAGE CONVEYANCE RETENTION AND THE EXTENSION OF WATER AND SEWER LINES IS IN SUBSTANTIAL CONFORMANCE TO THE APPROVED MASTER DRAINAGE AND SEWER AND WATER REPORTS WITH NO CHANGES TO THE MASTER REPORTS.

NOTE:

THIS PROPOSED DEVELOPMENT IS IN SUBSTANTIAL CONFORMANCE TO THE APPROVED GALLERY PARK MASTER DRAINAGE AND OFF-SITE DRAINAGE, WATER AND SEWER REPORTS WITH NO FURTHER UPDATES NEEDED TO THOSE REPORTS. ALL OFF-SITE DRAINAGE CONVEYANCE INCLUDING RETENTION WAS APPROVED PER THE OFF-SITE IMPROVEMENT PLANS PMT-19-11269.


PRELIMINARY GRADING, DRAINAGE AND UTILITY PLAN


GALLERY PARK HGI & HWS DUAL BRAND HOTEL

BUILDING 21 - 5057 S. POWER ROAD BUILDING 20 - 5027 S. POWER ROAD MESA, ARIZONA 85212

A PORTION OF LOT 5 OF GALLERY PARK REPLAT 2 BOOK 1615, PAGE 1 N.E.C. OF POWER ROAD AND RAY ROAD

MESA, ARIZONA 85212

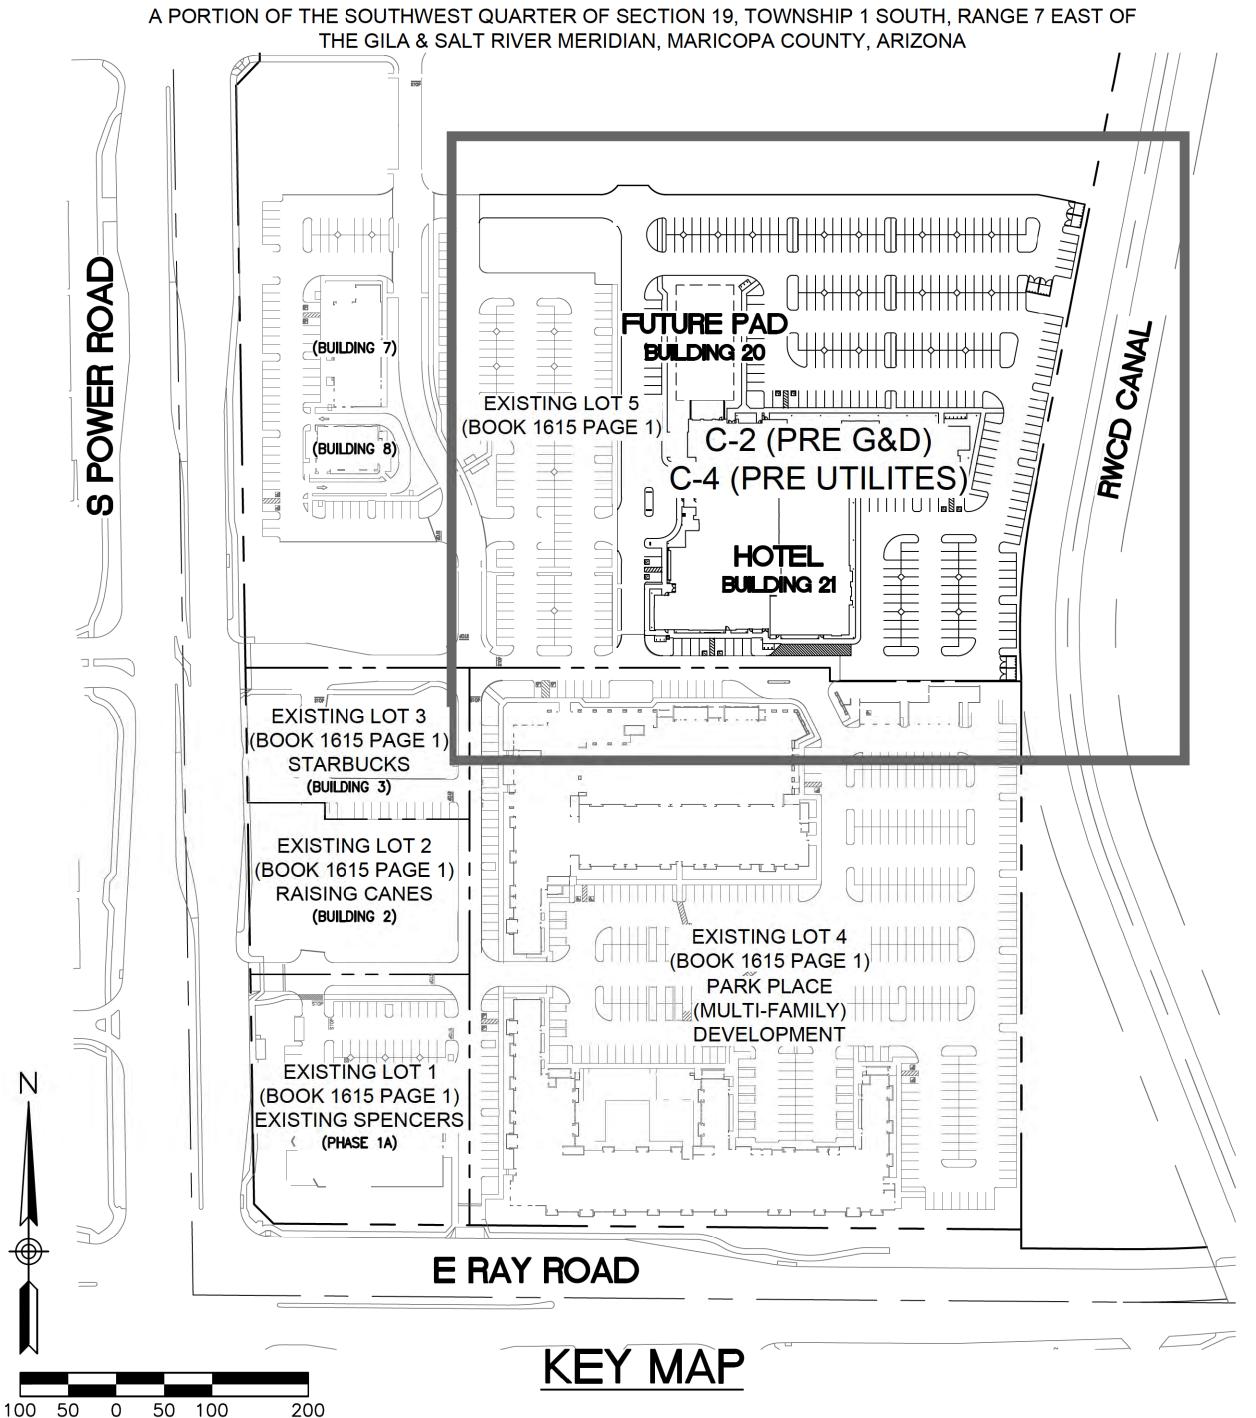

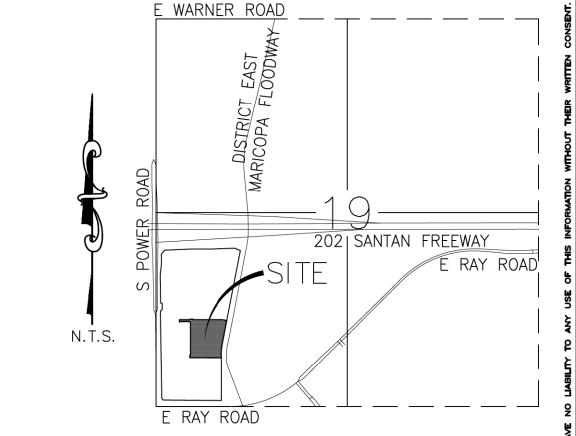

VICINITY MAP SWC 19, T. 1 S, R. 7 E

ARCHITECT

UPWARD ARCHITECTS 1155 WEST RIO SALADO PARKWAY. SUITE B-101 **TEMPE, AZ 85281** PHONE: (602) 753-5222 CONTACT: LORI KNUDSON

ENGINEER:

OPTIMUS CIVIL DESIGN GROUP 4650 EAST COTTON CENTER BLVD. SUITE 200 PHOENIX, ARIZONA 85040 PHONE: (602) 393-5234 FAX: (602) 286-9400 CONTACT: JEFF BEHRANA P.E.

OWNER/DEVELOPER

POWER 202 MIXED-USE, LLC C/O VIVO DEVELOPMENT PARTNERS, LLC 4650 EAST COTTON CENTER BLVD., SUITE 200 PHOENIX, ARIZONA 85040 PHONE: (602) 393-9364 FAX: (602) 393-5899 CONTACT: JOSE POMBO

304-30-064 (EXISTING LOT 5)

APN NUMBER

AREAS

GROSS & NET: 1,332,730 S.F. OR 30.595 AC. (LOT 5)

DISTURBED AREA: 5.22 ACRES EXISTING ZONING:

LEGAL DESCRIPTION

A PORTION OF LOT 5 OF THE FINAL PLAT OF GALLERY PARK REPLAT 2 AS RECORDED IN BOOK 1615, PAGE 1, RECORDS OF MARICOPA COUNTY, LYING WITHIN THE SOUTHWEST QUARTER OF SECTION 9, TOWNSHIP 1 SOUTH, RANGE 7 EAST OF THE GILA RIVER MERIDIAN, MARICOPA COUNTY, ARIZONA

BASIS OF BEARINGS

THE WEST LINE OF THE SOUTHWEST QUARTER OF SECTION 19, TOWNSHIP 1 SOUTH, RANGE 7 EAST OF THE GILA RIVER MERIDIAN, MARICOPA COUNTY, ARIZONA.

SAID LINE BEARS NORTH 00° 55' 11" WEST

BENCHMARK

BRASS TAG, TOP OF CURB, NORTHEAST CORNER OF LOOP 202 AND POWER ROAD.

ELEVATION=1324.10' (NAVD '88, CITY OF MESA DATUM)

FLOOD ZONE

ACCORDING TO THE FLOOD INSURANCE RATE MAP #04013C276OL, DATED OCTOBER 16, 2013. THIS PROPERTY IS LOCATED IN FLOOD ZONE "X".

LEGEND

SCALE IN FEET: 1"=100'

FOUND BRASS CAP IN HAND HOLE EASEMENT LINE PROPERTY LINE FOUND BRASS CAP FLUSH **BOUNDARY LINE** EXISTING SIGN RIGHT OF WAY

O SET 1/2" REBAR WITH CAP

FOUND MONUMENT AS SHOWN

EXISTING CATCH BASIN EXISTING STORM DRAIN MANHOLE

EXISTING TRAFFIC SIGNAL

EXISTING FIRE HYDRANT

EXISTING SANITARY SEWER MANHOLE EXISTING SEWER CLEANOUT

EXISTING UTILITY POLE **EXISTING POST** EXISTING SHUT OFF SWITCH EXISTING PULL/JUNCTION BOX

EXISTING BACKFLOW PREVENTER

EXISTING ELECTRIC UTILITY

EXISTING WATER VALVE

EXISTING TELEPHONE MANHOLE EXISTING LIGHT POLE EXISTING OVERHEAD ELECTRIC

COVER SHEET

SECTIONS SHEET

PRELIMINARY UTILITY PLAN

PRELIMINARY GRADING AND DRAINAGE PLAN

INDEX OF PLAN SHEETS

(C-2)

EXISTING STORM DRAIN --S-- Existing sewer main -- \forall -- **EXISTING WATER MAIN**


CONCRETE ELEVATION CO CURB OPENING ELEVATION GRATE ELEVATION PAVEMENT ELEVATION PROPOSED STORM DRAIN

PROPOSED SEWER CLEANOUT

PROPOSED CATCH BASIN PROPOSED STORM DRAIN MANHOLE PROPOSED RETENTION AREA BOUNDARY




RETENTION DRAINAGE AREA DESIGNATOR

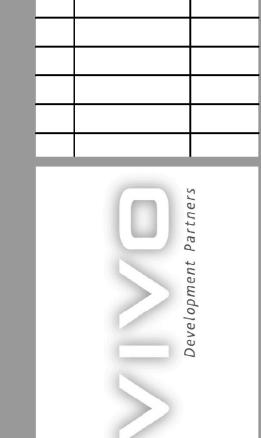

REVISION

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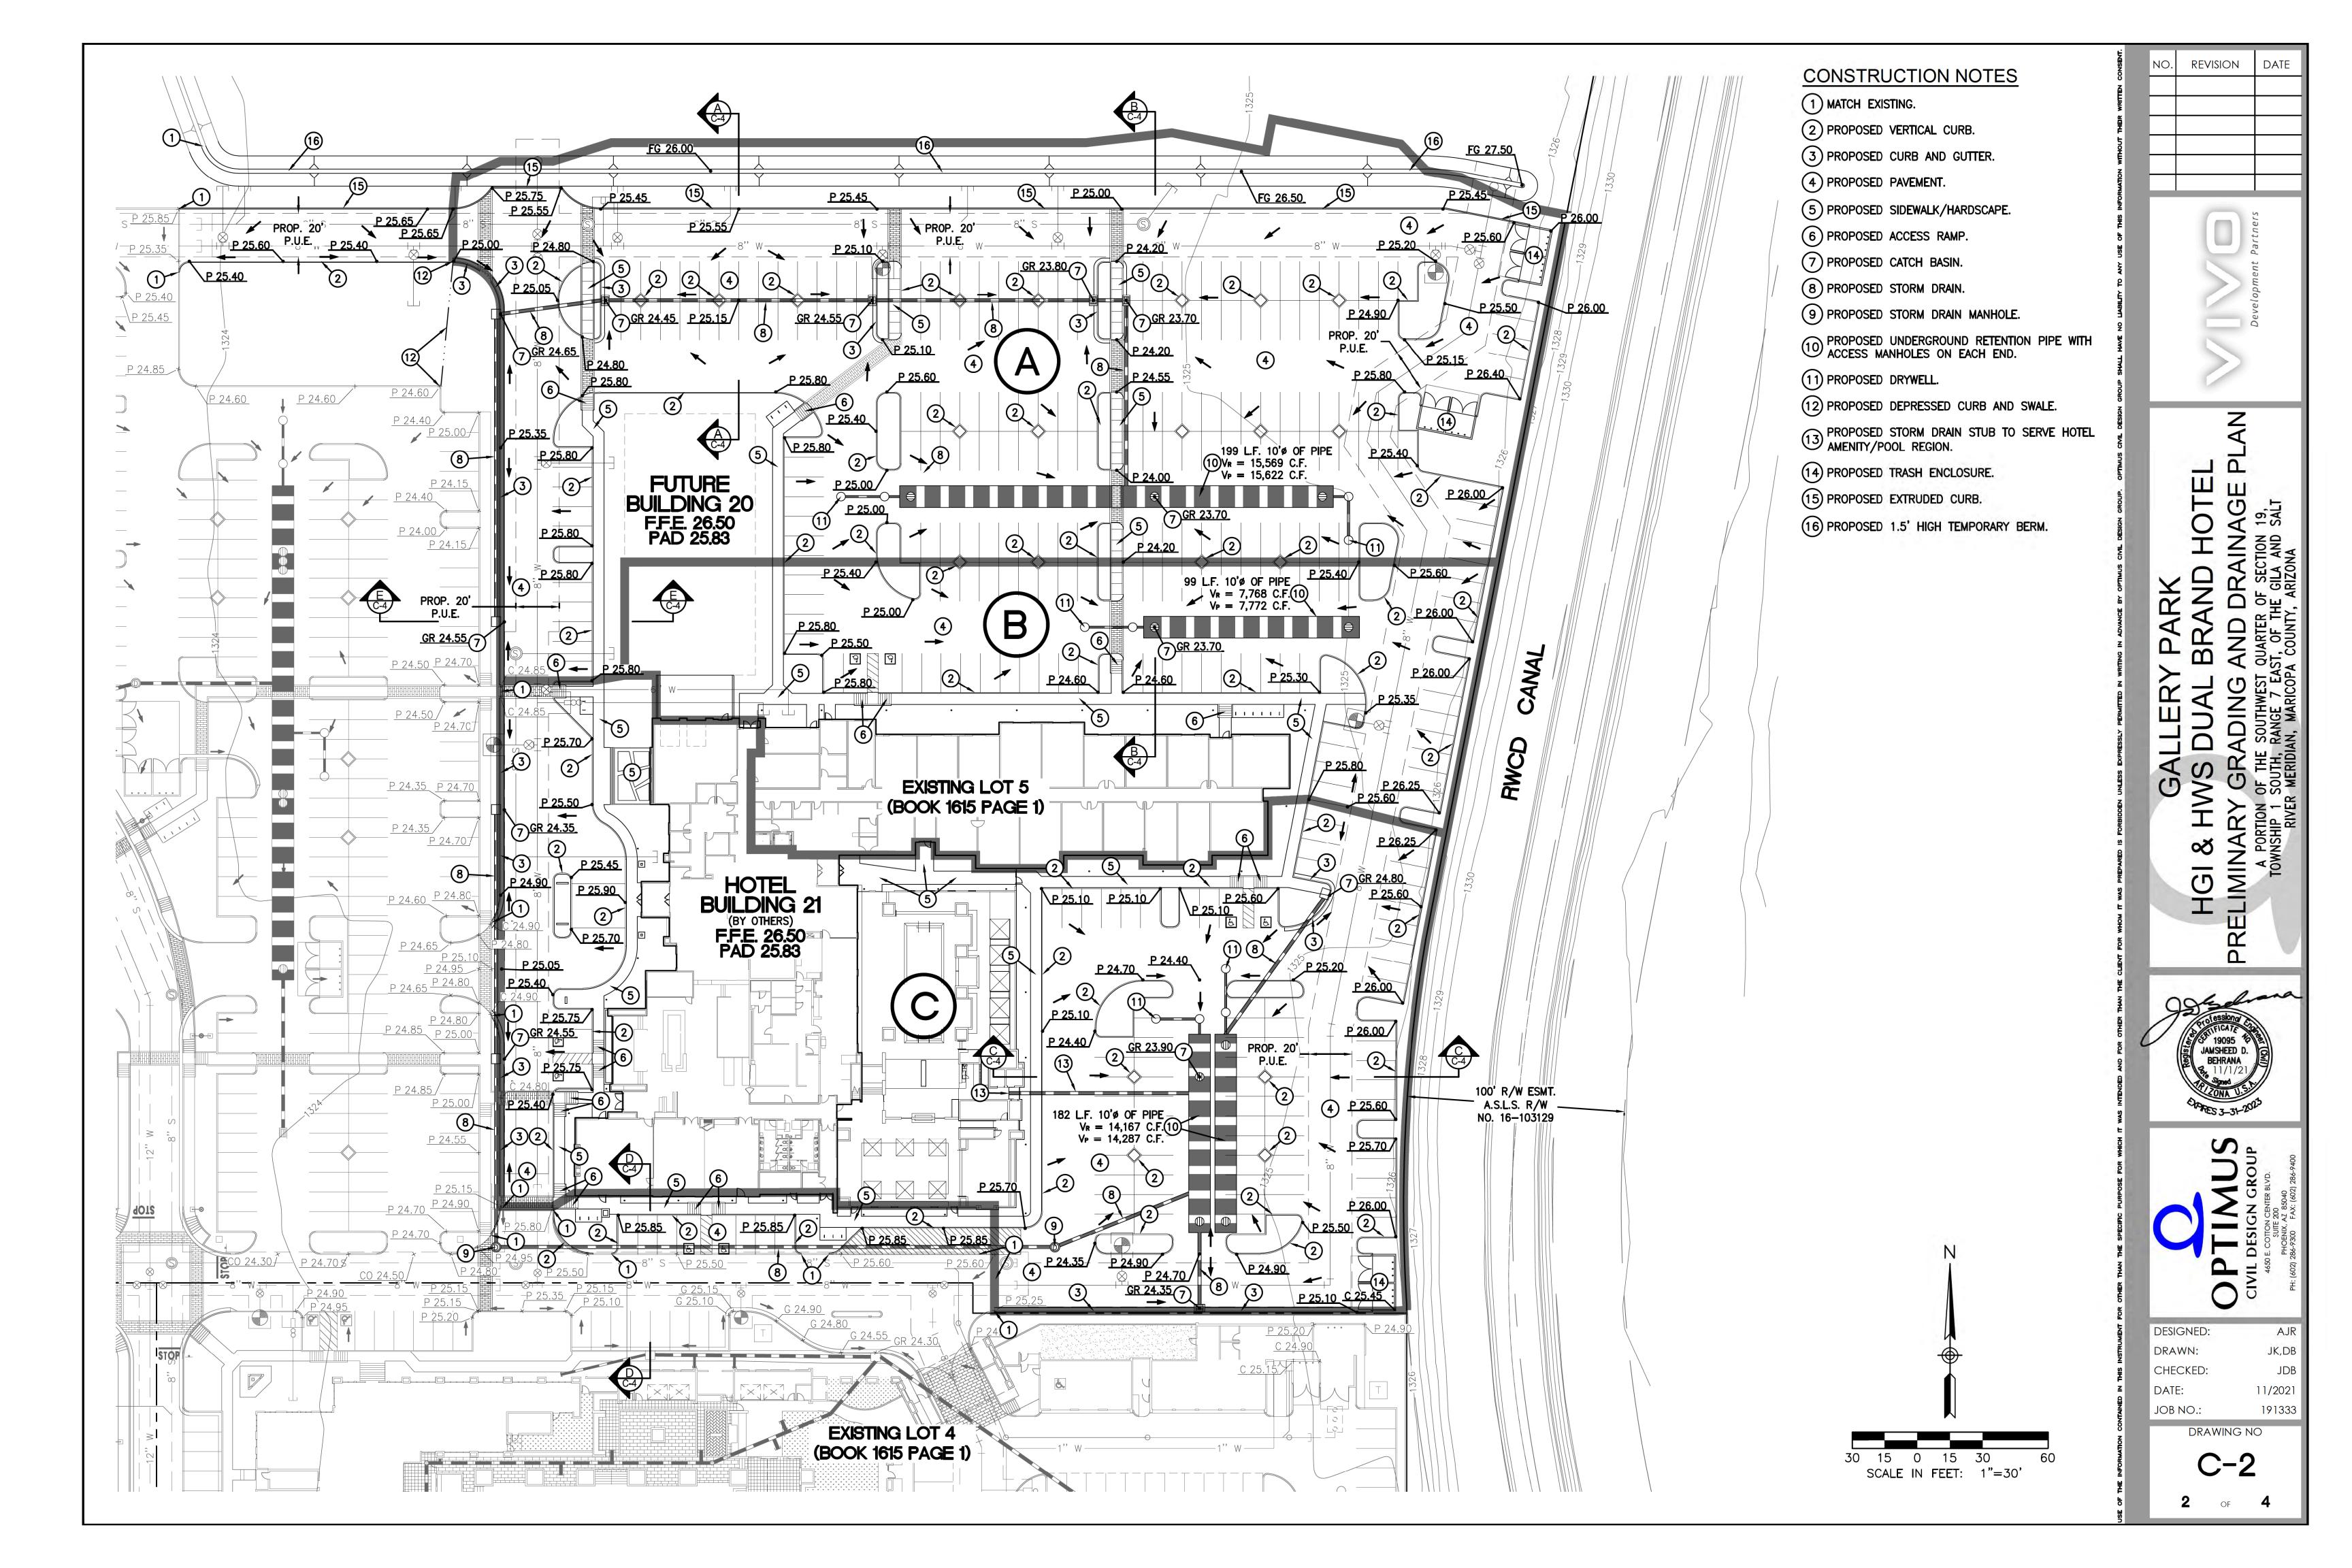


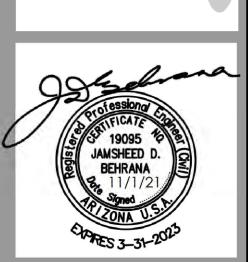


DESIGNED: DRAWN: JK,DB CHECKED: JDB DATE: 11/2021


JOB NO.: 191333 DRAWING NO





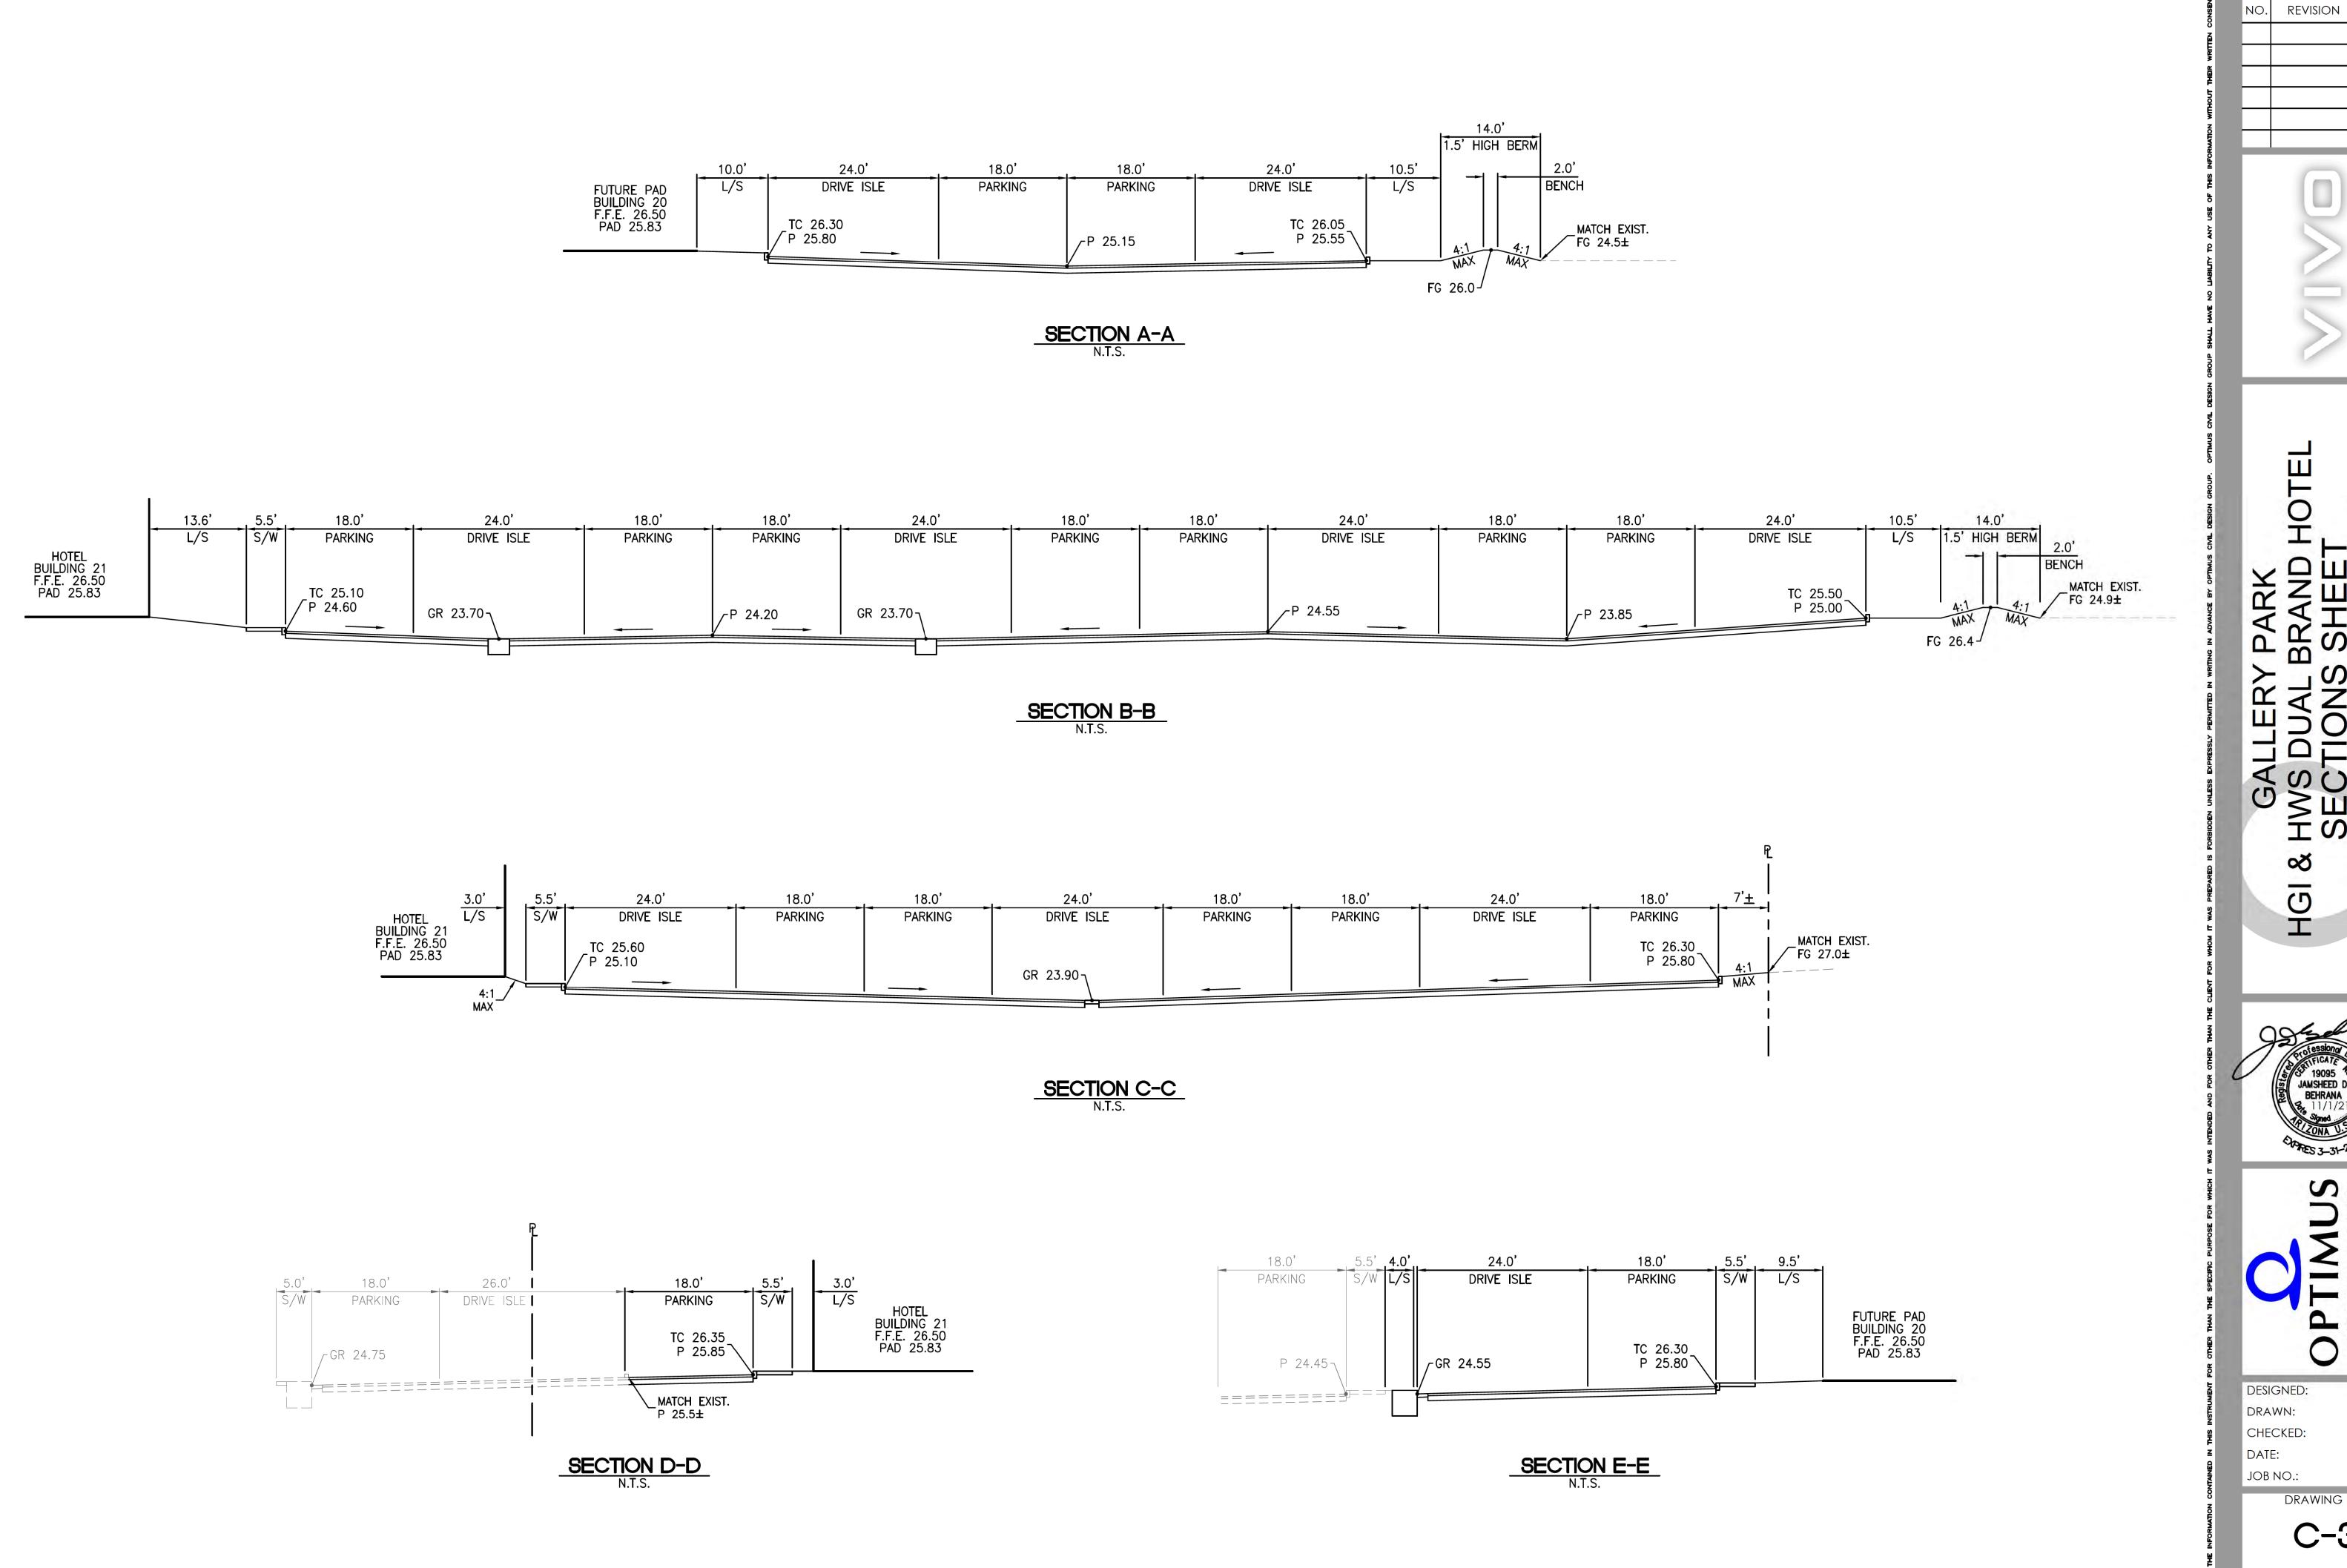



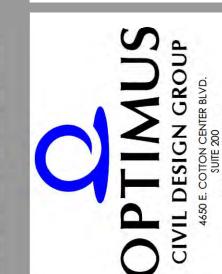

DESIGNED: AJR JK,DB JDB 11/2021 191333

DRAWING NO

