

DEFERRED SUBMITTAL

1. FIRE SPRINKLER SYSTEM

SEPTIC SYSTEM

PROJECT DIRECTORY

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GENERAL NOTES

A. COMPLY WITH ALL PROVISIONS AND REQUIREMENTS OF MESA BUILDING CODE (MBC) CHAPTER 33 - SAFEGUARDS DURING CONSTRUCTION, MESA FIRE CODE (MFC) CHAPTER 33 - FIRE SAFETY DURING CONSTRUCTION AND DEMOLITION, AND NFPA 241 FOR ITEMS NOT SPECIFICALLY ADDRESSED BY MFC CHAPTER 33.

FIRE APPARATUS ACCESS ROADS ARE ESSENTIAL DURING CONSTRUCTION TO ALLOW EMERGENCY RESPONSE TO THE SITE FOR BOTH FIRE AND MEDICAL EMERGENCIES. ACCESS ROADS SHALL BE IN PLACE PRIOR TO THE START OF VERTICAL CONSTRUCTION. IT IS IMPORTANT TO DEVELOP ACCESS ROADS AT AN EARLY STAGE OF CONSTRUCTION TO ALLOW FOR FIRE DEPARTMENT ACCESS TO THE SITE IN THE CASE OF FIRE OR INJURY.

REQUIRED FIRE APPARATUS ACCESS ROAD DURING CONSTRUCTION OR DEMOLITION SHALL COMPLY WITH MESA FIRE AND MEDICAL DEPARTMENT STANDARD DETAIL FPD 3310.1. THE ACCESS ROAD SHALL BE A MINIMUM OF 20 FEET WIDE OF ALL-WEATHER DRIVING SURFACE, GRADED TO DRAIN STANDING WATER AND ENGINEERED TO BEAR THE IMPOSED LOADS OF FIRE APPARATUS (78,000 LBS. / 24,000 LBS. FRONT AXLE, 54,000 LBS. REAR AXLE) WHEN ROADS ARE

THE ACCESS ROAD SHALL EXTEND TO WITHIN 200 FEET OF ANY COMBUSTIBLE MATERIALS AND/OR ANY LOCATION ON THE JOBSITE WHERE ANY PERSON(S) SHALL BE WORKING FOR A MINIMUM OF FOUR (4) CONTINUOUS HOURS IN ANY DAY. A CLEARLY VISIBLE SIGN MARKED FIRE ZONING DEPARTMENT ACCESS, IN RED LETTERS, SHALL BE PROVIDED AT THE ENTRY TO THE ACCESS ROAD. ALL OPEN TRENCHES SHALL HAVE STEEL PLATES CAPABLE OF MAINTAINING THE INTEGRITY OF THE ACCESS ROAD DESIGN WHEN THESE TRENCHES CROSS AN ACCESS ROAD.

THESE ACCESS ROADS MAY BE TEMPORARY OR PERMANENT. THIS POLICY APPLIES ONLY DURING CONSTRUCTION AND/OR DEMOLITION. PERMANENT ACCESS PER THE MFC SHALL BE IN PLACE PRIOR TO ANY FINAL INSPECTION OR CERTIFICATE OF OCCUPANCY.

WATER SUPPLY FOR FIRE PROTECTION. AN APPROVED WATER SUPPLY FOR CONSTRUCTION SITE

OCCUPANCY SHALL MEET THE REQUIREMENTS OF MFC APPENDIX CHAPTERS B AND C. THE MINIMUM FIRE FLOW REQUIREMENT WHEN CONTRACTOR OR DEVELOPER BRINGS COMBUSTIBLE MATERIALS ON PROPOSED USE SITE IS 1,500 GPM AT 20 PSI. AT LEAST ONE FIRE HYDRANT SHALL BE WITHIN 500 FEET OF ANY COMBUSTIBLE MATERIAL AND CAPABLE OF DELIVERING THE MINIMUM FIRE FLOW REQUIREMENT. THIS HYDRANT OR HYDRANTS MAY BE EITHER TEMPORARY OR PERMANENT AS LOT SIZE THE PROJECT SCHEDULE PERMITS.

IN ADDITION, THERE ARE TIMES WHEN HYDRANTS AND VALVES MUST BE CLOSED TEMPORARILY ALLOWABLE LOT COVERAGE FOR REPAIR WORK OR CONSTRUCTION OF THE WATER SYSTEM. THE DEVELOPER/CONTRACTOR IS

PROVIDED LOT COVERAGE RESPONSIBLE FOR ENSURING THAT THE WATER SUPPLY IS ALWAYS AVAILABLE. WHEN THE WORK IS COMPLETE, DEVELOPER/CONTRACTOR SHALL MAKE SURE THAT THE FIRE HYDRANTS ARE LANDSCAPE AREA PROVIDED ACTIVE, AND THE VALVES ARE OPEN.

MESA AMENDED FIRE CODE SECTION 903.4 SPRINKLER SYSTEM SUPERVISION AND ALARMS. VALVES CONTROLLING THE WATER SUPPLY FOR AUTOMATIC SPRINKLER SYSTEMS, PUMPS, PROPOSED BUILDING HEIGHT TANKS, WATER LEVELS AND TEMPERATURES, CRITICAL AIR PRESSURES, AND WATERFLOW SWITCHES ON ALL SPRINKLER SYSTEMS SHALL BE ELECTRICALLY SUPERVISED BY A LISTED FIRE ALARM CONTROL UNIT.

903.4.1 MONITORING. ALARM, SUPERVISORY AND TROUBLE SIGNALS SHALL BE DISTINCTLY DIFFERENT AND SHALL BE AUTOMATICALLY TRANSMITTED TO AN UNDERWRITERS LABORATORY LISTED OR FACTORY MUTUAL APPROVED SUPERVISING STATION OR, WHERE APPROVED BY THE TOTAL BUILDING AREA FIRE CODE OFFICIAL, SHALL SOUND AN AUDIBLE SIGNAL AT A CONSTANTLY ATTENDED LOCATION.

G.C. TO INVESTIGATE EXISTING PAVEMENT FOR COMPOSITION, STRUCTURAL CAPACITY, AND IF AFTER THE ENGINEER'S INVESTIGATION, THE CITY DETERMINES THE EXISTING PAVEMENT SECTION IS BELOW CURRENT STANDARDS, THE ENGINEER SHALL CALL OUT A SAWCUT AT THE CONSTRUCTION CENTERLINE AND REPLACEMENT OF THE EXISTING PAVEMENT WILL BE REQUIRED WITH NEW PAVEMENT PER CITY STANDARDS.

SIGNING AND PAVEMENT MARKING PLANS ARE REQUIRED FOR ANY DEVELOPMENT THAT MODIFIES EXISTING PAVEMENT, BUILDS NEW PAVEMENT, OR INTRODUCES NEW OR MODIFIES EXISTING VEHICULAR OR PEDESTRIAN ACCESS TO ROADWAYS PER THE CURRENT COM TOTAL PARKING REQUIRED ENGINEERING AND DESIGN STANDARDS SEC. 204.3. ANY SIGNING AND STRIPING INSTALLATION OR MODIFICATIONS SHALL BE THE RESPONSIBILITY OF THE DEVELOPER.

IF NECESSARY AND REQUIRED, GREASE TRAPS SHOULD FOLLOW CITY OF MESA ENGINEERING AND

FIRE SPRINKLER REQUIRED DESIGN STANDARDS SECTION 433.16 WITH AN INDUSTRIAL PRETREATMENT FORM. SITE PLAN INDICATES UTILIZATION OF EXISTING SIDEWALK AND DRIVEWAYS. CONFIRM ALL FIRE ALARM REQUIRED

SIDEWALKS AND DRIVEWAYS ARE FREE FROM DEFICIENCIES, ADA AND COM COMPLIANT PER FIRE EXTINGUISHER COM STD. DTL. M-42, AND ENGINEERING DESIGN GUIDELINES. G.C. TO COMPLY ON STREET LIGHT PLANS PER CHAPTER 9 OF THE CURRENT COM ENGINEERING &

DESIGN STANDARDS. THIS PROJECT IS LOT 7 OF THE RED MOUNTAIN COMMERCE CENTER AS RECORDED IN BOOK 694, PAGE 18 MCR TRACT A OF THIS COMMERCIAL SUBDIVISION IS DEDICATED AS A RETENTION BASIN FOR THE ENTIRE APPLICABLE CODES

KEYNOTES

- PROPERTY LINE
- EXISTING SCREEN WALL TO REMAIN EXISTING POWER POLE TO REMAIN
- EXISTING STREET LIGHT POLE TO REMAIN

NOT BE AN ALLOWED OR NECESSARY ON THIS PROJECT.

- EXISTING OVERHEAD ELECTRIC LINE TO REMAIN EXISTING ELECTRIC CABINET TO REMAIN
- EXISTING FIRE HYDRANT TO REMAIN 8. EXISTING SIDEWALK TO REMAIN
- 9. EXISTING CONCRETE CURB TO REMAIN 10. EXISTING A.D.A ACCESSIBLE CURB RAMP TO REMAIN
- 11. DASHED LINE INDICATES CURB TO BE REMOVED
- 12. HATCH INDICATES LANDSCAPING 13. NEW STOP SIGN POST, RE: 16/SP2.0
- 14. NEW 6" HIGH CONCRETE CURB, RE: 1/SP2.0
- 15. NEW CURB CUT, PER COM Stnd Dtl M-42, RE: 10/SP2.1
- 16. NEW A.D.A ACCESSIBLE CURB RAMP, MAX. SLOPE 1:12, RE: 12/SP2.0 17. NEW ROOF ACCESS
- 18. NEW TRASH ENCLOSURE, RE: 20/SP2.2 & 1/SP2.3 19. NEW ASPHALT PAVING
- 20. NEW SIDEWALK W/ CONTROL JOINTS AND EXPANSION JOINTS, RE: 1/SP2.3 21. NEW STRIPED CROSSWALK, RE: 12 (A)/SP2.1 22. NEW STANDARD WAY-FINDING ARROW
- 23. NEW PAINTED STOP SIGN, RE: 2/SP2.0 24. NEW A.D.A PARKING, RE: 20/SP2.0
- 25. NEW WHEEL STOP, RE: 11/SP2.0 26. NEW ACCESSIBLE PARKING SIGN, RE: 4/SP2.0 & 12/SP2.1 (B)
- 27. NEW BIKE RACK, RE: 13/SP2.0 28. NEW 20'-0" HIGH POLE MOUNTED SITE LIGHTING
- 29. NEW FIRE RISER ROOM WITH FIRE RISER DOOR SIGN, RE: 17/SP2.0 30. NEW FIRE DEPARTMENT CONNECTION WITH FDC SIGN, RE: 18/SP2.0
- 31. FIRE TRUCK TURNING RADIUS
- 32. NEW WALL PACK LIGHT 33. NEW ELECTRICAL SES CABINET
- 34. NEW EXTERIOR PIPE BOLLARD, RE: 15/SP2.0
- 35. EXISTING PARKING SPACES TO REMAIN 36. EXISTING OFFICE BUILDING TO REMAIN
- 37. EXISTING "RED MOUNTAIN COMMERCE CENTER" SIGN
- 38. EXISTING "NO PARKING" SIGN
- 39. NEW SEPTIC TANK AND SEPTIC PIT
- 40. NEW WATER METER
- 41. NEW COMMUNICATION BOX
- 42. NEW 300 S.F. COMMON OPEN SPACE
- 43. NEW SIGHT VISIBILITY TRIANGLE 44. NEW WATER AND FIRE LINE
- 45. NEW ROOF DRAINS WITH 2 OVERFLOW
- 46. NEW RECESSED HOSE BIBB 47. DASHED LINE INDICATES NEW "NO PARKING" FIRE LANE
- 48. RETAINING WALL, MAX HEIGHT AT 3'-0" 49. NEW KNOX BOX, RE: 7/SP2.0

PROJECT DESCRIPTION

PROPOSED PROJECT WILL BE A NEWLY CONSTRUCTED 1-STORY GROUND UP LIGHT INDUSTRIAL BUILDING (LI-PAD). PROJECT LOCATED AT RED MOUNTAIN COMMERCE CENTER - NORTHEAST CORNER OF E. THOMAS RD AND N. 55TH PL, MESA, AZ. BUILDING WILL BE BUILT IN MASONRY AND METAL FRAME CONSTRUCTION TYPE - EQUIPPED WITH FULLY AUTOMATIC SPRINKLER SYSTEM.

AS PART OF THE SUBMITTAL, AN ALTERNATIVE LANDSCAPE PLAN AND A FOUNDATION BASE EXCEPTION WILL BE REQUESTED AS A PART OF THE SUBMITTAL. CURRENTLY, THIS PROJECT IS IN COMPLIANCE WITH 11-33-7: ALTERNATIVE LANDSCAPE PLAN - LANDSCAPE DESIGN PRINCIPLES #1 (DESIGN PRINCIPLES), #2 (INNOVATIVE DESIGN), #3 (PLANT VARIETY), 4 (NATURALISTIC DESIGN), 5 (COMPATIBILITY WITH SURROUNDING USES), 6 (WATER EFFICIENCY) & 10 (PLANT VIABILITY AND LONGEVITY). THE DEVELOPMENT WILL ALSO BE IN COMPLIANCE WITH CHAPTER 21 BONUS INTENSITY ZONE OVERLAY DISTRICT, 11-21-3: DEVELOPMENT STANDARDS WITH A COMBINATION OF BOTH ITEMS UNDER 1 AND 3 OF THIS SUB CHAPTER.

PROJECT WILL BE BUILT IN COMPLIANCE WITH ALL REGULATIONS ADOPTED BY CITY AND JURISDICTION. THE PROPOSAL IS LOCATED WITHIN THE AIRPORT OVERFLIGHT AREA 3 (AOA 3). FUTURE DEVELOPMENT WILL BE REQUIRED TO MEET THE SUPPLEMENTARY PROVISIONS OUTLINED IN SECTION

> PER MZO SECTION 11-33-7: ALTERNATIVE LANDSCAPE PLAN REQUIRED AREA OF LANDSCAPE SETBACK YARD: 4,018 S.F. PROVIDED AREA FOR LANDSCAPE SETBACK: 4,190 S.F.

PER MZO SECTION 11-33-5(A)(1)

REQUIRED AREA OF BUILDING FRONTAGE: 1,589 S.F. PROVIDED AREA OF BUILDING FRONTAGE: 1,810 S.F.

141-38-027

WITHIN THE 3600 BLOCK OF N 55TH PLACE, NORTH OF E THOMAS RD

LI-PAD (LIGHT INDUSTRIAL) - INDUSTRIAL BUILDING IS PERMITTED

GENERAL PLAN DESIGNATION **EMPLOYMENT - SUB-TYPE: BUSINESS PARKS**

SUB AREA PLAN/S FALCON FIELD

JURISDICTION CITY OF MESA COUNCIL DISTRICT **COUNCIL DISTRICT 5**

B-BUSINESS OFFICE / COMMERCIAL 57,000 S.F. (TABLE 506.2)

34,208 S.F. / 0.785 ACRES 90% - PER CHAPTER 7: TABLE 11-7-3 18,942 S.F. / 34,208 S.F. = 55%

6,380 S.F. / 34,208 S.F. = 19%

SPACE 1: 3,900 S.F.

SPACE 2: 2,000 S.F. SPACE 3: 1,941 S.F.

7,842 S.F.

INDUSTRIAL SHELL BUILDING 75% AT 1 SPACE PER 500 S.F. + 25% AT 1 SPACE PER 375 S.F.

7,842 S.F. x 75% = 5,882 / 500 = 12 SPACES

7,842 S.F. x 25% = 1,961 / 375 = 5 SPACES 12 SPACES + 5 SPACES = 17 SPACES

17 SPACES 17 SPACES YES PER NFPA 13

YES

2A-10B: C PER 3,000 S.F. OF FLOOR AREA MAX TRAVEL DISTANCE OF 75'- TO FIRE EXIT

YES

PANIC HARDWARE

DEVELOPMENT WITH RETENTION VOLUME FOR THE ENTIRE DEVELOPMENT. THEREFORE, DRYWELLS WILL

ALL WORK SHALL BE IN COMPLIANCE WITH, BUT NOT LIMITED TO THE REQUIREMENTS OF THE

FOLLOWING AND ANY OTHER STATE AND LOCAL CODES HAVING JURISDICTION:

2018 IBC (INTERNATIONAL BUILDING CODE)

2018 IMC (INTERNATIONAL MECHANICAL CODE)

2018 IPC (INTERNATIONAL PLUMBING CODE)

2018 IECC (INTERNATIONAL ENERGY CONSERVATION CODE) 2018 IFC (INTERNATIONAL FIRE CODE)

2017 NEC (NATIONAL ELECTRIC CODE)

ARIZONANS WITH DISABILITIES ACT

AMERICANS WITH DISABILITIES ACT ACCESSIBILITY GUIDELINES

2018 AMERICANS WITH DISABILITIES ACT STANDARDS FOR ACCESSIBLE DESIGN

2010 ADA STANDARDS FOR ACCESSIBILITY DESIGN

LEGEND

PROJECT PROPERTY LINE — — — — — — PROPERTY SETBACK LINE * * * * * * * * NEW LANDSCAPE AREA

*** * * * * * * NEW CONCRETE**

— — — — — — — NEW FIRE LANE

NUMBER OF PARKING SPACES **EXISTING STREET POLE LIGHT EXISTING POWER POLE** -

EXISTING OVERHEAD ELECTRIC LINE — О.Н.Е. — —— E —— EXISTING UNDERGROUND ELECTRIC LINE EXISTING UNDERGROUND SEWER LINE ____s__ **EXISTING UNDERGROUND TELEVISION LINE** _____W____ **EXISTING UNDERGROUND WATER LINE**

EXISTING COMMUNICATION JUNCTION BOX EXISTING ELECTRIC TRANSFORMER EXISTING FIRE HYDRANT

NEW FIRE DEPARTMENT CONNECTION **NEW FIRE RISER**

/ITHOUT WRITTEN PERMISSION OF ORPORATION.


checked by: RH


design by: RH

drawn by: **MM**

project #: 23250



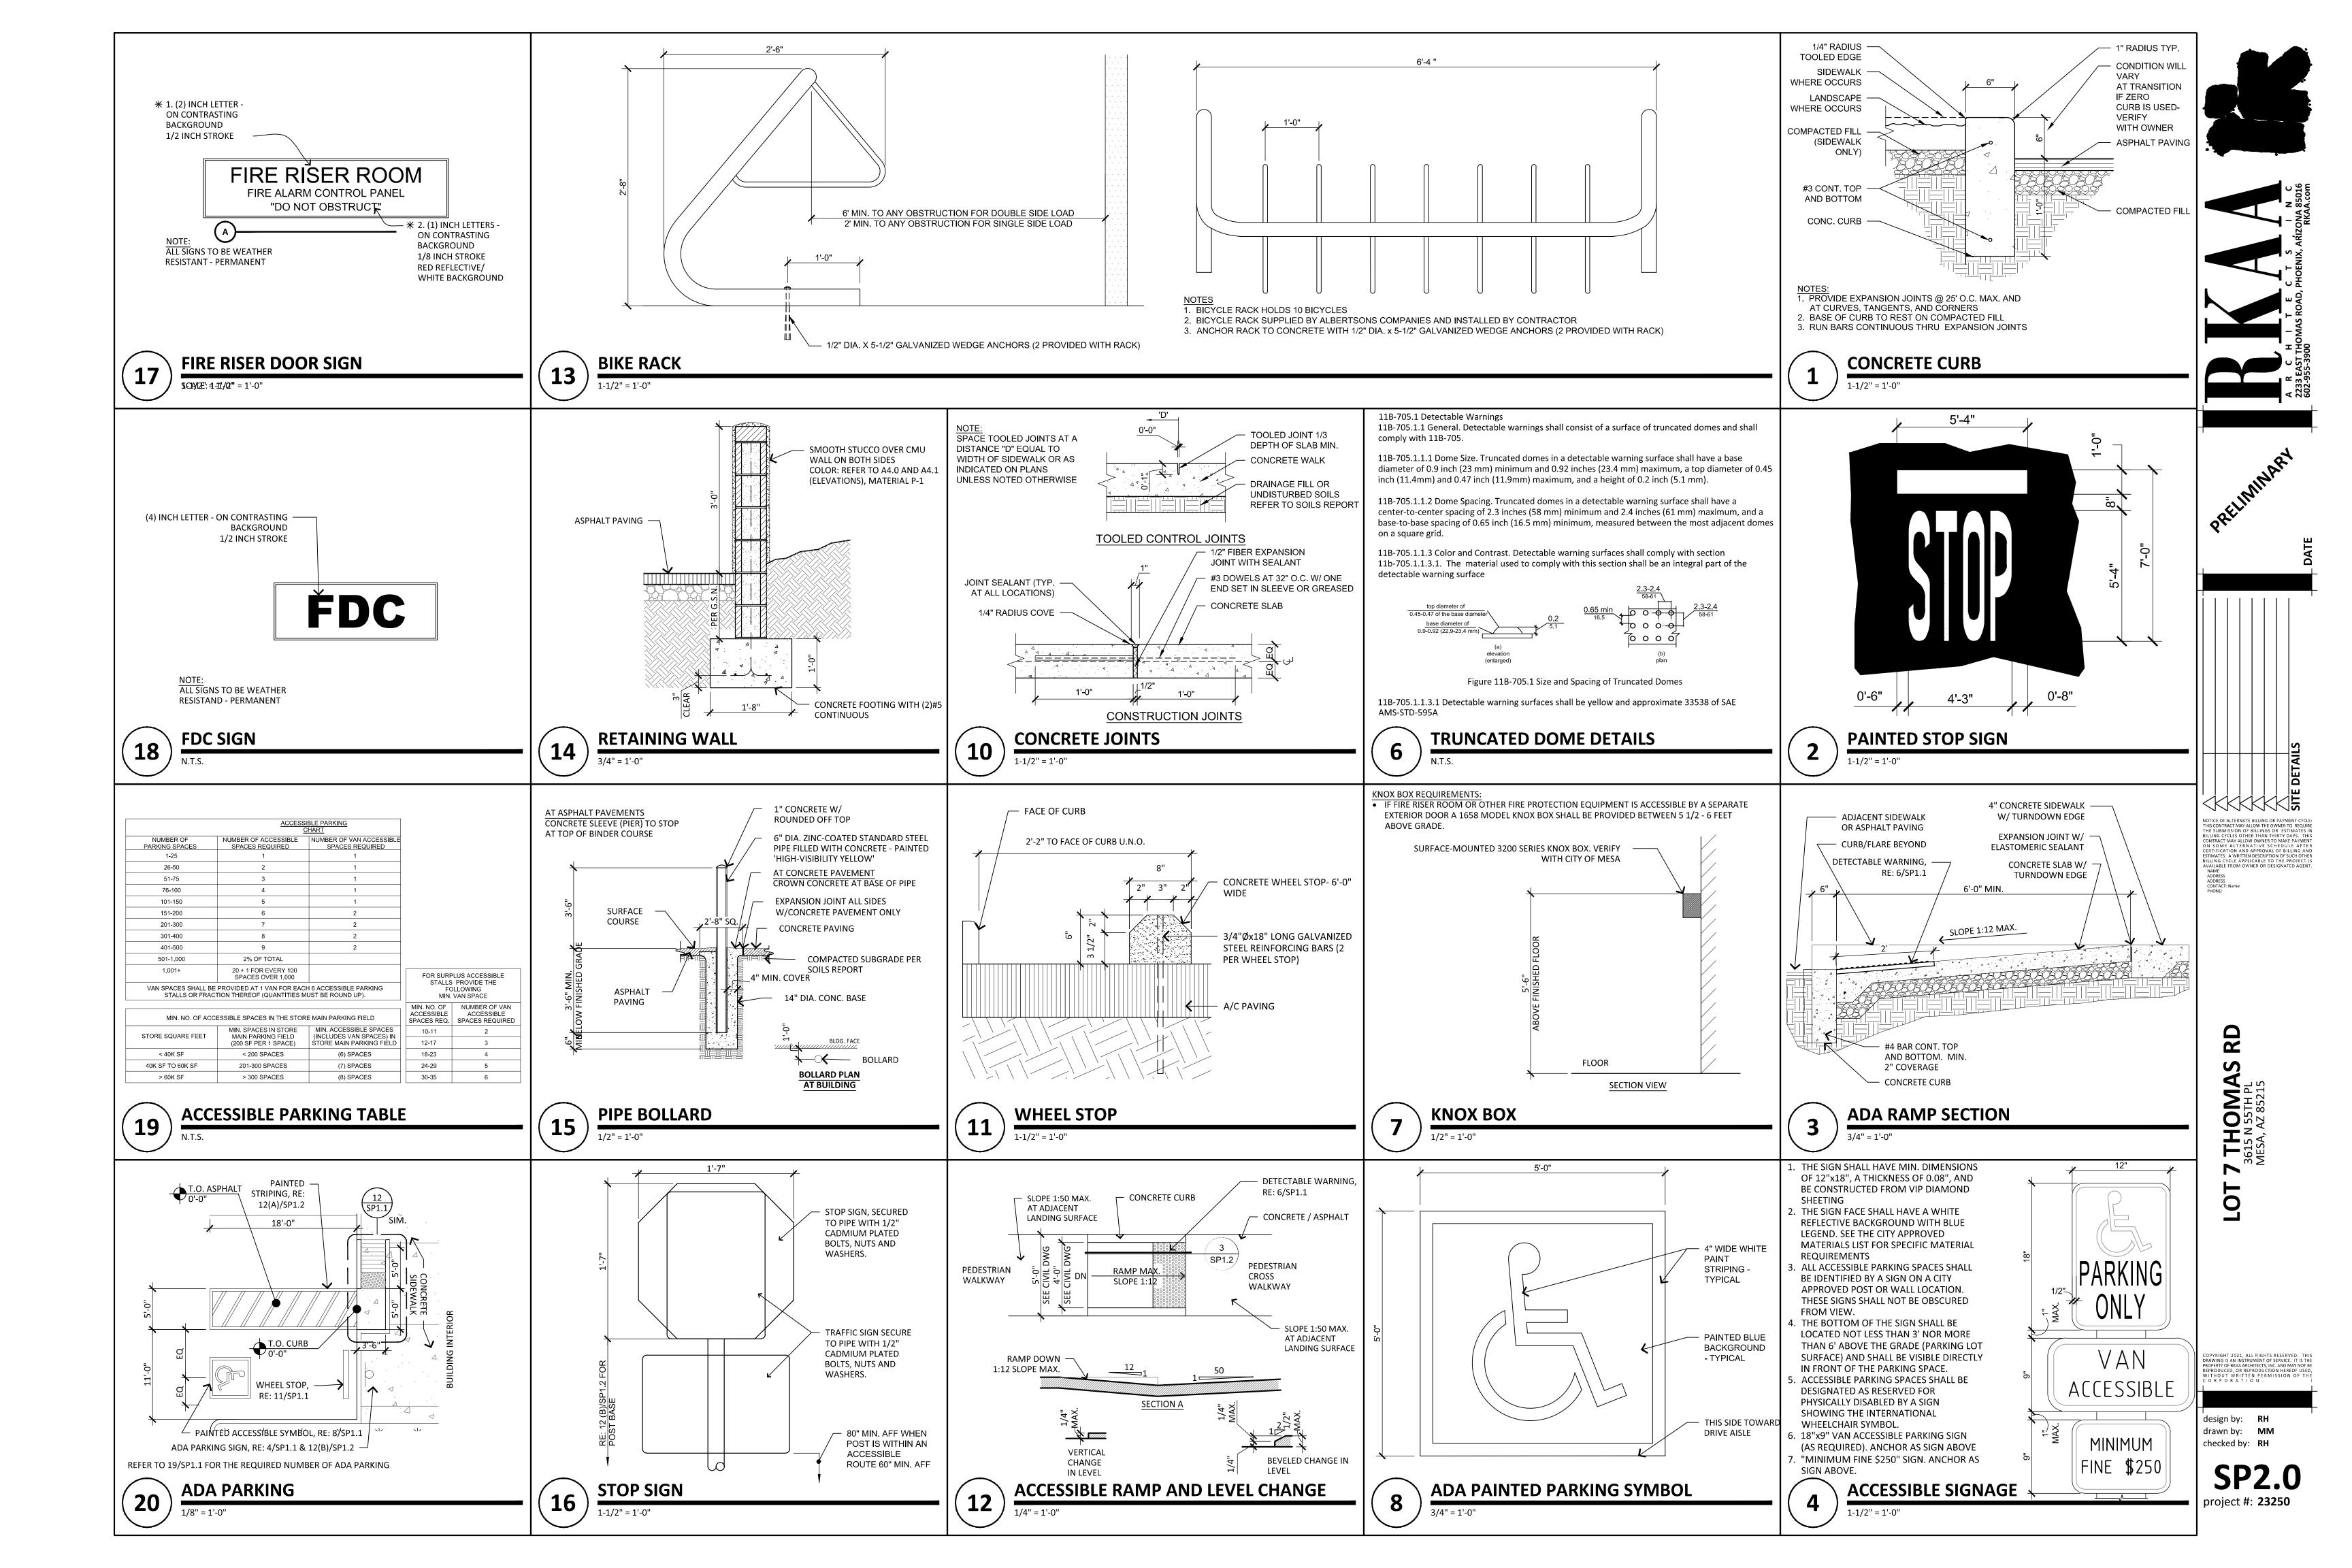

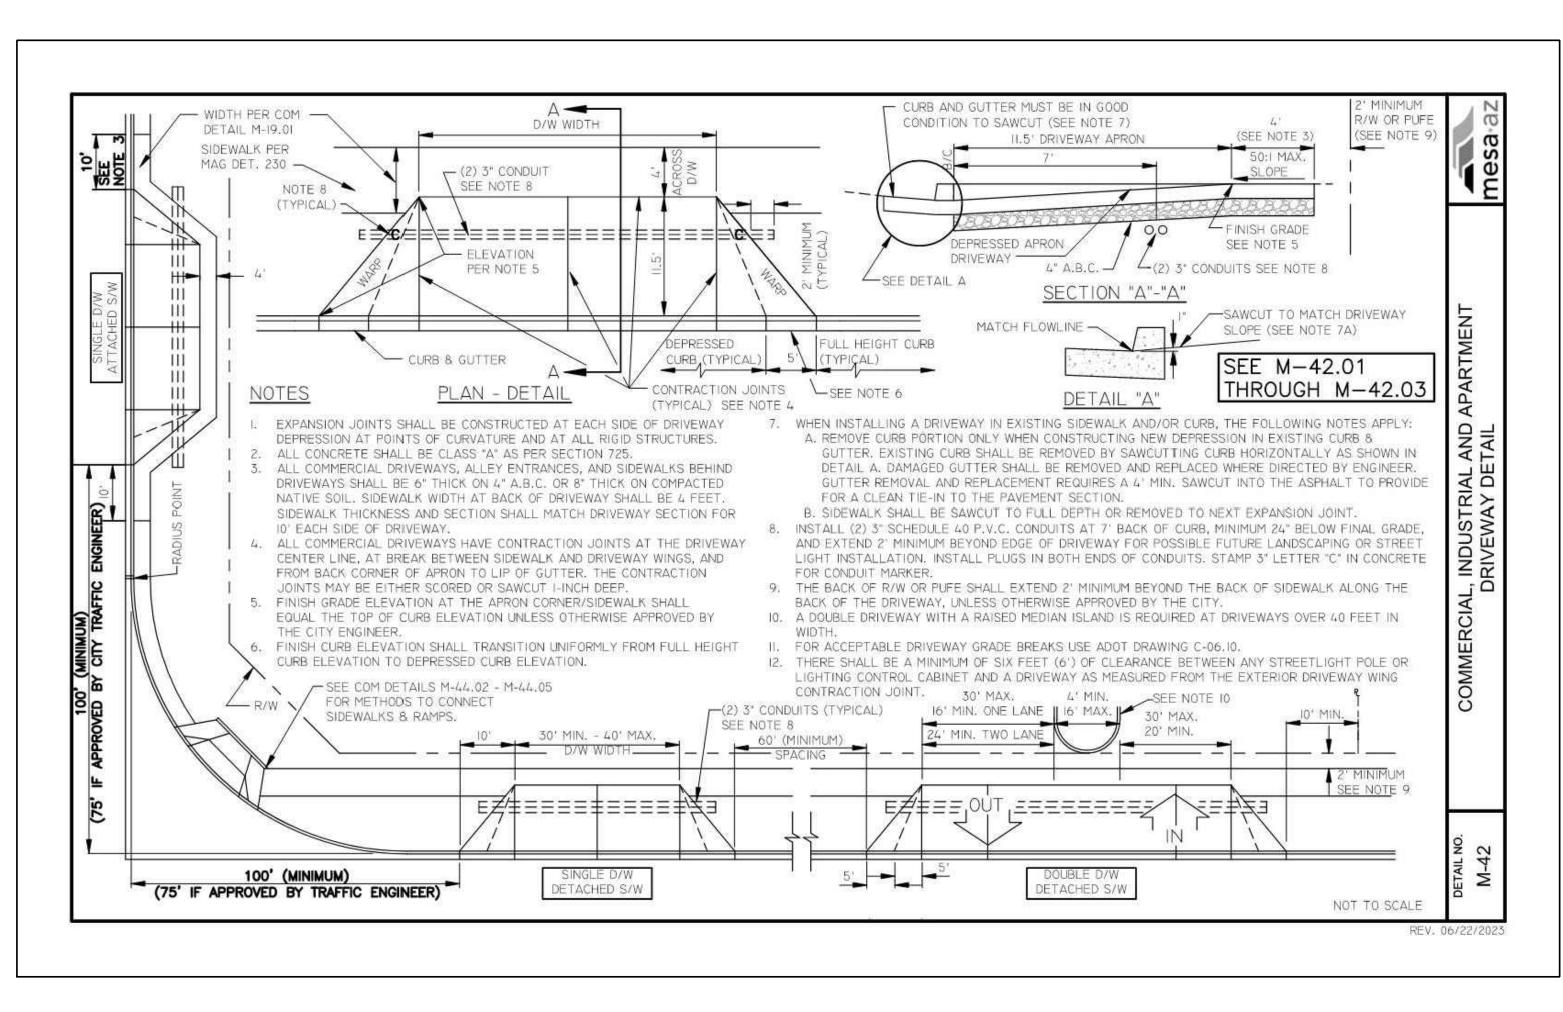

CURB CUT PER COM M-42

1-1/2" = 1'-0"

NOTES I. SEE DETAIL 4/SP1.1 FOR ACCESSIBLE SIGN DETAILS. 2. AN ACCESSIBLE SIGN IS REQUIRED FOR EACH ACCESSIBLE ACCESSIBLE SIGN, PARKING SPACE. SEE NOTE I HANDICAPPED PARKING SIGN TO BE PER SIGN POST LOCATION (TYP.) -THE 2017 ICC/ANSI A117.1 SECTION 8 FIGURE 307.3, POST MOUNTED OBJECTS SHALL OVERHANG A MAXIMUM OF 4" ON EACH SIDE OF THE POST. 2 POSTS MAY ACCESSIBLE AISLE VAIN ACCESSIBLE BE REQUIRED TO ACCOMPLISH THIS. 4' PREFERRED 12" x 6" VAN ACCESSIBLE PLAQUE (WHERE APPLICABLE), SEE NOTE I WHITE MARKINGS (TYP.) TYPICAL ACCESSIBLE STALL MARKINGS SIGN POST LOCATION (TYP.) TOP OF FINISHED GRADE MIN 3' WIDE ACCESSIBLE AISLE 4' PREFERRED WHITE MARKINGS (TYP.) ANCHOR ASSEMBLY PER COM DETAIL M-39 VAN ACCESSIBLE STALL MARKINGS CCESSIBLE SIGN HEIGHT AND INSTALLATION NOT TO SCALE T E C T S I N C
AS ROAD, PHOENIX, ARIZONA 85016
RKAA.com

A R C 2233 EAST

DETAILS


NOTICE OF ALTERNATE BILLING OR PAYMENT CYCTHIS CONTRACT MAY ALLOW THE OWNER TO REQUITHE SUBMISSION OF BILLINGS OR ESTIMATES BILLING CYCLES OTHER THAN THIRTY DAYS. TOONTRACT MAY ALLOW OWNER TO MAKE PAYMION SOME ALTERNATIVE SCHEDULE AFT CERTIFICATION AND APPROVAL OF BILLING SCHOTLING TO THE PROJECT AVAILABLE FROM OWNER OR DESIGNATED AGENAME ADDRESS ADDRESS ADDRESS CONTACT: Name

T 7 THOMAS RD 3615 N 55TH PL MESA, AZ 85215

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design by: RH
drawn by: MM
checked by: RH

SP2.1 project #: 23250

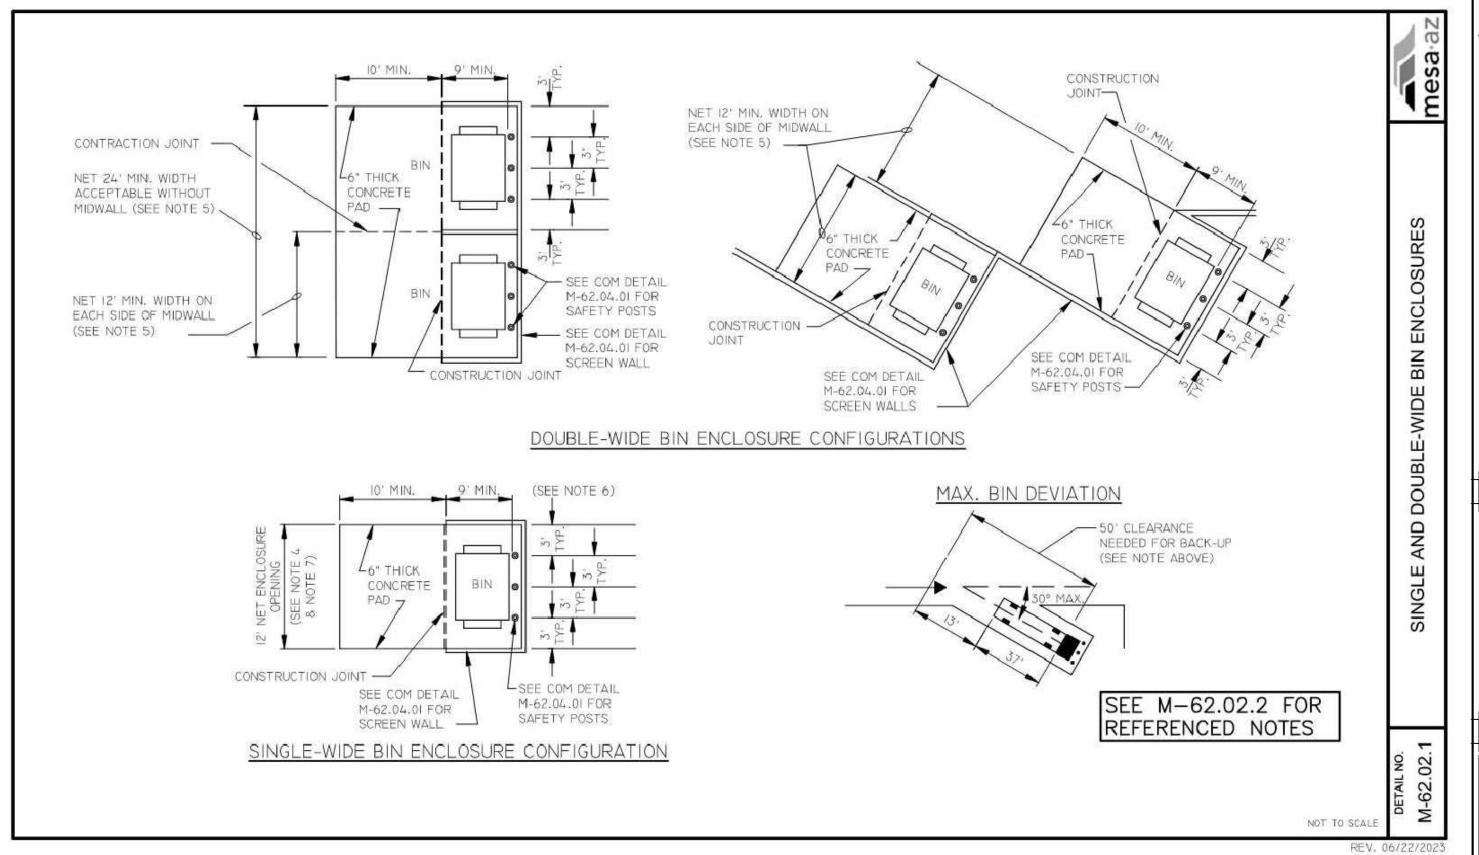

I. TRASH AND RECYCLING BIN AREA SHALL BE SCREENED WITH A SIX FOOT (6') MASONRY WALL PER COM DETAIL M-62.04.1.

2. BIN ENCLOSURE TO BE A MINIMUM OF 3 FEET FROM ANY NON-COMBUSTABLE PLANNED OR EXISTING STRUCTURE AT ITS CLOSEST POINT, AND 5 FEET FROM ANY COMBUSTABLE PLANNED OR EXISTING STRUCTURE AT ITS CLOSEST POINT (PER UNIFORM FIRE CODE 1103.2.2).

3. BINS THAT ARE VISIBLE FROM A PUBLIC ROADWAY SHALL HAVE ENCLOSURE GATES THAT SCREEN THE BINS FROM

4. GATES SHALL BE INSTALLED SO THERE IS A NET BIN ENCLOSURE OPENING OF 12 FEET PER BIN. GATES, HINGES, AND MOUNTING HARDWARE SHALL NOT INTRUDE UPON MINIMUM NET ENCLOSURE OPENING.

5. GATES, HINGES, SAFETY POSTS, AND MOUNTING HARDWARE SHALL BE INSTALLED SO THERE IS A MINIMUM 9 FOOT DEPTH CREATED WITHIN EACH ENCLOSURE.

6. EACH ENCLOSURE GATE SHALL HAVE DROP PINS INSTALLED AND HOLES DRILLED IN THE CONCRETE AT BOTH THE OPEN AND CLOSED POSITIONS TO PREVENT GATES FROM CLOSING INTO THE COLLECTION VEHICLE.

7. BIN ENCLOSURES SHALL HAVE (3) 6" DIAMETER STEEL SAFETY POSTS INSTALLED IN THE BACK OF THE ENCLOSURE ONLY PER COM DETAIL M-62.04.1.

8. SAFETY POSTS SHALL HAVE A HEIGHT OF 6 FEET OR BE EQUAL TO THE HEIGHT OF THE BACK SCREEN WALL OF THE ENCLOSURE, SAFETY POSTS SHALL BE PLACED A MINIMUM OF 4" FROM THE WALL.

9. USE CLASS "A" CONCRETE AS PER SECTION 725 EXCEPT AS NOTED IN SAFETY POST DETAIL ON COM DETAIL M-62.04.1.

STEEL REINFORCEMENT SHALL BE GRADE 40.

II. EXPANSION JOINT FILLER SHALL BE 1/2" BITUMINOUS TYPE PREFORMED EXPANSION JOINT FILLER ASTM D-1751.

12. EXTERIOR FINISH OF 6 FOOT MASONRY SCREEN WALLS SHALL BE COORDINATED ARCHITECTURALLY WITH PRIMARY BUILDING FINISHES.

13. SOIL BELOW THE WALL FOOTER AND CONCRETE PAD SHALL BE COMPACTED TO A DEPTH OF 6 INCHES AND TO A MINIMUM DRY DENSITY OF 90% IN ACCORDANCE WITH ASTM D-2922 AND D-3017, AFTER ADJUSTMENT FOR ROCK CORRECTION.

14. STANDARDS FOR SOLID WASTE VEHICLE ACCESS ARE ADDRESSED IN COM DETAIL M-62.01.

STANDARDS FOR SINGLE, DOUBLE, AND TRIPLE-WIDE BIN ENCLOSURES ARE ADDRESSED IN COM DETAILS M-62.02 AND M-62.03.

SEE M-62.04.1 FOR

REFERENCED NOTES

TO ACCOMMODATE (I) REFUSE AND (I) RECYCLING ENCLOSURE FOR EVERY 20,000 SQUARE FEET OF BUILDING SPACE, RESTAURANTS WHICH ARE DESIGNED ON A SINGLE PAD SHALL HAVE A MINIMUM (I) REFUSE AND (I) RECYCLING ENCLOSURE. THE ENCLOSURES CAN BE SET UP AS DOUBLES OR SINGLES TO MAXIMIZE THE USE OF THE PROPERTY, EACH COMMERCIAL BUILDING REGARDLESS OF SIZE NEEDS TO HAVE ITS OWN DOUBLE ENCLOSURE, ENCLOSURES CANNOT BE ATTACHED TO ANY STRUCTURE.

MULTI-UNIT RESIDENTIAL DEVELOPMENTS SHALL BE DESIGNED WITH EITHER SINGLE OR DOUBLE-WIDE ENCLOSURES FOR TRASH AND AT LEAST ONE ENCLOSURE FOR RECYCLING IDENTIFIED ON THE SITE

13. STANDARDS FOR TRIPLE WIDE ENCLOSURES ARE ADDRESSED IN COM DETAIL COMPACTORS CAN BE USED IN DEVELOPMENTS WHERE THE EMPLOYEES LOAD AND ACTIVATE THE COMPACTING EQUIPMENT, DEVELOPMENTS EQUIPMENT WILL NOT BE APPROVED, MARICOPA COUNTY REGULATIONS (MARICOPA COUNTY ENVIRONMENTAL HEALTH CODE CHAPTER 2, SECTION 5, REGULATION 4 (A)) REQUIRE TWICE PER WEEK COLLECTION 15. STANDARDS FOR PROPERTIES APPROVED FOR BARREL SERVICE ARE IF FOOD WASTE IS PLACED INTO CONTAINERS.

THE NUMBER OF BIN ENCLOSURES NEEDED DEPENDS ON THE SIZE OF THE DEVELOPMENT. TYPICALLY, TOTAL VOLUME NEEDS CAN BE CALCULATED BASED ON ONE HALF-CUBIC YARD PER LIVING UNIT PER WEEK. FOR EXAMPLE, A DEVELOPMENT WITH 240 UNITS X .5 YARDS = 120 YARDS PER WEEK OR 10 TRASH BINS (6 YARD) SERVICED TWO TIMES PER WEEK (10 X 6 X 2 = 120 YARDS).

SINGLE-WIDE BIN ENCLOSURES SHALL HAVE A NET ENCLOSURE OPENING OF 12 FEET BETWEEN THE GATES WHEN OPENED.

DOUBLE-WIDE BIN ENCLOSURES SHALL HAVE A NET ENCLOSURE OPENING OF 24 FEET WITHOUT MIDWALLS. ALTHOUGH NOT PREFERRED, DOUBLE WIDE BIN ENCLOSURES CAN BE DESIGNED WITH MIDWALLS WITH A NET ENCLOSURE OPENING OF 12 FEET ON EACH SIDE OF MIDWALL.

GATES, HINGES, SAFETY POSTS, & MOUNTING HARDWARE SHALL BE INSTALLED SO THERE IS A MIN. 9 FOOT DEPTH CREATED WITHIN EACH ENCLOSURE.

MINIMUM NET ENCLOSURE OPENING SO THERE IS A MINIMUM 12' WIDTH WITHIN EACH ENCLOSURE, DOUBLE ENCLOSURE GATES MUST BE ABLE TO OPEN SIMULTANEOUSLY,

. BIN ENCLOSURES ARE TO BE ANGLED NO MORE THAN 30 DEGREES FROM THE CENTER LINE OF THE SOLID WASTE COLLECTION VEHICLE ROUTE.

ALL COMMERCIAL PROPERTIES SHALL BE DESIGNED WITH ENCLOSURES 9. BIN ENCLOSURES ARE TO BE ANGLED NO MORE THAN 30 DEGREES FROM THE 22. USE OF A BOLLARD ENCLOSURE IS SUBJECT TO CENTER LINE OF THE SOLID WASTE COLLECTION VEHICLE ROUTE.

> 10. BINS THAT ARE VISIBLE FROM A PUBLIC ROADWAY SHALL HAVE ENCLOSURE GATES THAT SCREEN THE BINS FROM PUBLIC VIEW. II. BIN ENCLOSURES TO BE A MINIMUM OF 3 FEET FROM ANY NON-COMBUSTIBLE

COMBUSTIBLE PLANNED OR EXISTING STRUCTURE AT ITS CLOSEST POINT (PER UNIFORM FIRE CODE 1103.2.2).

PLANNED OR EXISTING STRUCTURE AT ITS CLOSEST POINT; 5 FEET FROM ANY

12. STANDARDS FOR SOLID WASTE VEHICLE ACCESS ARE ADDRESSED IN COM-DETAIL M-62.01.

THAT ALLOW CUSTOMERS OR RESIDENTS ACCESS TO THE COMPACTING 14. STANDARDS FOR BIN ENCLOSURE SCREEN WALLS, SAFETY POSTS, AND GATES ARE ADDRESSED IN COM DETAIL M-62.04.1.

ADDRESSED IN COM DETAIL M-62.05.

M-62.03.

RESTAURANTS MUST PROVIDE A SEPARATE ENCLOSED AREA TO ACCOMMODATE THEIR GREASE TRAP. THIS DESIGNATED AREA MUST NOT INTERFERE WITH THE TRASH/RECYCLING COLLECTION.

17. SOLID WASTE ENCLOSURES MAY INCLUDE WATER CONNECTIONS & DRAINS TO FACILITATE CLEANING OF DUMPSTERS. THESE SHOULD BE LOCATED TO NOT IMPEDE THE ENCLOSURE OPENING (AND GATING IF REQUIRED). ADDITIONAL ITEMS SUCH AS LANDSCAPING CONTROL BOXES AND LIGHTING MAY BE POSITIONED ON THE OUTSIDE OF THE ENCLOSURE WALLS.

18. TREE PLANTING SHOULD NOT TAKE PLACE WITHIN TEN (10) FEET OF THE BIN ENCLOSURE AND SHOULD BE SPACED SO AS NOT TO CREATE AN AERIAL OBSTRUCTION FOR THE BIN DUMPING AT THE FINAL FULL GROWTH DIMENSIONS. TREE PLANTING CANNOT ENCROACH THE 50' MANEUVERABILITY

19. TRASH ENCLOSURES FOR COMMERCIAL PROPERTIES MUST BE EVENLY SPACED FOR TENANT ACCESS. TRASH ENCLOSURES FOR APARTMENT/CONDO/TOWN-HOME/ MULTI-FAMILY COMPLEXES MUST BE EVENLY SPACED FOR RESIDENTIAL ACCESS.

GATES, HINGES AND MOUNTING HARDWARE SHALL NOT INTRUDE UPON 20. NO OBJECT OF ANY KIND SHALL BE STORED IN OR WITHIN 4' OUTSIDE OF ENCLOSURE AREA.

> 21. A REQUIRED 50' RECTANGULAR DIMENSION IN FRONT OF EACH ENCLOSURE MUST BE SHOWN ON THE SITE PLAN, THIS WILL ALLOW THE OPERATOR SAFE MANEUVERABILITY. THIS AREA MUST BE FREE AND CLEAR OF ALL OBSTRUCTIONS INCLUDING TREES. OVERHEAD OBSTRUCTIONS MUST BE MINIMUM HEIGHT OF 25'. REFER TO MAX. BIN DEVIATION ON DETAIL M-62.02.1.


APPROVAL BY THE CITY OF MESA SOLID WASTE DEPARTMENT DURING THE DESIGN PHASE OF THE PROJECT.


23. BOLLARD ENCLOSURES, WHEN APPROVED, WILL B DESIGNED PER COM DETAIL M-62.04.01 SAFETY POST. BOLLARDS WILL BE ET HORIZONTALLY TO REPLICATE SCREEN WALL DIMENSIONS PER COM DETAIL M-62.02.1, HAVING A MAXIMUM SPACING O 3' FROM CENTER OF BOLLARD TO CENTER OF BOLLARD.

design by: RH drawn by: MM checked by: RH

TICE OF ALTERNATE BILLING OR PAYMENT CYC S CONTRACT MAY ALLOW THE OWNER TO REQU S SUBMISSION OF BILLINGS OR ESTIMATES

CERTIFICATION AND APPROVAL OF BILLING AND ESTIMATES. A WRITTEN DESCRIPTION OF SUCH OTHE BILLING CYCLE APPLICABLE TO THE PROJECT !! AVAILABLE FROM OWNER OR DESIGNATED AGENT NAME ADDRESS ADDRESS ADDRESS CONTACT: Name PHONE:

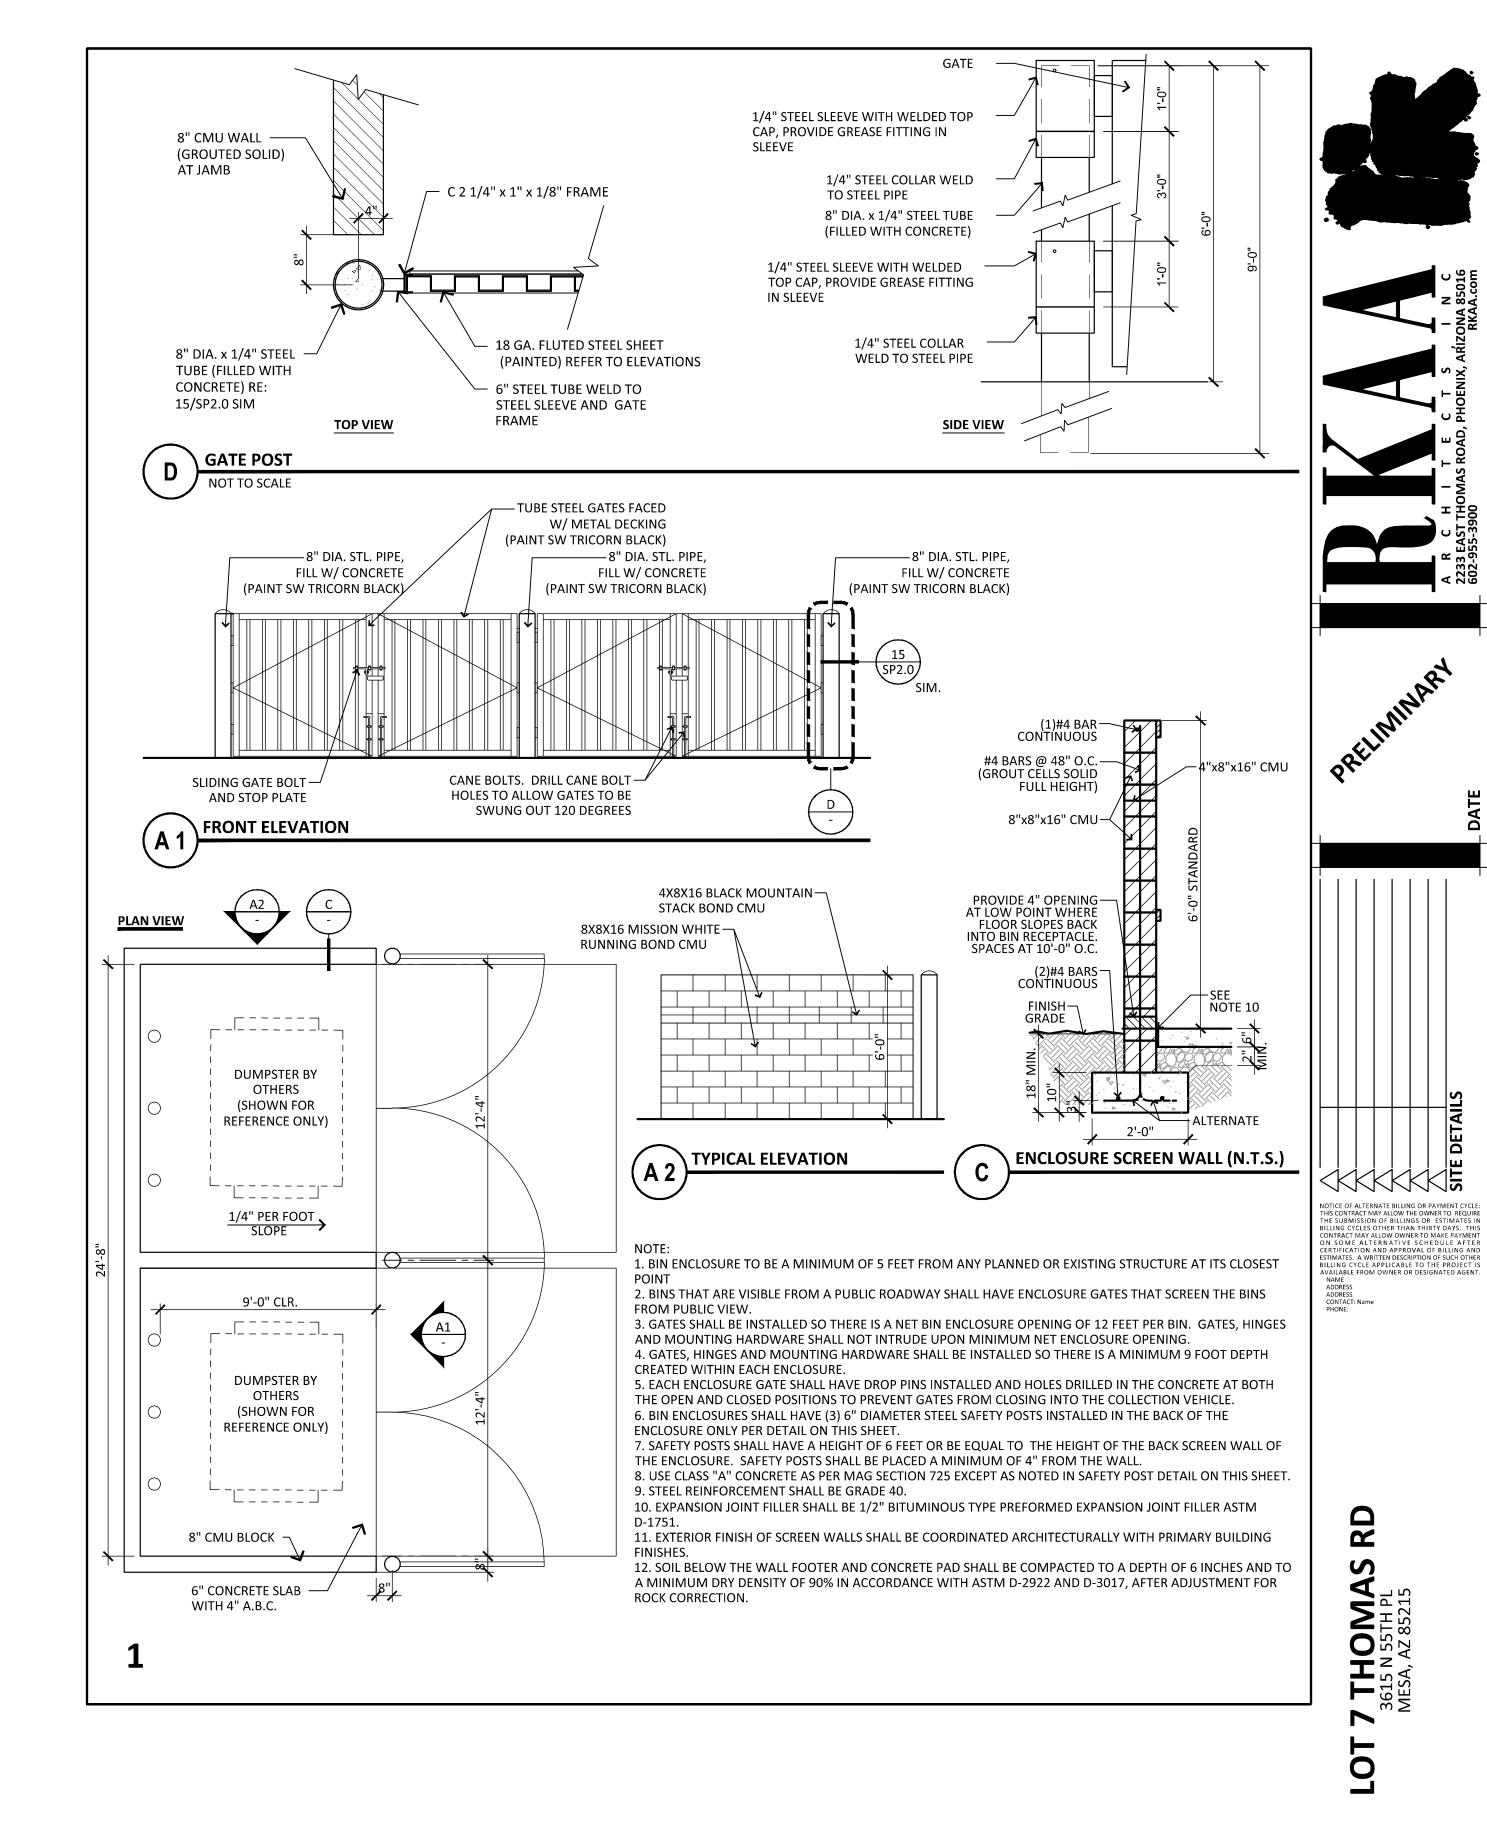

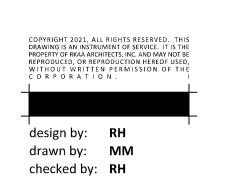

SP2.3 project #: 23250