
						☐ △{ DOOR SCHEDULE					
No.	SIZE	FUNCTION	HDR.	NOTES		No.	TYPE	SIZE	FUNCTION	NOTES	_և
	3046	XO	8'-0"			口	Α	2'-8" x 6'-8"	SWING		
2	6060	XO	8'-0"		8	2) c	2'-4" x 6'-8"	SWING		
(3)	3050	FXD	8'-0"		(<u> </u>) c	2'-6" x 6'-8"	SWING] 7
4	2050	FXD	8'-0"			4	С	NOT USED	BARN DOOR		$\exists \vdash$
(5)	6050	XO	8'-0"			5	С	NOT USED	POCKET		
NOTE: ALL WINDOWS TO BE VINYL, MANUFACTURER TBD.					6	С	4'-0" x 6'-8"	SWING (PAIR)			
						7	С	5'-0" x 6'-8"	SWING (PAIR)		
						8	B, D, E	3'-0" x 8'-0"	SWING] 7
NOTE.						9) -	16'-0" x 8'-0"	OVERHEAD] >
	NOTE:						С	6'-0" x 6'-8"	BI-PASS		<u> </u>
	DIMENSIONS CHOWN ON THIS ONCE NOT FOO OFFICENCE CET										

DIMENSIONS SHOWN ON THIS PAGE ARE FOR REFERENCE — SEE SHEETS A2-A3.1 FOR FINAL DIMENSIONS & LAYOUT

A =MIN. OF I 3/8" SOLID CORE W/ SELF CLOSER, SELF LATCHING, & TIGHT FITTING GASKETS & SWEEP — I.R.C. SEC. R309.1 D = TEMPERED GLASS **B** = SOLID CORE C =HOLLOW CORE

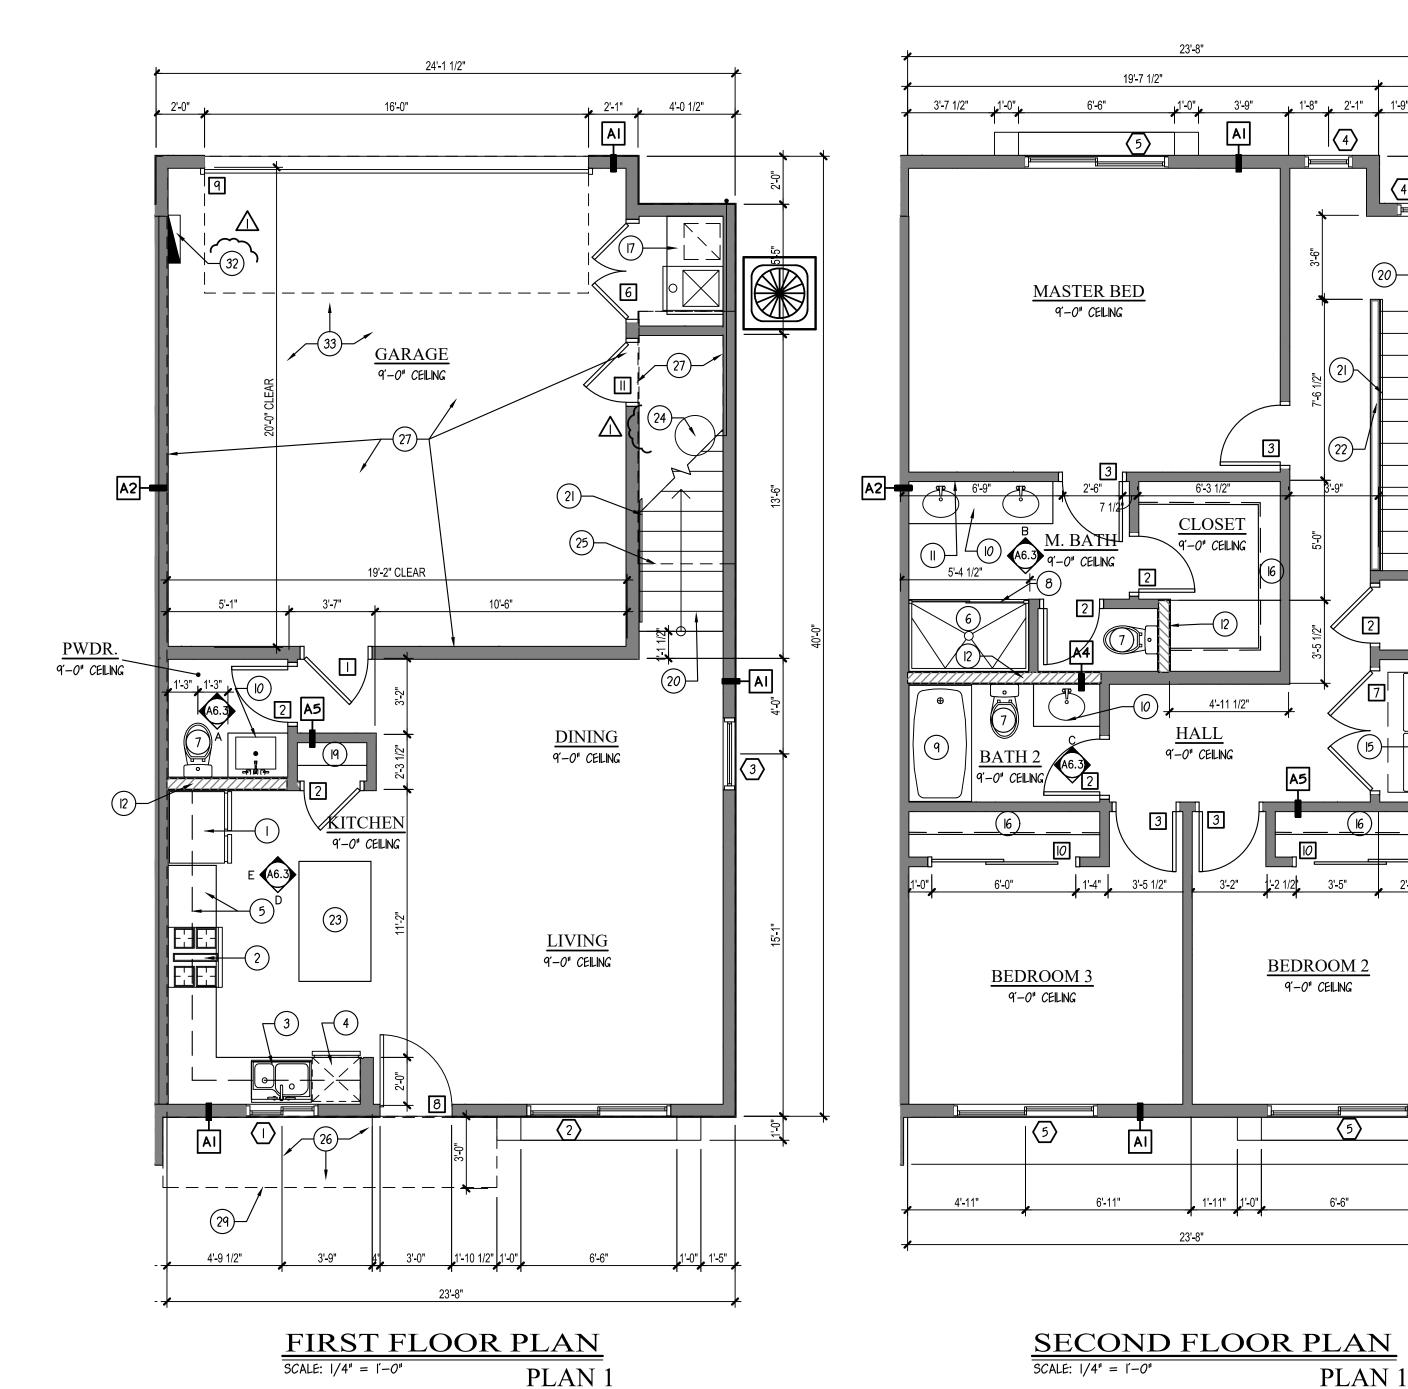

(PLAN 1 & PLAN 2 USED @ TRIPLEX & FOUR PLEX)

KEYNOTES

DESCRIPTION REFRIGERATOR - PRE-PLUMB FOR ICE MAKER RANGE & OVEN v/ HOOD/MICROWAVE ABOVE - PER OWNER HOOD EXHAUST @ +77" - VENT TO EXTERIOR WALL DOUBLE SINK w/ DISPOSAL

DISHWASHER — PROVIDE APPROVED AIR GAP

COUNTERTOP v/ BASE & UPPER CABINETS 32"x60" PREFAB SHOWER PAN v/ MOISTURE RESISTANT GYP. BD. W/ TILE, MARBLE OR EQ. TO +72" ABV. DRAIN
WATER CLOSET PROVIDE A (MIN.) 15" ON EACH SIDE & 24" (MIN.) CLEAR IN FRONT

4" CURB v/ SHOWER GLASS PORCELAIN STEEL TUB/SHOWER COMBO. v/ ROD FOR SHOWER CURTAIN

SINK AND VANITY $\mathbf{E} = \mathbf{I} - \mathbf{LITE} \ \mathbf{DOOR}$ 42" HIGH MIRROR IN MASTER BATHROOM & ALL

SECONDARY BATHROOMS — U.N.O. ON PLAN 2x6 PLUMBING WALL

WASHER-PROVIDE PAN UNDERNEATH FOR DRAIN OVERFLOW DRYER - 4" DRYER VENT THROUGH ROOF - NOT TO EXCEED 25'-0" PER I.R.C.

SHELF OR UPPER CABINETS - VERIFY w/ OWNER

SHELVING PER OWNER

F.A.U. ON RAISED PLATFORM PER MECHANICAL TEMPERED GLASS

5 SHELVES EQUALLY SPACED

STAIRS PER I.R.C. SEC. (MAX. RISE=7 3/4" - MIN. RUN=10") HANDRAIL - +34" TO +38" MAX

HANDRAIL/GUARDRAIL @ +36" MIN. w/ SPINDLES @ 4" O.C. IF APPLICABLI

ISLAND COUNTERTOP 36" DEEP WATERFALL EDGE ON SIDES v/ 24" DEEP BASE CABINETS & I' DEEP KNEESPACE WH v/ PRESSURE RELIEF VALVE AND DRAIN PAN (P2801.5). DRAIN LINE TERMINATES PER (P2801.5.2). INSTALL HOT WATER CIRCULATION PUMP LINE OF CEILING CHANGE

CONCRETE SLAB SLOPE 1/4" P.L.F. MIN.

5/8" TYPE 'X' GYPSUM BOARD o/ WALLS & CEILING PER

CVD. ENTRY, STUCCO WRAPPED SOFFIT @ +9'-0"

HOSE BIBB — VERIFY LOCATION

NOTE:

NOT USED ELECTRICAL PANEL - SEE ELECTRICAL PLANS

GARAGE FLOOR SLOPE MIN. 1/8" P.L.F.

THE MANUFACTURER'S NAME, TRADEMARK OR OTHER

DESCRIPTIVE MARKING BY WHICH THE ORGANIZATION

RESPONSIBLE FOR THE PRODUCT CAN BE IDENTIFIED SHALL BE


PLACED ON ALL ELECTRICAL EQUIPMENT. OTHER MARKINGS SHALL BE PROVIDED THAT INCLUDE VOLTAGE, CURRENT,

WATTAGE OR OTHER RATINGS AS SPECIFIED ELSEWHERE IN

DURABILITY TO WITHSTAND THE ENVIRONMENT INVOLVED.

CHAPTERS 34 THROUGH 43. THE MARKING SHALL HAVE THE

ELEVATION KEY

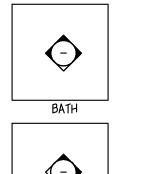

● 2x6 WOOD FRAMED EXTERIOR BEARING WALL & EXTERIOR INSULATION WHERE APPLICABLE - SEE DTL. 1/A7.1

> • EXTERIOR: WOOD SHEETING PER STRUCTURAL, MOISTURE BARRIER, COLOR CEMENTITIOUS STUCCO WITH ACRYLIC

A 2 2x4 WOOD FRAMED INTERIOR I—HOUR FIRE SOUNDPROOF PARTITION WITH A4, FRAMING @ 16" O.C. U.N.O., PROVIDE

PARTITION, FRAMING @ 16" O.C. U.N.O., PROVIDE R-11 BATT INSULATION & FRAMING TO RECEIVE 1-HOUR FIRE <u>PROTECTION</u>. SEE DTL. 3/A7.I

• 2x4 WOOD FRAMED INTERIOR 2—HOUR FIRE SOUNDPROOF

• EXTERIOR: (2) I" x 24" PROPRIETARY TYPE 'X' GYPSUM PANEL BETWEEN 2" FLOOR AND CEILING RUNNERS v/ 1/2" GYP. ON BOTH SIDES IN CAVITY

FRAMING @ 24" O.C. U.N.O.

• EXTERIOR: N/A.

• INTERIOR: 1/2" GYPSUM WALL BOARD INSTALL

GENERAL PLAN NOTES

THE ARCHITECT SHALL BE NOTIFIED OF ANY DISCREPANCIES WITH CODE, SUPPLEMENTARY DRAWINGS OR REPORTS. EXTERIOR TRIM, DOOR AND WINDOW HEAD, JAMBS AND SILLS, SOFFITS, EXTERIOR RAILING TYPES ARE AS INDICATED AND REFERENCED ON PROVIDE 1/2" CEILING RATED GYP. BD. AT CEILING PROVIDE FIBER

CEMENT BD. AT PATIO & PORCH CEILINGS - TAPE & TEXTURE PER PROJECT SPEC'S. SEE BUILDING PLANS FOR LOCATION AND SEE SITE PLAN FOR BUILDING

LOCATIONS AND BUILDING TYPES. SMOKE DETECTORS SHALL BE 110V, v/ BATTERY BACKUP & SHALL BE LOCATED IN EACH BEDROOM & HALLWAY LEADING THERE TO. BEDROOM SHALL HAVE A MINIMUM OF ONE OPENING WHICH MEETS PER SECTION 2509.3 IBC HEIGHT, 5.7 S.F. NET CLEAR OPENABLE AREA AND SHALL BE 44" MAXIMUM FROM FINISH. FLOOR TO SEE MECHANICAL DRAWINGS VENTILATION, DRYER VENTS, EXHAUST TOP OF SILL AS REQUIRED PER IBC SECTIONS 1029.2 & 1029.3 FANS AND DUCT LOCATIONS.

SEE BUILDING PLAN ROOF PLANS FOR VARIATION IN ROOFS OVER EACH UNIT DESIGNATION. VERIFY SIZE OF MECHANICAL UNIT PRIOR TO FRAMING ENCLOSURE. VERIFY WITH MECHANICAL CONTRACTOR DIRECTION OF FRAMING FOR

DROPPED CEILINGS, DROPPED CEILINGS TO BE NON-COMBUSTIBLE SEE DETAILS FOR TYPICAL ASSEMBLIES, OCCUPANCY AND FIRE WALLS FRAMING. DETAILS, REQUIREMENTS FOR MEMBRANE AND PENETRATION DETAILS, AND TYPICAL WALL AND SEE EXTERIOR ELEVATIONS FOR MATERIAL TYPE, ELEVATION, FLOOR PLAN DIMENSION VARIATIONS, AND UNIT ENTRY ALL INTERIOR ADHESIVES, SEALANT, PAINTS & COATINGS SHALL BE LOW-VOC. USE OF LOW-VOC PAINTS AND STAINS (NON-FLAT: 150 G/L OR LESS, FLAT: 50G/L OR LESS) FOR ENERGY STAR RATED APPLIANCES, INCLUDING BUT NOT LIMITED TO, REFRIGERATORS, DISHWASHERS, AND CLOTH WASHERS SHALL BE

FACILITIES. PROVIDE CARBON MONOXIDE ALARMS, INTERCONNECTED AND SHALL BE HARDWIRED WITH PROVIDED IN ALL OTHER FLOOR SPACES UNLESS THE BATTERY BACK-UP. REQUIREMENT IS SPECIFICALLY

INSTALLED WHEN SUCH APPLIANCE ARE PROVIDED OR REPLACED

WITHIN LOW-INCOME UNITS AND / OR IN ON-SITE COMMUNITY

GENERAL WALL INFO

WALL FRAMING #2 D.F. - SEE STRUCTURAL - U.N.O. EXTERIOR WALLS - 2x6, @ 16" o.c. U.N.O. INTERIOR BEARING WALLS - 2x @ 16" o.c. U.N.O. INTERIOR NON BRG. - 2x4, @ 24" o.c. U.N.O. PLUMBING WALLS - 2x6 U.N.O. - 16" O.C. @ TUBS & SHOWERS FOR PROPER INSTALLATION OF DENS SHIELD INSULATION: MANUFACTURER: CERTAIN TEED OR APPROVED

MATERIAL: BATT INSULATION WALL INSULATION: (2x6) R-19, (2x4) FURRING R-13, AIR CONDITIONED AREAS CEILING INSULATION: R-38 OVER ALL LIVABLE AREAS GARAGE INSULATION: R-19 BETWEEN GARAGE & ALL LIVABLE SPACES.) CAULK AND SEAL BOTTOM PLATES, PENETRATIONS, WINDOWS, AND DOORS. WINDOWS- U FACTOR .40 MAX., SHGC .25 MAX. WHEN APPLYING WATER-BASED TEXTURE MATERIAL, THE

MIN. GYP. BOARD THICKNESS SHALL BE INCREASED FROM

3/8" TO 1/2" THICK FOR 16" O.C. FRAMING AND FROM 1/2" TO 5/8" THICK FOR 24" O.C. FRAMING OR 1/2" SAG RESISTANT GYP. BOARD SHALL BE USED. PROVIDE 5/8" TYPE 'X' GYPSUM BOARD ON WALLS & CEILING IN GARAGE & ON USABLE SPACE UNDER STAIRS PER

ALL BATH ACCESSORIES, (TOWEL BARS, HOOKS ETC.,) AND MOUNTING HEIGHTS TO BE DETERMINED BY OWNER

WALL TAG LEGEND

2X FRAMED WALL

2x6 PLUMBING WALL

EXTERIOR WALLS

POP-OUTS, FRAMING @ 16" O.C. U.N.O. PROVIDE R-19 BATT

COAT, INSTALL PER MANUFACTURER'S SPECIFICATIONS.

• INTERIOR: 1/2" GYP., FINISH PER ROOM FINISH SCHEDULE IINTERIOR WALLS

> R-II BATT INSULATION & FRAMING TO RECEIVE I-HOUR FIRE <u>PROTECTION</u>. SEE DTL. 2/A7.I

EXTERIOR: N/A

● INTERIOR: 2 LAYERS 5/8" TYPE X GYPSUM WALLBOARD FINISH PER ROOM FINISH SCHEDULE

• INTERIOR: 2 LAYERS 5/8" TYPE X GYPSUM WALLBOARD BOTH SIDES FINISH PER ROOM FINISH SCHEDULE

• 2x6 WOOD FRAMED INTERIOR PLUMBING WALL, FRAMING @ 24" O.C. U.N.O., PROVIDE R-II BATT INSULATION

EXTERIOR: N/A • INTERIOR: 5/8" TYPE X GYPSUM WALLBOARD INSTALL BOTH SIDES - FINISH PER ROOM FINISH SCHEDULE

■ 2x4 OR 2x6 WOOD FRAMED INTERIOR PARTITION,

BOTH SIDES FINISH PER ROOM FINISH SCHEDULE

RESIDENTIA NOTED 8 DIMENSIONED

FLOOR

ARCHITECTURE

40666 N PARISI PL

SAN TAN VALLEY, AZ 85140

480.798.9460

44548

DAVID A.

MARR

Expires 06/30/27

design.drafting.planning

8 3 2 S. 3 4 TH ST. MESA, AZ 8 5 2 0 4 PHONE: 480-206-9959

REVISIONS

SHEET NO.

/\ - CITY 3/19/25

2 - OWNER 3/19/25


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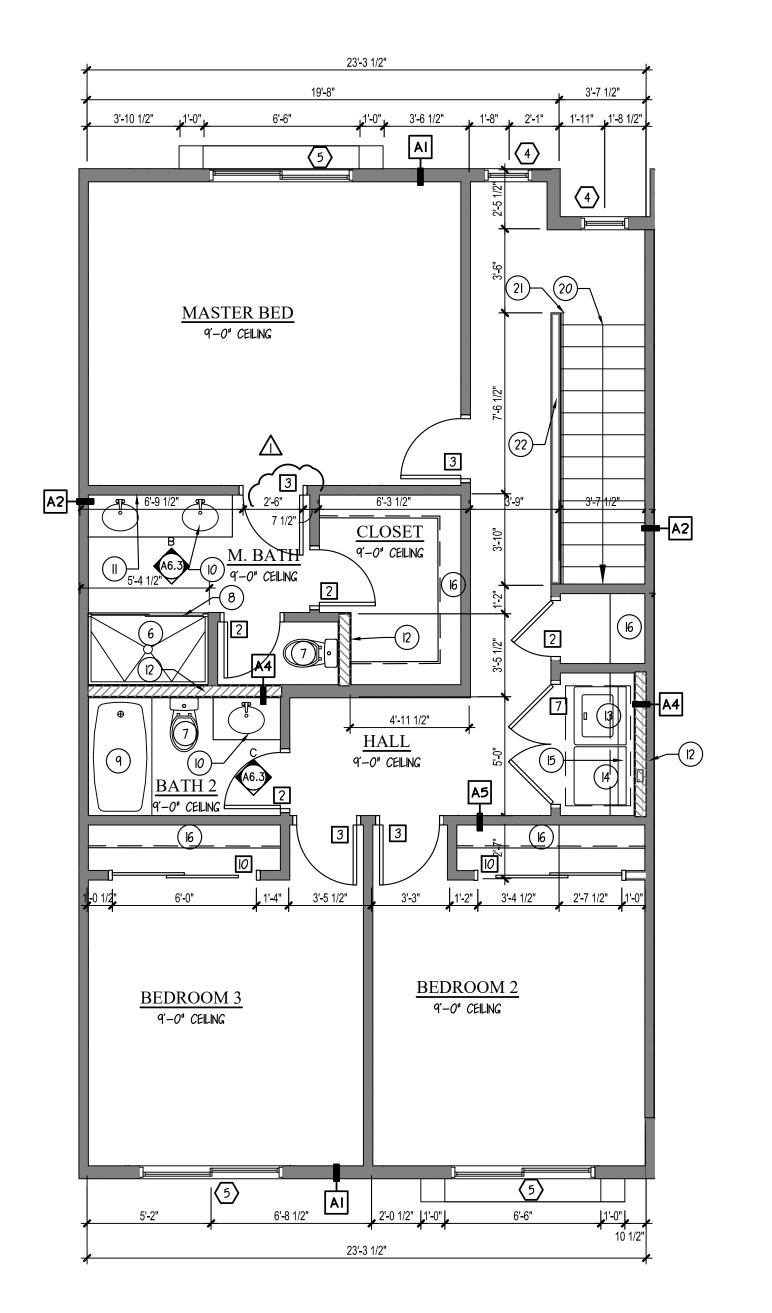
								_			
						☐ △{ DOOR SCHEDULE					
No.	SIZE	FUNCTION	HDR.	NOTES		No.	TYPE	SIZE	FUNCTION	NOTES	╙
	3046	XO	8'-0"			Д	Α	2'-8" x 6'-8"	SWING		N
2	6060	XO	8'-0"		- 6	2	C	2'-4" x 6'-8"	SWING		
(3)	3050	FXD	8'-0"		(<u> </u>) c	2'-6" x 6'-8"	SWING		
4	2050	FXD	8'-0 "			4	С	2'-6" x 6'-8"	BARN DOOR		
(5)	6050	XO	8'-0"			5	С	2'-4" x 6'-8"	POCKET		
NOTE:	NOTE: ALL WINDOWS TO BE VINYL, MANUFACTURER TBD.						С	4'-0" x 6'-8"	SWING (PAIR)		
							С	5'-0" x 6'-8"	SWING (PAIR)][C]
								3'-0" x 8'-0"	SWING] >
NOTE.) -	16'-0" x 8'-0"	OVERHEAD		
	NOTE:						С	6'-0" x 6'-8"	BI-PASS		
	DIMENSIONS SHOWN ON THIS PAGE ARE FOR REFERENCE — SEE							2'_6" v 6'_8"	SWINC		

SHEETS A2-A3.1 FOR FINAL DIMENSIONS & LAYOUT

A =MIN. OF I 3/8" SOLID CORE v/ SELF CLOSER, SELF LATCHING, & TIGHT FITTING GASKETS & SWEEP — I.R.C. SEC. R309.1 B = SOLID CORE D = TEMPERED GLASS C =HOLLOW CORE

 $\mathbf{E} = \mathbf{I} - \mathbf{LITE} \ \mathbf{DOOR}$



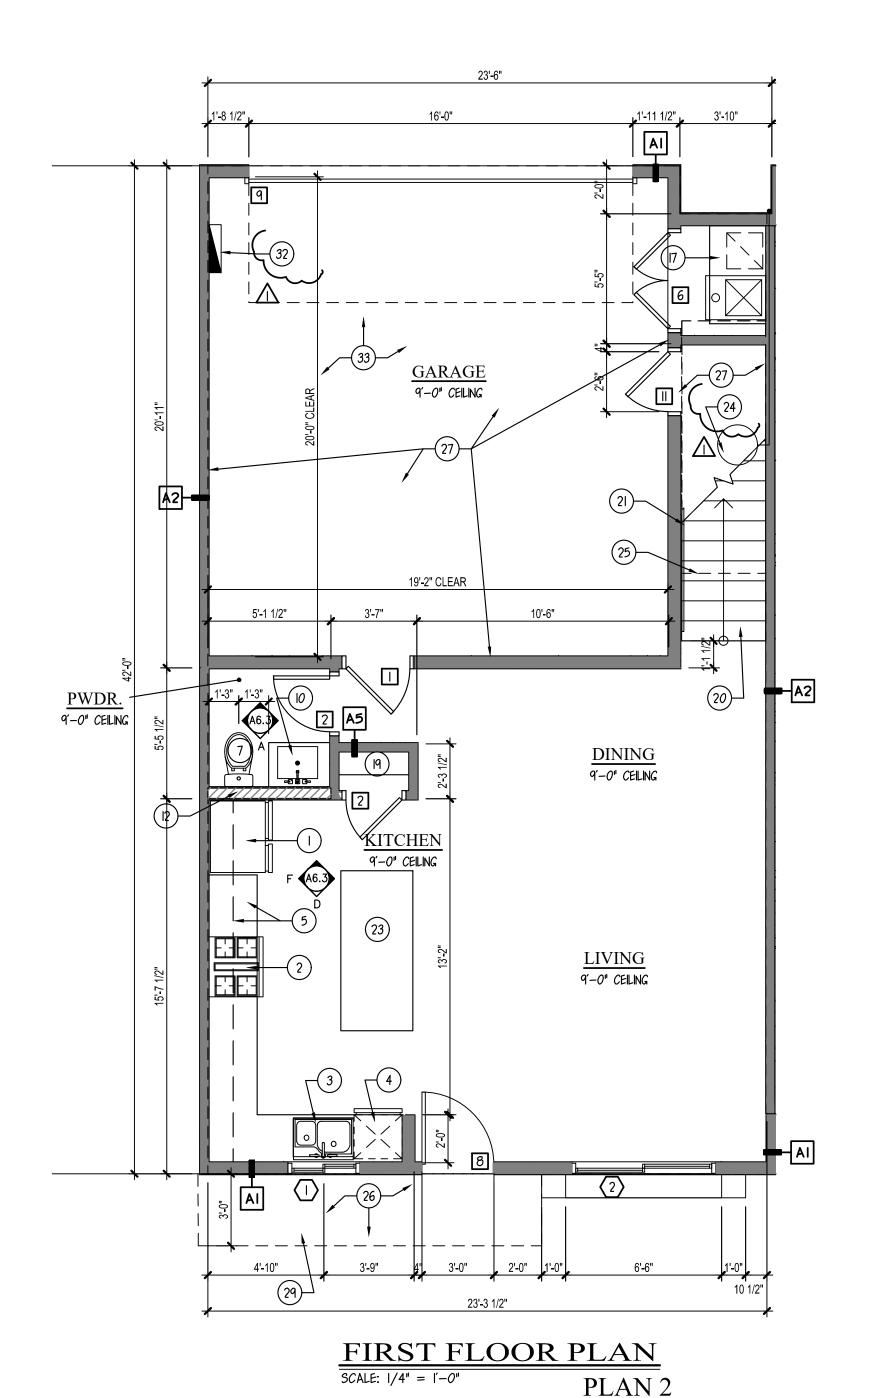

SECOND FLOOR PLAN SCALE: 1/4'' = 1'-0''PLAN 2

(PLAN 1 & PLAN 2 USED @ TRIPLEX & FOUR PLEX)

KEYNOTES

- DESCRIPTION REFRIGERATOR - PRE-PLUMB FOR ICE MAKER RANGE & OVEN v/ HOOD/MICROWAVE ABOVE - PER OWNER HOOD EXHAUST @ +77" - VENT TO EXTERIOR WALL
- DISHWASHER PROVIDE APPROVED AIR GAP

COUNTERTOP v/ BASE & UPPER CABINETS

- 32"x60" PREFAB SHOWER PAN w/ MOISTURE RESISTANT GYP. BD. W/ TILE, MARBLE OR EQ. TO +72" ABV. DRAIN
 WATER CLOSET PROVIDE A (MIN.) 15" ON EACH SIDE & 24" (MIN.) CLEAR IN FRONT
- 4" CURB v/ SHOWER GLASS


DOUBLE SINK w/ DISPOSAL

- PORCELAIN STEEL TUB/SHOWER COMBO. v/ ROD FOR SHOWER CURTAIN SINK AND VANITY
- 42" HIGH MIRROR IN MASTER BATHROOM & ALL SECONDARY BATHROOMS — U.N.O. ON PLAN 2x6 PLUMBING WALL
- WASHER-PROVIDE PAN UNDERNEATH FOR DRAIN OVERFLOW
- DRYER 4" DRYER VENT THROUGH ROOF NOT TO EXCEED 25'-0" PER I.R.C. SHELF OR UPPER CABINETS - VERIFY W/ OWNER
- SHELVING PER OWNER
- F.A.U. ON RAISED PLATFORM PER MECHANICAL TEMPERED GLASS
- 5 SHELVES EQUALLY SPACED

HANDRAIL - +34" TO +38" MAX

- STAIRS PER I.R.C. SEC. (MAX. RISE=7 3/4" MIN. RUN=10")
- HANDRAIL/GUARDRAIL @ +36" MIN. w/ SPINDLES @ 4" O.C. IF APPLICABLE
- ISLAND COUNTERTOP 36" DEEP WATERFALL EDGE ON SIDES v/ 24" DEEP BASE CABINETS & I' DEEP KNEESPACE √ WH v/ PRESSURE RELIEF VALVE AND DRAIN PAN (P2801.5). DRAIN LINE TERMINATES PER (P2801.5.2). INSTALL HOT WATER CIRCULATION PUMP
- LINE OF CEILING CHANGE CONCRETE SLAB SLOPE 1/4" P.L.F. MIN.
- 5/8" TYPE 'X' GYPSUM BOARD o/ WALLS & CEILING PER
- CVD. ENTRY, STUCCO WRAPPED SOFFIT @ +9'-0"
- HOSE BIBB VERIFY LOCATION
- STEEL BOLLARD
- ELECTRICAL PANEL SEE ELECTRICAL PLANS
- GARAGE FLOOR SLOPE MIN. 1/8" P.L.F.

ELEVATION KEY

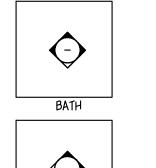

NOTE:

THE MANUFACTURER'S NAME, TRADEMARK OR OTHER DESCRIPTIVE MARKING BY WHICH THE ORGANIZATION RESPONSIBLE FOR THE PRODUCT CAN BE IDENTIFIED SHALL BE PLACED ON ALL ELECTRICAL EQUIPMENT. OTHER MARKINGS SHALL BE PROVIDED THAT INCLUDE VOLTAGE, CURRENT, WATTAGE OR OTHER RATINGS AS SPECIFIED ELSEWHERE IN CHAPTERS 34 THROUGH 43. THE MARKING SHALL HAVE THE DURABILITY TO WITHSTAND THE ENVIRONMENT INVOLVED.

GENERAL PLAN NOTES

- THE ARCHITECT SHALL BE NOTIFIED OF ANY DISCREPANCIES WITH CODE, SUPPLEMENTARY DRAWINGS OR REPORTS. EXTERIOR TRIM, DOOR AND WINDOW HEAD, JAMBS AND SILLS, SOFFITS, EXTERIOR RAILING TYPES ARE AS INDICATED AND REFERENCED ON PROVIDE 1/2" CEILING RATED GYP. BD. AT CEILING PROVIDE FIBER
- CEMENT BD. AT PATIO & PORCH CEILINGS TAPE & TEXTURE PER PROJECT SPEC'S. SEE BUILDING PLANS FOR LOCATION AND SEE SITE PLAN FOR BUILDING
- LOCATIONS AND BUILDING TYPES. SMOKE DETECTORS SHALL BE 110V, v/ BATTERY BACKUP & SHALL BE LOCATED IN EACH BEDROOM & HALLWAY LEADING THERE TO. BEDROOM SHALL HAVE A MINIMUM OF ONE OPENING WHICH MEETS PER SECTION 2509.3 IBC HEIGHT, 5.7 S.F. NET CLEAR OPENABLE AREA AND SHALL BE 44" MAXIMUM FROM FINISH. FLOOR TO SEE MECHANICAL DRAWINGS VENTILATION, DRYER VENTS, EXHAUST TOP OF SILL AS REQUIRED PER IBC SECTIONS 1029.2 & 1029.3 FANS
- AND DUCT LOCATIONS. SEE BUILDING PLAN ROOF PLANS FOR VARIATION IN ROOFS OVER EACH UNIT DESIGNATION.
- VERIFY SIZE OF MECHANICAL UNIT PRIOR TO FRAMING ENCLOSURE. VERIFY WITH MECHANICAL CONTRACTOR DIRECTION OF FRAMING FOR DROPPED CEILINGS, DROPPED CEILINGS TO BE NON-COMBUSTIBLE
- SEE DETAILS FOR TYPICAL ASSEMBLIES, OCCUPANCY AND FIRE WALLS FRAMING. DETAILS, REQUIREMENTS FOR MEMBRANE AND PENETRATION DETAILS, AND TYPICAL WALL AND SEE EXTERIOR ELEVATIONS FOR MATERIAL TYPE, ELEVATION, FLOOR PLAN DIMENSION VARIATIONS, AND UNIT ENTRY ALL INTERIOR ADHESIVES, SEALANT, PAINTS & COATINGS SHALL BE LOW-VOC. USE OF LOW-VOC PAINTS AND STAINS (NON-FLAT: 150 G/L OR LESS, FLAT: 50G/L OR LESS) FOR

ENERGY STAR RATED APPLIANCES, INCLUDING BUT NOT LIMITED TO,

REFRIGERATORS, DISHWASHERS, AND CLOTH WASHERS SHALL BE INSTALLED WHEN SUCH APPLIANCE ARE PROVIDED OR REPLACED WITHIN LOW-INCOME UNITS AND / OR IN ON-SITE COMMUNITY FACILITIES. PROVIDE CARBON MONOXIDE ALARMS, INTERCONNECTED AND SHALL BE HARDWIRED WITH PROVIDED IN ALL OTHER FLOOR SPACES UNLESS

GENERAL WALL INFO

WALL FRAMING #2 D.F. - SEE STRUCTURAL - U.N.O. EXTERIOR WALLS - 2x6, @ 16" o.c. U.N.O. INTERIOR BEARING WALLS - 2x @ 16" o.c. U.N.O. INTERIOR NON BRG. - 2x4, @ 24" o.c. U.N.O. PLUMBING WALLS - 2x6 U.N.O. - 16" O.C. @ TUBS & SHOWERS FOR PROPER INSTALLATION OF DENS SHIELD INSULATION: MANUFACTURER: CERTAIN TEED OR APPROVED

THE BATTERY BACK-UP. REQUIREMENT IS SPECIFICALLY

- MATERIAL: BATT INSULATION WALL INSULATION: (2x6) R-19, (2x4) FURRING R-13, AIR CONDITIONED AREAS CEILING INSULATION: R-38 OVER ALL LIVABLE AREAS GARAGE INSULATION: R-19 BETWEEN GARAGE & ALL LIVABLE SPACES.) CAULK AND SEAL BOTTOM PLATES, PENETRATIONS, WINDOWS, AND DOORS. WINDOWS- U FACTOR .40 MAX., SHGC .25 MAX.
- MIN. GYP. BOARD THICKNESS SHALL BE INCREASED FROM 3/8" TO 1/2" THICK FOR 16" O.C. FRAMING AND FROM 1/2" TO 5/8" THICK FOR 24" O.C. FRAMING OR 1/2" SAG RESISTANT GYP. BOARD SHALL BE USED. PROVIDE 5/8" TYPE 'X' GYPSUM BOARD ON WALLS &

AND MOUNTING HEIGHTS TO BE DETERMINED BY OWNER

WHEN APPLYING WATER-BASED TEXTURE MATERIAL, THE

CEILING IN GARAGE & ON USABLE SPACE UNDER STAIRS PER ALL BATH ACCESSORIES, (TOWEL BARS, HOOKS ETC.,)

WALL TAG LEGEND

2X FRAMED WALL

2x6 PLUMBING WALL

EXTERIOR WALLS

- 2x6 WOOD FRAMED EXTERIOR BEARING WALL & EXTERIOR POP-OUTS, FRAMING @ 16" O.C. U.N.O. PROVIDE R-19 BATT INSULATION WHERE APPLICABLE - SEE DTL. 1/A7.1
- EXTERIOR: WOOD SHEETING PER STRUCTURAL, MOISTURE BARRIER, COLOR CEMENTITIOUS STUCCO WITH ACRYLIC
- COAT, INSTALL PER MANUFACTURER'S SPECIFICATIONS. • INTERIOR: 1/2" GYP., FINISH PER ROOM FINISH SCHEDULE


IINTERIOR WALLS

- A2 2x4 WOOD FRAMED INTERIOR I—HOUR FIRE SOUNDPROOF PARTITION WITH A4, FRAMING @ 16" O.C. U.N.O., PROVIDE R-II BATT INSULATION & FRAMING TO RECEIVE I-HOUR FIRE <u>PROTECTION</u>. SEE DTL. 2/A7.I
 - EXTERIOR: N/A
 - INTERIOR: 2 LAYERS 5/8" TYPE X GYPSUM WALLBOARD FINISH PER ROOM FINISH SCHEDULE
- PARTITION, FRAMING @ 16" O.C. U.N.O., PROVIDE R-11 BATT INSULATION & FRAMING TO RECEIVE 1-HOUR FIRE <u>PROTECTION</u>. SEE DTL. 3/A7.I

A3 • 2x4 WOOD FRAMED INTERIOR 2-HOUR FIRE SOUNDPROOF

- EXTERIOR: (2) I" x 24" PROPRIETARY TYPE 'X' GYPSUM PANEL BETWEEN 2" FLOOR AND CEILING RUNNERS v/ 1/2" GYP. ON BOTH SIDES IN CAVITY
- INTERIOR: 2 LAYERS 5/8" TYPE X GYPSUM WALLBOARD BOTH SIDES FINISH PER ROOM FINISH SCHEDULE
- 2x6 WOOD FRAMED INTERIOR PLUMBING WALL, FRAMING @ 24" O.C. U.N.O., PROVIDE R-II BATT INSULATION
 - EXTERIOR: N/A
 - INTERIOR: 5/8" TYPE X GYPSUM WALLBOARD INSTALL
- BOTH SIDES FINISH PER ROOM FINISH SCHEDULE ■ 2x4 OR 2x6 WOOD FRAMED INTERIOR PARTITION, FRAMING @ 24" O.C. U.N.O.
 - EXTERIOR: N/A.
 - INTERIOR: 1/2" GYPSUM WALL BOARD INSTALL BOTH SIDES FINISH PER ROOM FINISH SCHEDULE

ARCHITECTURE 40666 N PARISI PL SAN TAN VALLEY, AZ 85140 480.798.9460

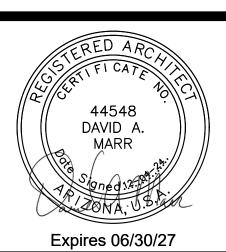

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8 3 2 S. 3 4 TH ST. MESA, AZ 8 5 2 0 4 PHONE: 480-206-9959

MULTI RESIDENTIA

VEW

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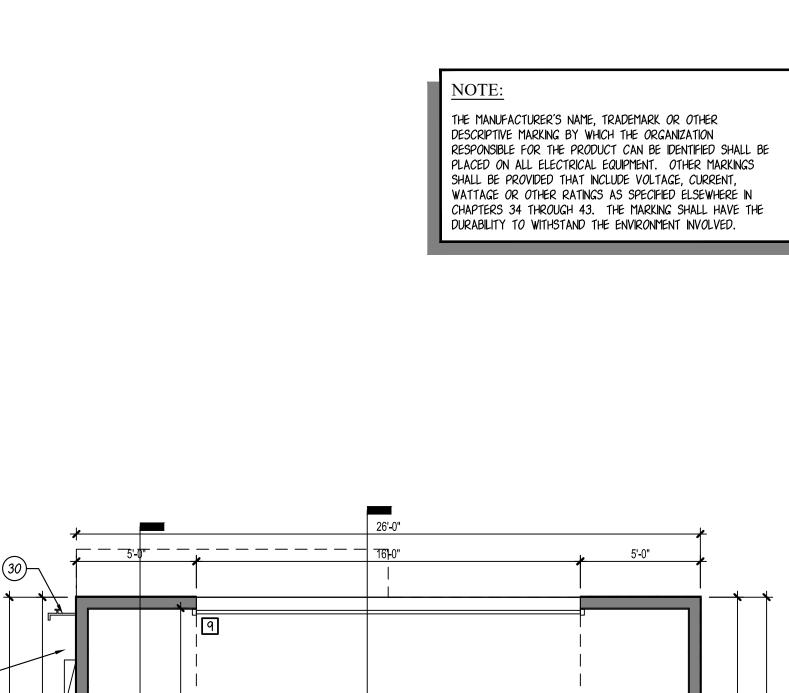
REVISIONS

/\ - CITY 3/19/25

PLOT DATE: 05/02/25

SHEET NO.

2 - OWNER 3/19/25



GARAGE

9'-0" CEILING

11'-8"

LIVING 9'-0" CEILING

23

KITCHEN 9'-0" CEILING

PLAN 3

FIRST FLOOR PLAN

SCALE: 1/4'' = 1'-0''

24

25'-1" CLEAR

DINING


9'-0" CEILING

7'-6 1/2"

PWDR. 9'-0" CEILING

A 2'-8" x 6'-8" SWING 2 2030	
3 6060 X0 8'-0" 3 C 2'-6" x 6'-8" SWING 4 4060 X0 8'-0" 4 B 2'-8" x 6'-8" SWING 5 4060 FXD 8'-0" 5 C 2'-0" x 6'-8" SWING 6 6050 X0 8'-0" 6 C 2'-8" x 6'-8" SWING 7 2050 SH 8'-0" 7 B, D, E 2'-8" x 8'-0" SWING 8 2030 FXD 8'-0" 8'-0" SWING	
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7 2050 SH 8'-0" 7 B, D, E 2'-8" x 8'-0" SWING 8 2030 FXD 8'-0" 8'-0" 8' -0" x 8'-0" SWING	
8 2030 FXD 8'-0" 8 B, D, E 3'-0" x 8'-0" SWING	
ALCOHOLOGICO DE MANIELA OFICIO DE CONTROLOGICO DE LOS DE CONTROLOGICOS DE LOS DE CONTROLOGICOS DE LOS DE CONTROLOGICOS DE LOS DELOS DE LOS DELOS DE LOS DELOS DE LOS DELOS	
NOTE: ALL WINDOWS TO BE VINYL, MANUFACTURER TBD.	


]							
A =M	IN. OF 13, TIGHT FIT	/8" SOLID	CORE	v/ SELF	CLOSER,	SELF L	-ATCHIN
&	TIGHT FIT	TING GASK	ŒTS &	SWEEP	- I.R.C. SI	EC. R3	09.1
B = S	OLID CORE			D =TEM	IPERED GL	.ASS	
		~-					

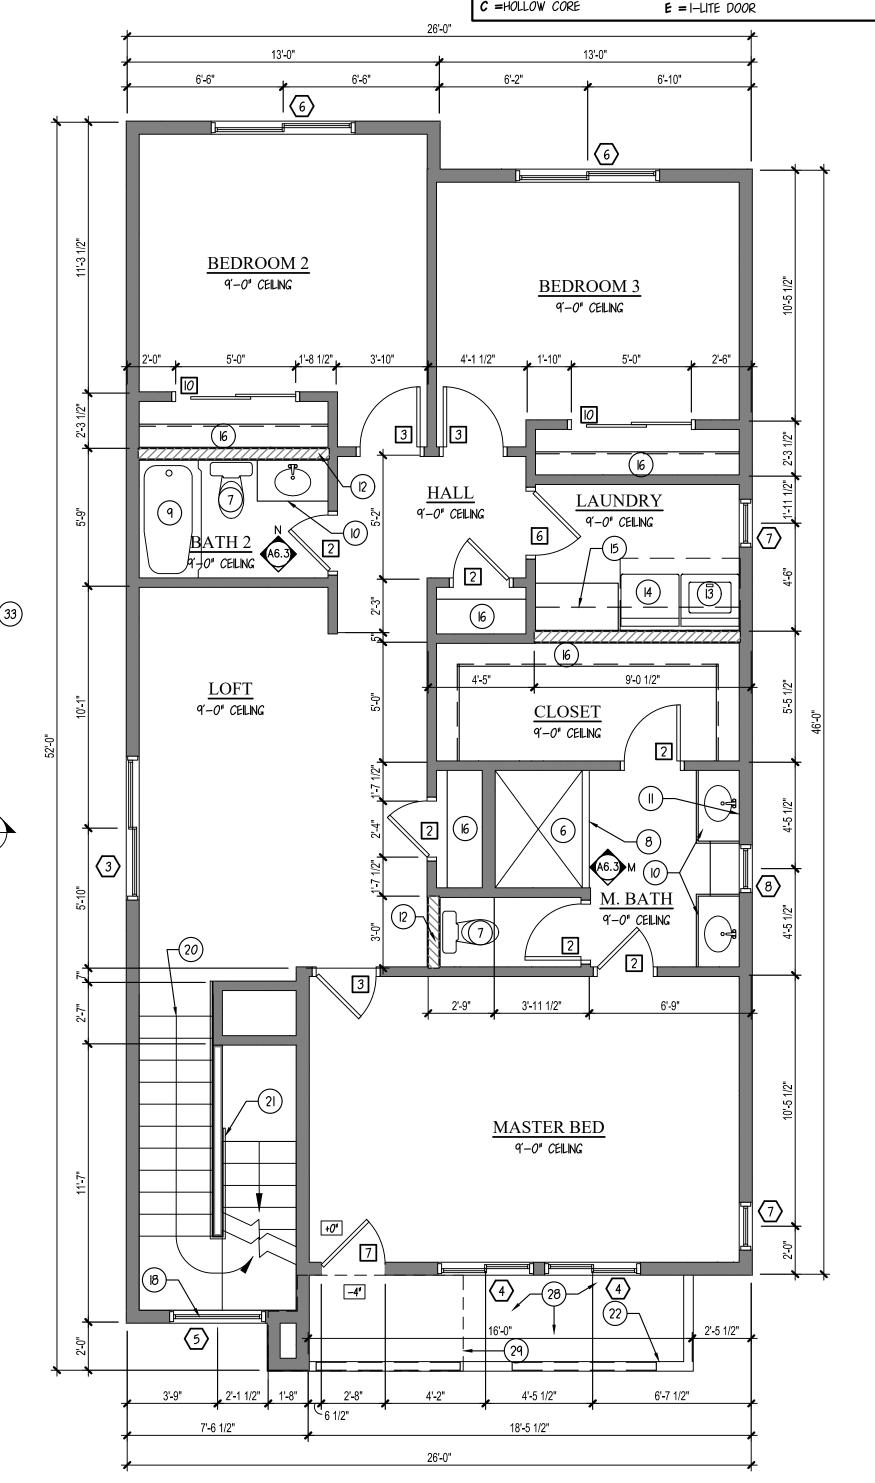

SECOND FLOOR PLAN

SCALE: 1/4" = 1'-0"

PLAN 3

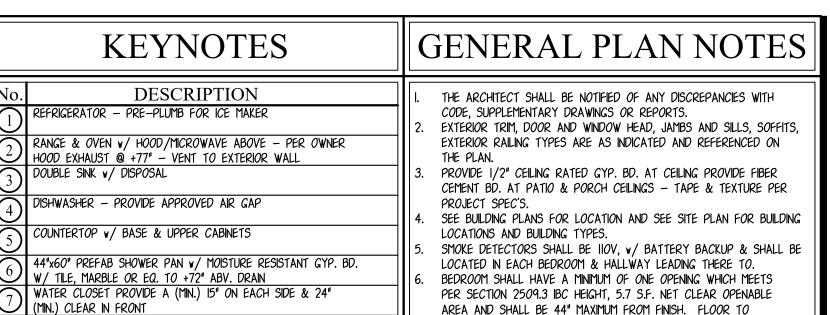

4" CURB v/ SHOWER GLASS

SHOWER CURTAIN

SINK AND VANITY

2x6 PLUMBING WALL

EXCEED 25'-0" PER I.R.C.

SHELVING PER OWNER

TEMPERED GLASS

5 SHELVES EQUALLY SPACED

HANDRAIL - +34" TO +38" MAX

PORCELAIN STEEL TUB/SHOWER COMBO. v/ ROD FOR

WASHER-PROVIDE PAN UNDERNEATH FOR DRAIN OVERFLOW

STAIRS PER I.R.C. SEC. (MAX. RISE=7 3/4" - MIN. RUN=10")

v/ 6' WIDE x 4" TALL DRAIN OPENING — SEE ELEVATIONS

V v/ 24" DEEP BASE CABINETS & 1' DEEP KNEESPACE

5/8" TYPE 'X' GYPSUM BOARD o/ WALLS & CEILING PER

CVD. PATIO, STUCCO WRAPPED SOFFIT @ +9'-0"

ELECTRICAL PANEL — SEE ELECTRICAL PLANS

HÓLD MIN. 6" FROM STEM GARAGE FLOOR SLOPE MIN. 1/8" P.L.F.

8x8x16 CMU SITE WALL +42" A.F.F.

42" SQUARE CONCRETE LANDING SLOPE 1/4" P.L.F. MIN.

/C COMPRESSOR PAD - VERIFY LOCATION v/ CONTRACTOR

ELEVATION KEY

CONCRETE SLAB SLOPE 1/4" P.L.F. MIN.

CITY REQUIREMENTS

PATIO DECK - SLOPE 1/2" P.L.F.

HOSE BIBB - VERIFY LOCATION

STEEL BOLLARD

ISLAND COUNTERTOP 36" DEEP WATERFALL EDGE ON SIDES

HANDRAIL/GUARDRAIL @ +36" MIN. v/ SPINDLES @ 4" O.C. IF APPLICABLE

NH v/ PRESSURE RELIEF VALVE AND DRAIN PAN (P2801.5). DRAIN LINE

TERMÍNATES PER (P2801.5.2). INSTALL HOT WATER CIRCÚLATION PUMP LINE OF CEILING CHANGE

DRYER - 4" DRYER VENT THROUGH ROOF - NOT TO

SHELF OR UPPER CABINETS - VERIFY v/ OWNER

F.A.U. ON RAISED PLATFORM PER MECHANICAL

42" HIGH MIRROR IN MASTER BATHROOM & ALL

SECONDARY BATHROOMS - U.N.O. ON PLAN

LOCATED IN EACH BEDROOM & HALLWAY LEADING THERE TO.

6. BEDROOM SHALL HAVE A MINIMUM OF ONE OPENING WHICH MEETS
PER SECTION 2509.3 IBC HEIGHT, 5.7 S.F. NET CLEAR OPENABLE
AREA AND SHALL BE 44" MAXIMUM FROM FINISH. FLOOR TO

7. SEE MECHANICAL DRAWINGS VENTILATION, DRYER VENTS, EXHAUST
TOP OF SILL AS REQUIRED PER IBC SECTIONS 1029.2 & 1029.3 FANS
AND DUCT LOCATIONS.

8. SEE BUILDING PLAN ROOF PLANS FOR VARIATION IN ROOFS OVER

SEE BUILDING PLAN ROOF PLANS FOR VARIATION IN ROOFS OVER EACH UNIT DESIGNATION.

VERIFY SIZE OF MECHANICAL UNIT PRIOR TO FRAMING ENCLOSURE.

VERIFY WITH MECHANICAL CONTRACTOR DIRECTION OF FRAMING FOR

DROPPED CEILINGS, DROPPED CEILINGS TO BE NON-COMBUSTIBLE

METAL

II. SEE DETAILS FOR TYPICAL ASSEMBLIES, OCCUPANCY AND FIRE WALLS FRAMING. DETAILS, REQUIREMENTS FOR MEMBRANE AND PENETRATION DETAILS, AND TYPICAL WALL AND

12. SEE EXTERIOR ELEVATIONS FOR MATERIAL TYPE, ELEVATION, FLOOR PLAN DIMENSION VARIATIONS, AND UNIT ENTRY

13. ALL INTERIOR ADHESIVES, SEALANT, PAINTS & COATINGS SHALL BE LOW-VOC. USE OF LOW-VOC PAINTS AND STAINS (NON-FLAT: 150 G/L OR LESS, FLAT: 50G/L OR LESS) FOR

14. ENERGY STAR RATED APPLIANCES, INCLUDING BUT NOT LIMITED TO, REFRIGERATORS, DISHWASHERS, AND CLOTH WASHERS SHALL BE INSTALLED WHEN SUCH APPLIANCE ARE PROVIDED OR REPLACED WITHIN LOW-INCOME UNITS AND / OR IN ON-SITE COMMUNITY

FACILITIES.
PROVIDE CARBON MONOXIDE ALARMS, INTERCONNECTED AND SHALL BE HARDWIRED WITH PROVIDED IN ALL OTHER FLOOR SPACES UNLESS THE BATTERY BACK-UP. REQUIREMENT IS SPECIFICALLY

GENERAL WALL INFO.

WALL FRAMING #2 D.F. — SEE STRUCTURAL — U.N.O. EXTERIOR WALLS — 2x6, @ 16" o.c. U.N.O. INTERIOR BEARING WALLS — 2x @ 16" o.c. U.N.O. INTERIOR NON BRG. — 2x4, @ 24" o.c. U.N.O. PLUMBING WALLS — 2x6 U.N.O. — 16" O.C. @ TUBS & SHOWERS FOR PROPER INSTALLATION OF DENS SHIELD INSULATION: MANUFACTURER: CERTAIN TEED OR APPROVED EQUAL


MATERIAL: BATT INSULATION WALL INSULATION: (2x6) R-19, (2x4) FURRING R-13, AIR CONDITIONED AREAS CEILING INSULATION: R-38 OVER ALL LIVABLE AREAS GARAGE INSULATION: R-19 BETWEEN GARAGE & ALL LIVABLE SPACES.) CAULK AND SEAL BOTTOM PLATES, PENETRATIONS, WINDOWS, AND DOORS. WINDOWS- U FACTOR .40 MAX., SHGC .25 MAX.

3. WHEN APPLYING WATER-BASED TEXTURE MATERIAL, THE

MIN. GYP. BOARD THICKNESS SHALL BE INCREASED FROM 3/8" TO 1/2" THICK FOR 16" O.C. FRAMING AND FROM 1/2" TO 5/8" THICK FOR 24" O.C. FRAMING OR 1/2" SAG RESISTANT GYP. BOARD SHALL BE USED.

4. PROVIDE 5/8" TYPE 'X' GYPSUM BOARD ON WALLS & CEILING IN GARAGE & ON USABLE SPACE UNDER STAIRS PER

ALL BATH ACCESSORIES, (TOWEL BARS, HOOKS ETC.,) AND MOUNTING HEIGHTS TO BE DETERMINED BY OWNER

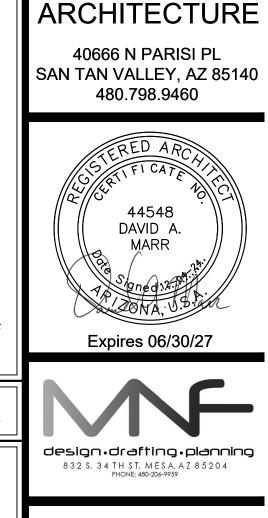


SIENNA RIDGE MULTI-FAMILY 144 S. 90TH ST. MESA, AZ 85207


MULTI RESIDENTIA

VEW

WALL TAG LEGEND

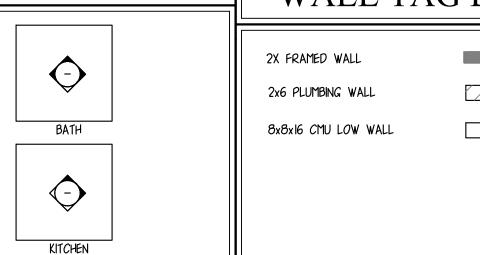

- []////

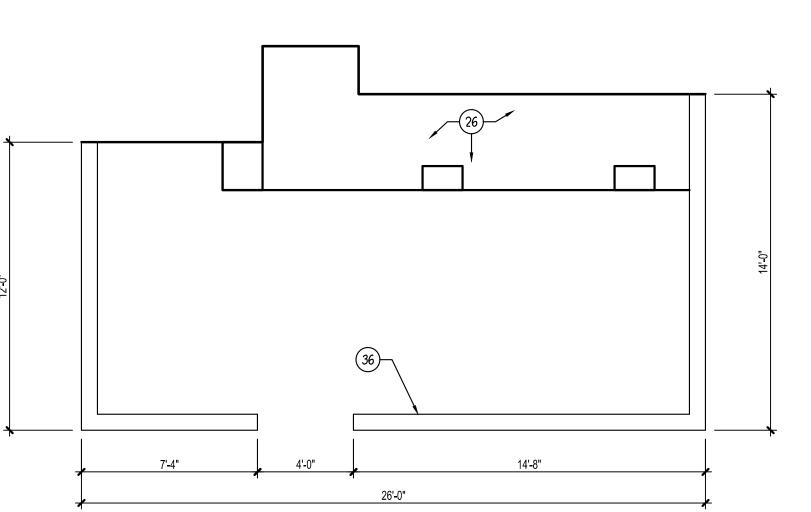

PATIO FLOOR PLAN

SCALE: 1/4" = 1'-0"

DIMENSIONED & NOTED FLOOR PLANS

PLOT DATE: 05/02/25 SHEET NO.

A1.2

NOTE


THE MANUFACTURER'S NAME, TRADEMARK OR OTHER DESCRIPTIVE MARKING BY WHICH THE ORGANIZATION RESPONSIBLE FOR THE PRODUCT CAN BE IDENTIFIED SHALL BE PLACED ON ALL ELECTRICAL EQUIPMENT. OTHER MARKINGS SHALL BE PROVIDED THAT INCLUDE VOLTAGE, CURRENT, WATTAGE OR OTHER RATINGS AS SPECIFIED ELSEWHERE IN CHAPTERS 34 THROUGH 43. THE MARKING SHALL HAVE THE DURABILITY TO WITHSTAND THE ENVIRONMENT INVOLVED.

						DOOR SCHEDULE					
No.	SIZE	FUNCTION	HDR.	NOTES	No.	TYPE	SIZE	FUNCTION	NOTES	_	
	4046	XO	8'-0"			Α	2'-8" x 6'-8"	SWING			
2	3050	SH	8´-0"		2	С	2'-4" x 6'-8"	SWING			
(3)	6060	XO	8'-0"		3	С	2'-6" x 6'-8"	SWING			
4	3060	FXD	8'-0"		4	В	2'-8" x 6'-8"	SWING			
(5)	4060	FXD	8'-0"		5	С	2'-0" x 6'-8"	SWING			
6	6050	XO	8'-0"		6	С	2'-8" x 6'-8"	SWING			
7	2650	SH	8'-0"		7	B, D, E	2'-8" x 8'-0"	SWING			
8	2030	SH	8'-0"		8	B, D, E	3'-0" x 8'-0"	SWING			
9	2030	FXD	6'-8"		9	_	16'-0" x 8'-0"	OVERHEAD			
NOTE:	ALL WINDOWS	3 TO BE VINYL, MANL	JFACTURER TE	BD.	10	С	6'-0" x 6'-8"	BI-PASS			
					A =M			v/ SELF CLOSER,			

C =HOLLOW CORE

0	С	6'-0" x 6'-8"	BI-PASS	
A =M	N. OF 13,	/8" SOLID CORE	v/ SELF CLOSER, & SWEEP - I.R.C. SI	SELF LATCHING,
&	TIGHT FIT	TING GASKETS 8	k ŚWEEP – I.R.C. SI	EC. R309.1
B = Se	OLID CORE		D = TEMPERED GL	.ASS

 $\mathbf{E} = \mathbf{I} - \mathbf{LITE} \ \mathbf{DOOR}$

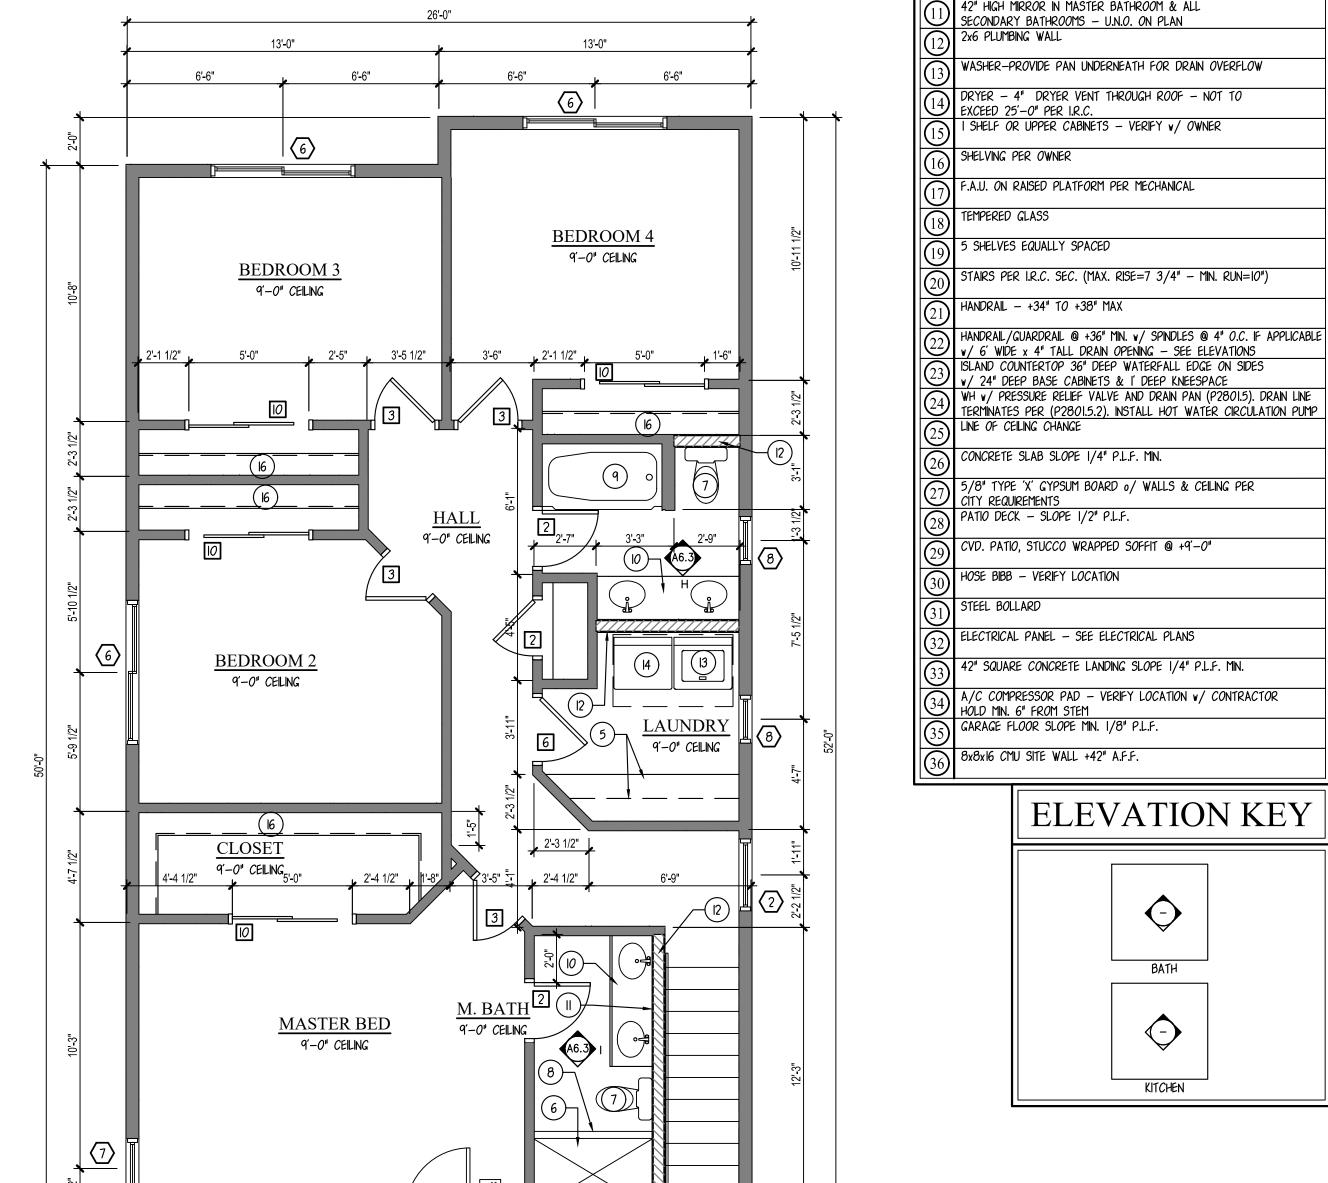

SECOND FLOOR PLAN $\frac{}{\text{SCALE: } 1/4" = 1'-0"}$ PLAN 4

18'-5 1/2"

5

GENERAL PLAN NOTES KEYNOTES DESCRIPTION THE ARCHITECT SHALL BE NOTIFIED OF ANY DISCREPANCIES WITH REFRIGERATOR - PRE-PLUMB FOR ICE MAKER CODE, SUPPLEMENTARY DRAWINGS OR REPORTS. EXTERIOR TRIM, DOOR AND WINDOW HEAD, JAMBS AND SILLS, SOFFITS, RANGE & OVEN w/ HOOD/MICROWAVE ABOVE - PER OWNER

HOOD EXHAUST @ +77" - VENT TO EXTERIOR WALL

DISHWASHER — PROVIDE APPROVED AIR GAP

COUNTERTOP w/ BASE & UPPER CABINETS

44"x60" PREFAB SHOWER PAN v/ MOISTURE RESISTANT GYP. BD.

W/ TILE, MARBLE OR EQ. TO +72" ABV. DRAIN
WATER CLOSET PROVIDE A (MIN.) 15" ON EACH SIDE & 24"

PORCELAIN STEEL TUB/SHOWER COMBO. V/ ROD FOR

42" HIGH MIRROR IN MASTER BATHROOM & ALL

F.A.U. ON RAISED PLATFORM PER MECHANICAL

ELECTRICAL PANEL — SEE ELECTRICAL PLANS

HÓLD MIN. 6" FROM STEM
GARAGE FLOOR SLOPE MIN. 1/8" P.L.F.

42" SQUARE CONCRETE LANDING SLOPE 1/4" P.L.F. MIN.

A/C COMPRESSOR PAD - VERIFY LOCATION v/ CONTRACTOR

WASHER-PROVIDE PAN UNDERNEATH FOR DRAIN OVERFLOW

STAIRS PER I.R.C. SEC. (MAX. RISE=7 3/4" - MIN. RUN=10")

WH v/ PRESSURE RELIEF VALVE AND DRAIN PAN (P2801.5). DRAIN LINE

DOUBLE SINK v/ DISPOSAL

ノ (MIN.) CLEAR IN FRONT

2x6 PLUMBING WALL

SHELVING PER OWNER

TEMPERED GLASS

5 SHELVES EQUALLY SPACED

HANDRAIL - +34" TO +38" MAX

SHOWER CURTAIN

SINK AND VANITY

4" CURB w/ SHOWER GLASS

EXTERIOR RAILING TYPES ARE AS INDICATED AND REFERENCED ON PROVIDE 1/2" CEILING RATED GYP. BD. AT CEILING PROVIDE FIBER

CEMENT BD. AT PATIO & PORCH CEILINGS - TAPE & TEXTURE PER PROJECT SPEC'S.

SEE BUILDING PLANS FOR LOCATION AND SEE SITE PLAN FOR BUILDING LOCATIONS AND BUILDING TYPES. SMOKE DETECTORS SHALL BE 110V, v/ BATTERY BACKUP & SHALL BE

LOCATED IN EACH BEDROOM & HALLWAY LEADING THERE TO. BEDROOM SHALL HAVE A MINIMUM OF ONE OPENING WHICH MEETS PER SECTION 2509.3 IBC HEIGHT, 5.7 S.F. NET CLEAR OPENABLE AREA AND SHALL BE 44" MAXIMUM FROM FINISH. FLOOR TO SEE MECHANICAL DRAWINGS VENTILATION, DRYER VENTS, EXHAUST TOP OF SILL AS REQUIRED PER IBC SECTIONS 1029.2 & 1029.3 FANS AND DUCT LOCATIONS.

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VEW

IENNA RIDGE IULTI-FAMILY 144 S. 90TH ST. MESA, AZ 85207

ARCHITECTURE

40666 N PARISI PL

SAN TAN VALLEY, AZ 85140

480.798.9460

44548

DAVID A.




KITCHEN

ELEVATION KEY

2X FRAMED WALL 2x6 PLUMBING WALL 8x8x16 CMU LOW WALL NOTED DIMENSIONED FLOOR PI


REVISIONS ⚠ - CITY 3/19/25 ⚠ - OWNER 3/19/25

PLOT DATE: 05/02/25 SHEET NO.

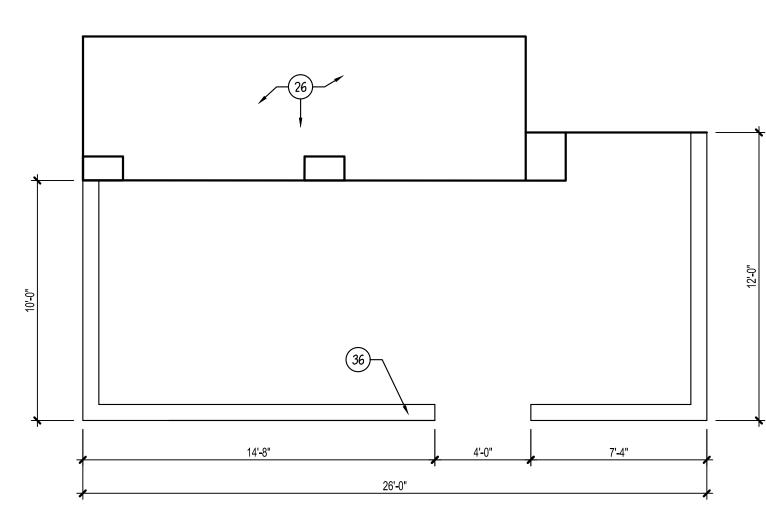

PATIO FLOOR PLAN

SCALE: 1/4" = 1'-0"

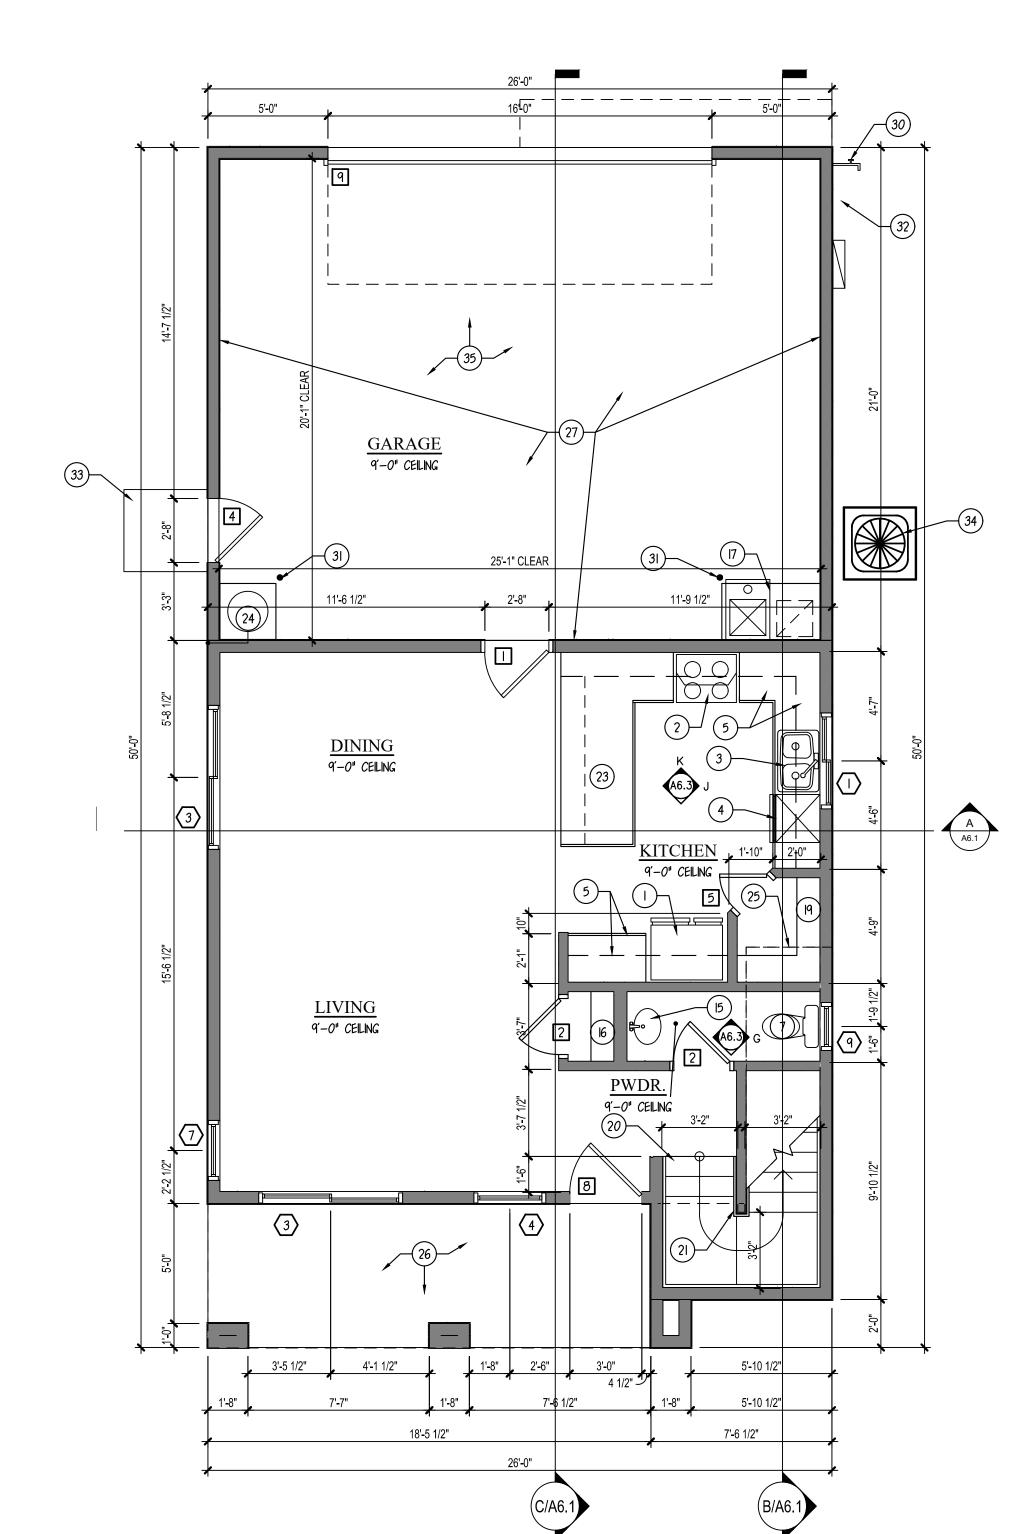

FIRST FLOOR PLAN

PLAN 4

 $\frac{}{\text{SCALE: } 1/4" = 1'-0"}$