



NOTE:  
 FOR ALL SCREEN DIMENSION,  
 REFER TO ARCH'L. PLANS

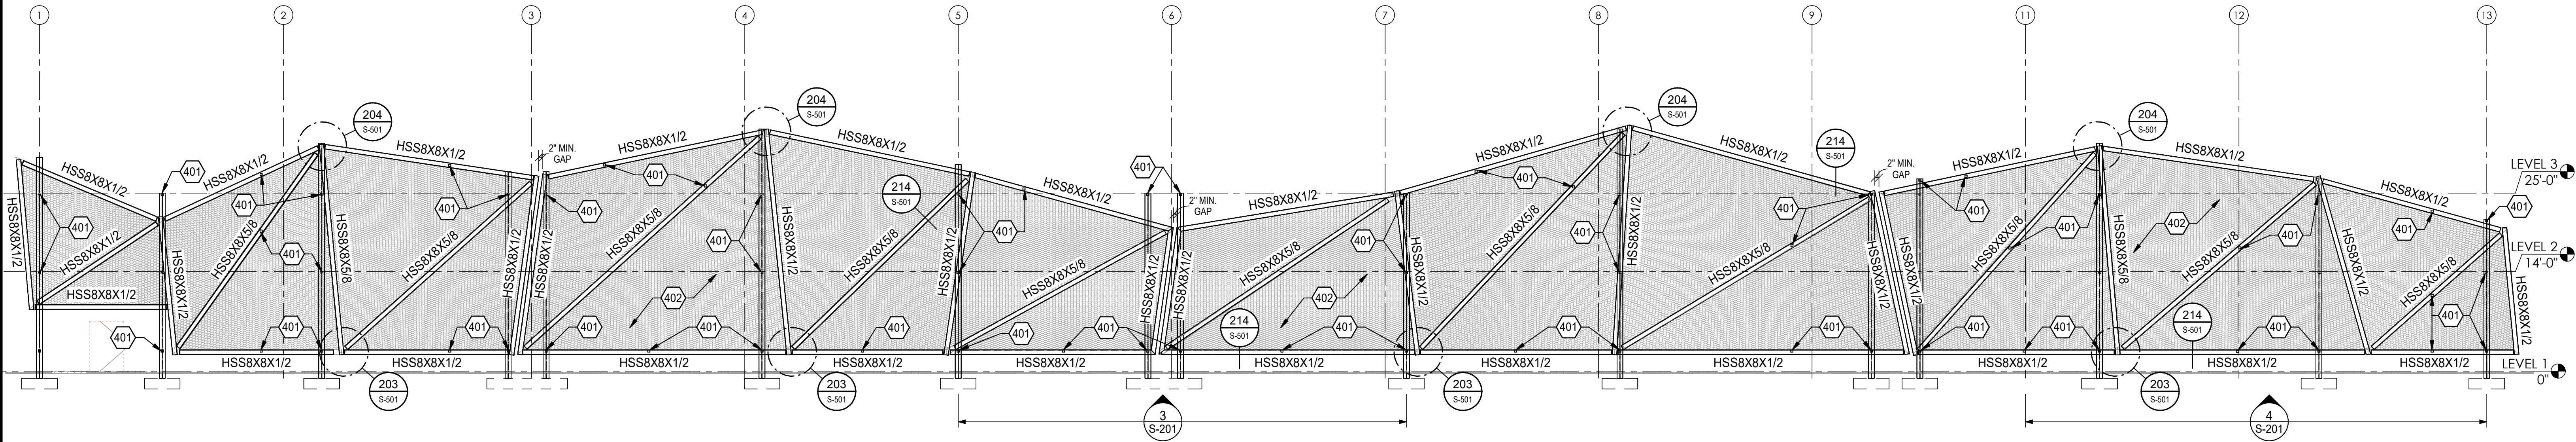

**1 SOUTH SCREEN WALL ELEVATION**  
 SCALE: 3/32" = 1'-0"


NOTE:  
 FOR ALL SCREEN DIMENSION,  
 REFER TO ARCH'L. PLANS

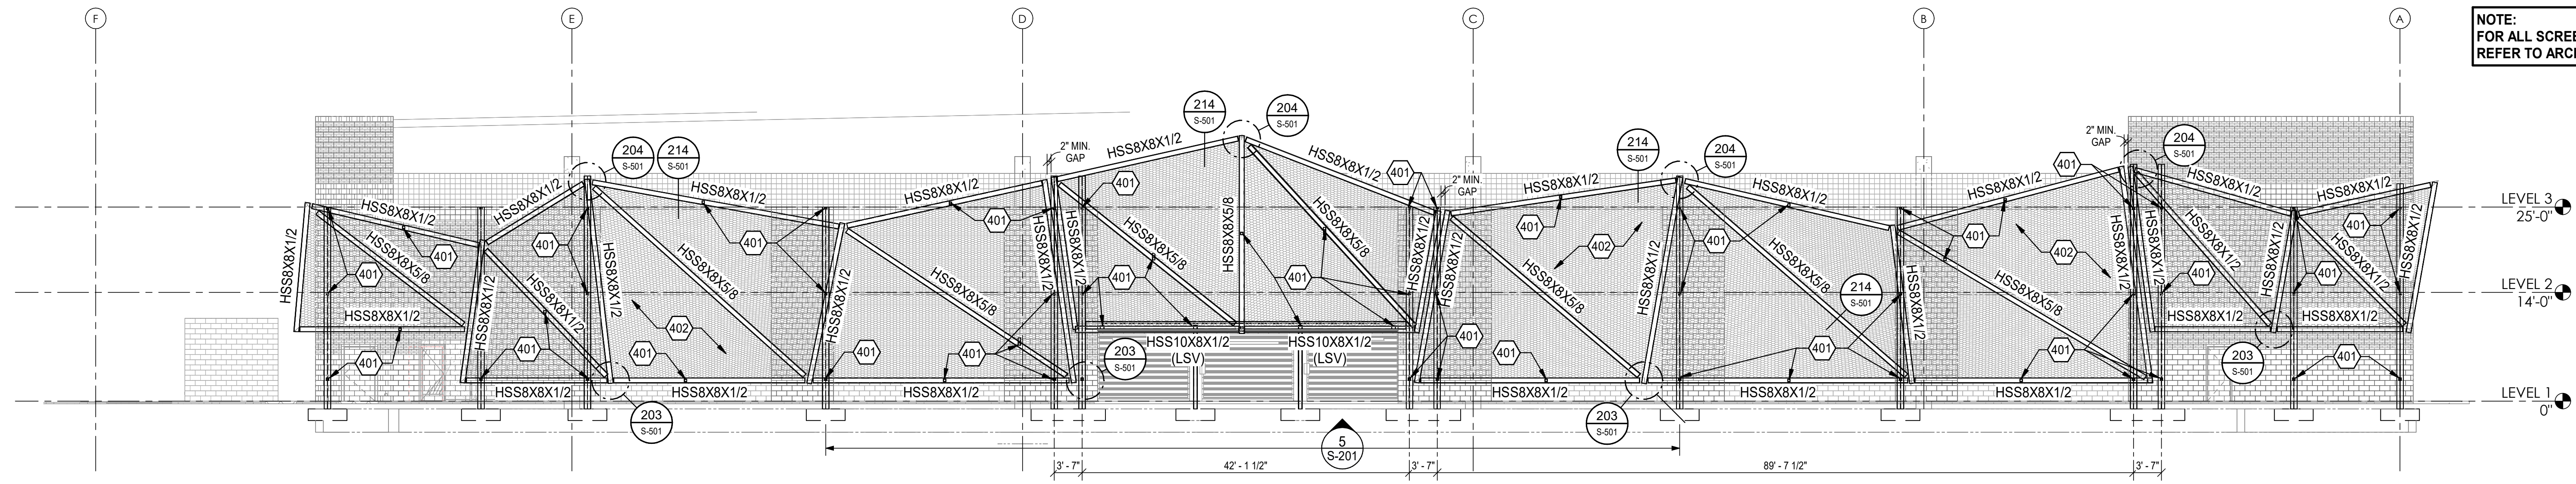


**2 EAST SCREEN WALL ELEVATION**  
 SCALE: 3/32" = 1'-0"

**# SCREEN ELEVATION KEYNOTES**


- 401 NEW HSS4x4x3/8 STEEL TUBE BRACE
- 402 PERFORATED METAL PANEL SCREEN PER ARCH'L.

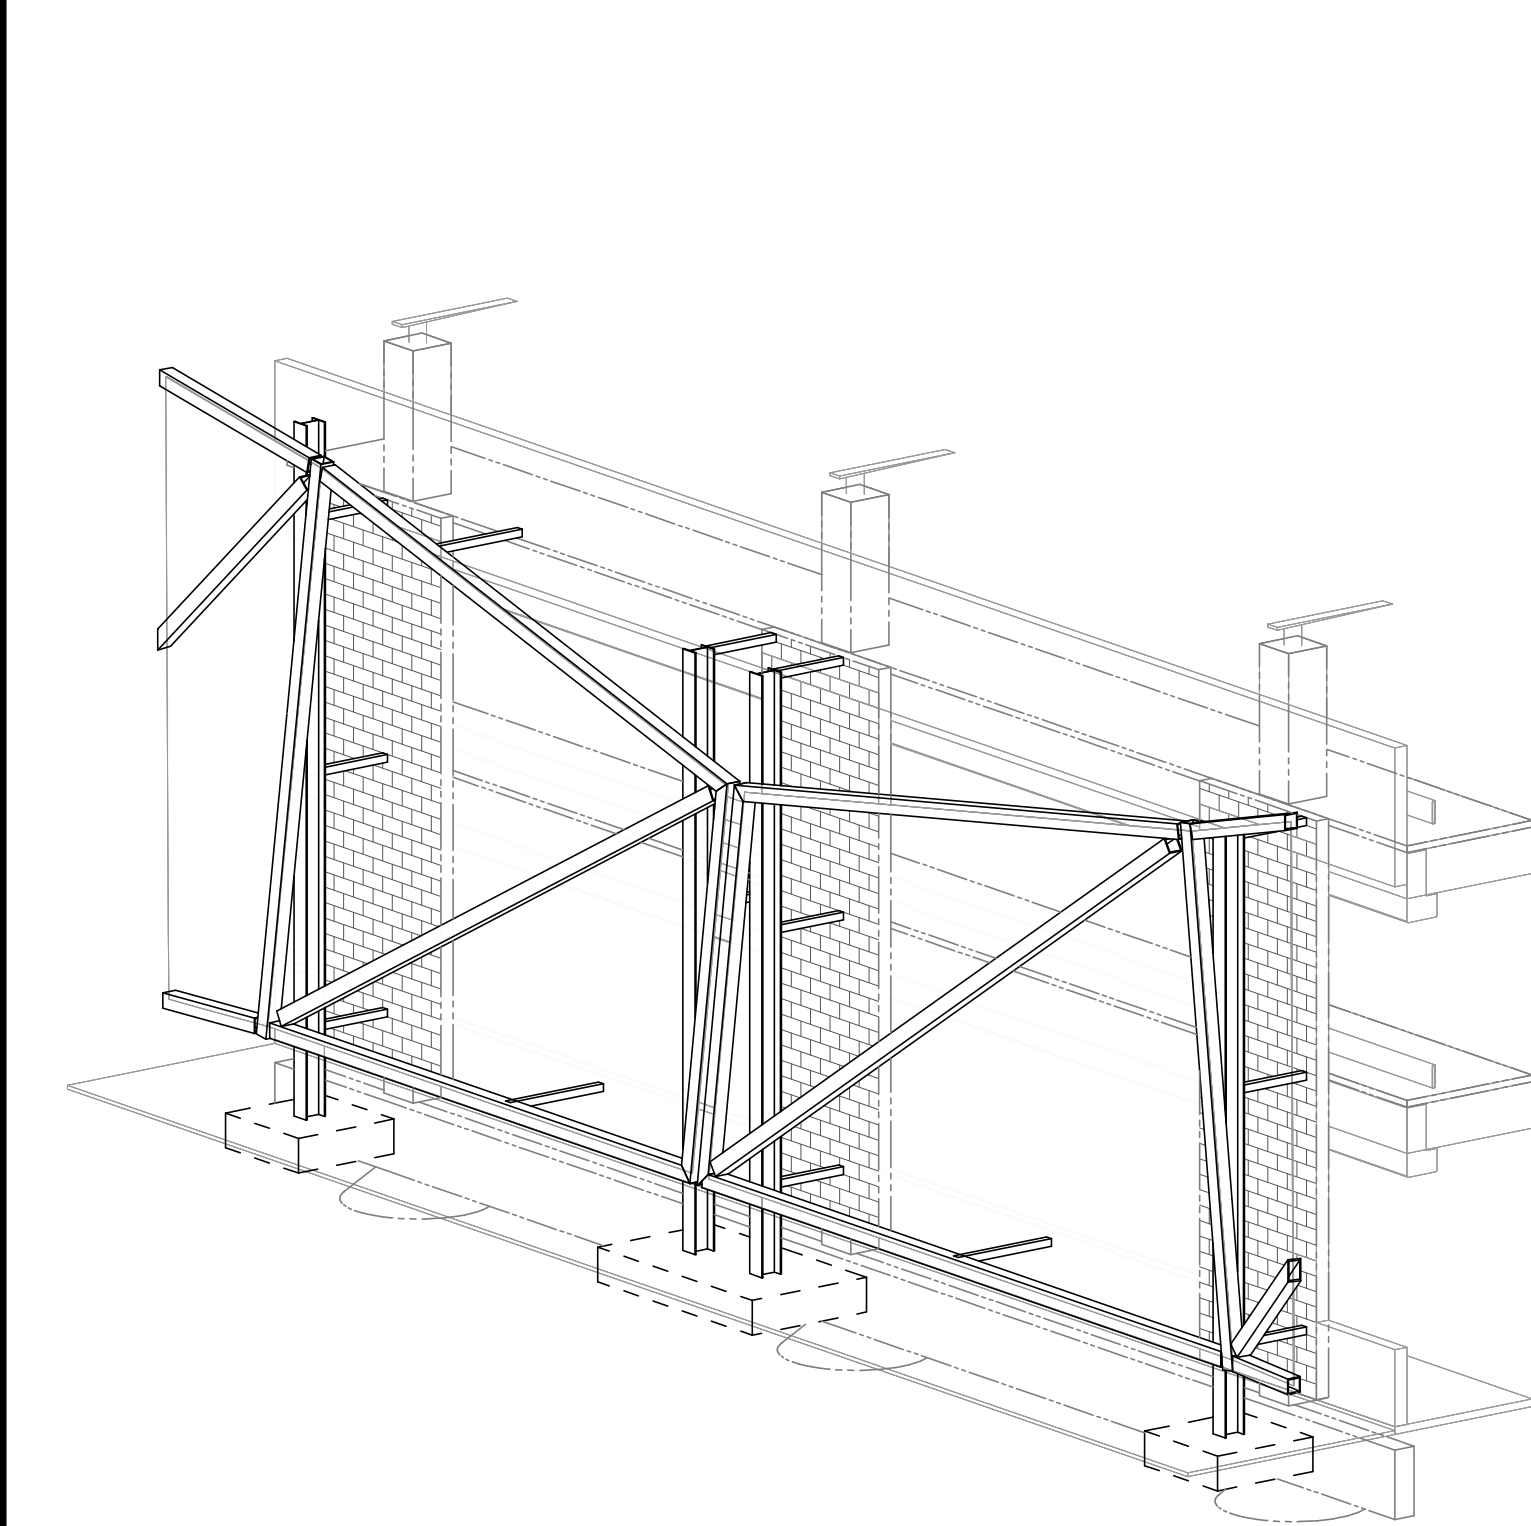

**3 PARTIAL SCREEN WALL SOUTH 3D VIEW**  
 SCALE:

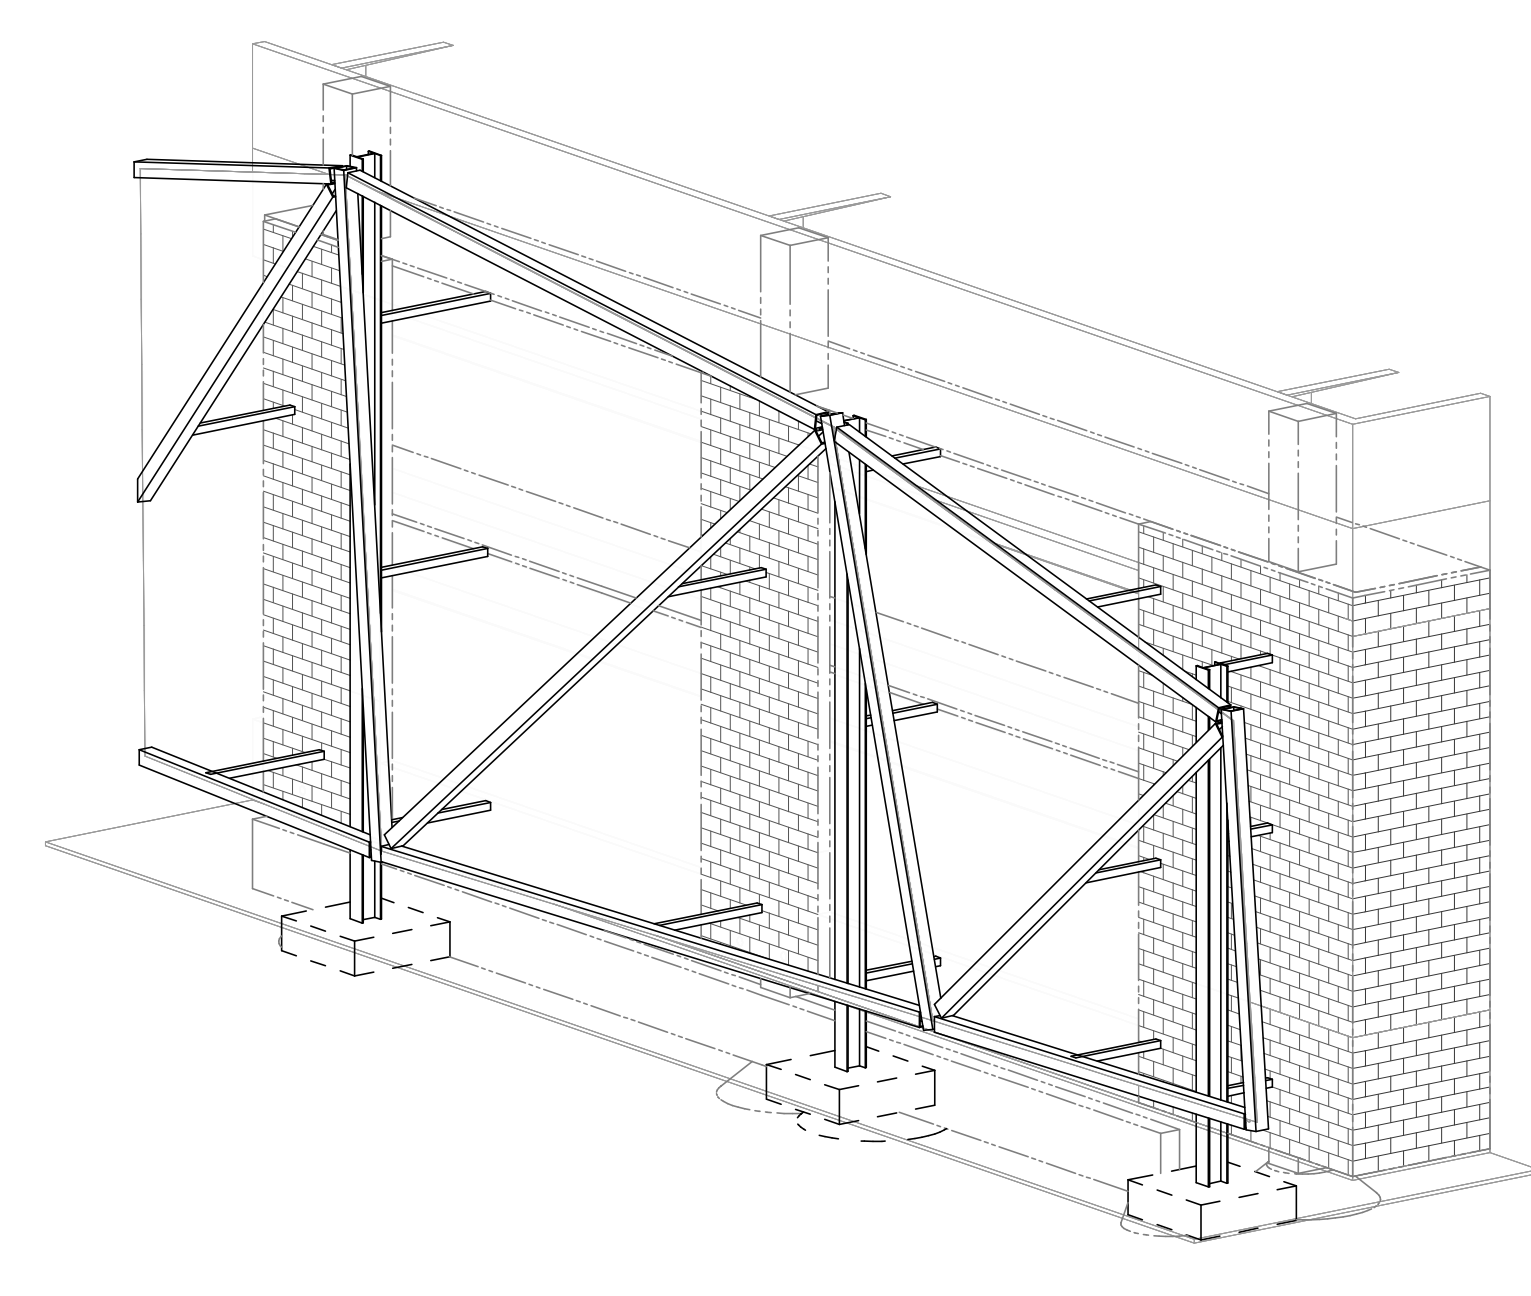

**4 PARTIAL SCREEN WALL SOUTHEAST 3D VIEW**  
 SCALE:

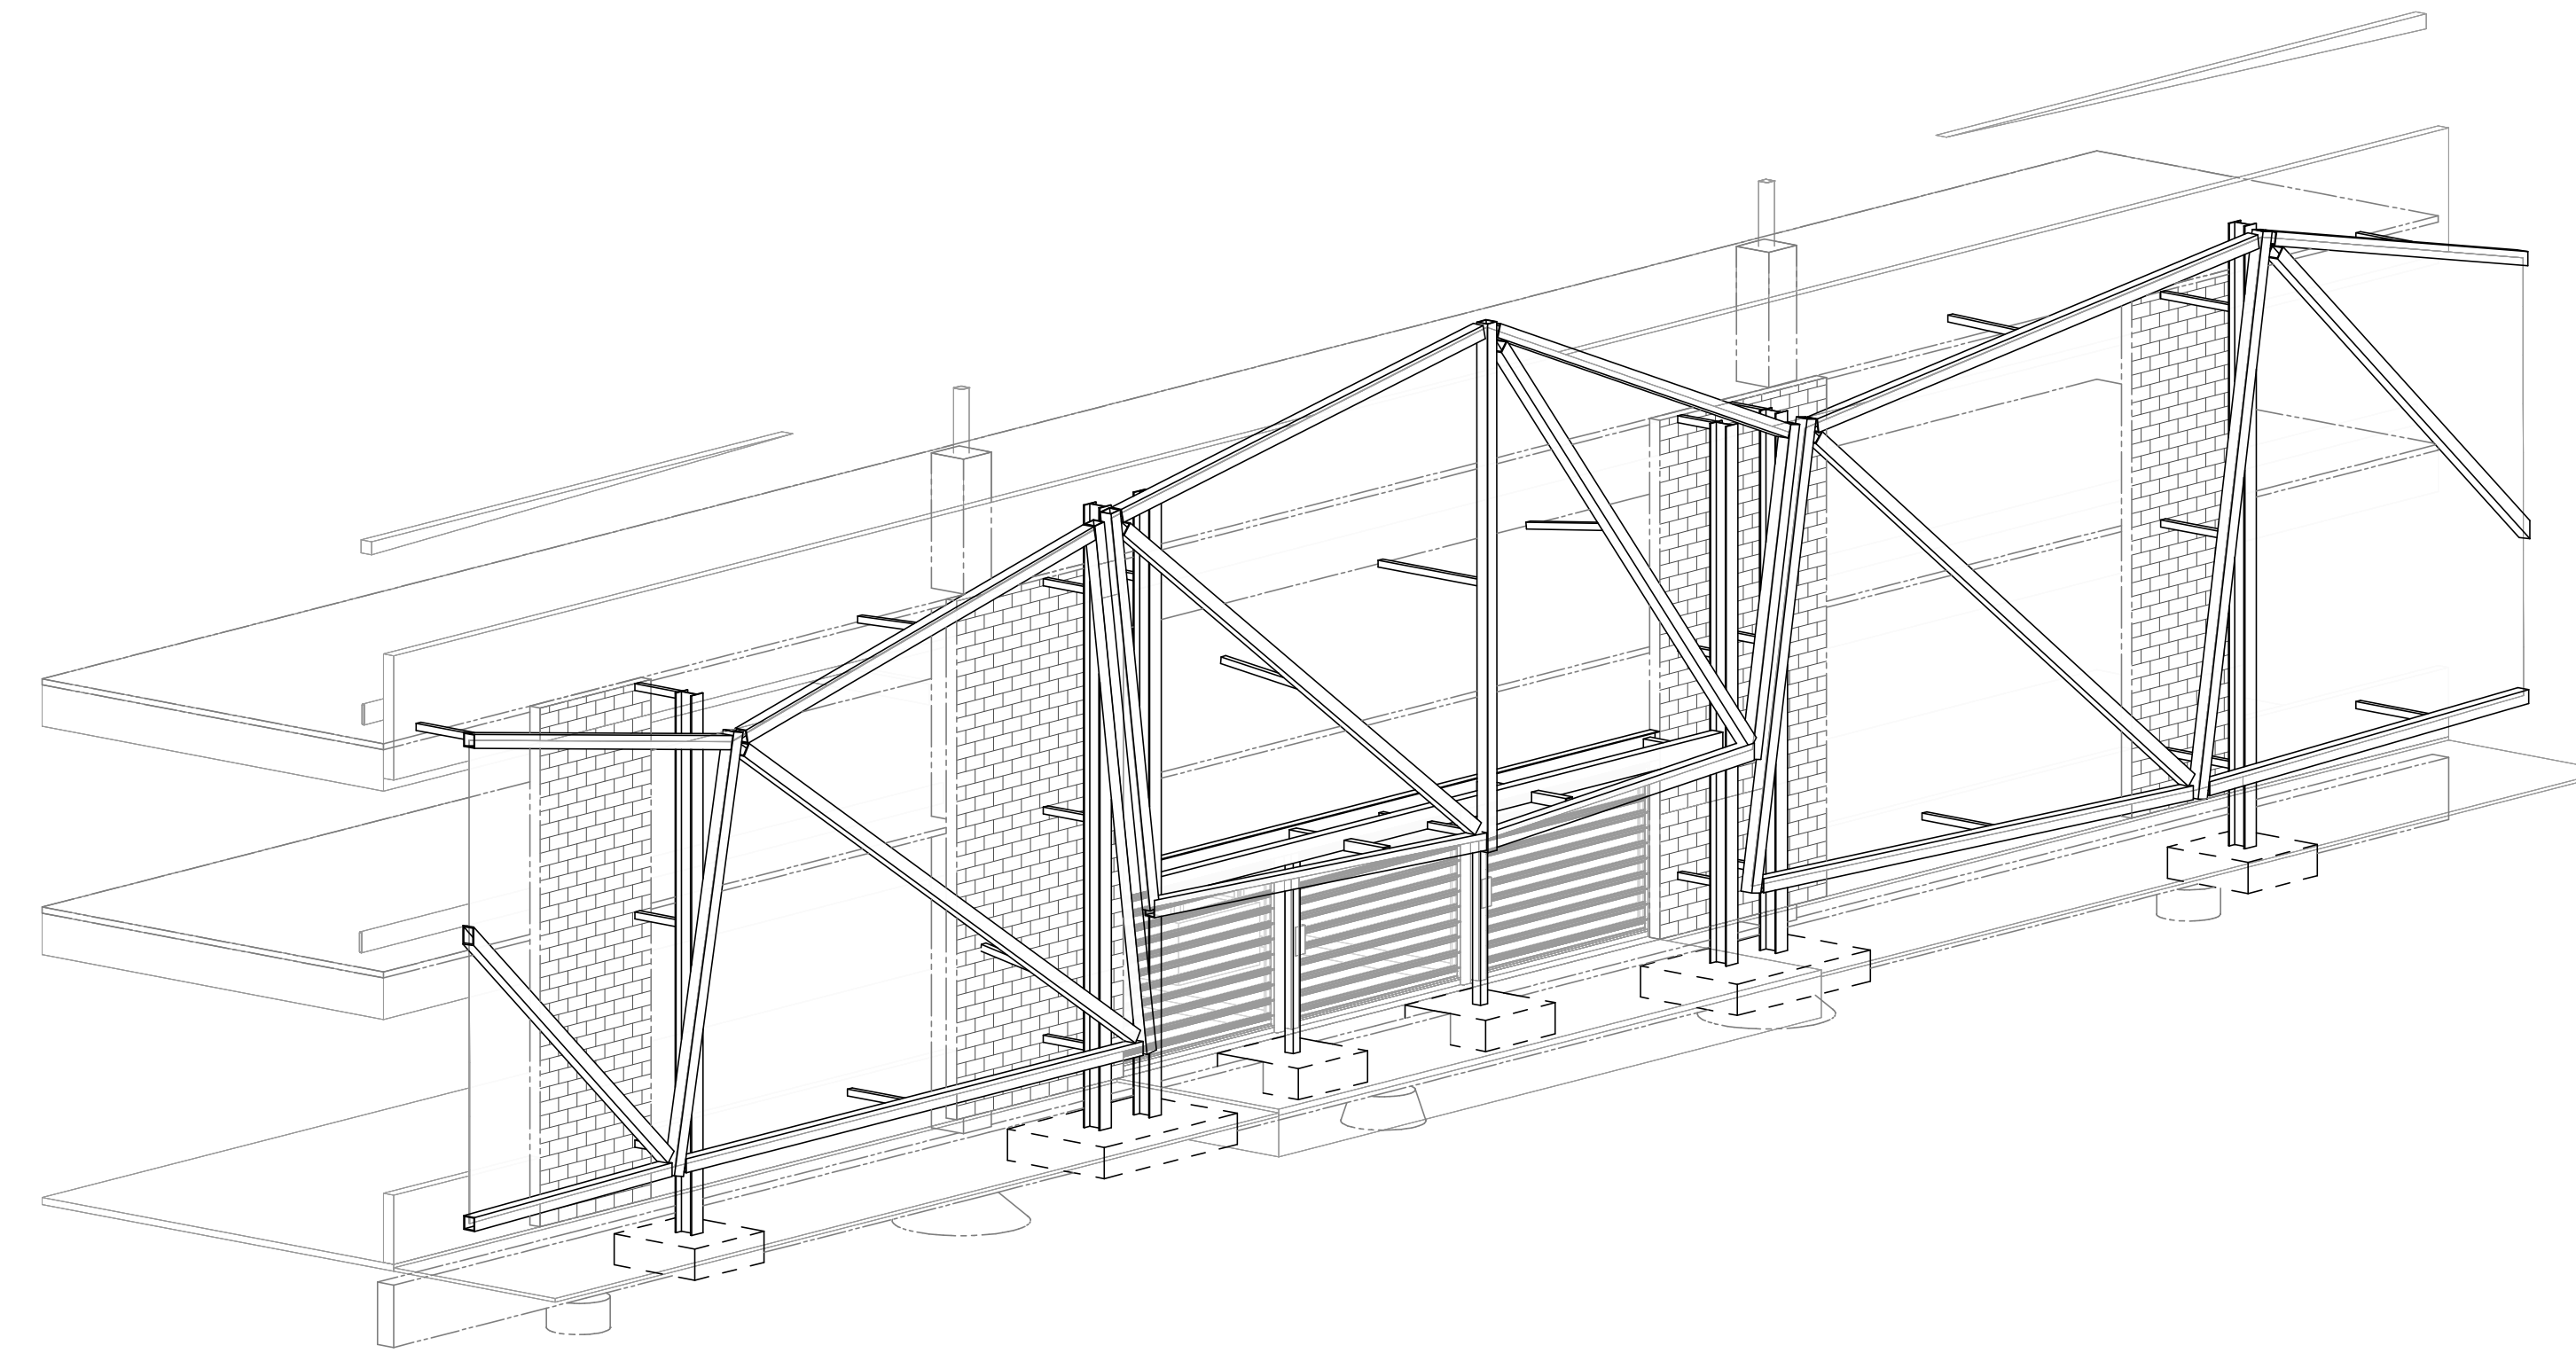

**5 PARTIAL SCREEN WALL EAST 3D VIEW**  
 SCALE:

**PK Associates, L.L.C.**  
 1431 E. McDowell Drive  
 Scottsdale, Arizona 85250  
 Phone: (480) 923-8854  
 Email: cad@pkstructural.com  
 Website: www.pkstructural.com

PRELIMINARY <b>90%                  Progress                  Submittal</b> NOT FOR CONSTRUCTION OR RECORDING	CITY OF MESA ENGINEERING DEPARTMENT	
	HIBBERT GARAGE RENOVATIONS	
DRAWN BY: EH DESIGN: HP APPROVED BY: SCS	SCREEN WALL ELEVATIONS	DRAWING S-201
ACTIVITY: PROJ. NO.: CP-189	SHEET 19 OF 74	CATALOG NUMBER: A-286153



**KEYNOTES**

- 1 DEMOLISH EXISTING 20'-0" X 22'-0" DECORATIVE METAL SCREEN IN ITS ENTIRETY. EMBEDDED WELD PLATES TO REMAIN
- 2 DEMOLISH METAL CANOPY AND STRUCTURE IN ITS ENTIRETY
- 3 VALLEY METRO UTILITY YARD AND ALL ASSOCIATED HARDSCAPE TO REMAIN
- 4 DEMOLISH EXISTING METAL SCREEN
- 5 DEMOLISH EXISTING ROLL-UP DOORS, INCLUDING MOTORS, CONTROLLERS, TRACKS, AND ATTACHMENT POINTS
- 6 DEMOLISH PORTION OF EXISTING MASONRY WALL AS INDICATED. COORDINATE WITH NEW WORK.
- 7 DEMOLISH PORTION OF EXISTING MASONRY WALL
- 8 EXISTING CANOPY TO REMAIN
- 9 EXISTING MESH SCREENING TO REMAIN
- 10 EXISTING METAL SCREEN TO REMAIN
- 11 DEMOLISH PORTION OF EXISTING METAL SCREEN FOR NEW ELECTRICAL ROOM AND MDF ROOM WALL
- 12 DEMOLISH EXISTING BEAM EXTENSIONS BACK TO END PLATE OF CANOPY BEAM. GRIND SMOOTH AND PREPARE FOR NEW PAINT.
- 13 DEMOLISH EXISTING CHAIN LINK FENCE AND GATE
- 14 EXISTING VALLEY METRO UTILITY YARD LIGHTING TO REMAIN
- 15 DEMOLISH EXISTING DOWNSPOUT NOZZLE AND REMOVE EXISTING RAINWATER LEADER TO EXTENTS INDICATED ON PLUMBING DRAWINGS. PATCH SPILT-FACE MASONRY TO MATCH EXISTING UTILIZING NEW MATERIAL OF IDENTICAL COLOR AND TEXTURE, OR SALVAGED MATERIAL FROM ELSEWHERE IN THE PROJECT.

**DEMOLITION GENERAL NOTES**


- A. DO NOT COMMENCE DEMOLITION WORK UNTIL OWNER HAS REMOVED EXISTING FURNISHINGS, APPLIANCES, EQUIPMENT, COMPUTERS, MONITORS AND DEMOUNTABLE OR MOVABLE DEVICES, SHELVES, SUPPLIES, ETC AND HAS PROVIDED THE DEMOLITION CONTRACTOR WITH WRITTEN NOTICE TO PROCEED.
- B. FIELD VERIFY ALL INDICATED SAWCUT LOCATIONS WITH PLUMBING PLAN LAYOUT PRIOR TO CUTTING TO ASSURE PLUMBING FIXTURES CAN BE PROPERLY LOCATED.
- C. PROTECT ALL ADJACENT EXISTING CONSTRUCTION FROM DAMAGE NOT INDICATED AS BEING REMOVED. DAMAGED SURFACES, EQUIPMENT AND FINISHES SHALL BE REPAIRED AT NO ADDITIONAL COST TO THEIR ORIGINAL CONDITION OR PREPARED FOR NEW FINISH WORK AS DENOTED.
- D. CONTRACTOR SHALL ERRECT AND MAINTAIN SAFETY BARRIERS, WARNING DEVICES, ENTRY PORTALS, ETC., AS NECESSARY TO PROTECT EMPLOYEES AND THE PUBLIC DURING ALL CONSTRUCTION ACTIVITIES.
- E. WHEN DIRECTED BY OWNER, DEMOLITION ACTIVITIES SHALL BE CONDUCTED IN SUCH A MANNER AS TO MAINTAIN OPERATIONAL STATUS OF BUSINESSES WHICH WILL CONTINUE TO OPERATE DURING CONSTRUCTION. THIS CONTRACTOR SHALL ERRECT NECESSARY ENCLOSURES TO PROTECT THESE BUSINESSES AND THEIR EQUIPMENT AND PRODUCTS FROM DAMAGE DUE TO FIRE, THEFT OR VANDALISM. ENTRY PORTAL STRUCTURES SHALL ALSO BE ERRECTED TO PROTECT THE PUBLIC ENTERING AND LEAVING THESE BUSINESSES.
- F. DEMOLITION OR ERRECTION ACTIVITIES WHICH ARE DEEMED BY THE CONTRACTOR TO BE TO HAZARDOUS TO MAINTAIN BUSINESS OPERATIONS OR ACCESS BY THE PUBLIC OR SHALL INTERRUPT THE AVAILABILITY OF UTILITY SERVICE SHALL REQUIRE THE CONTRACTOR TO NOTIFY THE OWNER AND BUSINESSES AFFECTED BY THIS WORK OF THE NEED FOR TEMPORARY CLOSURE AND SHALL PROVIDE A SCHEDULE INDICATING THE DATES CLOSURE WILL BE NECESSARY AND THE TYPE OF ACTIVITY THAT WILL BE OCCURRING DURING THAT PERIOD.
- G. THE ARCHITECT SHALL BE NOTIFIED OF ANY EXISTING BEARING WALL, FOUNDATION COMPONENT, STRUCTURAL MEMBER, ANCHORING CONNECTION OR REUSED STRUCTURAL CONNECTION WHICH HAS BEEN COMPROMISED BY FIRE, WATER, MOLD, DEMOLITION ACTIVITIES OR AGE OR WHICH APPEARS TO BE SUBSTANDARD WITH RESPECT TO THE STANDARDS DEFINED BY CURRENT CODE PRACTICES OF CONSTRUCTION, FOR ASSESSMENT, PRIOR TO FURTHER WORK BEING CONDUCTED IN THE SUSPECT AREA.
- H. SURFACES DAMAGED BY DEMOLITION OR OPENINGS RESULTING FROM REMOVED WALLS, DOORS, FIXTURES EQUIPMENT, CEILING, ETC. SHALL BE REPAIRED SUCH THAT THE INTERIOR AND EXTERIOR SURFACES MATCH THE SURROUNDING MATERIAL, TEXTURE, FINISH AND COLOR. THE FINISHED SURFACE SHALL NOT BE DISTINGUISHABLE FROM THE SURROUNDING SURFACE.
- I. FIRE PROTECTED SURFACES DAMAGED BY DEMOLITION OR NEW CONSTRUCTION ATTACHMENTS SHALL BE REFINISHED WITH LIKE MATERIALS TO THE DEPTHS AND ASSEMBLIES OF THE SURROUNDING FIRE PROTECTION SYSTEM.

**SALVAGE**


- A. GENERAL CONTRACTOR SHALL SURVEY THE PROJECT WITH APPROPRIATE FACILITY STAFF TO DETERMINE DISPOSITION OF THE FOLLOWING ENCOUNTERED ITEMS. CONTRACTOR SHALL SALVAGE ALL FLAGGED ITEMS AND DELIVER TO THE APPROPRIATE FACILITY SALVAGE LOCATION(S).  
LED EXIT LIGHTS / METERS (ALL) / DOOR HARDWARE / BACKFLOW PREVENTERS / FIRE ALARM DEVICES / SIMPLEX EQUIPMENT / AEDS / AED CABINETS / KNOX BOXES / KNOX FDCS / FIRE EXTINGUISHERS / EXTINGUISHER CABINETS / HM DOORS / ELECTRICAL PANELS / MECH EQUIP / IRRIGATION EQUIP. / DISCONNECT SWITCHES / ELEVATOR EQUIP. / ACCESS DOORS / ELEC LIGHT FIXTURES / ELECTRICAL EQUIP. / STARTERS / TRANSFORMERS / HVAC MIXING BOXES

**RECYCLE**


- A. GENERAL CONTRACTOR SHALL COORDINATE WITH THE APPROPRIATE FACILITY STAFF TO DETERMINE IF ANY ITEMS SHALL BE RECYCLED. PROVIDE RECEIPT DOCUMENTATION TO OWNERS REPRESENTATIVE AS TO THE RECEIVING AGENCIES OF THE RECYCLED ITEMS.

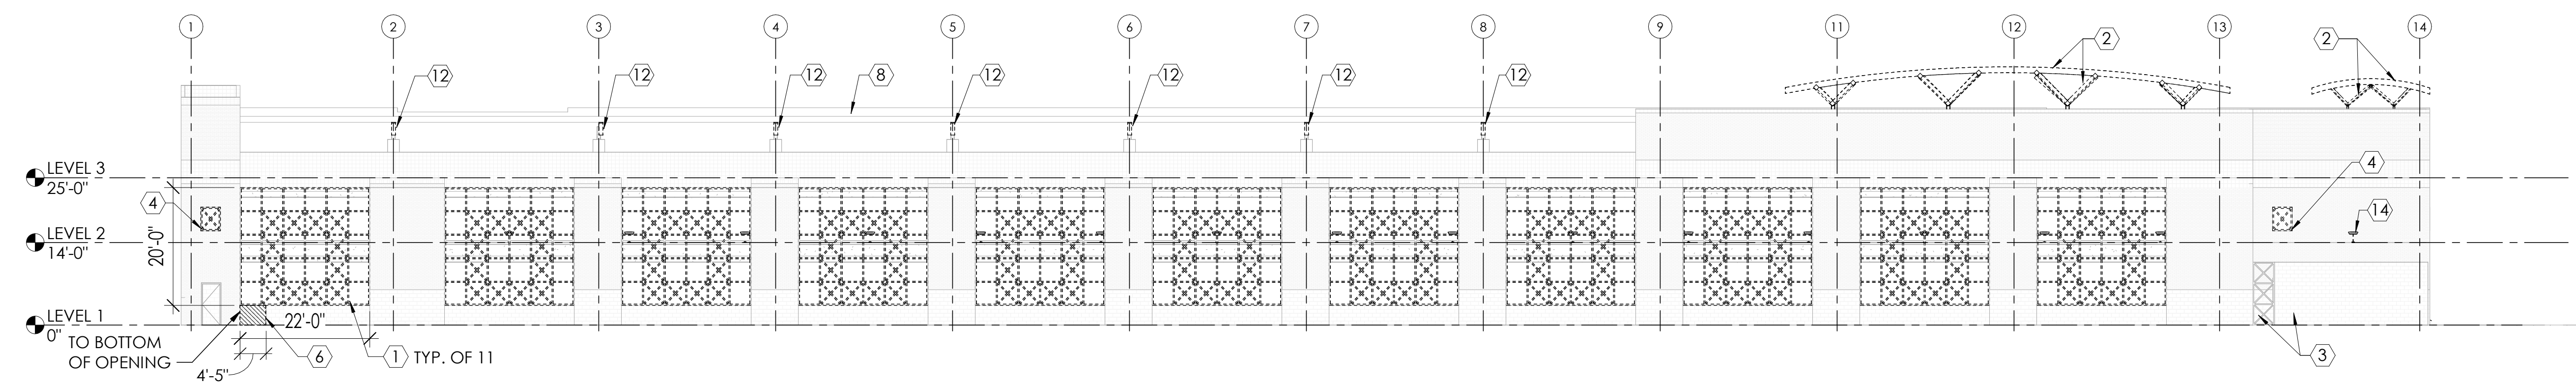


**1 SOUTH DEMOLITION ELEVATION**  
SCALE: 1/16" = 1'-0"

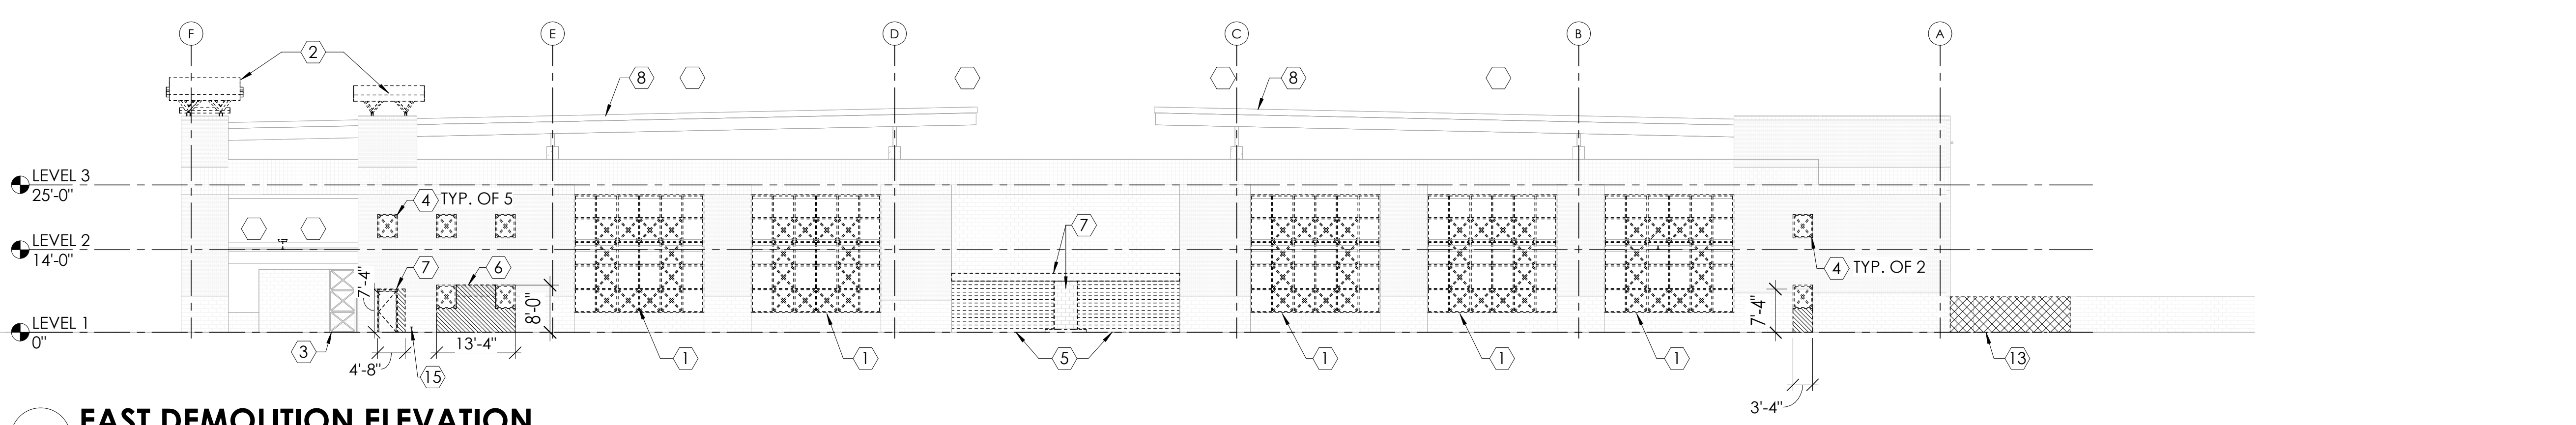

**2 EAST DEMOLITION ELEVATION**  
SCALE: 1/16" = 1'-0"

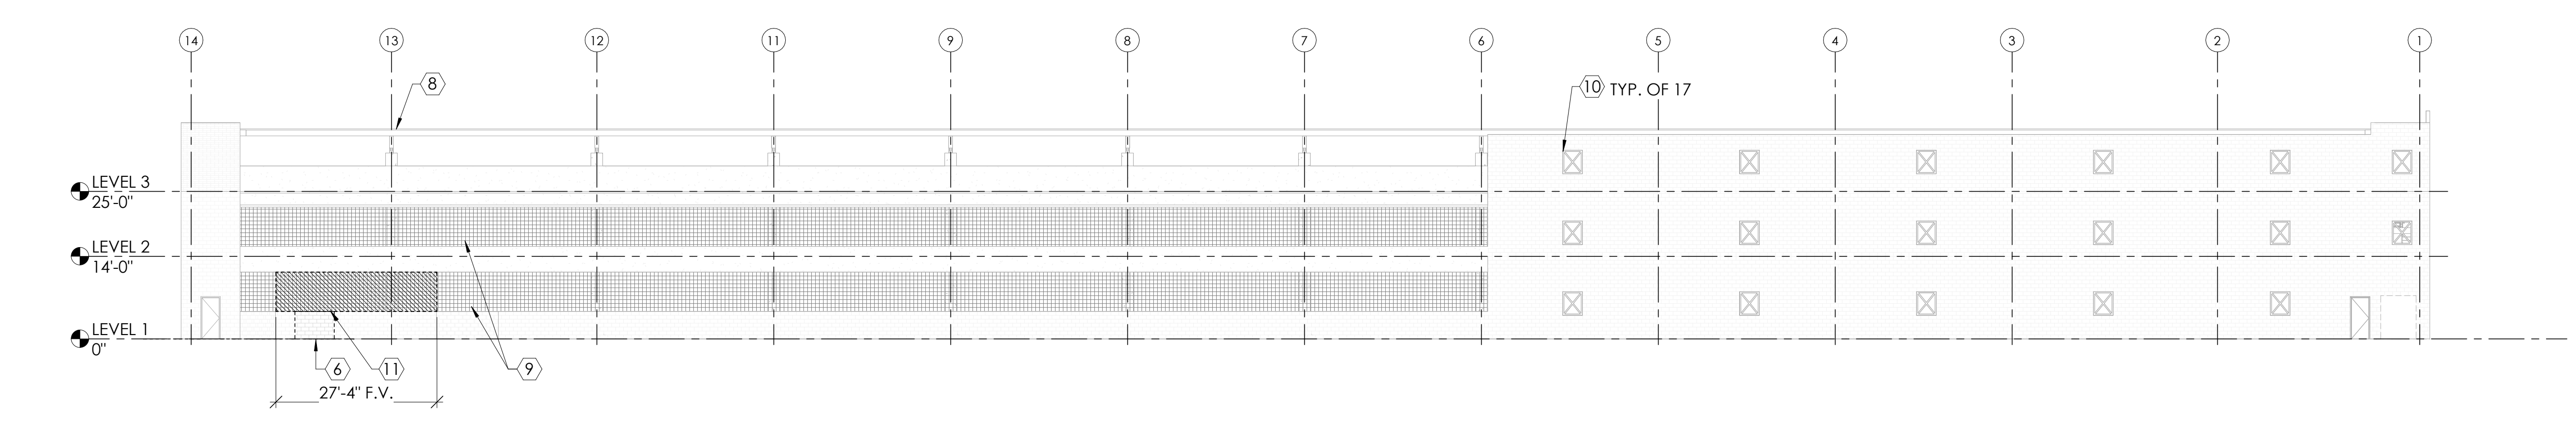

**3 NORTH DEMOLITION ELEVATION**  
SCALE: 1/16" = 1'-0"

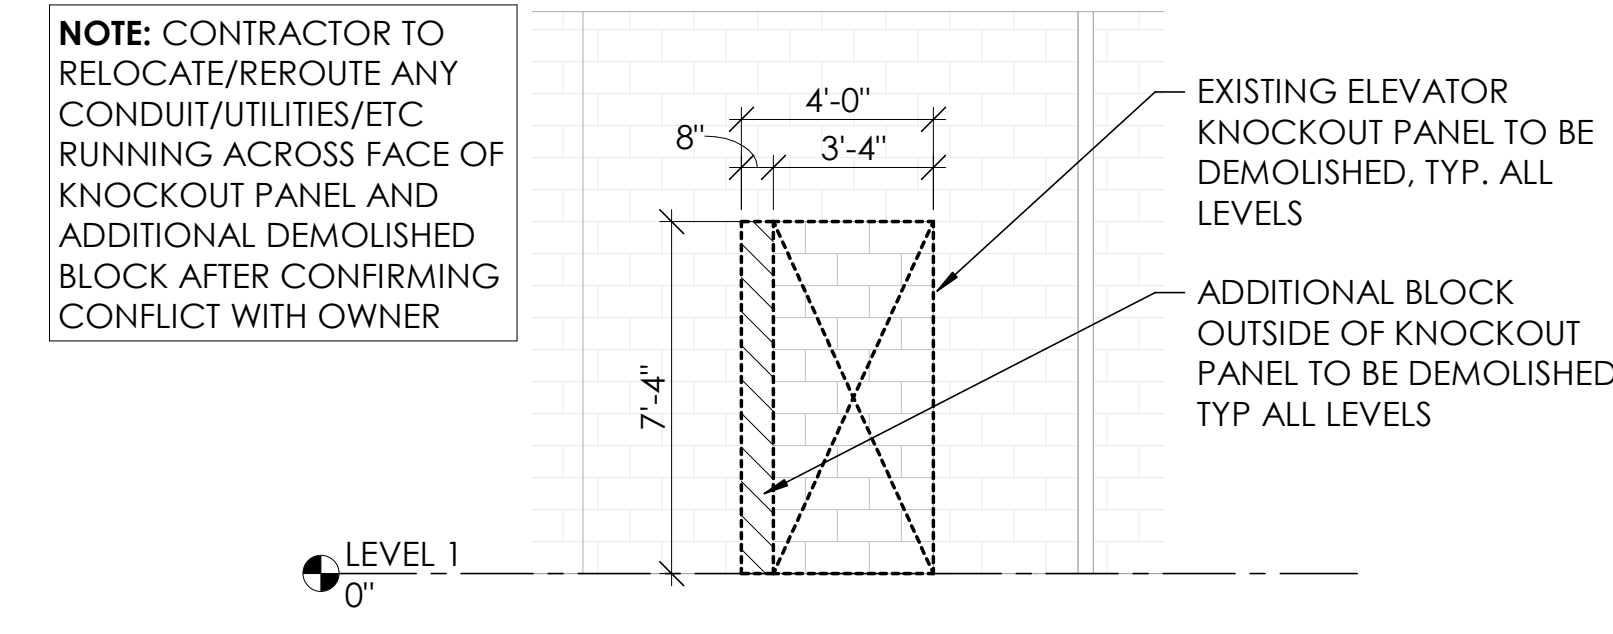


**4 DEMO ELEVATION - ELEVATOR KNOCKOUT PANEL**  
SCALE: 1/4" = 1'-0"

**NOTE:** CONTRACTOR TO RELOCATE/REROUTE ANY CONDUIT/UTILITIES/ETC RUNNING ACROSS FACE OF KNOCKOUT PANEL AND ADDITIONAL DEMOLISHED BLOCK AFTER CONFIRMING CONFLICT WITH OWNER


EXISTING ELEVATOR KNOCKOUT PANEL TO BE DEMOLISHED, TYP. ALL LEVELS  
ADDITIONAL BLOCK OUTSIDE OF KNOCKOUT PANEL TO BE DEMOLISHED, TYP ALL LEVELS

PRELIMINARY <b>90% Progress Submittal</b> NOT FOR CONSTRUCTION OR RECORDING	CITY OF MESA ENGINEERING DEPARTMENT	
	HIBBERT GARAGE RENOVATIONS	
DRAWN BY: [ ] DESIGN: [ ] APPROVED BY: [ ]	DEMOLITION ELEVATIONS	
	DRAWING NUMBER: AD201	
PROJECT: [ ] PROJ. NO.: CP1189	SHEET: 29 OF 74	DRAWING NUMBER: A-286163




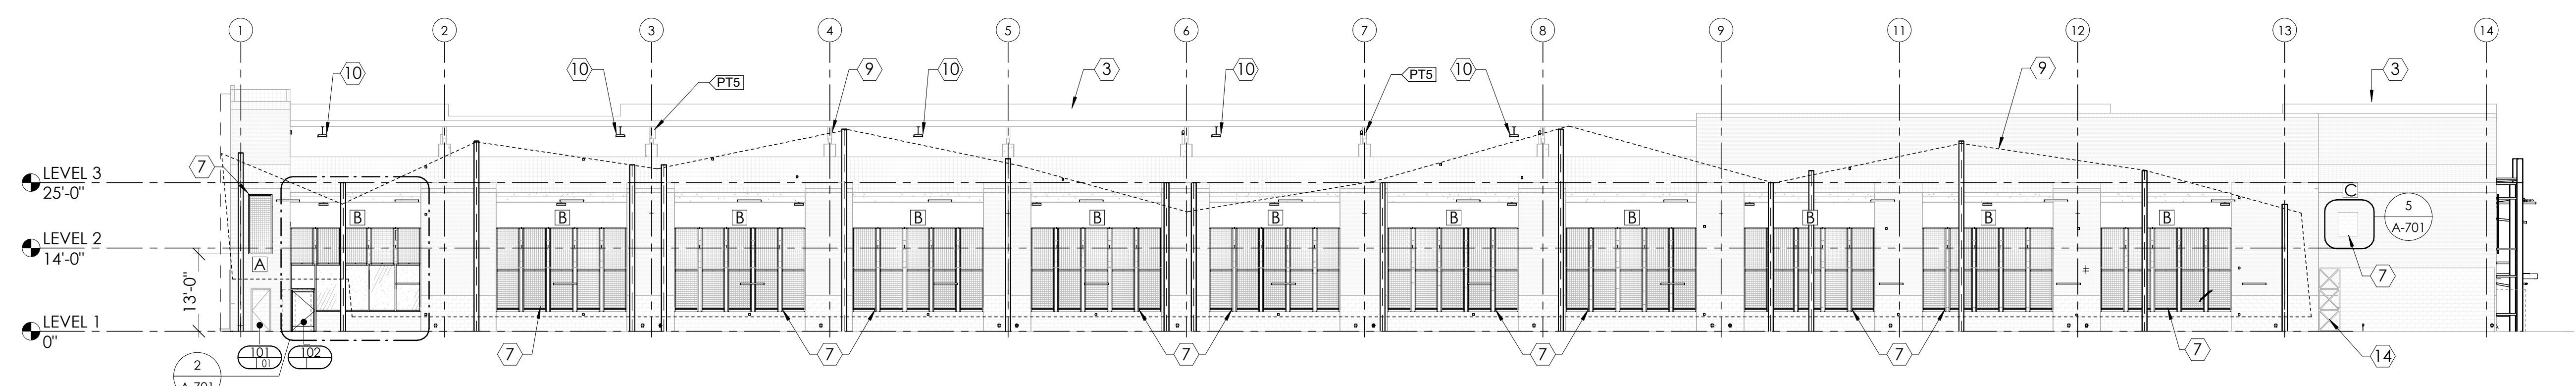


**1 EXTERIOR ELEVATION - SOUTH**  
SCALE: 1/16" = 1'-0"

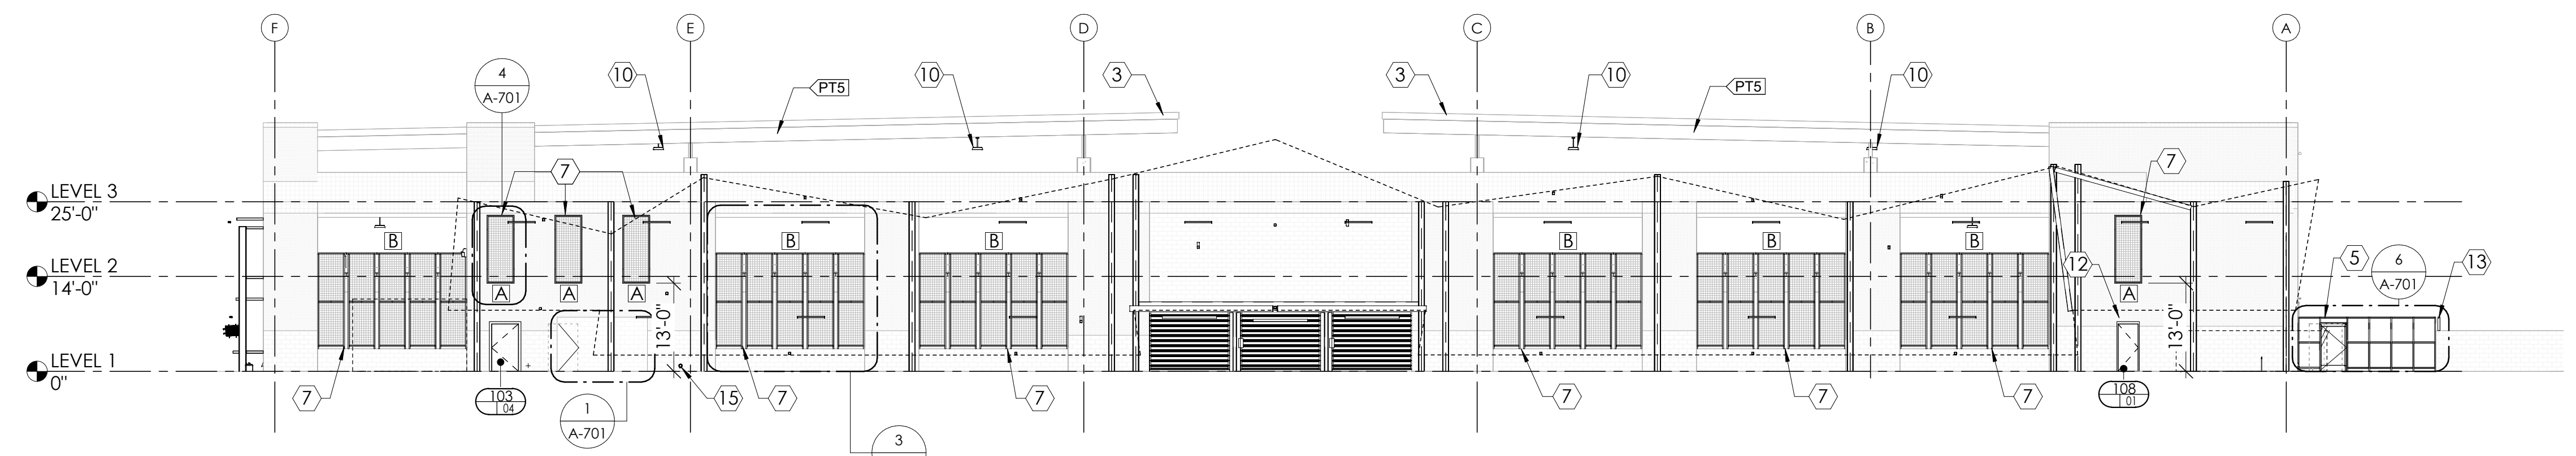

**2 EXTERIOR ELEVATION - EAST**  
SCALE: 1/16" = 1'-0"

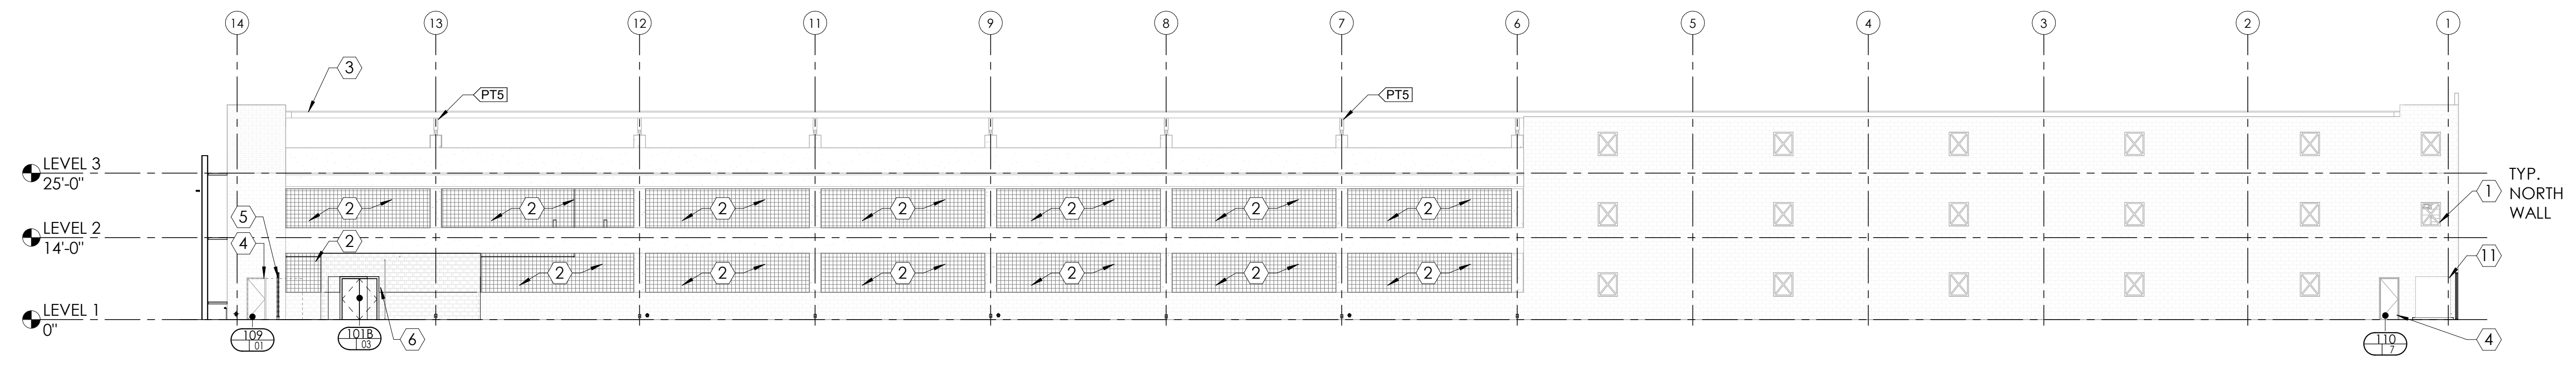

**3 EXTERIOR ELEVATION - NORTH**  
SCALE: 1/16" = 1'-0"

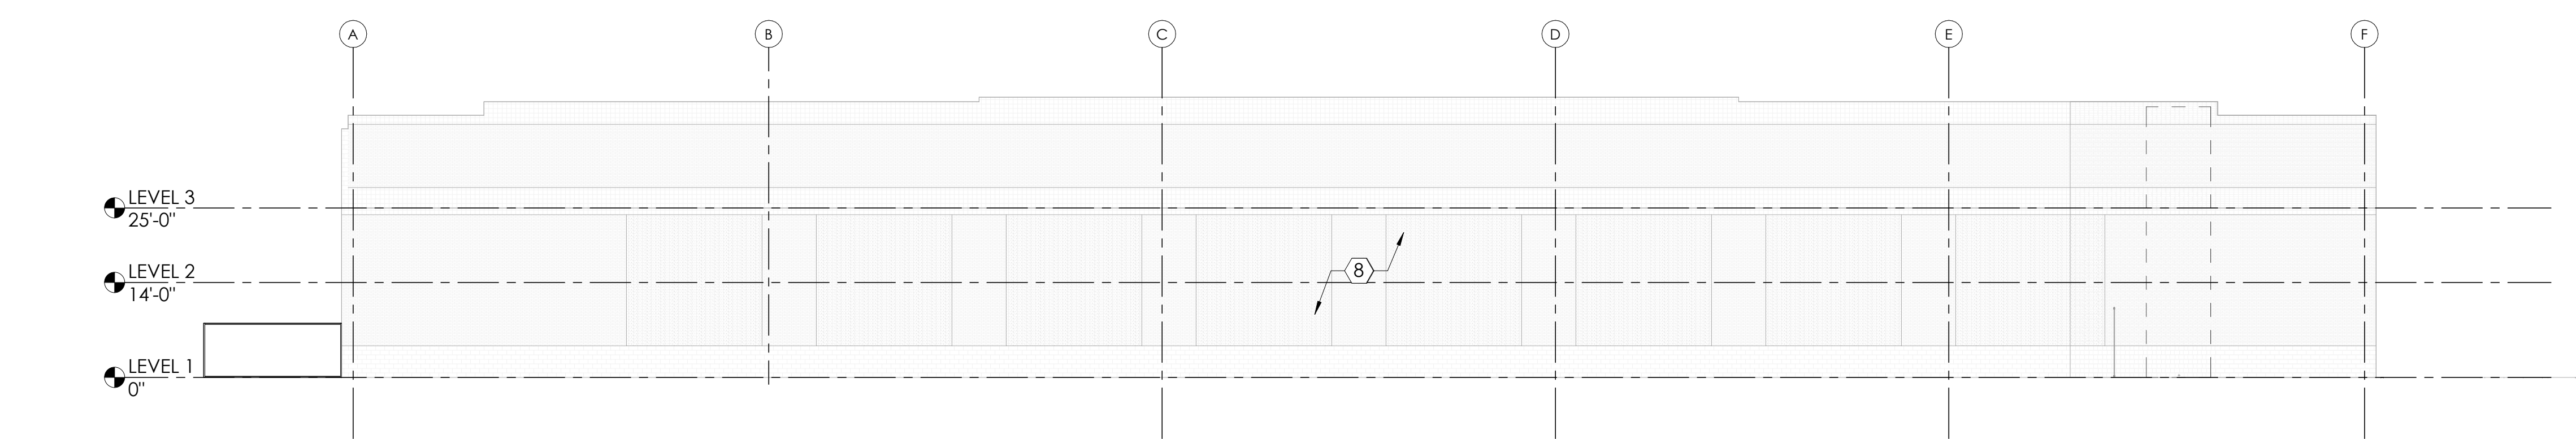

**4 EXTERIOR ELEVATION - WEST**  
SCALE: 1/16" = 1'-0"


- KEYNOTES**
- 1 EXISTING WINDOW SCREEN TO REMAIN. REPAIR AS DETERMINED NECESSARY BY OWNER.
  - 2 EXISTING WELDED METAL SCREEN TO RECEIVE NEW PAINT.
  - 3 EXISTING CANOPY AND STRUCTURE TO REMAIN. EXISTING STEEL COLUMNS, BEAMS, AND PURLINS TO RECEIVE NEW PAINT. REFER TO FINISH SCHEDULE.
  - 4 EXISTING EXTERIOR DOOR TO BE RECONDITIONED AND PAINTED AS SPECIFIED.
  - 5 NEW FENCE AND GATE WITH CARD READER AND PANIC HARDWARE.
  - 6 8X8X16 CMU INFILL WALL ABOVE EXISTING MASONRY WALL TO BOTTOM OF EXISTING PRECAST PANEL. REFER TO STRUCTURAL.
  - 7 HSS STEEL FRAMED METAL WIRE MESH SCREENS.
  - 8 EXISTING 1HR CMU PARTY WALL.
  - 9 OUTLINE OF NEW ARCHITECTURAL SCREENS. REFER TO SHEET A-202.
  - 10 NEW PENDANT LIGHT. REFER TO ELECTRICAL DRAWINGS.
  - 11 EXISTING ELECTRICAL SERVICE AND HOUSEKEEPING PAD TO REMAIN UNTIL NEW SERVICE IS INSTALLED. REFER TO ELECTRICAL DRAWINGS FOR MORE INFORMATION.
  - 12 INFILL MASONRY OPENING AS REQUIRED TO MATCH EXISTING.
  - 13 NEW 2'-0" HIGH STEEL TUBE AND WIRE MESH FENCE MOUNTED TO 4'-0" EXISTING CMU SITE WALL.
  - 14 EXISTING METAL SCREEN TO REMAIN.
  - 15 NEW DOWNSPOUT NOZZLE AND CONCRETE SPLASH BLOCK. REFER TO PLUMBING FOR MORE INFORMATION.

- ELEVATION GENERAL NOTES**
- A. DIMENSIONS FOR SPEED DOORS FOR REFERENCE ONLY. FIELD VERIFY DIMENSIONS AND CONSULT WITH DOOR MANUFACTURER FOR REQUIRED CLEARANCES.

PRELIMINARY <b>90% Progress Submittal</b> NOT FOR CONSTRUCTION OR RECORDING	CITY OF MESA ENGINEERING DEPARTMENT	
	HIBBERT GARAGE RENOVATIONS	
DRAWN BY: [blank] SR: [blank] DESIGN: [blank] SR: [blank] APPROVED BY: [blank] SR: [blank]	BUILDING ELEVATIONS - EXTERIOR	DRAWING A-201
PROJECT: PROJ. NO.: CP1189	SHEET 33 OF 74	DRAWING NUMBER A-286167






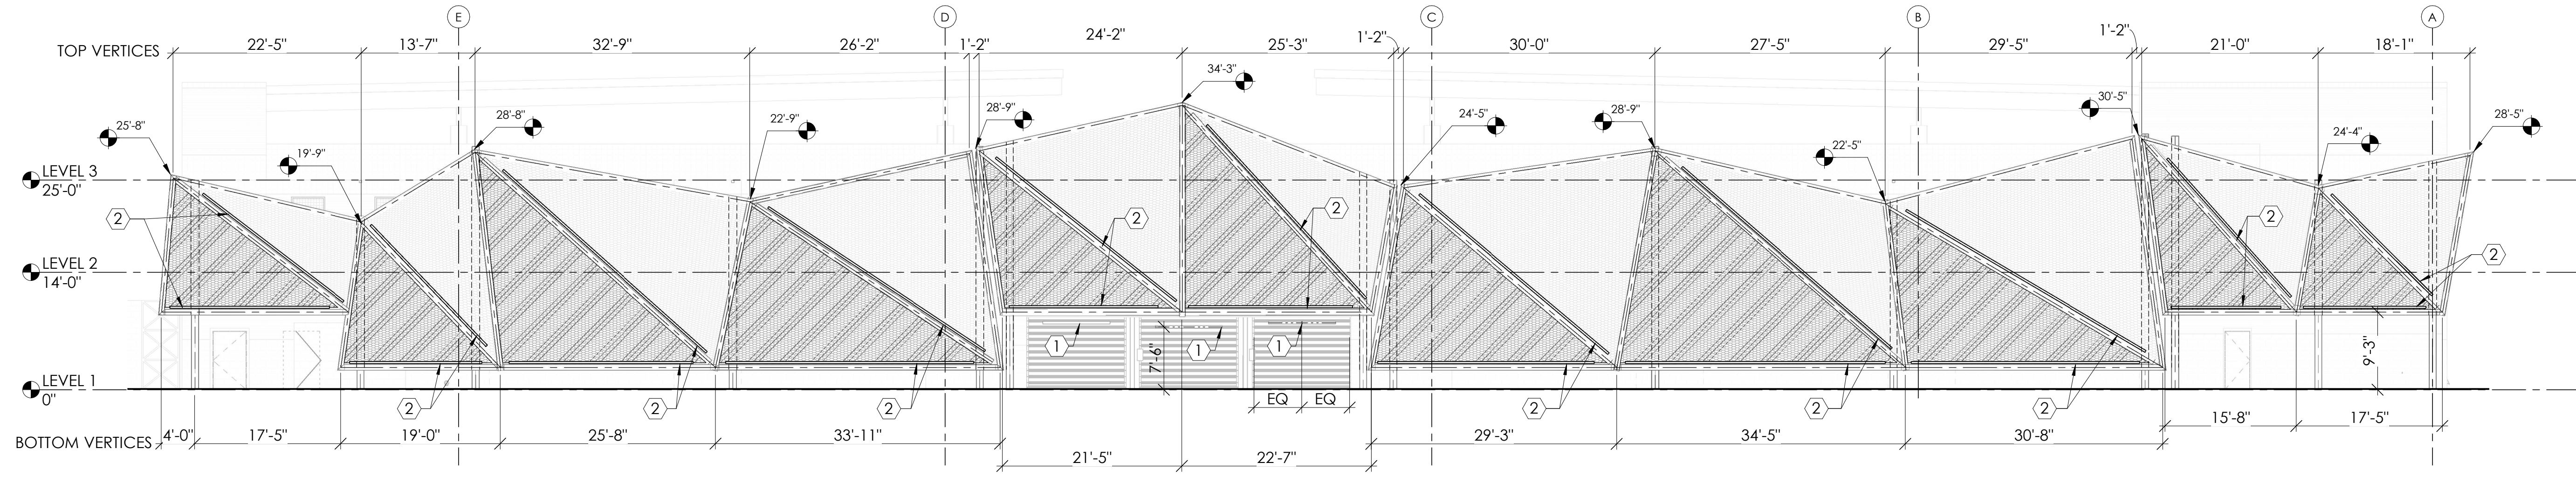


- KEYNOTES**
- OVERHEAD CLEARANCE BAR SUSPENDED FROM UNDERSIDE OF FACADE ELEMENT FRAMING @ 8'-0", 8" DIAMETER 10'-0" LENGTH
  - LINEAR RGB LIGHT FIXTURE AIMED UP ONTO COILED WIRE FABRIC. REFER TO ELECTRICAL DRAWINGS FOR MORE INFORMATION.
- FACADE SCREEN NOTES**
- A. DIMENSIONS OF SCREEN STRUCTURE AND PANELS ARE TO CENTERLINES OF STEEL MEMBERS, UNLESS NOTED OTHERWISE.

- ELEVATION LEGEND**
- STAINLESS STEEL COILED WIRE FABRIC - METALLIC WHITE FINISH BY MANUFACTURER
  - STAINLESS STEEL COILED WIRE FABRIC - SILVER FINISH BY MANUFACTURER


**1 EAST SCREEN ENLARGED ELEVATION**  
 SCALE: 3/32" = 1'-0"

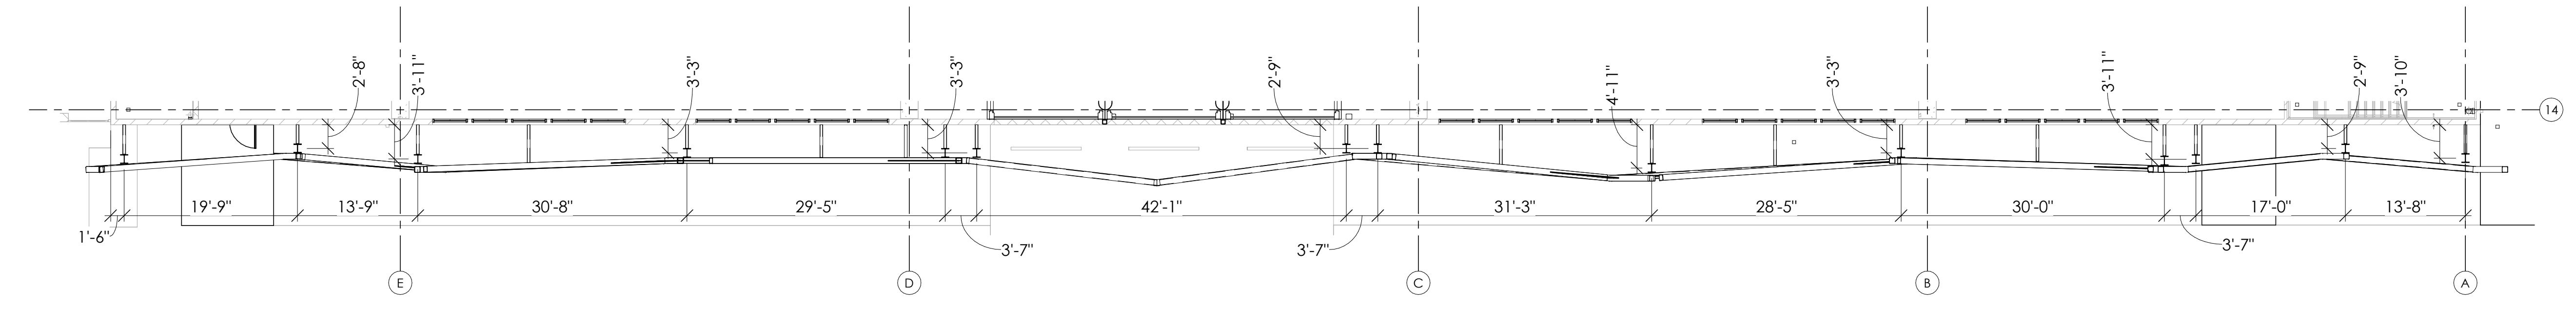

**5 EAST SCREEN ENLARGED PLAN AT GRADE LEVEL**  
 SCALE: 3/32" = 1'-0"

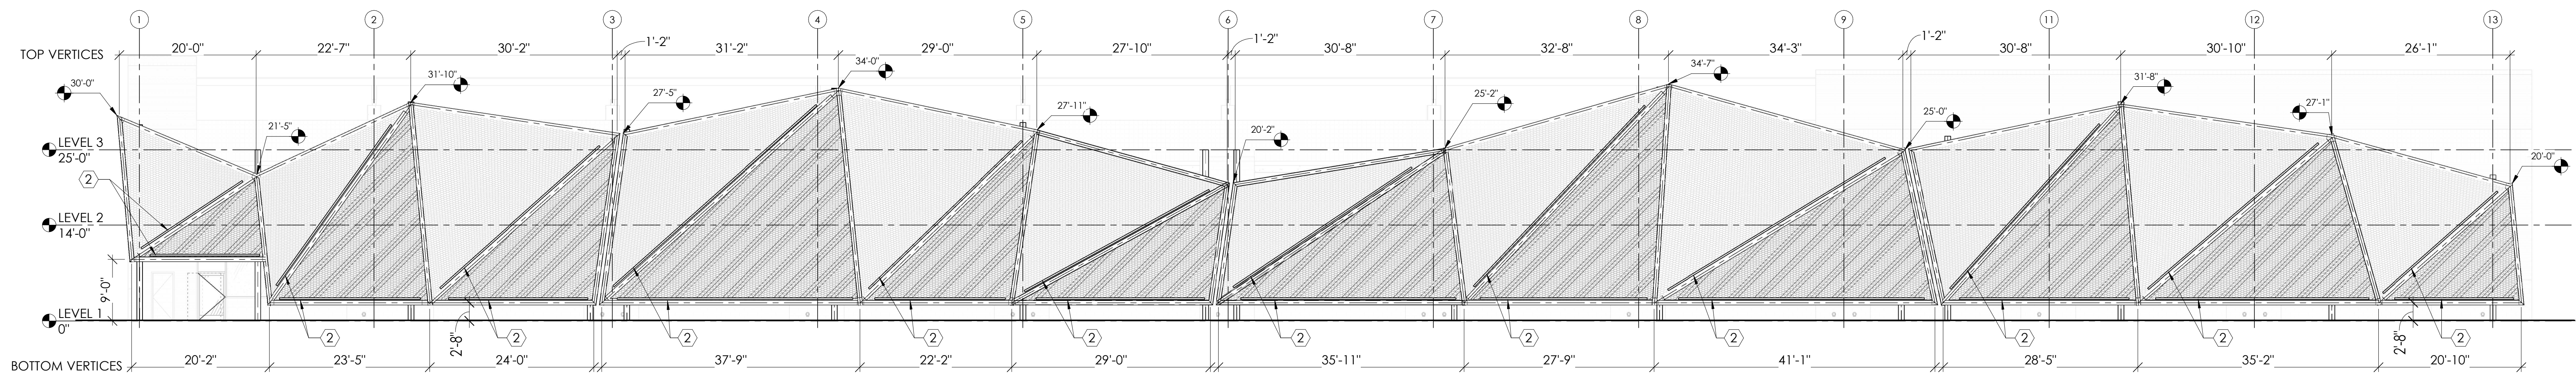

**3 SOUTH SCREEN ENLARGED ELEVATION**  
 SCALE: 3/32" = 1'-0"

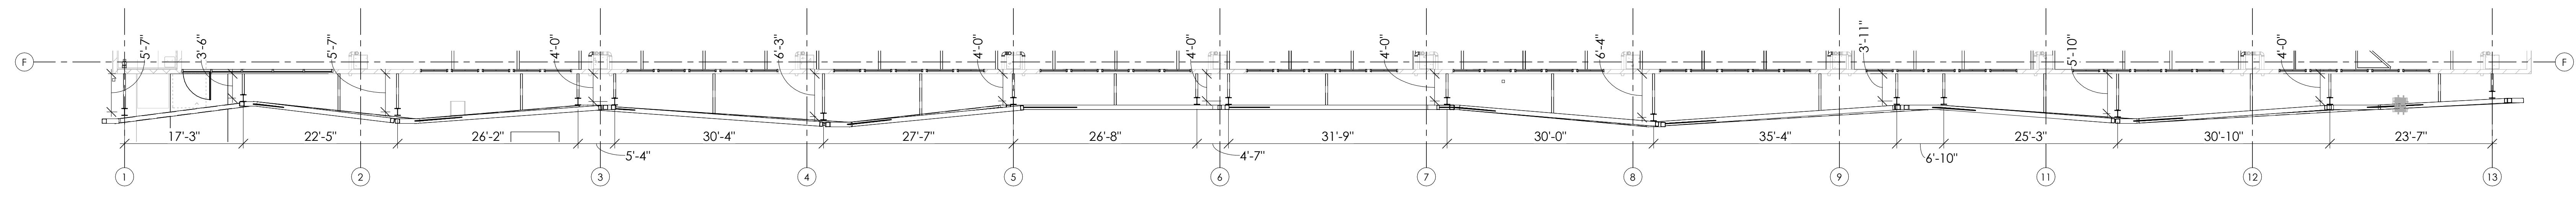

**2 SOUTH SCREEN ENLARGED PLAN AT GRADE LEVEL**  
 SCALE: 3/32" = 1'-0"

PRELIMINARY <b>90% Progress Submittal</b> NOT FOR CONSTRUCTION OR RECORDING	CITY OF MESA ENGINEERING DEPARTMENT	
	HIBBERT GARAGE RENOVATIONS	
DRAWN BY: SR, CL DESIGN: SR, CL APPROVED BY: SR, CL	SCREEN WALL & SCREEN ELEVATIONS	
SHEET NO. 34 OF 74 PROJECT NO. CP1189	DRAWING NUMBER: A-286168	





