
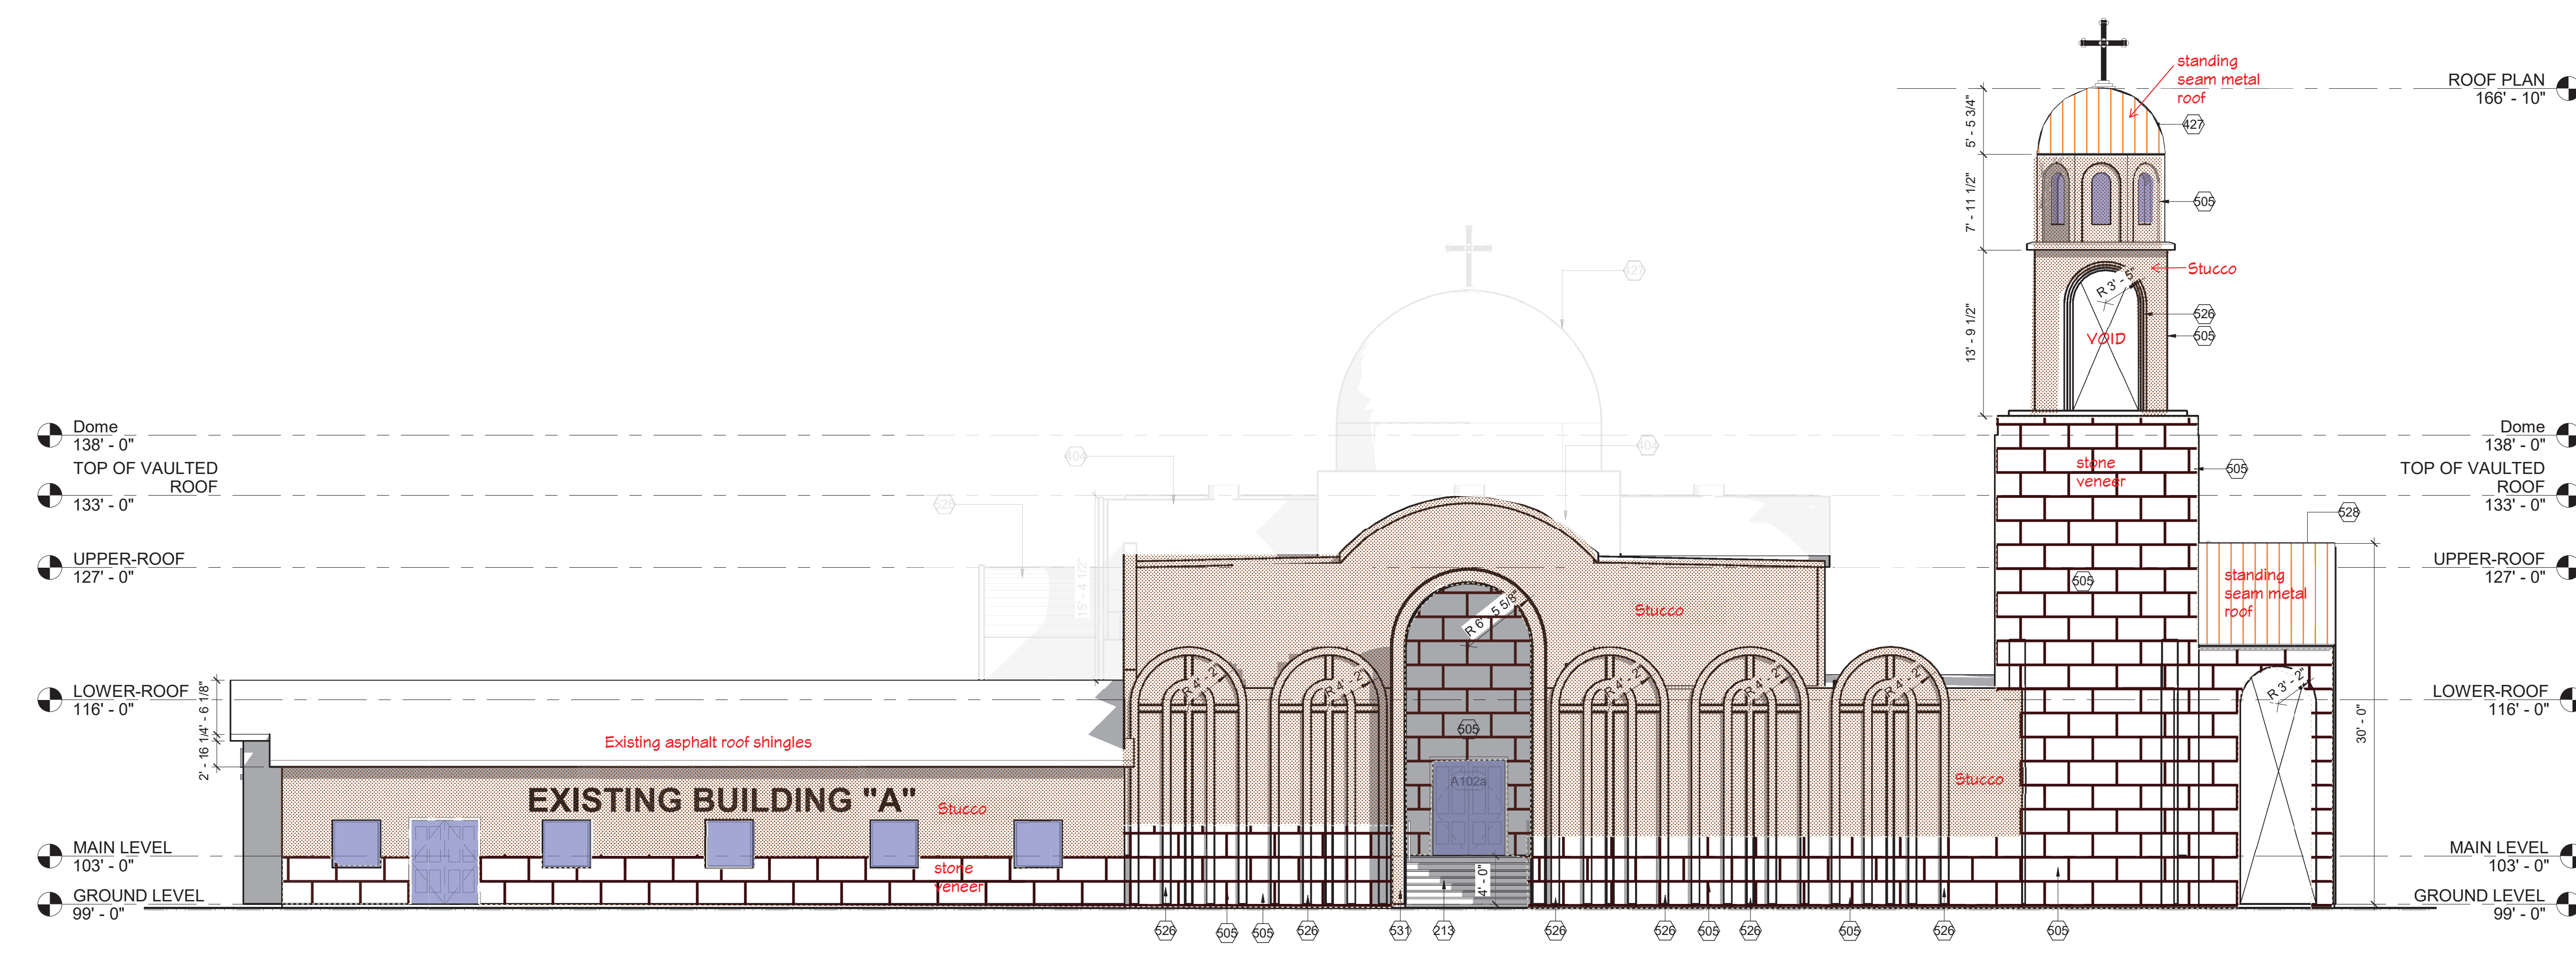





Total facade area = 3,783 sf = 100%
 Glazing area = 349 sf = 9%
 Stone veneer = 1,574 sf = 42%
 Stucco finish = 1,860 sf = 49%

1 EAST ELEVATION SIDE ENTRANCE
 1/8" = 1'-0"

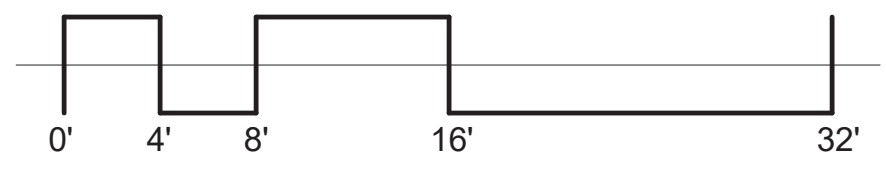


Total facade area = 3,827 sf = 100%
 Glazing area = 194 sf = 5%
 Stone veneer = 1,743 sf = 45%
 Stucco finish = 1,890 sf = 49%

4 WEST ELEVATION MAIN ENTRANCE
 1/8" = 1'-0"

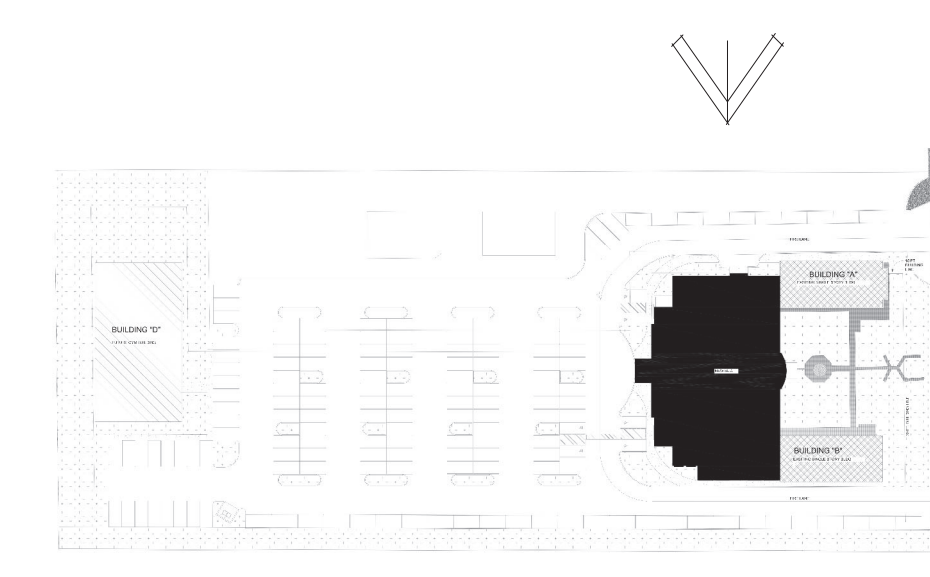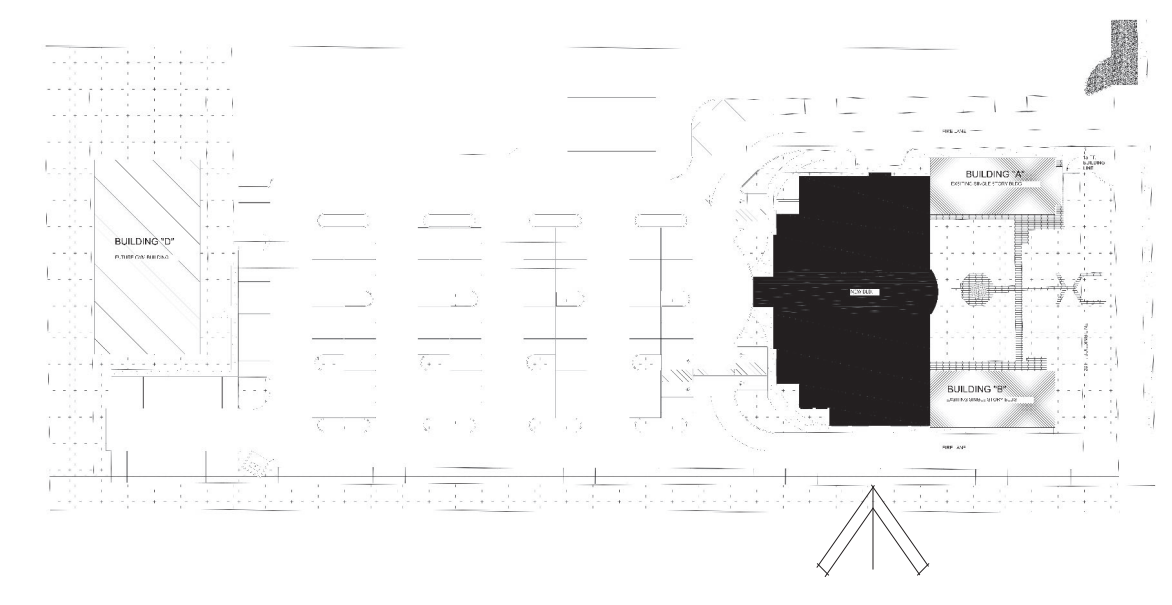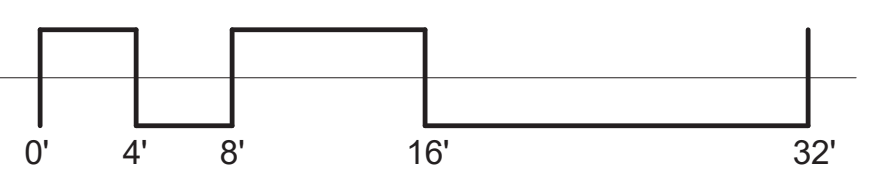

Exterior finish material

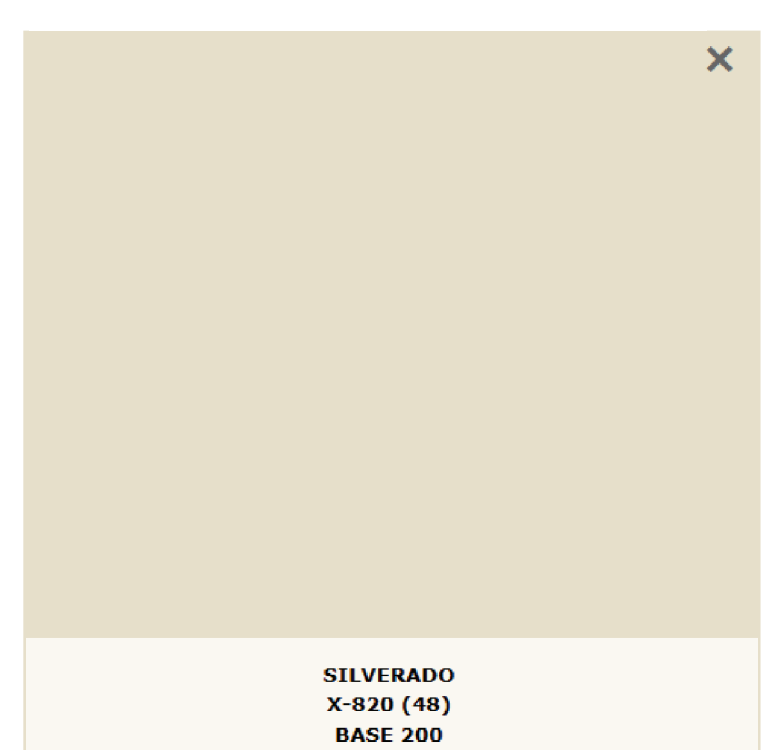

GENERAL ELEVATIONS NOTES

EXTERIOR FINISH:
 CONFLEX™ SHERLASTIC® ELASTOMERIC COATING BY SHERWIN WILLIAMS.
 COLOR: TBD

- APPLICATIONS:
- TEMPERATURE: 50°-100°F
 - REDUCER: DO NOT REDUCE
 - AIRLESS SPRAY:
 - PRESSURE 2300 P.S.I.
 - TIP: .021 INCH
 - CONCRETE & STUCCO:
 - 1 COAT LOXON CONCRETE AND MASONRY PRIMER
 - 2 COATS CONFLEX SHERLASTIC ELASTOMERIC CONCRETE BLOCK, CMU, SPLIT-FACE BLOCK
 - CONCRETE & STUCCO:
 - 1-2 COATS CONFLEX BLOCK FILLER OR
 - 1-2 COATS LOXON ACRYLIC BLOCK SURFACER
 - 2 COATS CONFLEX SHERLASTIC ELASTOMERIC CONCRETE BLOCK, CMU, SPLIT-FACE BLOCK
 - CONSIDERATIONS TO MINIMIZE PINHOLES:
 - 2 COAT APPLICATION WITH OVERNIGHT DRYING
 - SPRAY APPLICATION WITH BACKROLLING
 - POWER ROLLING

- SURFACE PREPARATION
- GAPS BETWEEN WINDOWS, DOORS, TRIM, AND OTHER THROUGH-WALL OPENINGS CAN BE FILLED WITH THE APPROPRIATE CAULK AFTER PRIMING THE SURFACE. REMOVE ALL DIRT, DUST, MILDEW, LOOSE PARTICLES, LANTAGE, FOREIGN MATERIAL, PEELING AND DEFECTIVE COATINGS, CHALK, FORM RELEASE AGENTS, MOISTURE CURING MEMBRANES, ETC. ALL NEW SURFACES MUST BE CURED ACCORDING TO THE SUPPLIER'S RECOMMENDATION USUALLY ABOUT 30 DAYS. IF PAINTING CANNOT WAIT 30 DAYS, ALLOW THE SURFACE TO CURE 7 DAYS AT 75°F AND PRIME THE SURFACE WITH LOXON CONCRETE & MASONRY PRIMER OR LOXON BLOCK SURFACER TO FILL BLOCK, AND CMU.
 - ON TILT-UP AND POURED-IN-PLACE CONCRETE, COMMERCIAL DETERGENTS AND SANDBLASTING MAY BE NECESSARY TO REMOVE SEALERS, RELEASE COMPOUNDS, AND TO PROVIDE AN ANCHOR PATTERN. ALLOW THE SURFACE TO DRY THOROUGHLY. PRIMER REQUIRED. CONCRETE AND MORTAR MUST BE CURED AT LEAST 30 DAYS. IF PAINTING CANNOT WAIT 30 DAYS, ALLOW THE SURFACE TO CURE 7 DAYS AT 75°F AND PRIME THE SURFACE WITH LOXON CONCRETE & MASONRY PRIMER. FILL BUGHOLES, AIR POCKETS, CRACKS, AND OTHER VOIDS WITH AN ELASTOMERIC PATCH OR SEALANT. ROUGH SURFACES CAN BE FILLED TO PROVIDE A SMOOTH SURFACE.

- CLEANUP INFORMATION
- CLEAN SPILLS, SPATTERS, HANDS AND TOOLS IMMEDIATELY AFTER USE WITH SOAP AND WARM WATER. AFTER CLEANING, FLUSH SPRAY EQUIPMENT WITH A COMPLIANT CLEANUP SOLVENT TO PREVENT RUSTING OF THE EQUIPMENT.
 - FOLLOW MANUFACTURER'S SAFETY RECOMMENDATIONS WHEN USING SOLVENTS.

Keynote Legend

Key Value	Keynote Text
213	EXTERIOR STEPS
404	VAULTED CEILING USING CURVED SUSPENDED SYSTEM WITH (2) LAYERS OF 1/4" GYP-BD BENDED.
427	FIBERGLASS DOME
505	3/4" CEMENT (2) COAT STUCCO ON METAL LATH
526	EPS WALL FRAME MOLD WITH STUCCO FINISH
528	VAULTED STANDING SEAM METAL ROOF
529	EXISTING ASPHALT ROOF SHINGLES TILES
531	METAL COPPER DECORATIVE FRAME

EXTERIOR FINISH LEGEND

	Standing seam metal roof
	Stucco finish
	Glazing
	Stone veneer

ARCHITECT OF RECORD:

DESIGN ARCHITECT:

MASTERPLAN DESIGN LLC
 ADDRESS: 2001 TIMBER CREEK RD, #109 FLOWER MOUND, TX 75026
 CONTACT: ASHRAF SHOKRY (214) 718-9119 ashraf@masterplan-design.com EMAIL:

OWNER:

ST. JOSEPH COPTIC ORTHODOX CHURCH
 ADDRESS: 5013 E. BROADWAY RD. MESA AZ 85206
 CONTACT: FR. THOMAS MANSOUR 480-809-0028 fatherthomas@stjosephaz.org EMAIL:

CIVIL:

KEOGH ENGINEERING, INC.
 ADDRESS: 850 N. 137TH AVE, #110 TEMPE, ARIZONA 85338
 CONTACT: DENNIS F. KEOGH, P.E. (602) 535-7260 keogh@keoghengineering.com EMAIL:


STRUCTURAL:

COOK STRUCTURAL ENGINEERS
 ADDRESS: 12850 SPURLING ROAD SUITE 120 DALLAS, TX 75250
 CONTACT: JACK COOK, P.E. (972) 387-1920 jack_cse@scglobal.net EMAIL:

MEP:

ABUWANDI ENGINEERING ASSOCIATES
 ADDRESS: 64 E. BROADWAY RD. SUITE 200 TEMPE, ARIZONA 85282
 CONTACT: ZEID ABUWANDI, P.E. (480) 372-4073 zeid@abuwandieng.com EMAIL:

Issue	Issue Name	Date

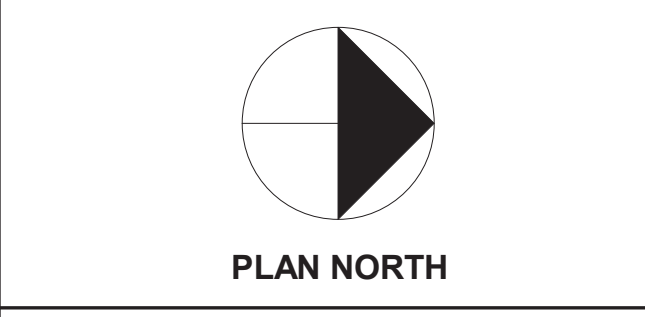

ST.Meena Coptic Orthodox Church
 11545 ALTA VISTA ROAD
 FORT WORTH, TEXAS 76244

ISSUED FOR PRELIMINARY PURPOSES ONLY.

THESE DOCUMENTS MAY NOT BE USED FOR REGULATORY APPROVAL, PERMITTING OR CONSTRUCTION.

THESE DRAWINGS ARE ASSUMED TO BE COMPLETE AND FINAL. IT SHALL BE THE TENANT/CLIENT'S RESPONSIBILITY TO REVIEW AND BRING IN WRITING ANY DESIGN DISCREPANCIES TO THE DESIGNER'S ATTENTION. ANY DESIGN CHANGES WILL BE AT ADDITIONAL EXPENSE. THE DESIGNER SHALL NOT BE HELD RESPONSIBLE FOR CITY, STATE AND FEDERAL CODE/REGULATION AUTHORITY'S INTERPRETATIONS.

APPROVED: _____ DATE: _____

SCHEMATIC DESIGN

Sheet Name: **BUILDING ELEVATIONS**

Original Issue: _____
 Sheet Number: _____

A2.01

Project # 005 Drawing Date 6/9/2023

GENERAL ELEVATIONS NOTES

EXTERIOR FINISH:
 CONPLEXSM SHERLASTICSM
 ELASTOMERIC COATING BY SHERWIN WILLIAMS.
 COLOR: TBD


- APPLICATIONS:**
- TEMPERATURE: 50°-100°F
 - REDUCER: DO NOT REDUCE
 - AIRLESS SPRAY:
 - A. PRESSURE 2300 P.S.I.
 - B. TIP .021 INCH
 - CONCRETE & STUCCO:
 - A. 1 COAT LOXON CONCRETE AND MASONRY PRIMER
 - B. 2 COATS CONPLEX
 - SHERLASTIC ELASTOMERIC CONCRETE BLOCK, CMU, SPLIT-FACE BLOCK:
 - A. 1-2 COATS CONPLEX BLOCK FILLER OR
 - B. 1-2 COATS LOXON ACRYLIC BLOCK SURFACER
 - C. 2 COATS CONPLEX SHERLASTIC ELASTOMERIC
 - CONSIDERATIONS TO MINIMIZE PINHOLES:
 - A. 2 COAT APPLICATION WITH OVERNIGHT DRYING BETWEEN COATS
 - B. SPRAY APPLICATION WITH BACKROLLING
 - C. POWER ROLLING

SURFACE PREPARATION

- GAPS BETWEEN WINDOWS, DOORS, TRIM, AND OTHER THROUGH-WALL OPENINGS CAN BE FILLED WITH THE APPROPRIATE CAULK AFTER PRIMING THE SURFACE. REMOVE ALL DIRT, DUST, MILDEW, LOOSE PARTICLES, LAITANCE, FOREIGN MATERIAL, PEELING AND DEFECTIVE COATINGS, CHALK, FORM RELEASE AGENTS, MOISTURE CURING MEMBRANES, ETC. ALL NEW SURFACES MUST BE CURED ACCORDING TO THE SUPPLIER'S RECOMMENDATION USUALLY ABOUT 30 DAYS. IF PAINTING CANNOT WAIT 30 DAYS, ALLOW THE SURFACE TO CURE 7 DAYS AT 75°F AND PRIME THE SURFACE WITH LOXON CONCRETE & MASONRY PRIMER OR LOXON BLOCK SURFACER TO FILL BLOCK, AND CMU.
- ON TILT-UP AND Poured-IN-PLACE CONCRETE, COMMERCIAL DETERGENTS AND SANDBLASTING MAY BE NECESSARY TO REMOVE SEALERS, RELEASE COMPOUNDS, AND TO PROVIDE AN ANCHOR PATTERN. ALLOW THE SURFACE TO DRY THOROUGHLY. PRIMER REQUIRED. CONCRETE AND MORTAR MUST BE CURED AT LEAST 30 DAYS. IF PAINTING CANNOT WAIT 30 DAYS, ALLOW THE SURFACE TO CURE 7 DAYS AT 75°F AND PRIME THE SURFACE WITH LOXON CONCRETE & MASONRY PRIMER. FILL BUGHOLES, AIR POCKETS, CRACKS, AND OTHER VOIDS WITH AN ELASTOMERIC PATCH OR SEALANT. ROUGH SURFACES CAN BE FILLED TO PROVIDE A SMOOTH SURFACE.

CLEANUP INFORMATION

- CLEAN SPILLS, SPATTERS, HANDS AND TOOLS IMMEDIATELY AFTER USE WITH SOAP AND WARM WATER.
- AFTER CLEANING, FLUSH SPRAY EQUIPMENT WITH A COMPLIANT CLEANUP SOLVENT TO PREVENT RUSTING OF THE EQUIPMENT.
- FOLLOW MANUFACTURER'S SAFETY RECOMMENDATIONS WHEN USING SOLVENTS.

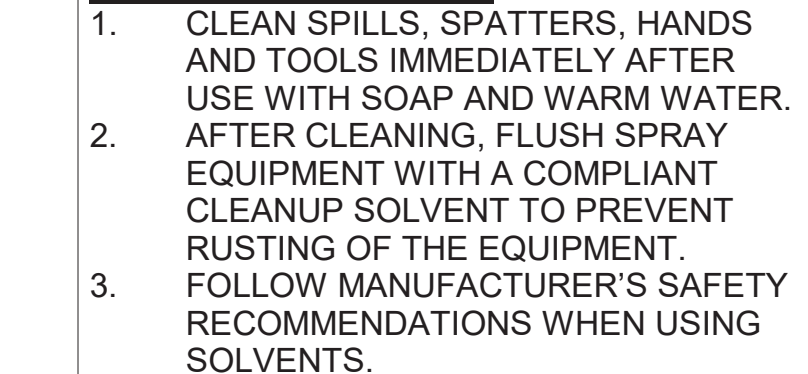

Keynote Legend

Key Value	Keynote Text
213	EXTERIOR STEPS
404	VAULTED CEILING, USING CURVED SUSPENDED SYSTEM WITH (2) LAYERS OF 1/4" GYP-BD BENDED.
427	FIBERGLASS DOME
505	3/4" CEMENT (2) COAT STUCCO ON METAL LATH
522	GUTTER
526	EPS WALL FRAME MOLD WITH STUCCO FINISH

EXTERIOR FINISH LEGEND

- Standing seam metal roof
- Stucco finish
- Glazing
- Stone veneer

ST. JOSEPH COPTIC ORTHODOX CHURCH

11545 ALTA VISTA ROAD
FORT WORTH, TEXAS 76244

ISSUED FOR PRELIMINARY PURPOSES ONLY.

THESE DOCUMENTS MAY NOT BE USED FOR REGULATORY APPROVAL, PERMITTING OR CONSTRUCTION.

THESE DRAWINGS ARE ASSUMED TO BE COMPLETE AND FINAL. IT SHALL BE THE TENANT/CLIENT'S RESPONSIBILITY TO REVIEW AND BRING IN WRITING ANY DESIGN DISCREPANCIES TO THE DESIGNERS' ATTENTION. ANY DESIGN CHANGES WILL BE AT ADDITIONAL EXPENSE. THE DESIGNER SHALL NOT BE HELD RESPONSIBLE FOR CITY, STATE AND FEDERAL CODE/REGULATION AUTHORITY'S INTERPRETATIONS.


APPROVED: _____ DATE: _____

SCHEMATIC DESIGN

Sheet Name
BUILDING ELEVATIONS


Original Issue
Sheet Number
A2.02

Project # 005 Drawing Date 6/9/2023

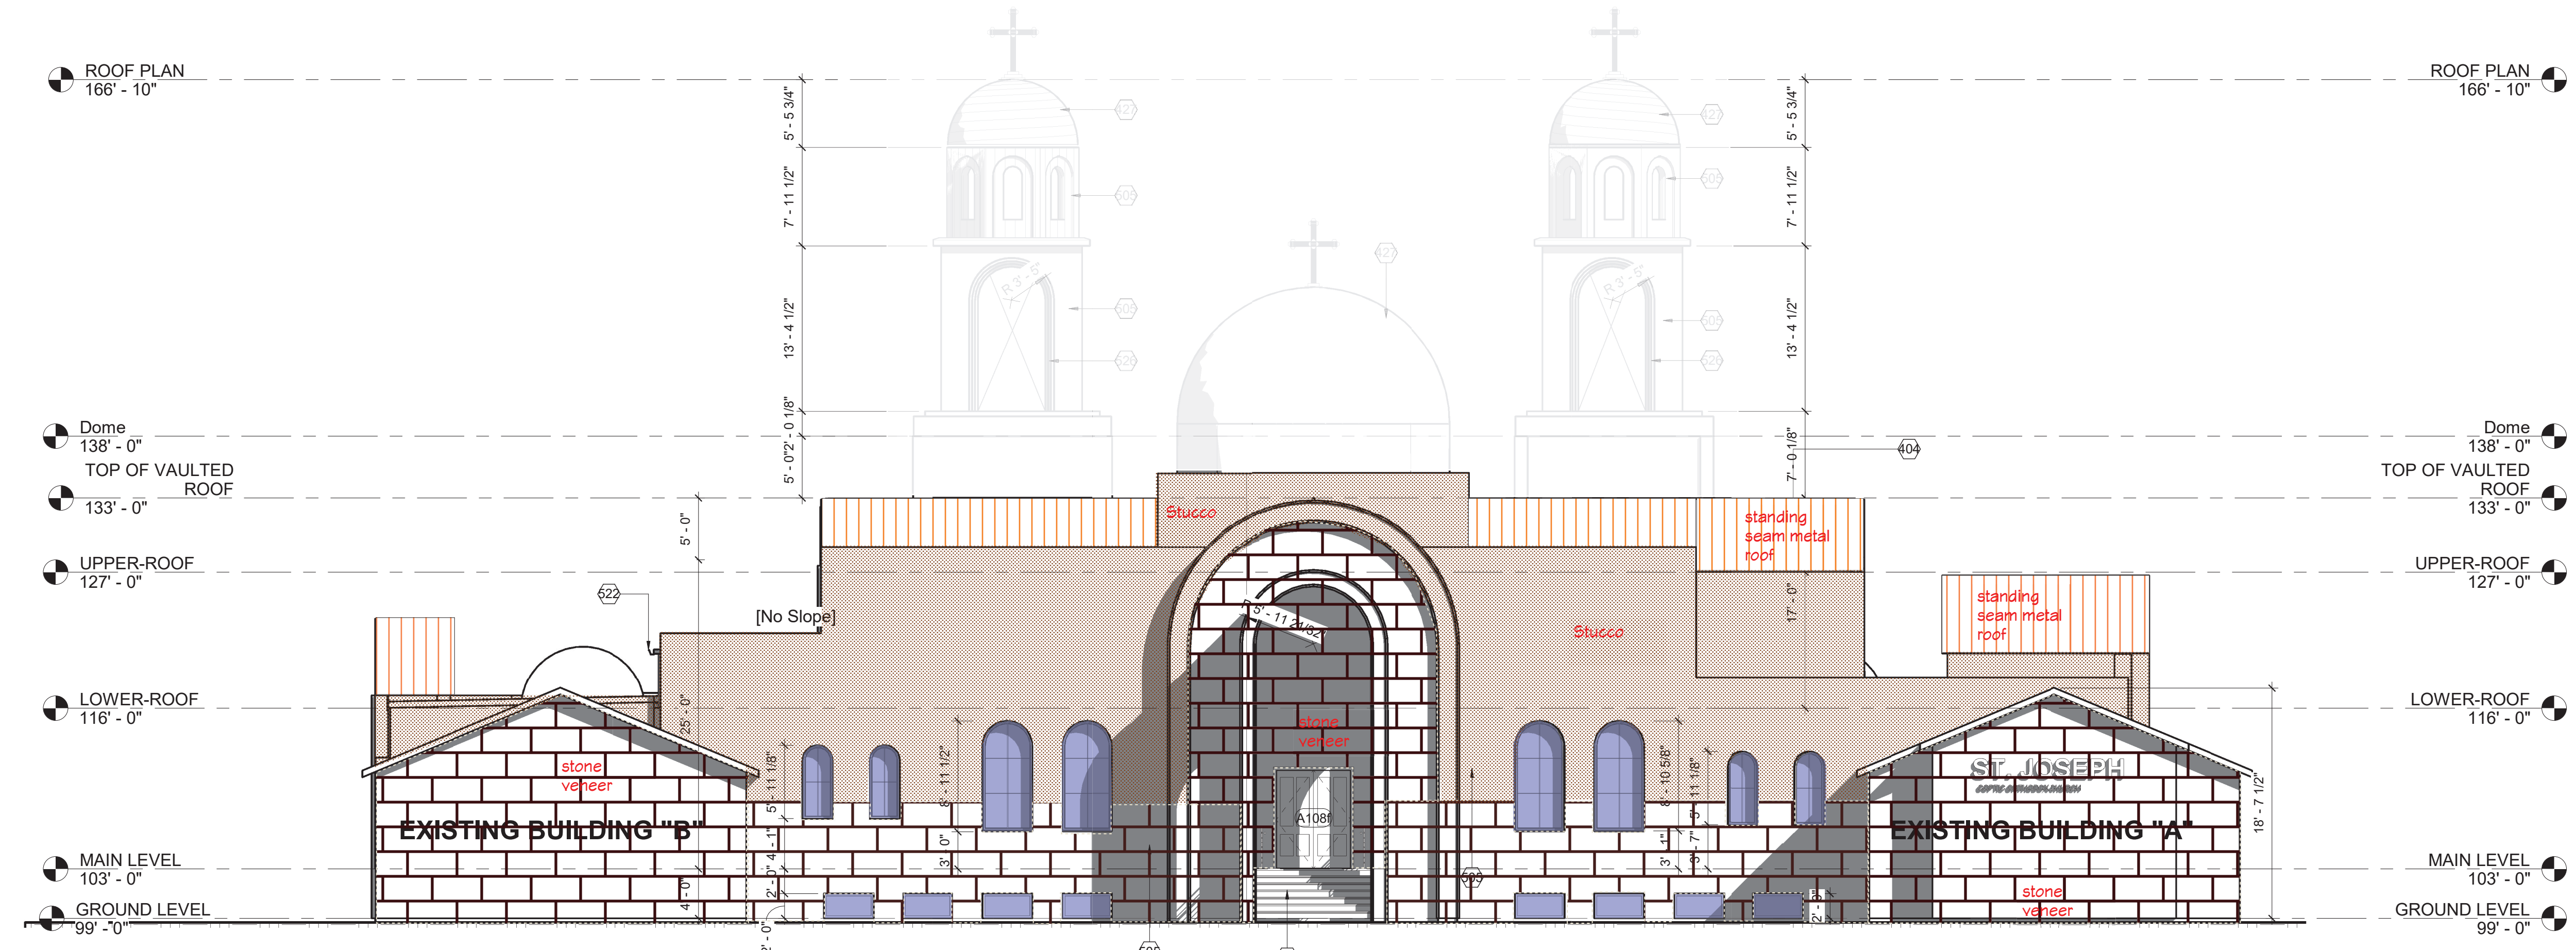



Total facade area = 3,962 sf = 100%
 Glazing area = 256 sf = 7%
 Stone veneer = 1,950 sf = 49%
 Stucco finish = 1,756 sf = 44%

1 NORTH ELEVATION BACK
1/8" = 1'-0"

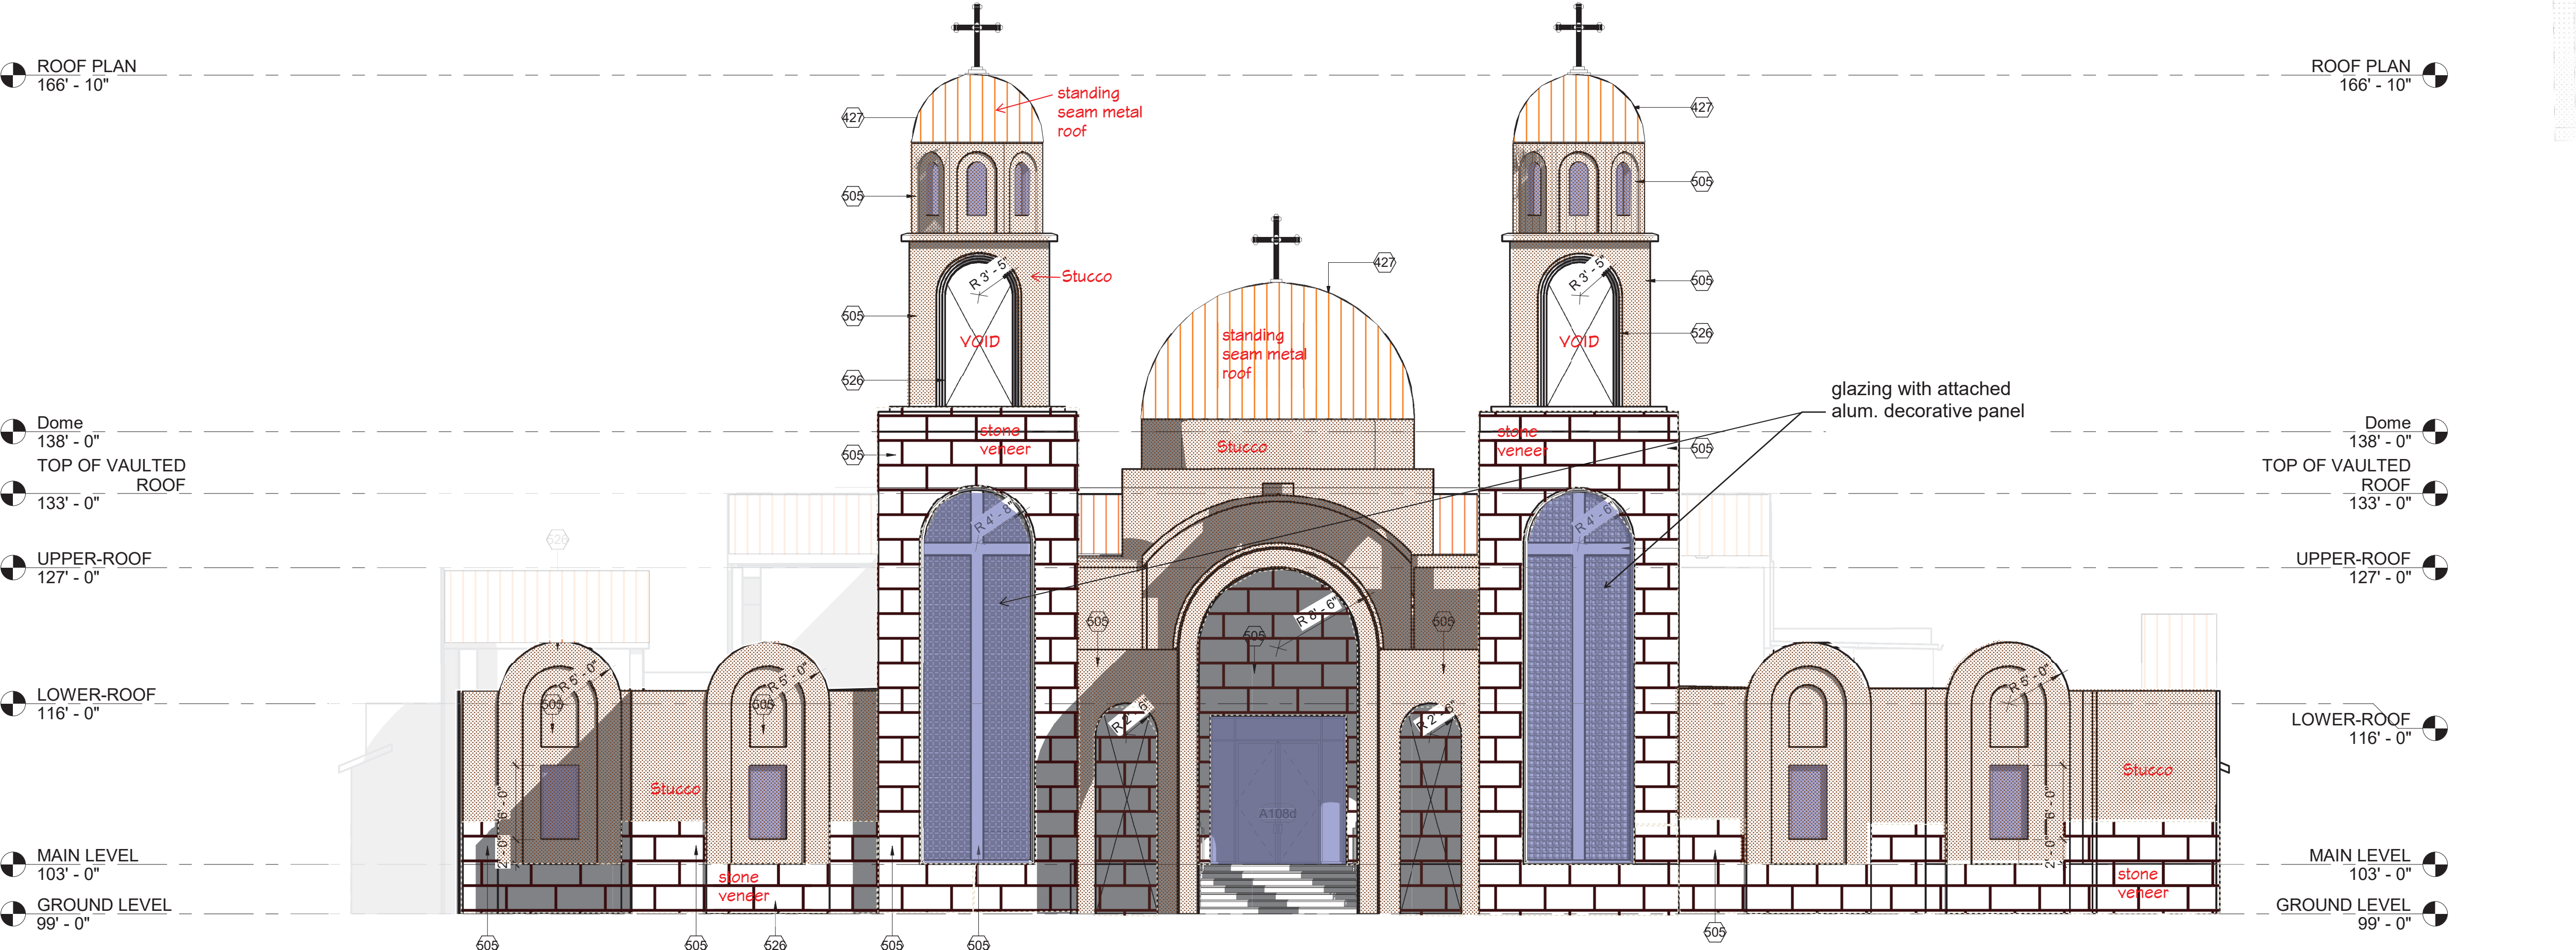


Total facade area = 4,447 sf = 100%
 Glazing area = 807 sf = 17%
 Stone veneer = 1,600 sf = 36%
 Stucco finish = 2,100 sf = 47%

2 SOUTH ELEVATION-PARKING ENTRANCE
1/8" = 1'-0"

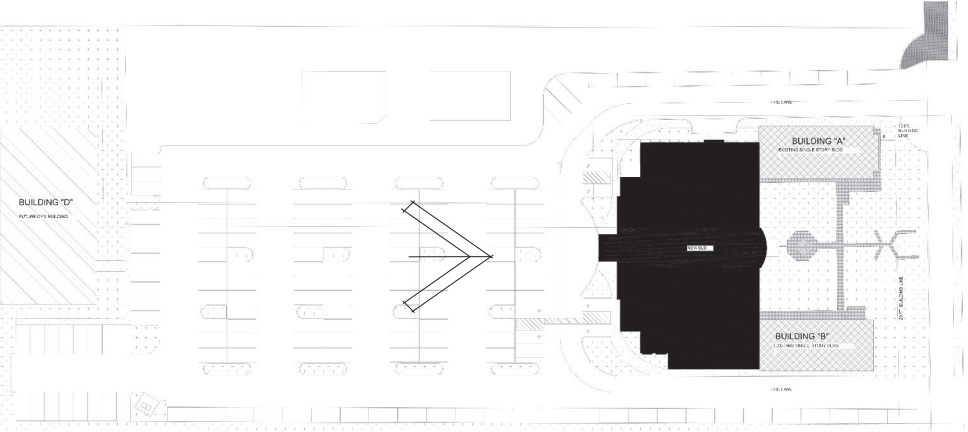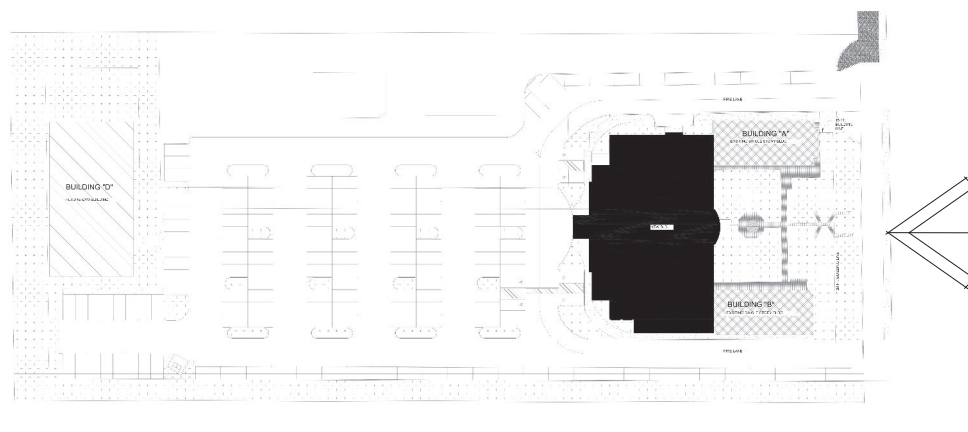

Exterior finish material

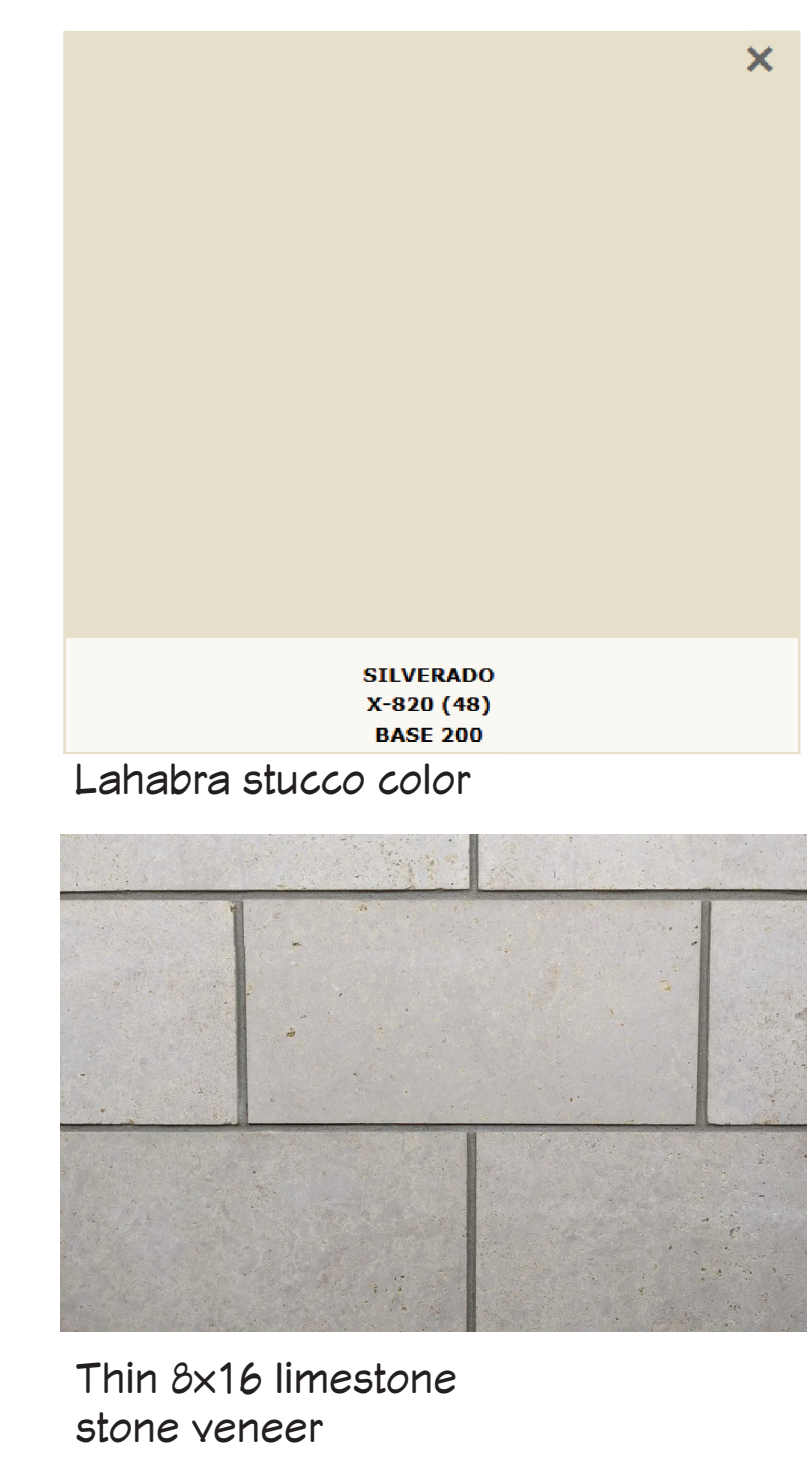

CAUTION: IF THIS PRINT IS NOT 30"X42" THEN IT IS A REDUCED PRINT













