

427 CMU WALL W/ STUCCO SMOOTH STUCCO FINISH.

CAUTION: IF THIS SHEET IS NOT 24"x36" IT IS A REDUCED PRINT

BRADEN P.

SS RO, 85212

ELEVATIONS EXTERIOR

PA/PM: A.MADRID DRAWN BY.: A.M. JOB NO.: PHX23-0173-00

| - | 0 | 0 | 4 | C |

CALCULATION PER MATERIAL DETAILS "A" PAINTED CMU BLOCK - DEC6123 - TRAIL DUST = 303 SF = 2.4% OF ELEVATION "A" PAINTED PEMB METAL PANEL - DEC6123 - TRAIL DUST = 1,656 SF = 13.2% OF ELEVATION "C" PAINTED CMU BLOCK - DE6105 - WEATHERED LEATHER = 45 SF = 0.4% OF ELEVATION "C" PAINTED METAL ROOF - DE6105 - WEATHERED LEATHER = 108 SF = 0.9% OF ELEVATION "C" PAINTED GUTTER & DRAIN SYSTEM - DE6105 - WEATHERED LEATHER = 83 SF = 0.7% OF ELEVATION "C" PAINTED PEMB TRIM - DE6105 - WEATHERED LEATHER = 32 SF = 0.2% OF ELEVATION "D" PAINTED CMU BLOCK - DEC718 - MESA TAN = 212 SF = 1.7% OF ELEVATION "D" PAINTED PEMB METAL PANEL - DEC718 - MESA TAN = 558 SF = 4.4% OF ELEVATION "E" PEMB METAL PANEL - MANUFACTURER WHITE FINISH= 8,496 SF = 67.6% OF ELEVATION GUTTER & DRAIN SYSTEM= 45 SF = 0.3% OF ELEVATION METAL ROOF= 162 SF= 1.3% OF ELEVATION CLERESTORY GLAZING= 64 SF= 0.5% OF ELEVATION OVERHEAD & MAN DOORS - MANUFACTURERS FINISH= 614 SF= 4.9% OF ELEVATION OVERHEAD & MAN DOORS - DEC718 - MESA TAN= 195 SF= 1.5% OF ELEVATION


TOTAL ELEVATION AREA = 12,573 SF

CALCULATION PER MATERIAL TYPES

CMU BLOCK TOTAL COMBINED= 560 SF= 4.5% OF ELEVATION PEMB TOTAL COMBINED= 10,742 SF= 85.4% OF ELEVATION METAL TOTAL COMBINED= 398 SF= 3.2% OF ELEVATION GLAZING TOTAL COMBINED= 64 SF= 0.5% OF ELEVATION


DOOR TOTAL COMBINED= 809 SF= 6.4% OF ELEVATION

TOTAL ELEVATION AREA = 12,573 SF

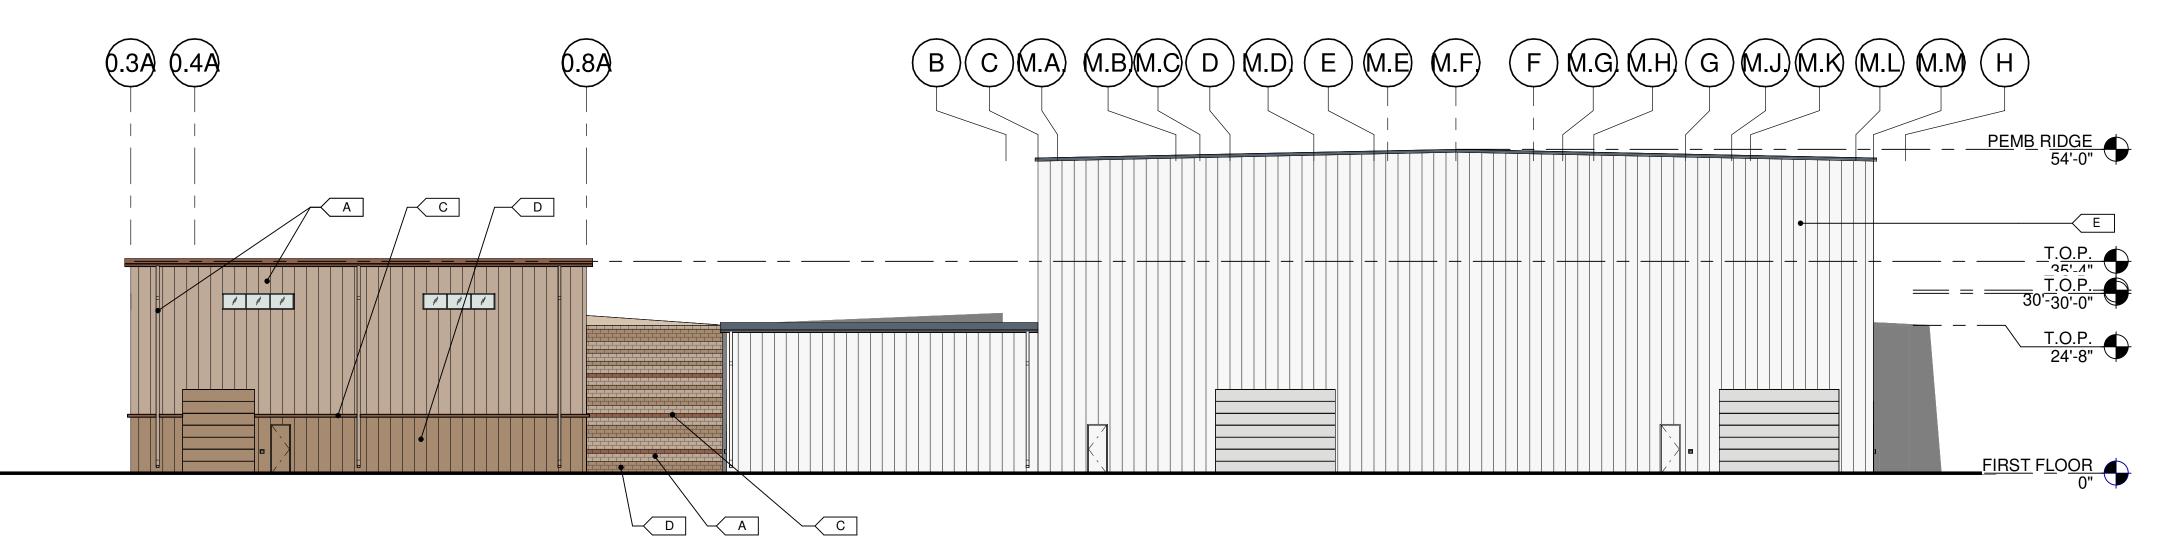

OVERALL SOUTH ELEVATION

SCALE: 1/16" = 1'-0"

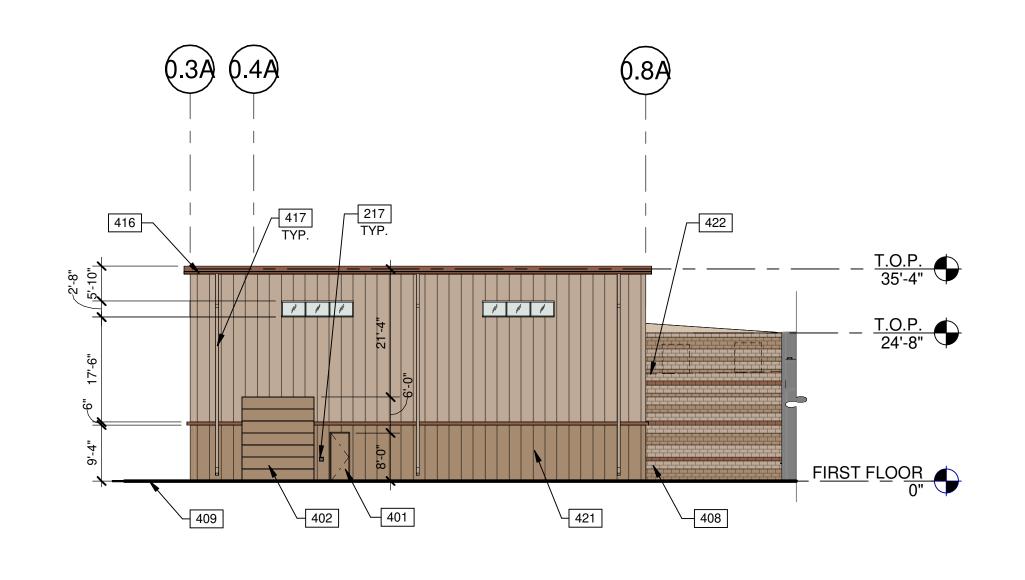

(M.A)(M.B)(M.C)(D)(M.D)(E)(M.E)(M.F)(F)(M.G)(M.H)(G)(M.J)401 217 TYP. 402 TYP. 412 TYP.

SOUTH ELEVATION - TRAINING CENTER SCALE: 1/16" = 1'-0" 64'

SOUTH ELEVATION - PEMB EXPANSION

**KEY PLAN** 

SCALE: 1/16" = 1'-0"

LEGEND

COLORS:

PROVIDE 6'-0" WIDE PAINT COLOR MOCK-UP FULL HEIGHT OF BUILDING FOR OWNER/ARCHITECT REVIEW.

ALL WALLS TO BE PAINTED WITH BASE COLOR U.O.N.

DUNN EDWARDS DE6123 - "TRAIL DUST" DUNN EDWARDS DEC747 - "SAHARA"

DUNN EDWARDS DE6105 - "WEATHERED LEATHER" DUNN EDWARDS DEC718 - "MESA TAN"

PEMB PANEL - MANUFACTURER'S WHITE FINISH

RUSTED PATINA METAL METAL LINTEL WITH 3" BOLT HEAD - DECORATIVE **GLASS**:

VISION GLASS: 1" INSULATING BRONZE REFLECTIVE OLDCASTLE - IGU OB: 1/4" PPG SOLARCOOL BRONZE REFLECTIVE #2 AS: 1/2" (AIR FILL) IB: 1/4" PPG SOLÁRBAN 60 ON CLEAR LOW-E #3 U-FACTOR SUMMER DAYTIME: 0.27

SPANDREL GLASS

TEMPERED GLASS

SOLAR HEAT GAIN COEFFICIENT (SHGC): 0.18

421 PAINTED PEMB.




217 SURFACE MOUNTED KNOX BOX LOCATION (REQ. AT ALL BUILDING EXIT DOORS, LOCATED ON DOOR STRIKE LEG SIDE).


401 HOLLOW METAL MAN DOOR. 402 OVERHEAD DOOR.

PAINTED CMU WALL. 409 FINISH GRADE VARIES.

412 METAL PANEL 26 GA EMBOSSED 'VEE-PANEL' OR EQUAL - BY PEMB.

416 DRAINGE GUTTER SYSTEM. 417 DRAIN LEADER.

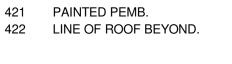

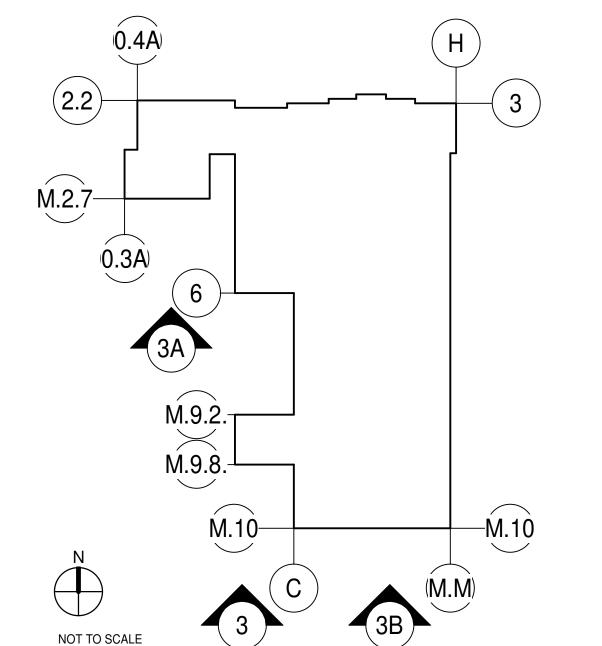



1/16"=1'-0"


0 8' 16'

32'

1 1 1

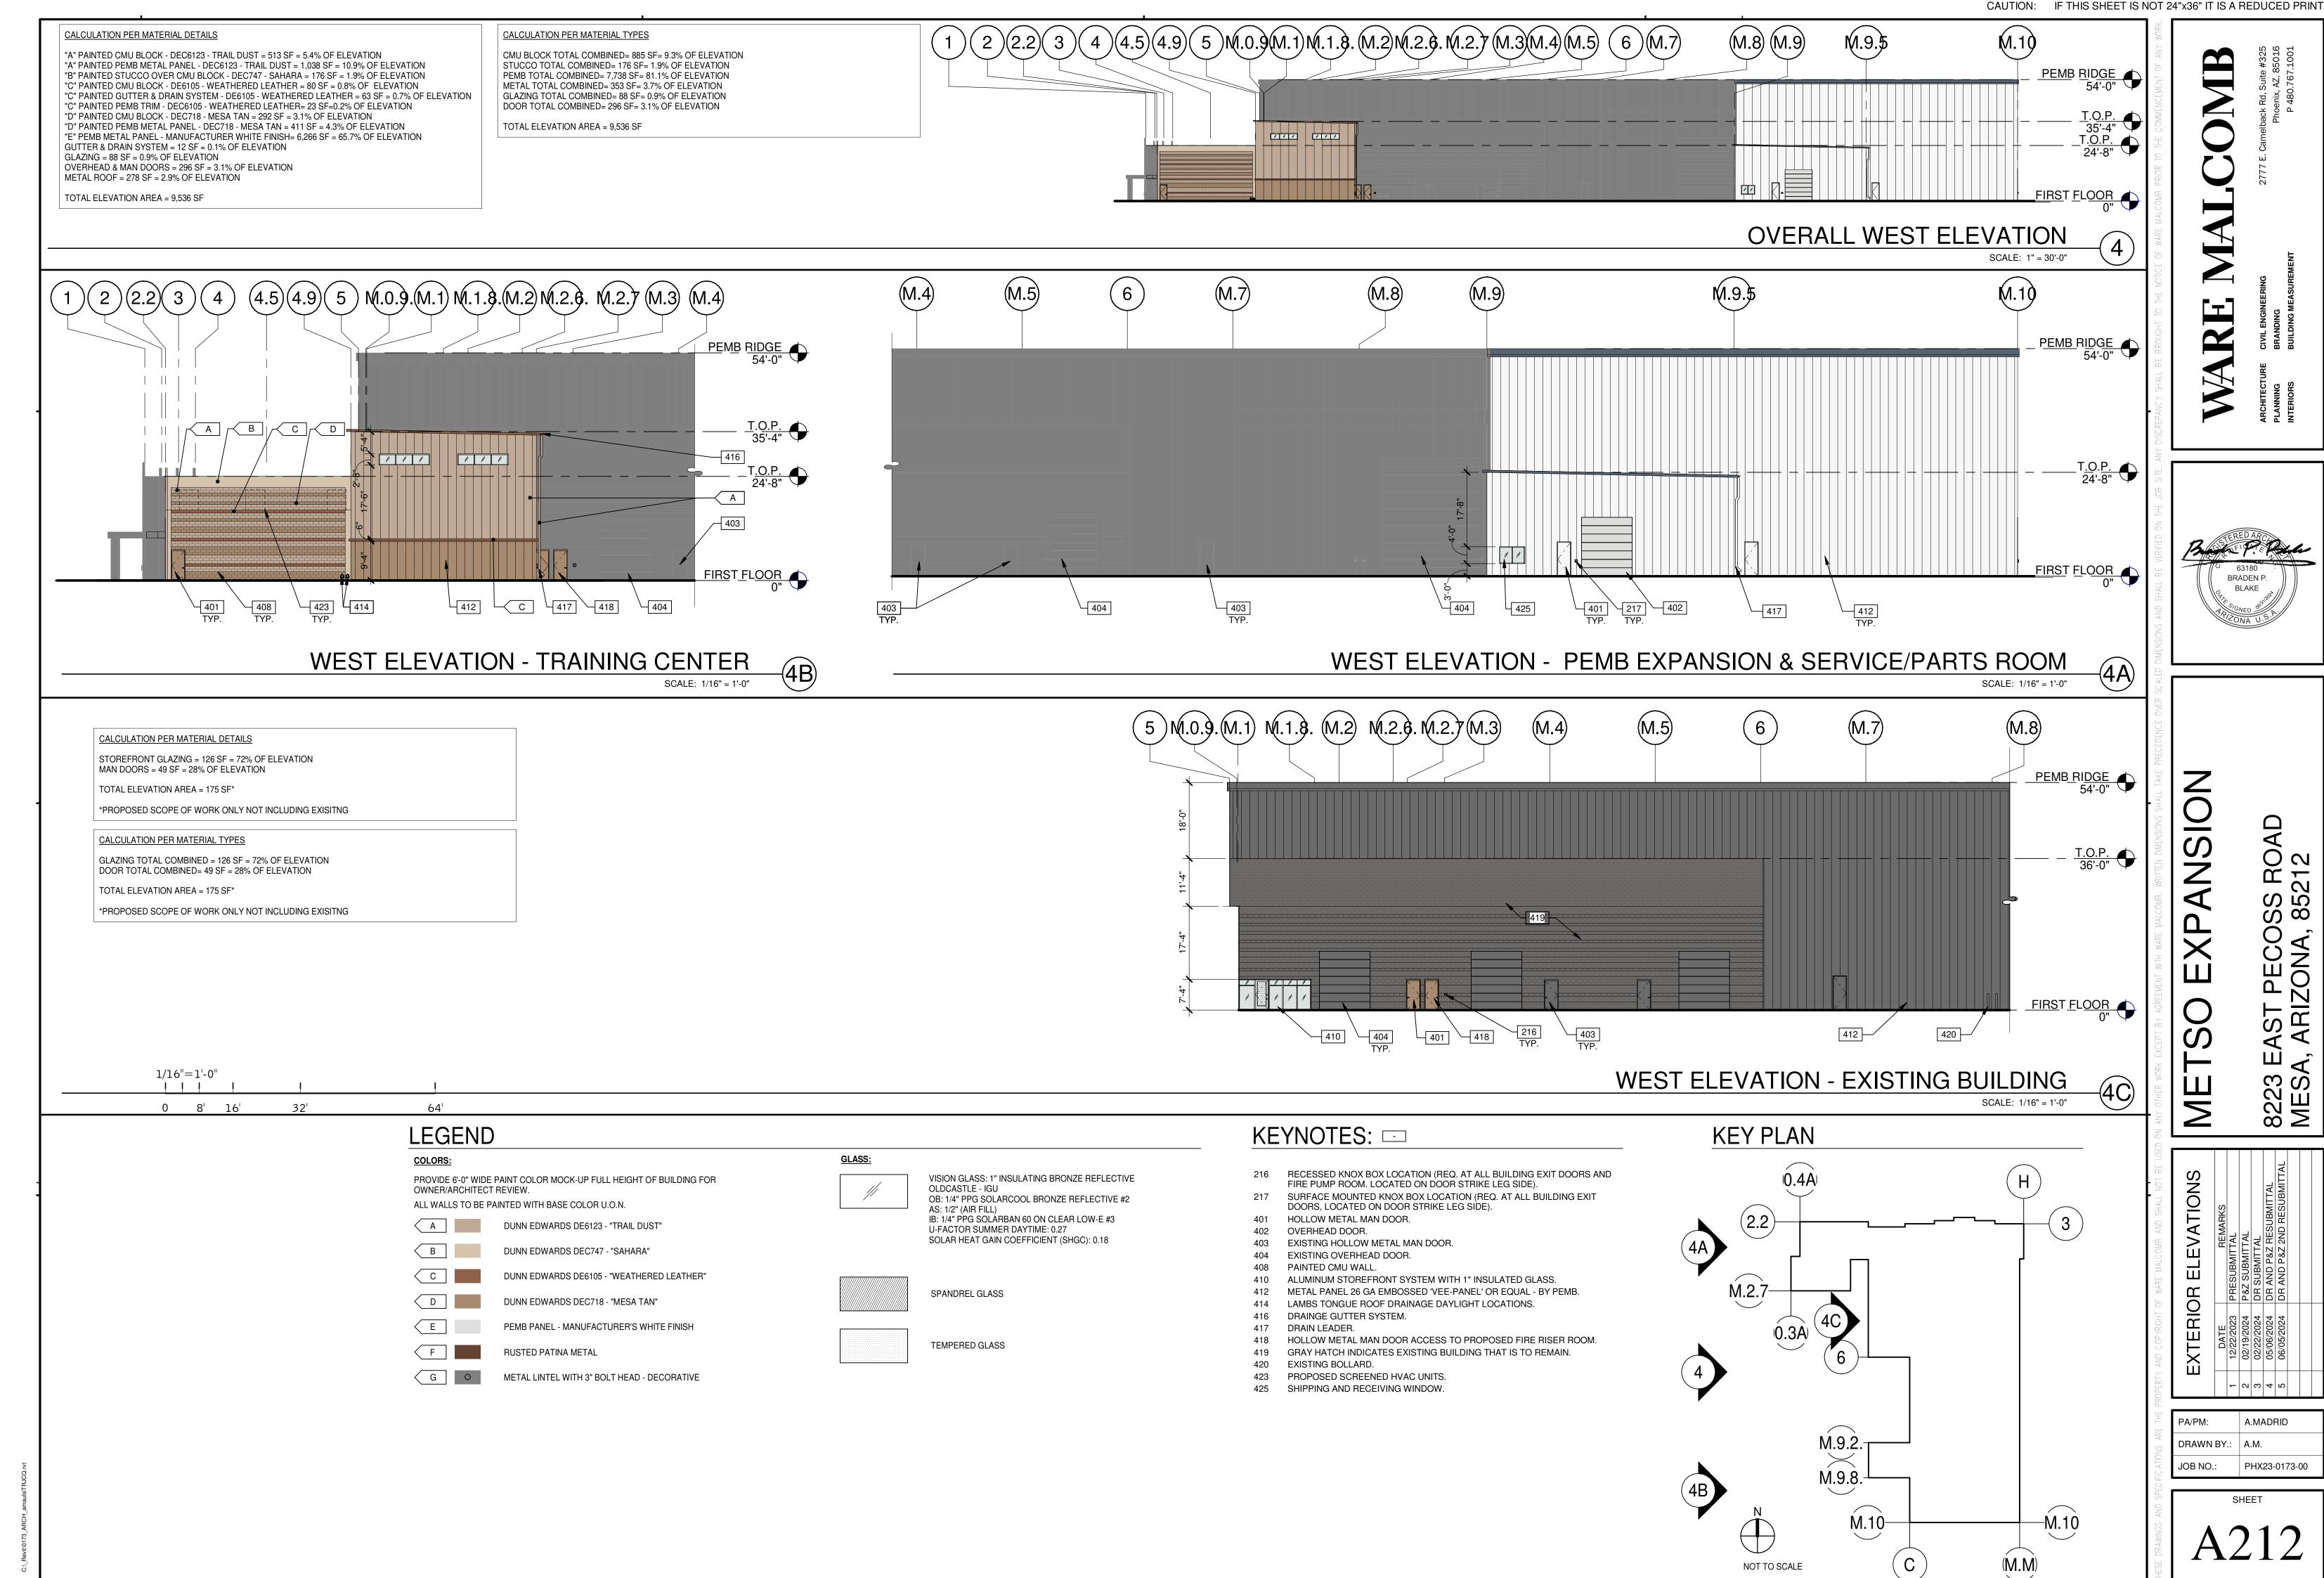

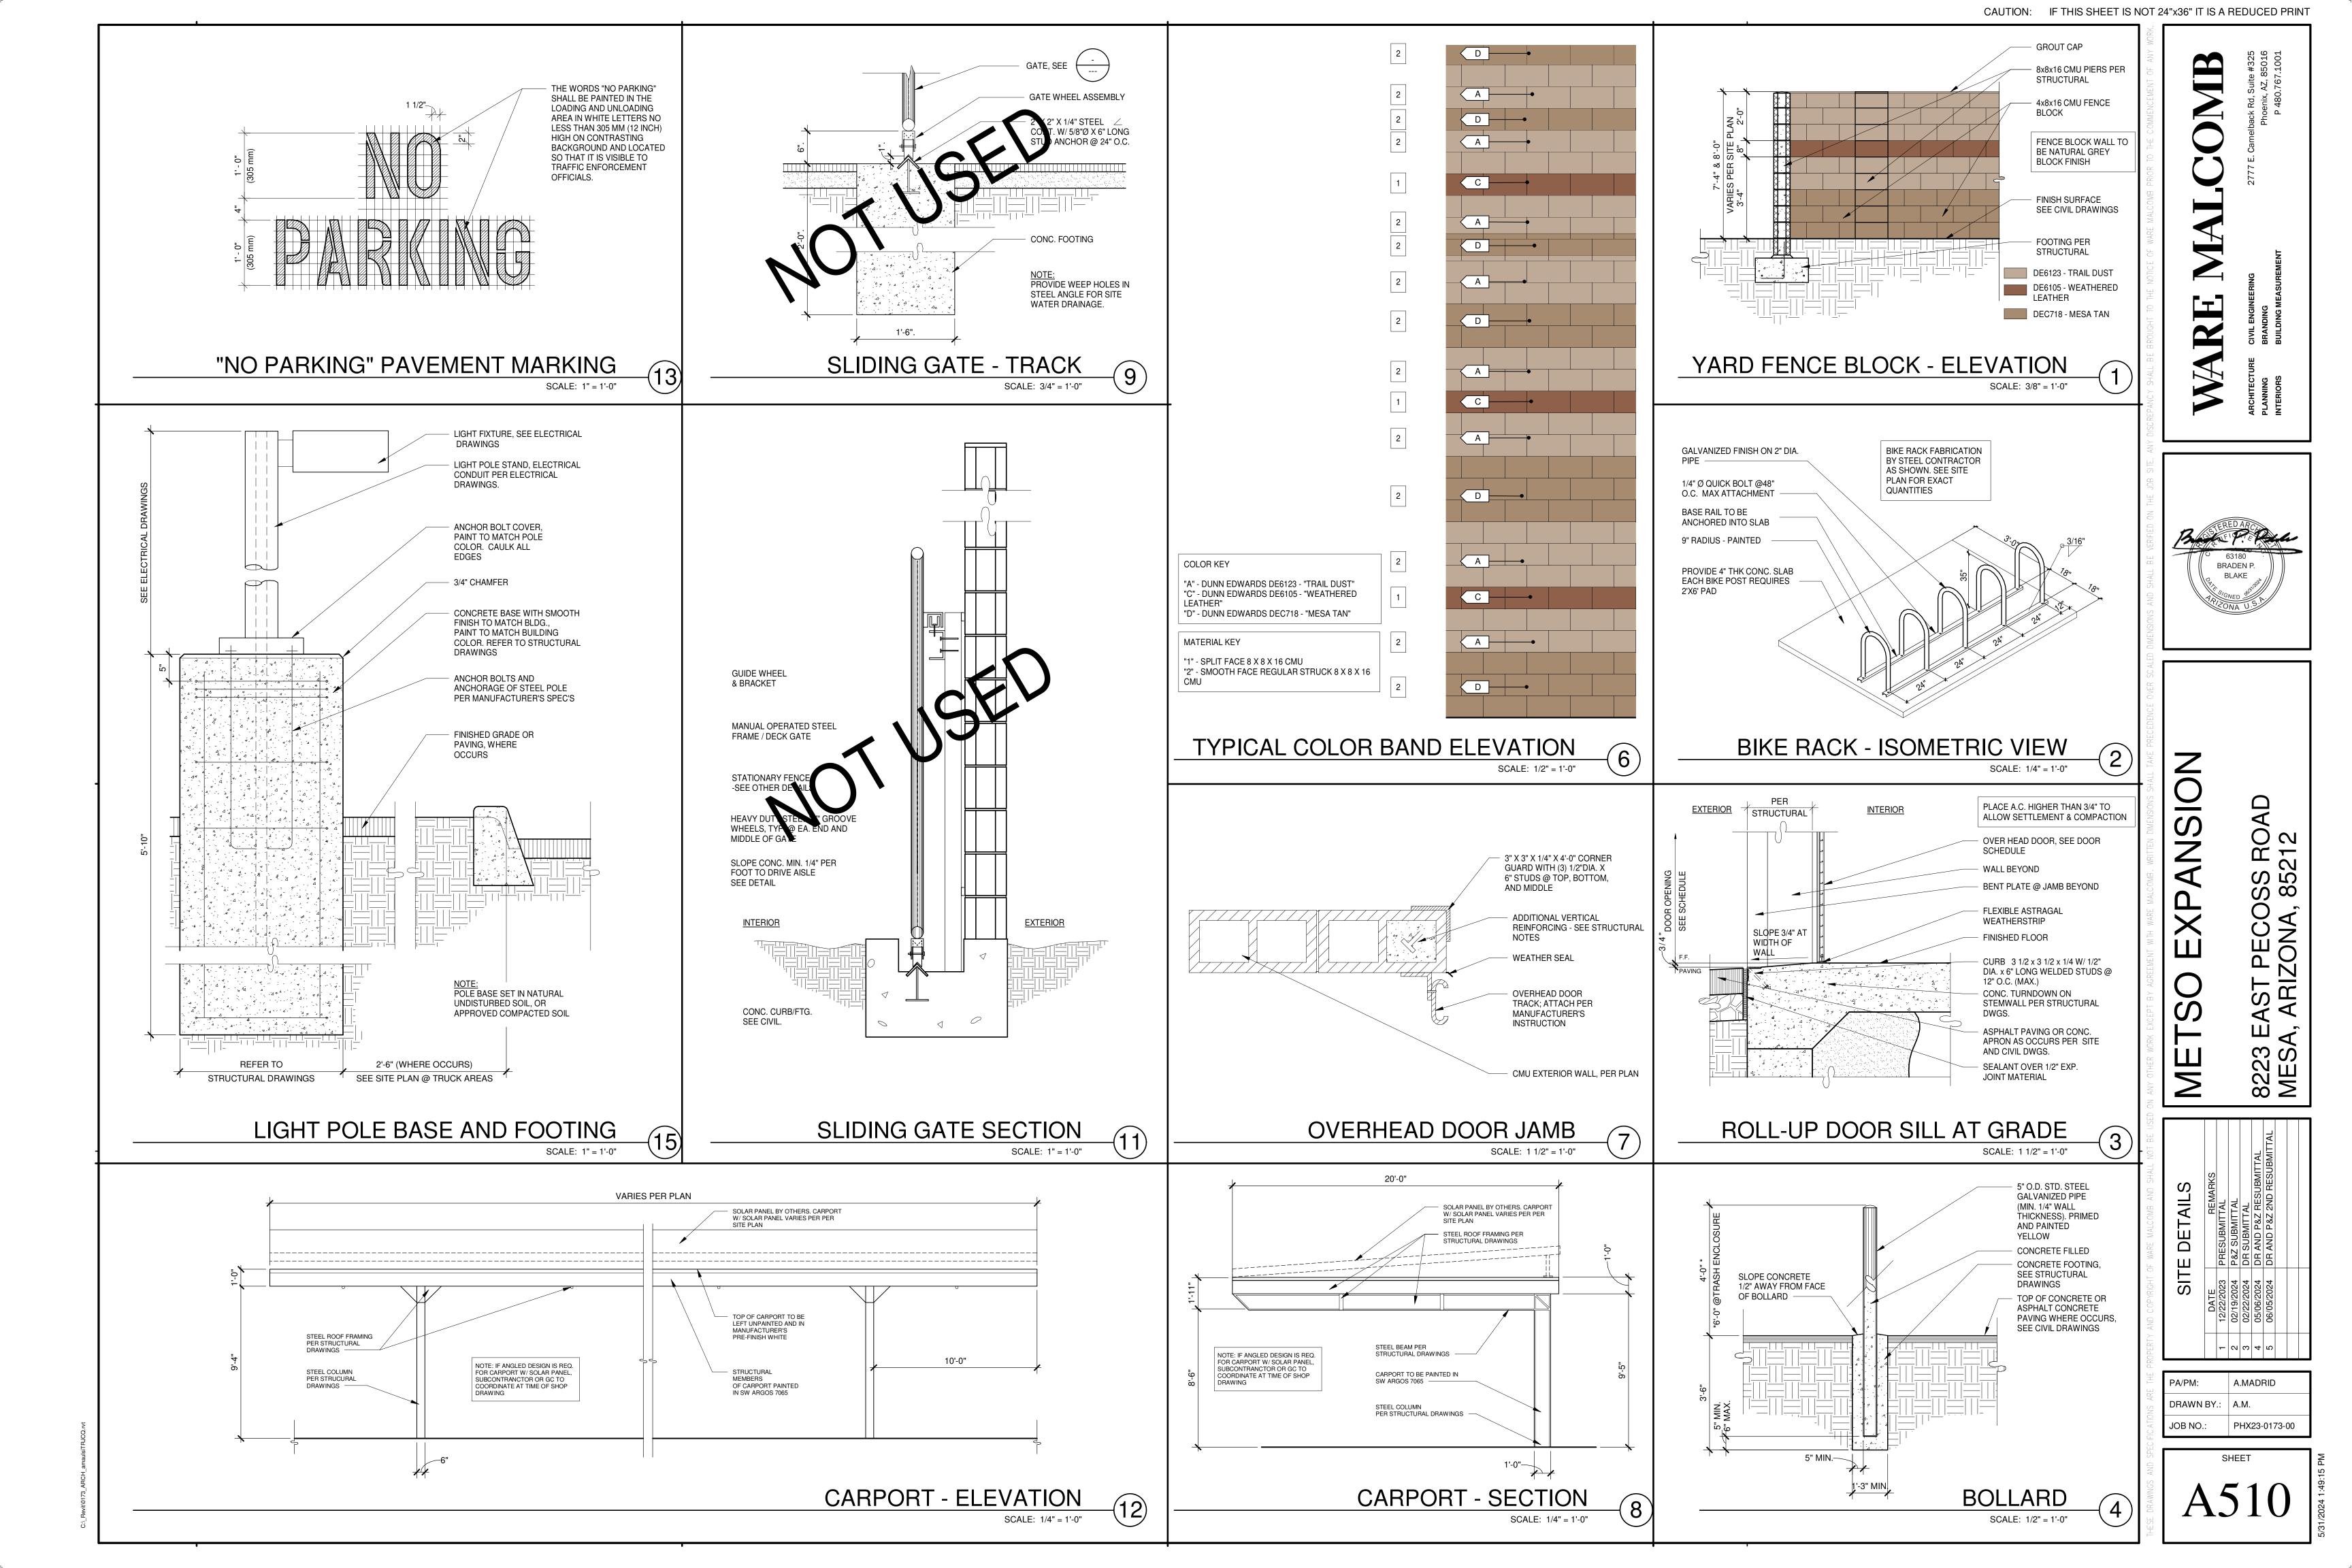

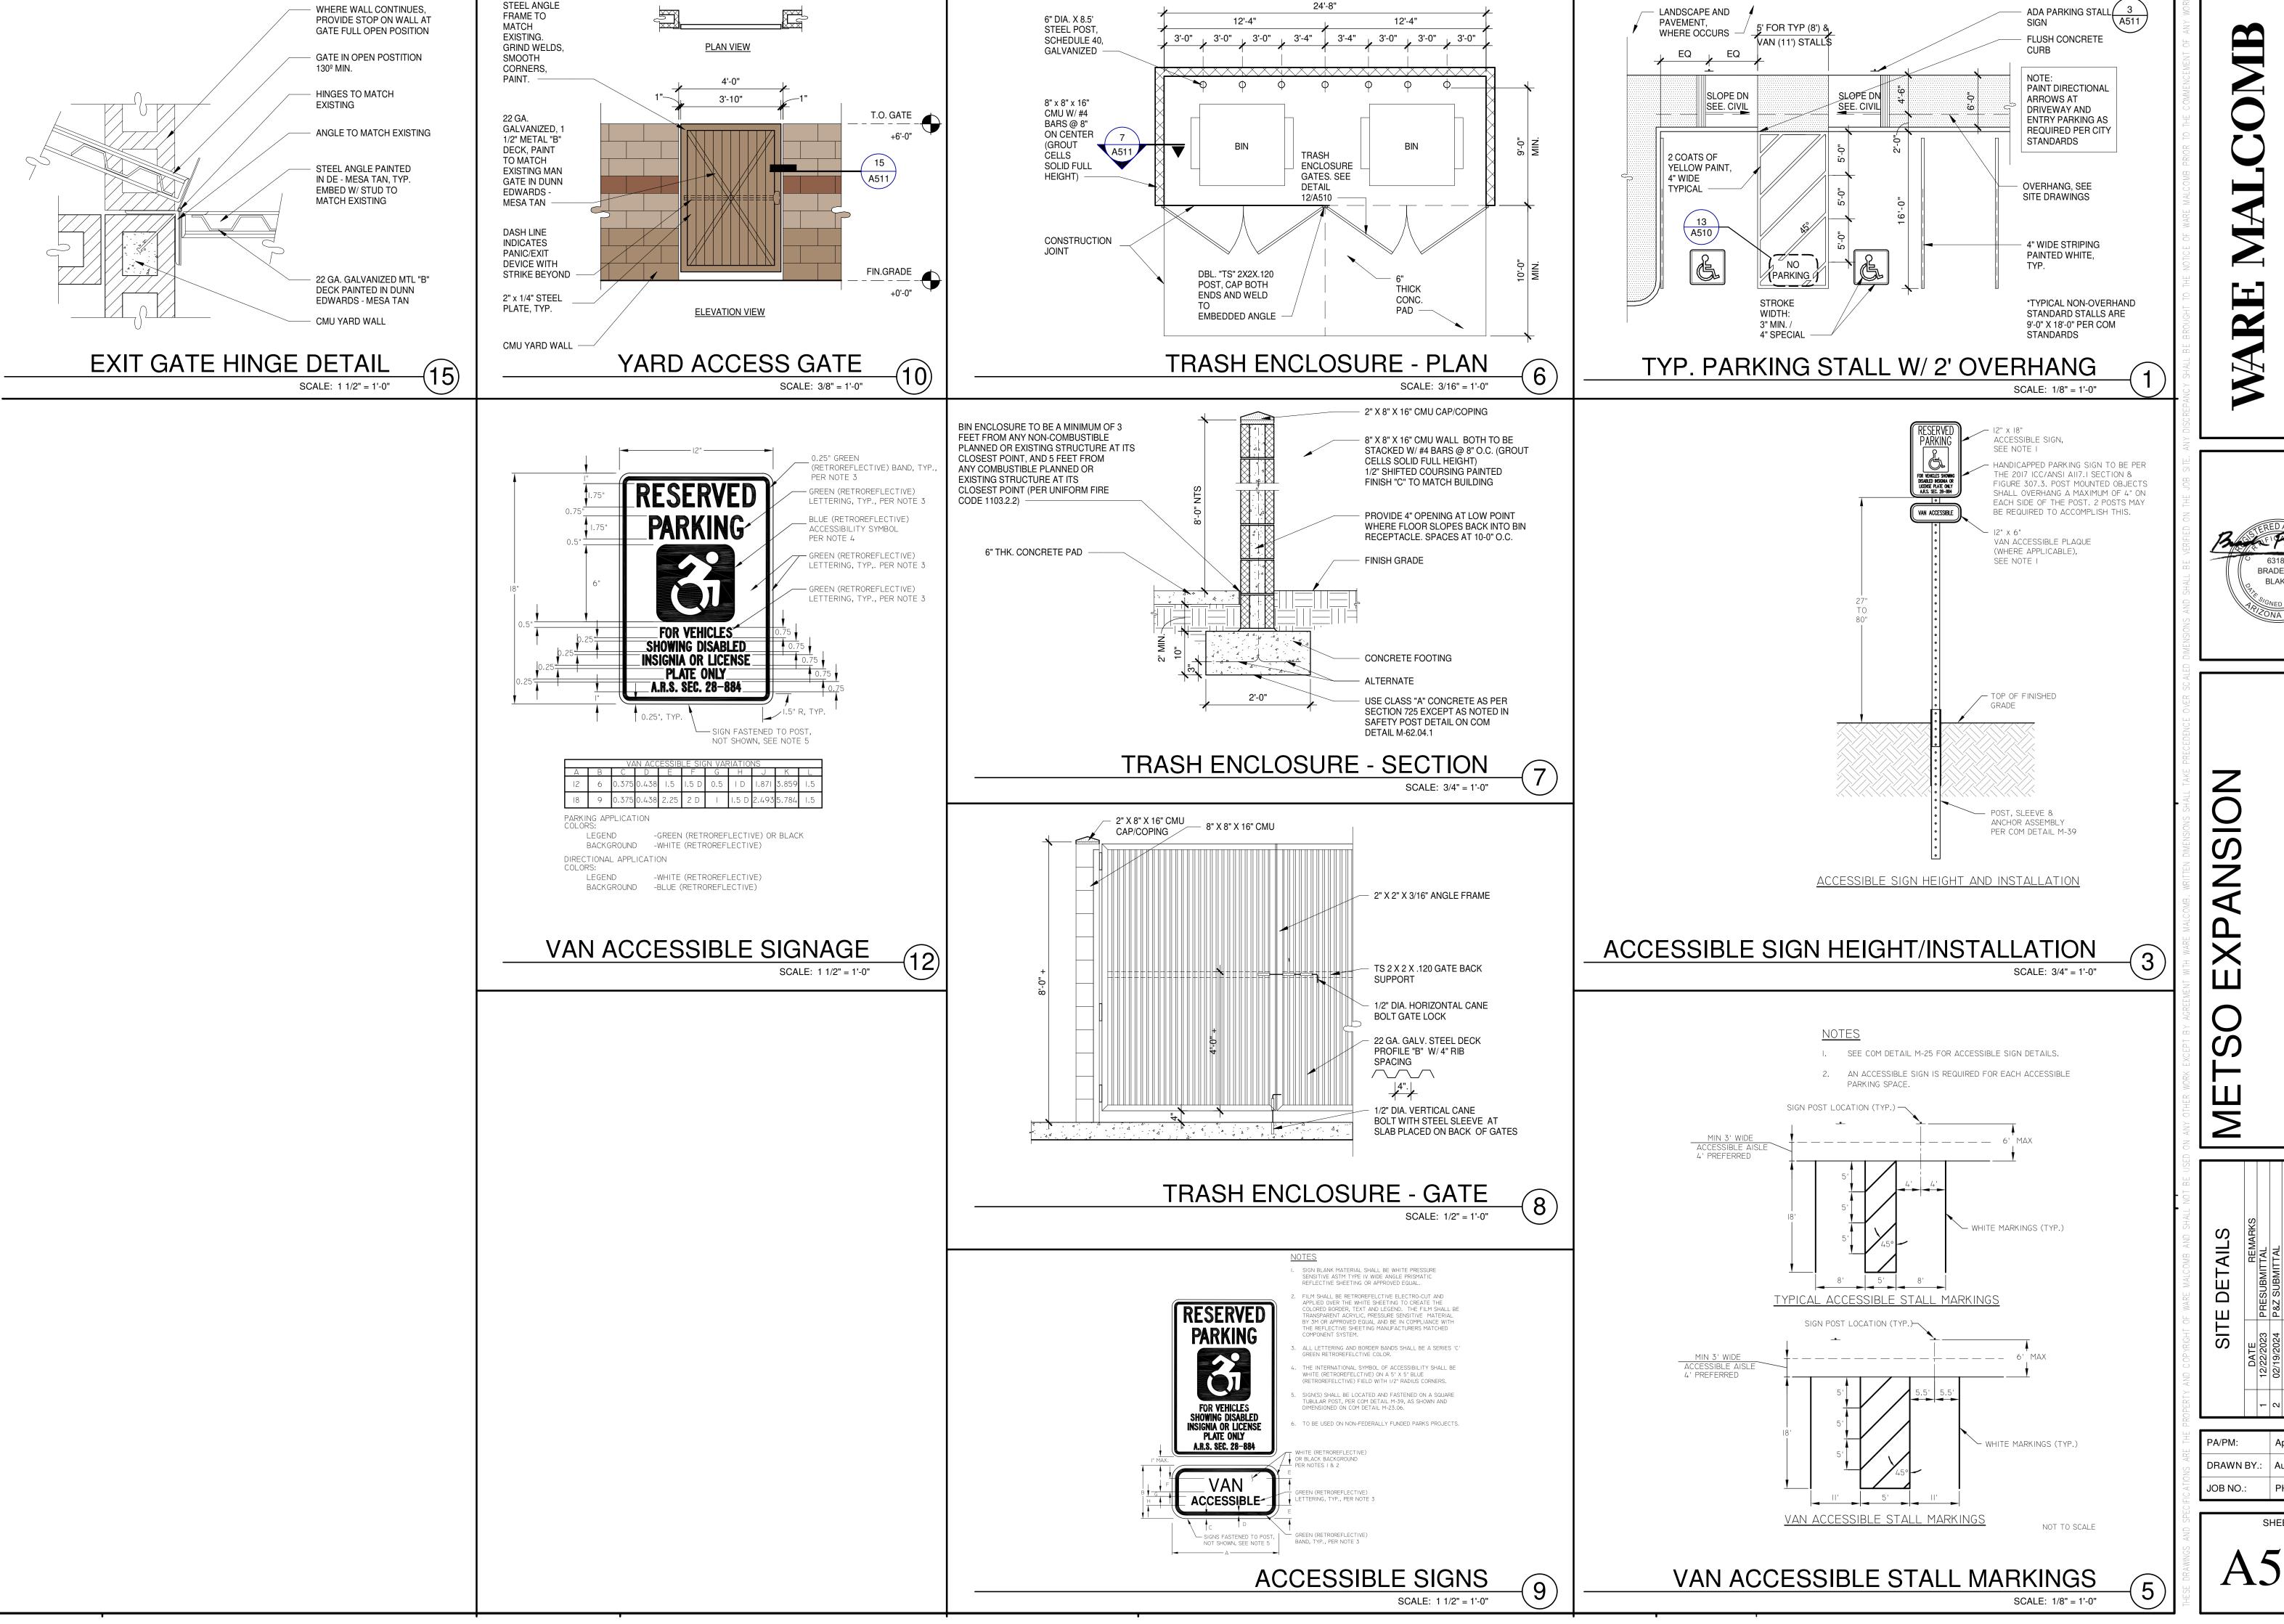

STEEL ANGLE

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BRADEN P.

0 0

- 2 c 4 c Approver DRAWN BY.: Author

PHX23-0173-00



# **METSO**

8223 EAST PECOS ROAD MESA, ARIZONA

CONCEPT RENDERINGS
PHX23-0173-00
05.06.2024

WARE MALCOMB



This conceptual design is based upon a preliminary review of entitlement requirements and on unverified and possibly incomplete site and/or building information, and is intended merely to assist in exploring how the project might be developed. Signage shown is for illustrative purposes only and does not necessarily reflect municipal code compliance. All colors shown are for representative purposes only. Refer to material samples for actual color verification.

NORTHWEST CORNER VIEW



This conceptual design is based upon a preliminary review of entitlement requirements and on unverified and possibly incomplete site and/or building information, and is intended merely to assist in exploring how the project might be developed. Signage shown is for illustrative purposes only and does not necessarily reflect municipal code compliance. All colors shown are for representative purposes only. Refer to material samples for actual color verification.

SOUTHWEST CORNER VIEW



This conceptual design is based upon a preliminary review of entitlement requirements and on unverified and possibly incomplete site and/or building information, and is intended merely to assist in exploring how the project might be developed. Signage shown is for illustrative purposes only and does not necessarily reflect municipal code compliance. All colors shown are for representative purposes only. Refer to material samples for actual color verification.

TRAINING AREA VIEW

**METSO** 

ARCHITECTURE

CIVIL ENGINEERING

PLANNING

BRANDING

**INTERIORS** 

**BUILDING MEASUREMENT** 


## **Metso Expansion - Elevation Material Calculation Breakdown**

Design Review Case#: DRB24-00175

Zoning Case#: ZON24-00137

Calculation breakdown tables can be found on elevation sheets A210 - A212 for more information. Please reference alternative compliance request in PAD Zoning narrative.

# Overall North Elevation - Training Center

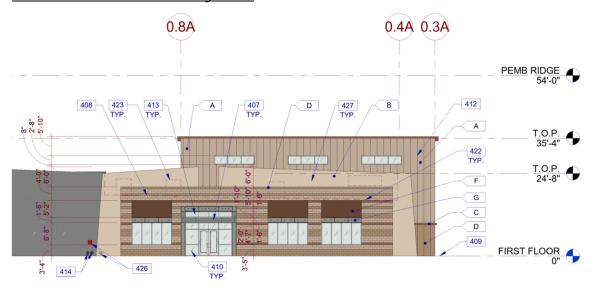

#### CALCULATION PER MATERIAL DETAILS

"A" PAINTED CMU BLOCK - DEC6123 - TRAIL DUST = 498 SF = 14.9% OF ELEVATION

"A" PAINTED PEMB METAL PANEL - DEC6123 - TRAIL DUST = 771 SF = 23% OF ELEVATION "B" PAINTED STUCCO OVER CMU BLOCK - DEC747 - SAHARA = 770 SF = 23% OF ELEVATION

"C" PAINTED CMU BLOCK - DE6105 - WEATHERED LEATHER = 62 SF = 1.9% OF ELEVATION

"C" PAINTED METAL ROOF - DE6105 - WEATHERED LEATHER = 41 SF = 1.2% OF ELEVATION "C" PAINTED PEMB TRIM - DE6105 - WEATHERED LEATHER = 3 SF = 0.1% OF ELEVATION

"D" PAINTED CMU BLOCK - DEC718 - MESA TAN = 328 SF = 9.8% OF ELEVATION

"D" PAINTED PEMB METAL PANEL - DEC718 - MESA TAN = 53 SF = 1.6% OF ELEVATION

"F" RUSTED PATINA METAL= 186 SF= 5.6% OF ELEVATION

"G" METAL LINTEL WITH DECORATIVE BOLTS= 109 SF= 3.3% OF ELEVATION

METAL CANOPY= 25 SF= 0.7% OF ELEVATION

STOREFRONT SYSTEM GLAZING= 404 SF= 12.1% OF ELEVATION

CLERESTORY GLAZING= 96 SF= 2.9% OF ELEVATION

TOTAL ELEVATION AREA = 3,346 SF

#### CALCULATION PER MATERIAL TYPES

CMU BLOCK TOTAL COMBINED= 888 SF= 26.5% OF ELEVATION PEMB TOTAL COMBINED= 827 SF= 24.7% OF ELEVATION METAL TOTAL COMBINED= 361 SF= 10.8% OF ELEVATION STUCCO TOTAL COMBINED= 770 SF= 23% OF ELEVATION GLAZING TOTAL COMBINED= 500 SF= 15% OF ELEVATION

TOTAL ELEVATION AREA = 3,346 SF

ARCHITECTURE

CIVIL ENGINEERING


PLANNING

**BRANDING** 

INTERIORS

**BUILDING MEASUREMENT** 

#### Overall East Elevation – PEMB Expansion

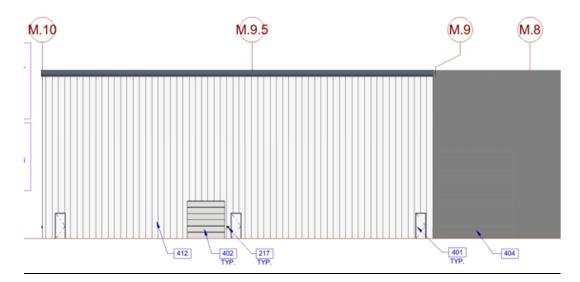

# CALCULATION PER MATERIAL DETAILS

"E" PEMB METAL PANEL - MANUFACTURER WHITE FINISH= 6,433 SF = 93.1% OF ELEVATION METAL ROOF= 248 SF = 3.6% OF ELEVATION OVERHEAD & MAN DOORS= 226 SF= 3.3% OF ELEVATION

TOTAL ELEVATION AREA = 6,907 SF

# CALCULATION PER MATERIAL TYPES

PEMB TOTAL COMBINED = 6,433 SF = 93.1% OF ELEVATION


METAL TOTAL COMBINED= 248 SF = 3.6% OF ELEVATION DOOR TOTAL COMBINED= 226= 3.3% OF ELEVATION

TOTAL ELEVATION AREA = 6,907 SF

ARCHITECTURE
PLANNING
INTERIORS

CIVIL ENGINEERING
BRANDING
BUILDING MEASUREMENT

## North Elevation - Service Parts Room

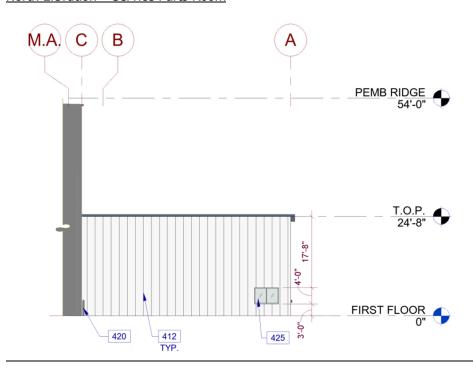

## CALCULATION PER MATERIAL DETAILS

"E" PEMB METAL PANEL - MANUFACTURER WHITE FINISH = 1,258 SF = 96% OF ELEVATION METAL ROOF= 29 SF = 2.2% OF ELEVATION GLAZING= 24 SF= 1.8% OF ELEVATION

TOTAL ELEVATION AREA = 1,311 SF

#### CALCULATION PER MATERIAL TYPES

PEMB TOTAL COMBINED = 1,258 SF = 96% OF ELEVATION METAL TOTAL COMBINED= 29 SF = 2.2% OF ELEVATION GLAZING TOTAL COMBINED= 24 SF= 1.8% OF ELEVATION

TOTAL ELEVATION AREA = 1,311 SF

ARCHITECTURE

CIVIL ENGINEERING


PLANNING

**BRANDING** 

INTERIORS

**BUILDING MEASUREMENT** 

#### East Elevation - PEMB Training Center

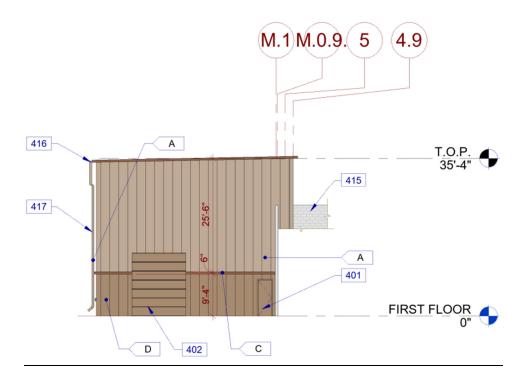

#### CALCULATION PER MATERIAL DETAILS

- "A" PAINTED PEMB METAL PANEL DEC6123 TRAIL DUST = 1,011 SF = 67.7% OF ELEVATION
- "C" PAINTED METAL ROOF DE6105 WEATHERED LEATHER = 23 SF = 1.5% OF ELEVATION
- "C" PAINTED PEMB TRIM DE6105 WEATHERED LEATHER = 14 SF = 0.9% OF ELEVATION
- "C" PAINTED GUTTER & DRAIN SYSTEM DE6105 WEATHERED LEATHER =17 SF = 1.1% OF ELEVATION
- "D" PAINTED PEMB METAL PANEL DEC718 MESA TAN = 234 SF = 15.7% OF ELEVATION OVERHEAD & MAN DOORS DEC718 MESA TAN= 195 SF= 13.1% OF ELEVATION

TOTAL ELEVATION AREA = 1,494 SF

## CALCULATION PER MATERIAL TYPES

PEMB TOTAL COMBINED = 1,259 SF = 84.3% OF ELEVATION METAL TOTAL COMBINED = 40 SF = 2.7% OF ELEVATION DOOR TOTAL COMBINED = 195 SF = 13.1% OF ELEVATION

TOTAL ELEVATION AREA = 1,494 SF

ARCHITECTURE

CIVIL ENGINEERING


PLANNING

**BRANDING** 

INTERIORS

**BUILDING MEASUREMENT** 

#### **Overall South Elevation**

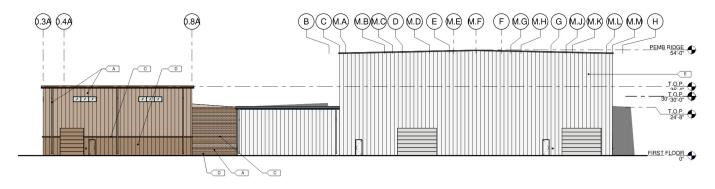

## CALCULATION PER MATERIAL DETAILS

"A" PAINTED CMU BLOCK - DEC6123 - TRAIL DUST = 303 SF = 2.4% OF ELEVATION

"A" PAINTED PEMB METAL PANEL - DEC6123 - TRAIL DUST = 1,656 SF = 13,2% OF ELEVATION

"C" PAINTED CMU BLOCK - DE6105 - WEATHERED LEATHER = 45 SF = 0.4% OF ELEVATION

"C" PAINTED METAL ROOF - DE6105 - WEATHERED LEATHER = 108 SF = 0.9% OF ELEVATION

"C" PAINTED GUTTER & DRAIN SYSTEM - DE6105 - WEATHERED LEATHER = 83 SF = 0.7% OF ELEVATION

"C" PAINTED PEMB TRIM - DE6105 - WEATHERED LEATHER = 32 SF = 0.2% OF ELEVATION

"D" PAINTED CMU BLOCK - DEC718 - MESA TAN = 212 SF = 1.7% OF ELEVATION

"D" PAINTED PEMB METAL PANEL - DEC718 - MESA TAN = 558 SF = 4.4% OF ELEVATION

"E" PEMB METAL PANEL - MANUFACTURER WHITE FINISH= 8,496 SF = 67.6% OF ELEVATION

GUTTER & DRAIN SYSTEM= 45 SF = 0.3% OF ELEVATION

METAL ROOF= 162 SF= 1.3% OF ELEVATION

CLERESTORY GLAZING= 64 SF= 0.5% OF ELEVATION

OVERHEAD & MAN DOORS - MANUFACTURERS FINISH= 614 SF= 4.9% OF ELEVATION

OVERHEAD & MAN DOORS - DEC718 - MESA TAN= 195 SF= 1.5% OF ELEVATION

TOTAL ELEVATION AREA = 12,573 SF

#### CALCULATION PER MATERIAL TYPES

CMU BLOCK TOTAL COMBINED= 560 SF= 4.5% OF ELEVATION PEMB TOTAL COMBINED= 10,742 SF= 85.4% OF ELEVATION METAL TOTAL COMBINED= 398 SF= 3.2% OF ELEVATION GLAZING TOTAL COMBINED= 64 SF= 0.5% OF ELEVATION DOOR TOTAL COMBINED= 809 SF= 6.4% OF ELEVATION

TOTAL ELEVATION AREA = 12,573 SF

ARCHITECTURE

CIVIL ENGINEERING


PLANNING

**BRANDING** 

INTERIORS

**BUILDING MEASUREMENT** 

#### Overall West Elevation – PEMB Expansion & Service and Parts Room

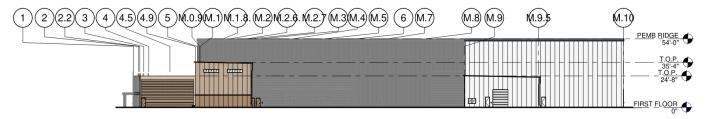

## CALCULATION PER MATERIAL DETAILS

"A" PAINTED CMU BLOCK - DEC6123 - TRAIL DUST = 513 SF = 5.4% OF ELEVATION

"A" PAINTED PEMB METAL PANEL - DEC6123 - TRAIL DUST = 1,038 SF = 10,9% OF ELEVATION

"B" PAINTED STUCCO OVER CMU BLOCK - DEC747 - SAHARA = 176 SF = 1.9% OF ELEVATION

"C" PAINTED CMU BLOCK - DE6105 - WEATHERED LEATHER = 80 SF = 0.8% OF ELEVATION

"C" PAINTED GUTTER & DRAIN SYSTEM - DE6105 - WEATHERED LEATHER = 63 SF = 0.7% OF ELEVATION

"C" PAINTED PEMB TRIM - DEC6105 - WEATHERED LEATHER= 23 SF=0.2% OF ELEVATION

"D" PAINTED CMU BLOCK - DEC718 - MESA TAN = 292 SF = 3.1% OF ELEVATION

"D" PAINTED PEMB METAL PANEL - DEC718 - MESA TAN = 411 SF = 4.3% OF ELEVATION

"E" PEMB METAL PANEL - MANUFACTURER WHITE FINISH= 6,266 SF = 65.7% OF ELEVATION

GUTTER & DRAIN SYSTEM = 12 SF = 0.1% OF ELEVATION

GLAZING = 88 SF = 0.9% OF ELEVATION

OVERHEAD & MAN DOORS = 296 SF = 3.1% OF ELEVATION

METAL ROOF = 278 SF = 2.9% OF ELEVATION

TOTAL ELEVATION AREA = 9,536 SF

#### CALCULATION PER MATERIAL TYPES

CMU BLOCK TOTAL COMBINED= 885 SF= 9.3% OF ELEVATION STUCCO TOTAL COMBINED= 176 SF= 1.9% OF ELEVATION PEMB TOTAL COMBINED= 7,738 SF= 81.1% OF ELEVATION METAL TOTAL COMBINED= 353 SF= 3.7% OF ELEVATION GLAZING TOTAL COMBINED= 88 SF= 0.9% OF ELEVATION DOOR TOTAL COMBINED= 296 SF= 3.1% OF ELEVATION

TOTAL ELEVATION AREA = 9,536 SF

ARCHITECTURE

CIVIL ENGINEERING


PLANNING

**BRANDING** 

INTERIORS

BUILDING MEASUREMENT

#### West Elevation - Existing Building

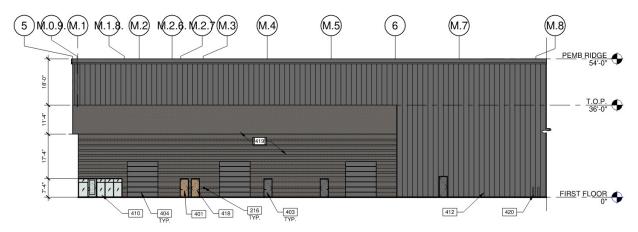

# CALCULATION PER MATERIAL DETAILS

STOREFRONT GLAZING = 126 SF = 72% OF ELEVATION MAN DOORS = 49 SF = 28% OF ELEVATION

TOTAL ELEVATION AREA = 175 SF\*

\*PROPOSED SCOPE OF WORK ONLY NOT INCLUDING EXISITNG

## CALCULATION PER MATERIAL TYPES

GLAZING TOTAL COMBINED = 126 SF = 72% OF ELEVATION DOOR TOTAL COMBINED = 49 SF = 28% OF ELEVATION

TOTAL ELEVATION AREA = 175 SF\*

\*PROPOSED SCOPE OF WORK ONLY NOT INCLUDING EXISITNG