# **CIVIL ENGINEER**

PHONE: 480-588-7226 EMAIL: ALI@AZSEG.COM

SUSTAINABILITY ENGINEERING GROUP 5240 N.16TH STREET, SUITE 105 PHOENIX, AZ 85016 ATTN: ALI FAKIH

## LANDSCAPE ARCHITECT:

DESIGN ETHIC 7525 E. 6TH AVE. SCOTTSDALE, ARIZONA 85251 ATTN: BRANDON T. PAUL

# PHONE: 480-225-7077

EMAIL: BPAUL@DESIGNETHIC.NET

### 1937 E SOUTHERN AVENUE, MESA, ARIZONA

#### SITE PLAN NOTES

- 1. DEVELOPMENT AND USE OF THIS SITE WILL CONFORM TO ALL APPLICABLE CODES AND ORDINANCES.
- 2. FIRE LANES SHALL BE ESTABLISHED AND PROPERLY DESIGNATED IN ACCORDANCE WITH THE LOCAL MUNICIPALITY AND LOCAL FIRE DEPARTMENT
- 3. ALL NEW OR RELOCATED UTILITIES WILL BE PLACED UNDERGROUND.
- 4. ALL ROOFTOP EQUIPMENT AND SATELLITE DISHES SHALL BE SCREENED TO THE HEIGHT OF THE TALLEST EQUIPMENT.
- 5. ALL SERVICE AREAS SHALL BE SCREENED TO CONCEAL TRASH CONTAINERS, LOADING DOCKS, TRANSFORMERS, BACKFLOW PREVENTERS AND OTHER MECHANICAL OR ELECTRICAL EQUIPMENT FROM EYE LEVEL ADJACENT TO ALL PUBLIC STREETS.
- 6. IF APPLICABLE, PEDESTRIAN ACCESS ROUTES ARE PROVIDED IN COMPLIANCE WITH THE LATEST ADA STANDARDS. ALL RAMPS MUST MEET ADA ACCESSIBILITY GUIDELINES (ADAAG) STANDARDS, 2% MAX CROSS SLOPES, AND 5% MAXIMUM LONGITUDINAL SLOPES. TRUNCATED DOMES, AS DETECTABLE WARNINGS, ARE REQUIRED, AS SHOWN IN PLANS, ON ALL SITE RAMPS AND WALKS THAT CROSS A VEHICULAR WAY PER ADAAG CHAPTER 7.
- . PIPE BOLLARDS SHALL BE INSTALLED IN TRAFFIC AND LOADING AREAS AS REQUIRED TO PROTECT BUILDING CORNERS, RECEIVING AREAS, HYDRANTS, TRANSFORMERS, METERS, GENERATORS, COMPACTORS, STEPS, AND RAILINGS, AS NECESSARY.
- 8. ALL SIGNAGE REQUIRES SEPARATE APPROVAL AND PERMITS.
- 9. A MINIMUM 6-FOOT HORIZONTAL SEPARATION BETWEEN WATER AND SEWER PIPELINES WILL BE MAINTAINED.
- 10. OWNERS OF PROPERTY ADJACENT TO THE PUBLIC RIGHT-OF-WAY WILL HAVE THE RESPONSIBILITY FOR MAINTAINING ALL LANDSCAPING WITHIN THE RIGHT-OF-WAY IN ACCORDANCE WITH APPROVED PLANS.

LOT AREA:		7,752	SE	0.18	۸۲
BUILDING FOOTPRINT:		3,136		0.10	AC
MAX. BUILDING HEIGHT:		30'	31		
PROPOSED BUILDING HEIGHT.	HT∙	1-Story			
MAX ALLOWED LOT COVERAGE		80%			
PROVIDED LOT COVERAGE		70%			
SETBACKS:	REQUIRED	7070			
FRONT (S ):	15'				
SIDE (W):	NONE				
SIDE (E):	NONE				
REAR (N):	NONE				
4' High wall along street					
frontage					
PICK UP WINDOW REQUIREMENTS		REQU	JIRED:		PROVIDED:
ENTRANCE TO PICK UP WINDOW		N/A		124'	
<b>PARKING REVIEW: 9.5'X18</b>	3' (90°)				
INDOOR FLOOR AREA:		3,136	SF	100	1 per 100 sf
MIN REQUIRED CAR PARKING:		32	SPACES	5	
MAX ALLOWED CAR PARK	ING:	32			
PROPOSED CAR			SPACES		
<b>PARKING: (WITH SHARED</b>		32			
PARKING AGREEMENT)					
PARKING AGREEMENT) REQUIRED BICYCLE		3			cle parking spaces
PARKING AGREEMENT)		3	at least	1	
PARKING AGREEMENT) REQUIRED BICYCLE PARKING SPACES		3	at least bicycle	1 space p	per 10 on-site vehic
PARKING AGREEMENT) REQUIRED BICYCLE PARKING SPACES PROVIDED BICYCLE		3	at least bicycle parking	1 space p	
PARKING AGREEMENT) REQUIRED BICYCLE PARKING SPACES			at least bicycle parking whiche	1 space p spaces ver is	cle parking spaces of per 10 on-site vehicles actually provided,
PARKING AGREEMENT) REQUIRED BICYCLE PARKING SPACES PROVIDED BICYCLE		3	at least bicycle parking	1 space p spaces ver is	per 10 on-site vehic

## PROPOSED LEGEND: — VERTICAL CURB MASONRY WALL. PARKING SPACE PER SHARED PARKING AGREEMENT PARKING COUNT PER SHARED PARKING AGREEMENT ---- SAWCUT LINE PROPOSED SIGN CONCRETE PAVEMENT HEAVY DUTY PAVEMENT PAVEMENT STRIPING -ACCESSIBLE PEDESTRIAN

PATH

35'/55' FIRE ACCESS


TURN RADIUS


# **EXISTING LEGEND:**

PROPERTY LINE

FIRE HYDRANT

# **CHIPOTLE** SITE PLAN

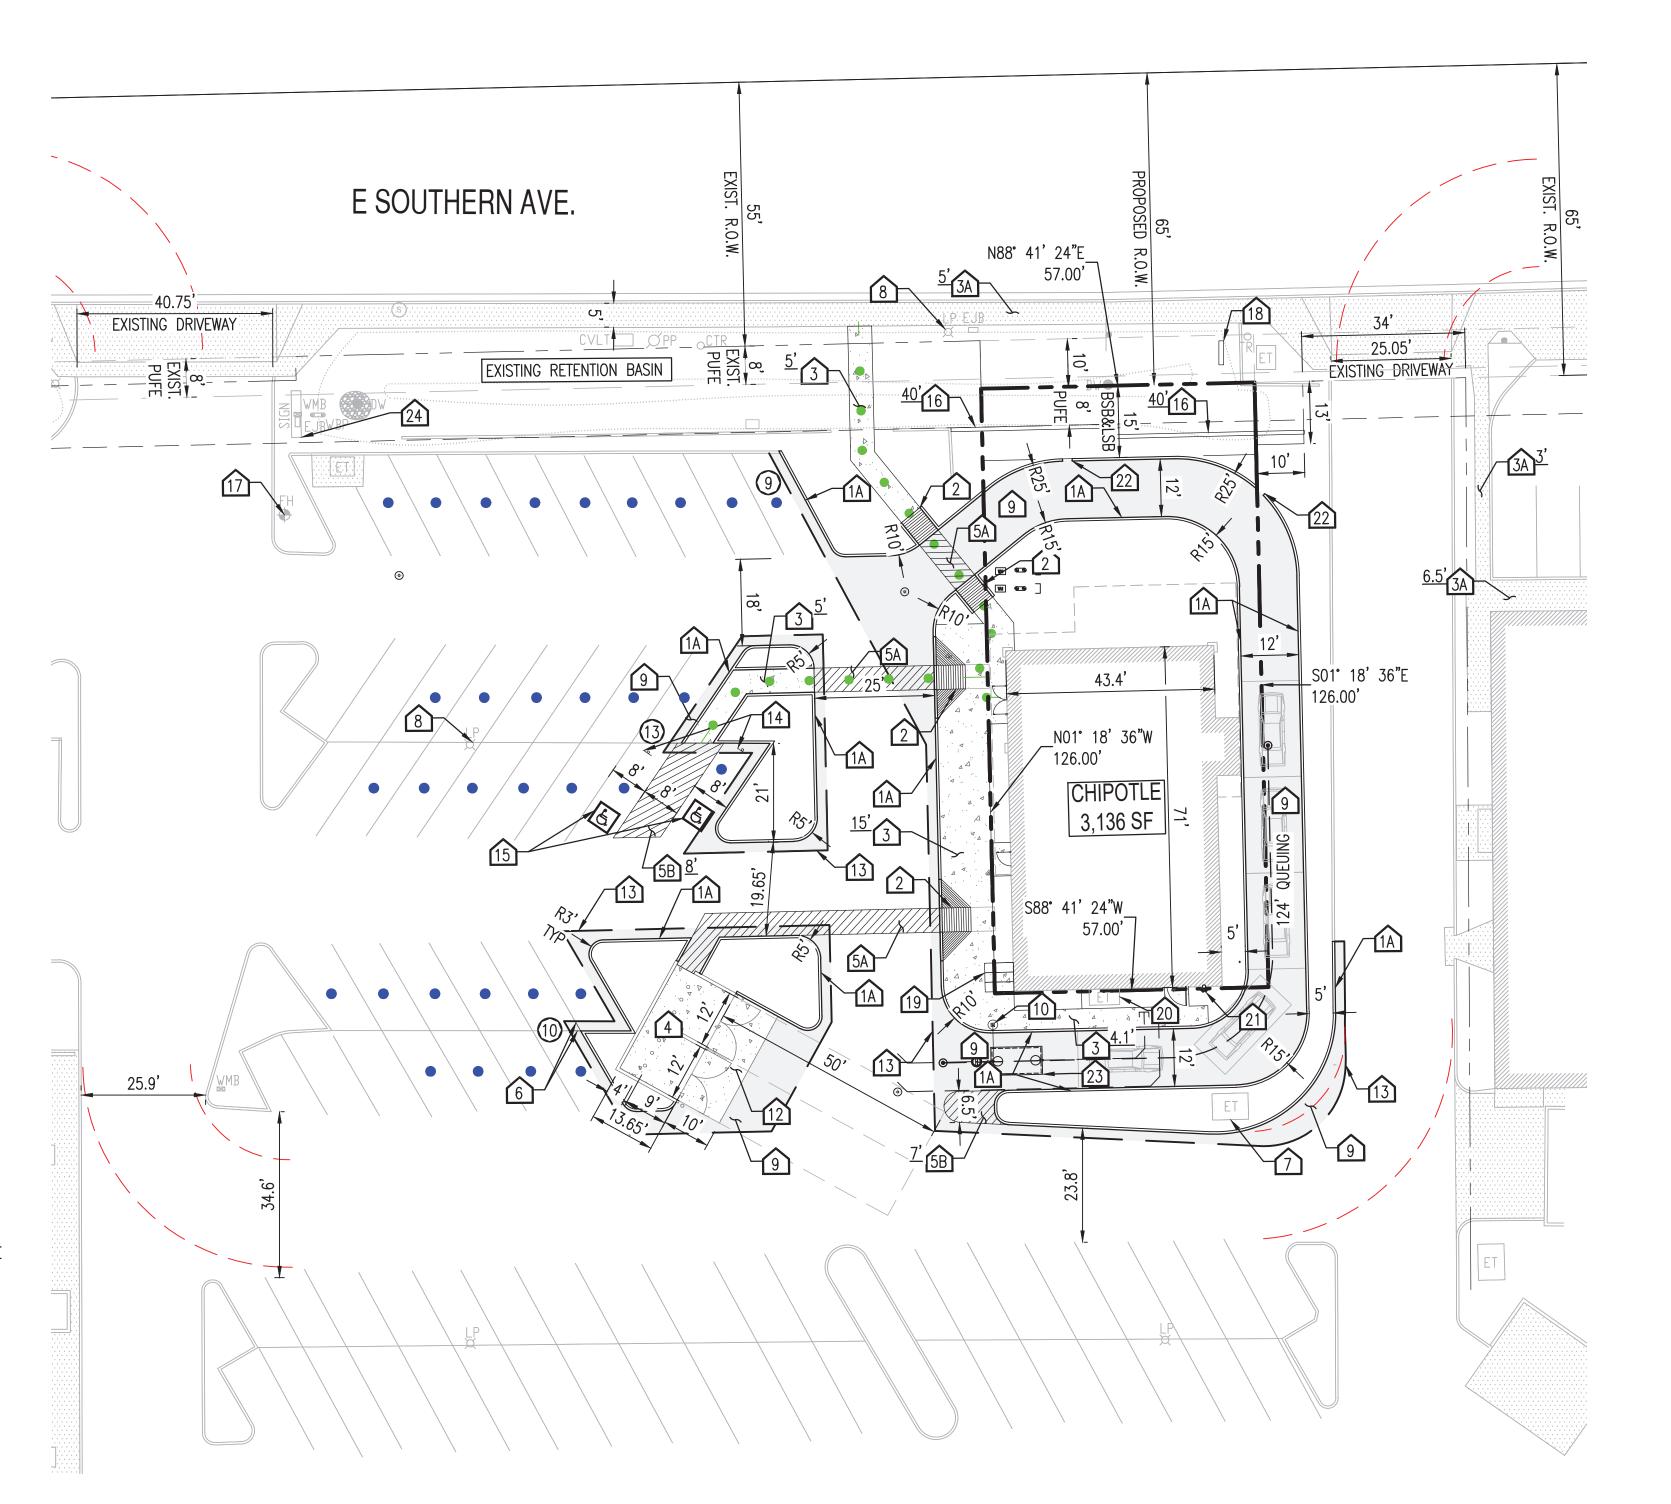

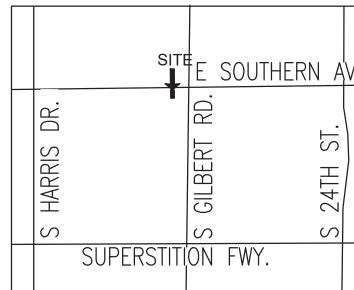




#### SITE PLAN KEYNOTES:


- 1A PROPOSED VERTICAL CURB.
- 2 PROPOSED ACCESSIBLE RAMP.
- 3 PROPOSED CONCRETE SIDEWALK PER MAG STD. DET.230, WIDTH PER PLAN.
- 3A EXISTING SIDEWALK, WIDTH PER PLAN.
- PROPOSED TRASH ENCLOSURE PER AHITECTURAL PLANS.
- 5A PROPOSED 5" PEDESTRIAN PATHWAY WITH 4" WIDE YELLOW PAINT, AT 45° 2 FEET O.C.
- PROPOSED STRIPED AREA WITH 4" WIDE YELLOW PAINT, AT 45° 2 FEET O.C., WIDTH PER PLAN.
- 6 PROPOSED 4" WIDE WHITE PAINTED STRIPING.
- EXISTING TRANSFORMER TO BE PROTECTED ON SITE.
- 8 EXISTING LIGHT POLE TO BE PROTECTED ON SITE.
- 9 PROPOSED HEAVY DUTY ASPHALT PAVEMENT.
- PROPOSED PICK-UP CLEARANCE BAR..
- PROPOSED CONCRETE RUNOUT PAD.
- PROPOSED SAWCUT LINE.
- PROPOSED ADA SIGN STALL PER DET. 3/C2.10
- PROPOSED ADA PAINTED SYMBOL OF ACCESSIBILITY PER DET. 5/C2.10.
- 16 PROPOSED 4' HIGH SCREEN WALL, LENGTH PER PLAN, PER DET. 1/C2.10.
- 17 EXISTING FIRE HYDRANT.
- PROPOSED SIGN MONUMENT LOCATION TO BE APPLIED FOR IN SEPARATE PERMIT.
- PROPOSED BIKE RACK PER DET. 4/C2.10.
- 20 EXISTING ELECTRICAL PANEL TO BE PROTECTED ON SITE.
- 21 PROPOSED FDC.

SITE PLAN

SCALE: 1" = 20'

- PROPOSED CURB OPENING PER GRADING AND DRAINAGE
- 23 PROPOSED GREASE INTERCEPTOR PER UTILITY PLANS.
- 24 EXISTING MONUMENT SIGN TO REMAIN.

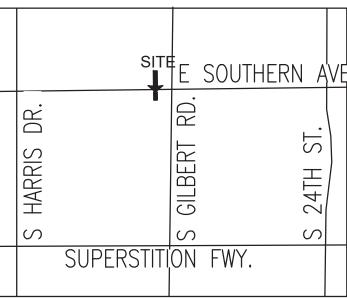

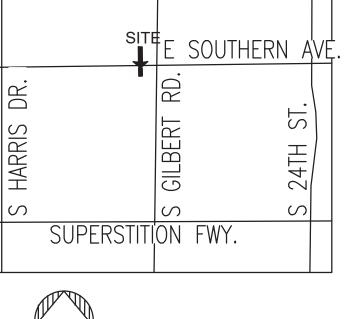



SUSTAINABILITY ENGINEERING GROUP

NOT FOR

CONSTRUCTION







PROJECT <b>CHIPOTLE</b>	LOCATION 1937 EAST SOU MESA, ARIZONA					
DRAWN	MA/GA 01/24/2024					
DESIGNED	GA 01/24/2024					
QC	AB 01/24/2024					
FINAL QC ———	CB 01/24/2024					
PROJ. MGR. ———	AF 01/24/2024					
DATE:						
01/24/2024						
ISSUED FOR:						

DESIGN REVIEW					
VISION NO.:	DATE:				
7					
7					
B NO:					


SITE PLAN

231012

1 OF 2

SHEET TITLE:

C2.00

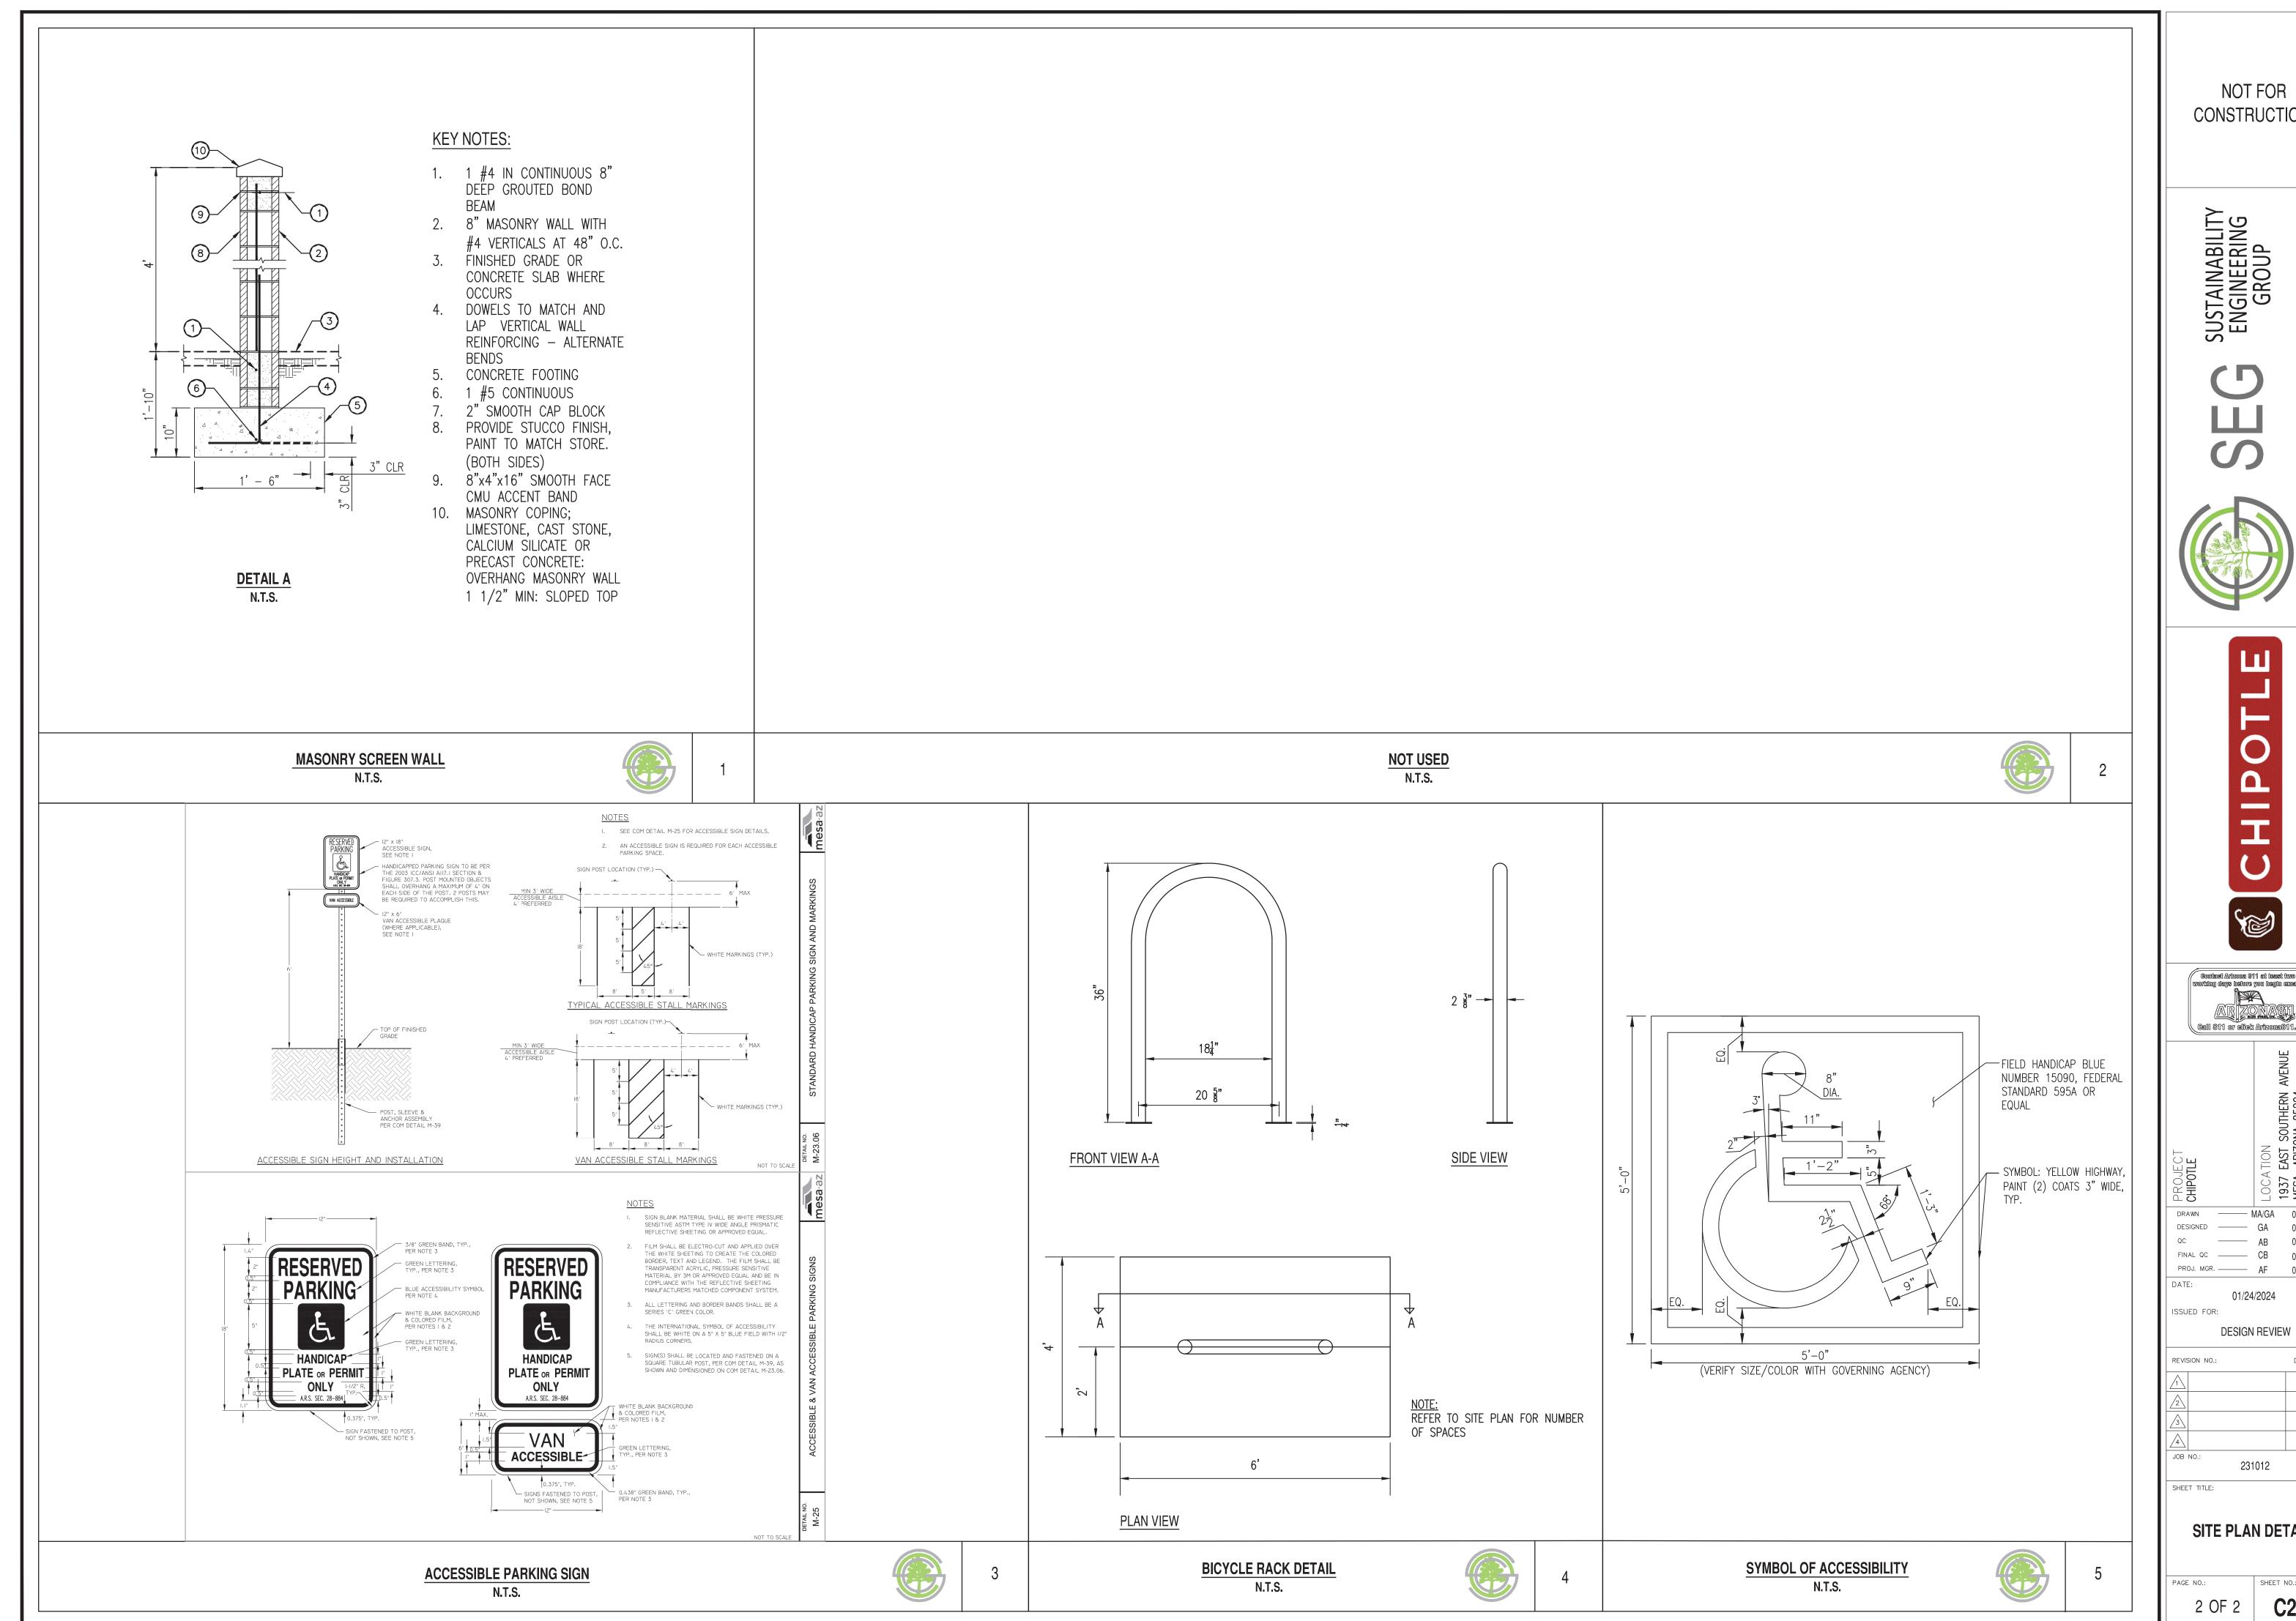

CONSTRUCTION



——— MA/GA 01/24/2024 GA 01/24/2024

AB 01/24/2024 FINAL QC ——— CB 01/24/2024 PROJ. MGR. — AF 01/24/2024

DATE:

SITE PLAN DETAILS