

# RSX1 LED Area Luminaire

















### Catalog SEE LIGHT FIXTURE SCHEDULE

Notes


Туре

P1, P2, P3

### Introduction

The new RSX LED Area family delivers maximum value by providing significant energy savings, long life and outstanding photometric performance at an affordable price. The RSX1 delivers 7,000 to 17,000 lumens allowing it to replace 70W to 400W HID luminaires.

The RSX features an integral universal mounting mechanism that allows the luminaire to be mounted on most existing drill hole patterns. This "no-drill" solution provides significant labor savings. An easy-access door on the bottom of mounting arm allows for wiring without opening the electrical compartment. A mast arm adaptor, adjustable integral slipfitter and other mounting configurations are available.

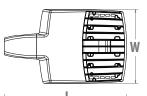




0.57 ft<sup>2</sup> (0.05 m<sup>2</sup>)

21.8" (55.4 cm)

13.3" (33.8 cm)

(SPA mount)

Height: 7.2" (18.4 cm) Arm Weight:

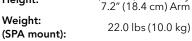





ds design select

Items marked by a shaded background qualify for the Design Select program and ship in 15 days or less. To learn more about Design Select, visit www.acuitybrands.com/designselect. \*See ordering tree for details



**Specifications** 

**EPA** 

(ft2@0°):

Length:

Width:

### **Ordering Information**

### **EXAMPLE:** RSX1 LED P4 40K R3 MVOLT SPA DDBXD

RSX1 LED	P3	30K	R2 Type 2 Wide R3 Type 3 Wide R3S Type 3 Short		MVOLT		SPA			
Series	Performance Package	Color Temperature	Distribut	ion	Voltage		Mounting			
RSX1 LED	P1 P2 P3 P4	30K 3000K 40K 4000K 50K 5000K	R3	Type 3 Wide	MVOLT HVOLT XVOLT (use specoptions: 120 <sup>3</sup> 208 <sup>3</sup> 240 <sup>3</sup>	(120V-277V) <sup>2</sup> (347V-480V) <sup>3</sup> (277V-480V) <sup>4</sup> cific voltage for as noted) 277 <sup>5</sup> 347 <sup>5</sup> 480 <sup>5</sup>	SPA RPA MA IS WBA WBASC AASP AARP AAWB	Square pole mounting (3.0" min. SQ pole for 1 at 90°, 3.5" min. SQ pole for 2, 3, 4 at 90°) Round pole mounting (3.2" min. dia. RND pole for 2, 3, 4 at 90°, 3.0" min. dia. RND pole for 1 at 90°, 2 at 180°, 3 at 120°) Mast arm adaptor (fits 2-3/8" 0D horizontal tenon) Adjustable slipfitter (fits 2-3/8" 0D tenon) 6 Wall bracket 1 Wall bracket with surface conduit box Adjustable tilt arm square pole mounting 6 Adjustable tilt arm with wall bracket 6 Adjustable tilt arm wall bracket and surface conduit box 6		

Options				Finish		
Shipped Installed		Shipped Installed			Dark Bronze	
HS	House-side shield <sup>7</sup>	*Stand	lalone and Networked Sensors/Controls (factory default settings, see table page 9)	DBLXD	Black	
PE	Photocontrol, button style 8,9	NLTAIR2	PIRHN nLight AIR generation 2, with Networked, Bi-Level motion/ambient sensor 9, 12, 13, 14	DNAXD	Natural Aluminum	
PER7	Seven-wire twist-lock receptacle only (no controls) 9,10,11	BAA	Buy America(n) Act and/or Build America Buy America Qualified	DWHXD	White	
SF	Single fuse (120, 277, 347) <sup>5</sup>	CCE	Coastal Construction <sup>15</sup>	DDBTXD	Textured Dark Bronze	
DF	Double fuse (208, 240, 480) 5	*Note: NLTAIR2 PIRHN with nLight Air can be used as a standalone or networked solution. Sensor coverage pattern is affected when luminaire is tilted.		DBLBXD	Textured Black	
SPD20KV	20KV Surge pack (10KV standard)			DNATXD	Textured Natural Aluminum	
FA0	Field adjustable output 9	Shippe	ed Separately (requires some field assembly)	DWHGXD	Textured White	
DMG	0-10V dimming extend out back of housing for external	EGS	External glare shield <sup>7</sup>			
	control (control ordered separate) 9	EGFV	External glare full visor (360° around light aperture) 7			
		BS	Bird spikes <sup>16</sup>			





## **WPX LED** Wall Packs












## **Specifications**

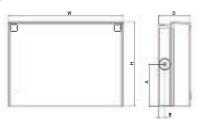

#### Front View

Side View

Luminaire	Height (H)	Width (W)	Depth (D)	Side Condu	Weight		
Lummaire	neight (n)	wiath (w)	νeptii (ν)	Α	В	weight	
WPX1	8.1" (20.6 cm)	11.1" (28.3 cm)	3.2" (8.1 cm)	4.0" (10.3 cm)	0.6" (1.6 cm)	6.1 lbs (2.8kg)	
WPX2	9.1" (23.1 cm)	12.3" (31.1 cm)	4.1" (10.5 cm)	4.5" (11.5 cm)	0.7" (1.7 cm)	8.2 lbs (3.7kg)	
WPX3	9.5" (24.1 cm)	13.0" (33.0 cm)	5.5" (13.7 cm)	4.7" (12.0 cm)	0.7" (1.7 cm)	11.0 lbs (5.0kg)	

Catalog Number	REFER TO LIGHT FIXTURE SCHEDULE
Notes	
Туре	W

#### Introduction

The WPX LED wall packs are energy-efficient, cost-effective, and aesthetically appealing solutions for both HID wall pack replacement and new construction opportunities. Available in three sizes, the WPX family delivers 1,550 to 9,200 lumens with a wide, uniform distribution.

The WPX full cut-off solutions fully cover the footprint of the HID glass wall packs that they replace, providing a neat installation and an upgraded appearance. Reliable IP66 construction and excellent LED lumen maintenance ensure a long service life. Photocell and emergency egress battery options make WPX ideal for every wall mounted lighting application.

### **Ordering Information**

### **EXAMPLE: WPX2 LED 40K MVOLT DDBXD**

WPX1LEDP1		30K	MVOLT				
Series		Color Temperature	Voltage	Options	Finish		
WPX1 LED P1 WPX1 LED P2 WPX2 LED WPX3 LED	1,550 Lumens, 11W <sup>1</sup> 2,900 Lumens, 24W 6,000 Lumens, 47W 9,200 Lumens, 69W	30K 3000K 40K 4000K 50K 5000K	MVOLT 120V - 277V 347 347V <sup>3</sup>	(blank) None  E4WH Emergency battery backup, CEC compliant (4W, 0°C min)²  E14WC Emergency battery backup, CEC compliant (14W, -20°C min)²  PE Photocell³	DDBXD Dark bronze DWHXD White DBLXD Black Note: For other options, consult factory.		

Note: The lumen output and input power shown in the ordering tree are average representations of all configuration options. Specific values are available on request.

#### NOTES

- All WPX wall packs come with 6kV surge protection standard, except WPX1 LED P1 package which comes with 2.5kV surge protection standard. Add SPD6KV option to get WPX1 LED P1 with 6kV surge protection. Sample nomenclature: WPX1 LED P1 40K MVOLT SPD6KV DDBXD
- 2. Battery pack options only available on WPX1 and WPX2.
- Battery pack options only available with 347V or PE options.

### **FEATURES & SPECIFICATIONS**

#### INTENDED USE

The WPX LED wall packs are designed to provide a cost-effective, energy-efficient solution for the one-for-one replacement of existing HID wall packs. The WPX1, WPX2 and WPX3 are ideal for replacing up to 150W, 250W, and 400W HID luminaires respectively. WPX luminaires deliver a uniform, wide distribution. WPX is rated for -40°C to 40°C.

#### CONSTRUCTION

WPX feature a die-cast aluminum main body with optimal thermal management that both enhances LED efficacy and extends component life. The luminaires are IP66 rated, and sealed against moisture or environmental contaminants.

#### **ELECTRICA**

Light engine(s) configurations consist of high-efficacy LEDs and LED lumen maintenance of L90/100,000 hours. Color temperature (CCT) options of 3000K, 4000K and 5000K with minimum CRI of 70. Electronic drivers ensure system power factor >90% and THD <20%. All luminaires have 6kV surge protection (Note: WPX1 LED P1 package comes with a standard surge protection rating of 2.5kV. It can be ordered with an optional 6kV surge protection). All photocell (PE) operate on MVOLT (120V - 277V) input.

Note: The standard WPX LED wall pack luminaires come with field-adjustable drive current feature. This feature allows tuning the output current of the LED drivers to adjust the lumen output (to dim the luminaire).

#### INSTALLATION

WPX can be mounted directly over a standard electrical junction box. Three 1/2 inch conduit ports on three sides allow for surface conduit wiring. A port on the back surface allows poke-through conduit wiring on surfaces that don't have an electrical junction box. Wiring can be made in the integral wiring compartment in all cases. WPX is only recommended for installations with LEDs facing downwards.

#### LISTINGS

CSA Certified to meet U.S. and Canadian standards. Suitable for wet locations. IP66 Rated. DesignLights Consortium® (DLC) qualified product. Not all versions of this product may be DLC qualified. Please check the DLC Qualified Products List at <a href="www.designlights.org/QPL">www.designlights.org/QPL</a> to confirm which versions are qualified. International Dark Sky Association (IDA) Fixture Seal of Approval (FSA) is available for all products on this page utilizing 3000K color temperature only.

#### WARRANTY

5-year limited warranty. This is the only warranty provided and no other statements in this specification sheet create any warranty of any kind. All other express and implied warranties are disclaimed. Complete warranty terms located at:

www.acuitybrands.com/CustomerResources/Terms and conditions.aspx.

**Note:** Actual performance may differ as a result of end-user environment and application. All values are design or typical values, measured under laboratory conditions at 25°C. Specifications subject to change without notice.



CALCULATION ZONE

AVERAGE MAXIMUM 0.8FC 8.7FC MINIMUM MAX/MIN AVR./MIN N/A N/A

LIGHT FIXTURE SCHEDULE										
MRK	MOUNT	MFR	CATALOG NUMBER NO	LAMPS D. TYPE	REMARKS	INP W	UT VA	VOI		
P1	PEND	LITHONIA	- RSX1 LED P3 30K R3 MVOLT- -	15000LUMENS 109W LED 3000°K	POLE LIGHT @ 22'-6" FULLY SHIELDED -	109	120	12		
P2	PEND	LITHONIA	- RSX1 LED P2 30K R4 MVOLT- -	7090LUMENS 72W LED 3000°K	POLE LIGHT @ 22'-6" FULLY SHIELDED -	73	80	12		
Р3	PEND	LITHONIA	- RSX1 LED P3 30K R5 MVOLT-	15000LUMENS 109W LED 3000°K	POLE LIGHT @ 22'-6" FULLY SHIELDED -	109	120	12		
W	WB	LITHONIA	- WPX1 LED P2 30K MVOLT -	2749LUMENS 23W LED 3000°K	FULLY SHIELDED WALL SCONCE MTD. @ 12'-0"	23	25	12		

1. VERIFY FINISHES/COLOR OF LIGHT FIXTURES WITH ARCHITECT. COMPLY WITH ARCHITECT'S FINISHES/ COLOR SELECTIONS.

ISSUE INFORMATION **Building Design** 

**BRAMIC DESIGN GROUP** 

10820 E CALLE LINDA VISTA

COPYRIGHT. BRAMIC DESIGN GROUP PLLC

TUCSON AZ 85748 P 520.401.9183

REVISION ISSUE INFORMATION

04.15.2025

SEAL / SIGNATURE



DCS Mesa Site Planning 8008 E University. Mesa, AZ 85207.

Photometric Site Plan

1" = 20'-0"

ENGINEERED DESIGN GROUP

CONSULTING MECHANICAL-ELECTRICAL-PLUMBING REFRIGERATION & FIRE PROTECTION ENGINEERS

EDG PROJECT # 25w-041

954 N. ALVERNON WAY, TUCSON AZ. 85711
PH.(520)881-8896, FAX:(520)881-5647 Engineered Design Group

FILE NAME File Path


JOB NUMBER


25-005-00-PDCS


IYP/DWC

DRAWN BY

Web Site: www.edg-ce.com CERTIFICATE OF AUTHORIZATION #24GA28116500 THESE PLANS ARE THE SOLE POSSESSION OF ENGINEERED DESIGN GROUP, INC. AND ARE COPYRIGHTED ①. THEY ARE NOT TO BE REPRODUCED WITHOUT THE EXPRESSED WRITTEN PERMISSION OF EDG WEST, INC. THIS DRAWING IS PRELIMINARY, NOT FOR CONSTRUCTION UNLESS SEALE AND SIGNED BY A REGISTERED ENGINEER.

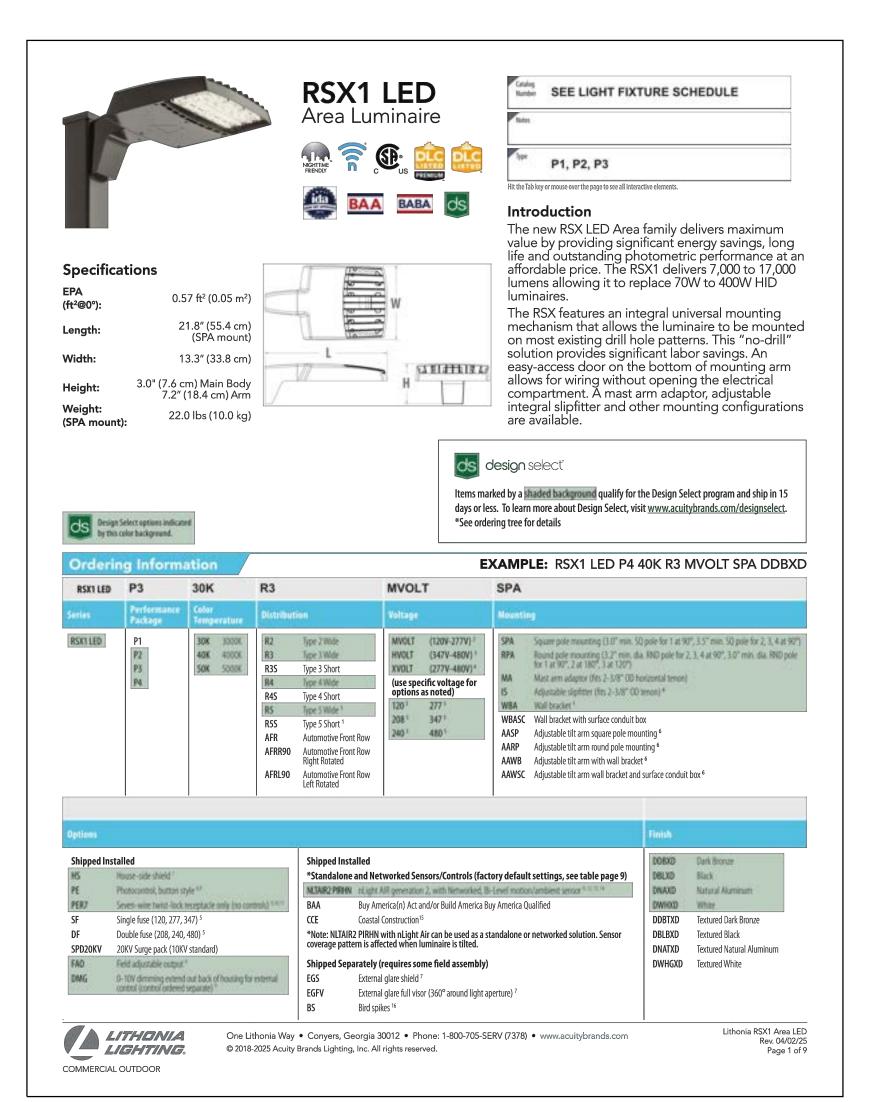

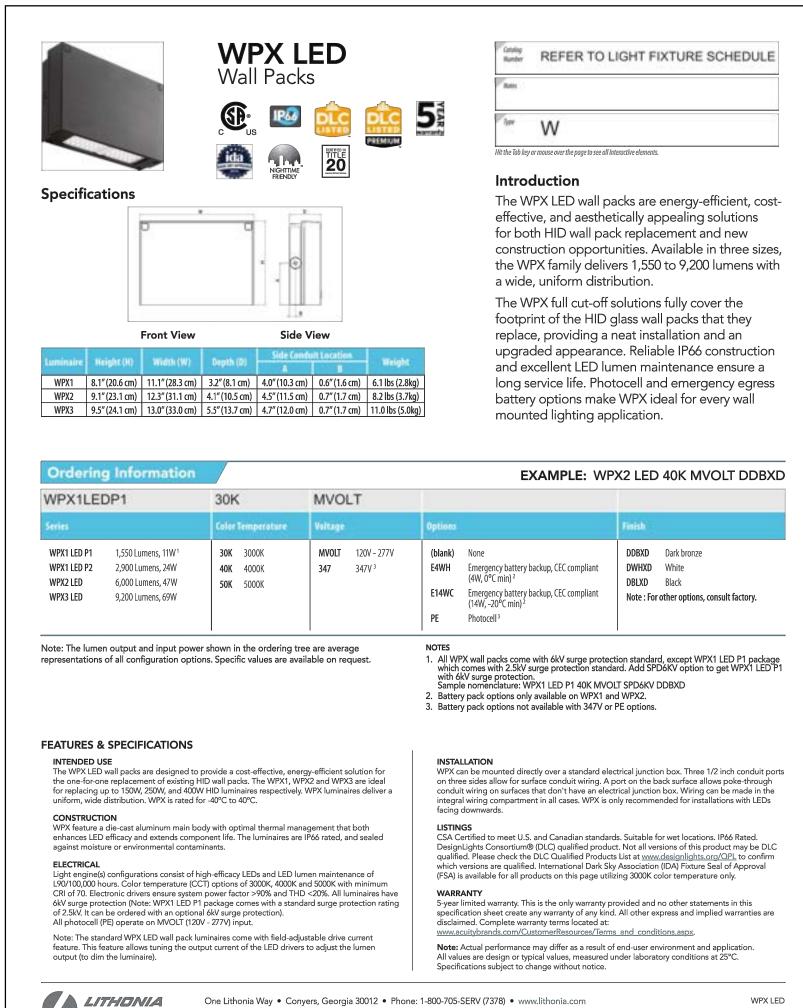


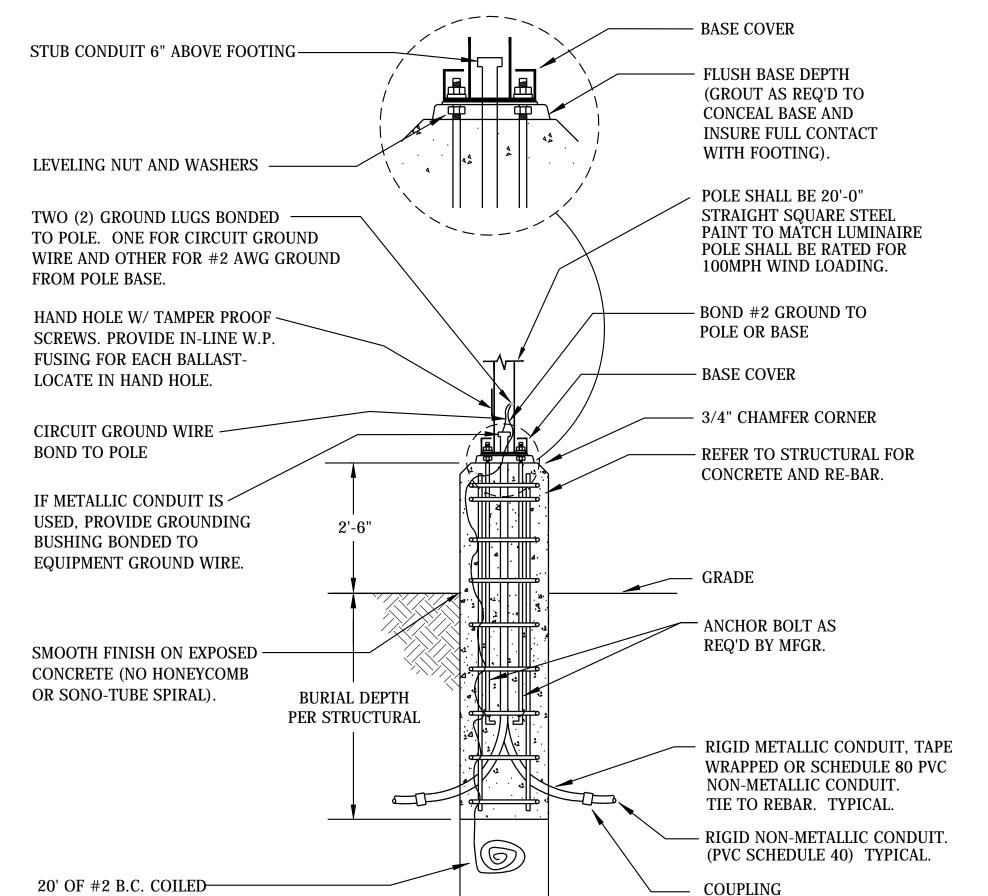

**--** 2'-0" Φ **--**

FIXTURES "P1", "P2" & "P3" POLE & BASE DETAIL

BELOW CONCRETE FOOTING.

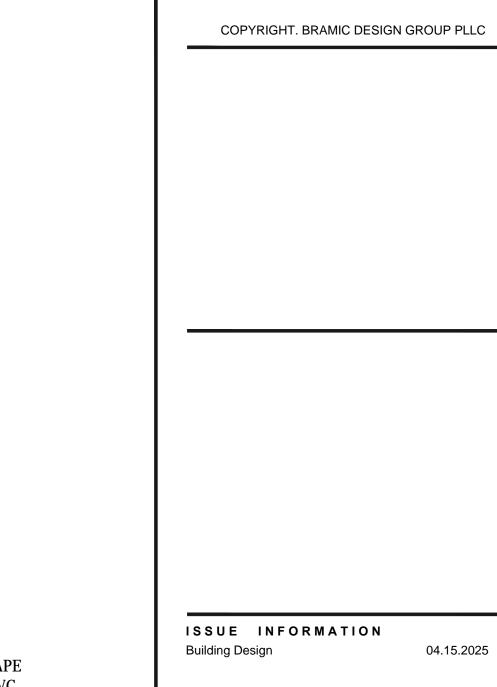

REVISION ISSUE INFORMATION

04.15.2025

**BRAMIC DESIGN GROUP** 

10820 E CALLE LINDA VISTA

TUCSON AZ 85748

P 520.401.9183

SEAL / SIGNATURE



DCS Mesa Site Planning 8008 E University. Mesa, AZ 85207.

ENGINEERED DESIGN GROUP

CONSULTING MECHANICAL-ELECTRICAL-PLUMBING REFRIGERATION & FIRE PROTECTION ENGINEERS

EDG PROJECT # 25w-041

954 N. ALVERNON WAY, TUCSON AZ. 85711
PH.(520)881-8896, FAX:(520)881-5647 ENGINEERED DESIGN GROUP PH.(520)881-8896, FAX:(520)881-5647 Web Site: www.edg-ce.com

CERTIFICATE OF AUTHORIZATION #24GA28116500 THESE PLANS ARE THE SOLE POSSESSION OF ENGINEERED DESIGN GROUP, INC. AND ARE COPYRIGHTED ( ). THEY ARE NOT TO BE REPRODUCED WITHOUT THE EXPRESSE WRITTEN PERMISSION OF EDG WEST, INC. THIS DRAWING IS PRELIMINARY, NOT FOR CONSTRUCTION UNLESS SEALE AND SIGNED BY A REGISTERED ENGINEER.

JOB NUMBER 25-005-00-PDCS

DRAWN BY

IYP/DWC

FILE NAME File Path